LAWRENCE CENTRALIZED KINDERGARTEN

NORTH & SOUTH CAMPUS ADDITIONS

METROPOLITAN SCHOOL DISTRICT OF LAWRENCE TOWNSHIP MARION COUNTY, INDIANA

GIBRALTAR DESIGN



CONTACT US:
6868 W. 96TH STREET
ZIONSVILLE, INDIANA 46077
(317) 873—5909
FAX: (317) 873—5909

SHEET INDEX

NORTH & SOUTH GENERAL

GIO01 COVER SHEET, SHEET INDEX AND LOCATION MAP

GIOO2 UNIT "A" FIRST & SECOND FLOOR

LIFE SAFETY PLAN

GIOO3 UNIT "A" LIFE SAFETY PLAN

GIOO4 GENERAL NOTES, ABBREVIATIONS, SYMBOLOGY LEGEND, WALL TYPES, & ADA REQUIREMENTS

NORTH CIVIL

C C-001 CIVIL DETAILS
C-002 CIVIL DETAILS
CS101 CIVIL SITE SURVEY
CD101 CIVIL DEMOLITION PLAN

CU101 CIVIL UTILITY PLAN

CG101 CIVIL LAYOUT PLAN
CE101 CIVIL EROSION CONTROL PLAN

CE101 CIVIL EROSION CONTROL PLA CL101 CIVIL LAYOUT PLAN

STRUCTURAL

S S-001 STRUCTURAL GENERAL NOTES, LEGENDS, SCHEDULES AND TYPICAL DETAILS
SB101 UNIT "A" FOUNDATION/SLAB PLAN
SF101 UNIT "A" LIGHT POOF FRAMING PLAN
SE103 UNIT "A" LIGHT POOF FRAMING PLAN

SF102 UNIT "A" HIGH ROOF FRAMING PLAN
SL101 UNIT "A" MASONRY PANEL REINFORCING/LINTEL
PLAN

S-301 STRUCTURAL SECTIONS AND DETAILS S-302 STRUCTURAL SECTIONS AND DETAILS S-303 STRUCTURAL SECTIONS AND DETAILS

ARCHITECTURAL

A AE101 UNIT "A" FIRST FLOOR PLAN
AE102 UNIT "A" SECOND FLOOR PLAN
PLAN

AE201 EXTERIOR ELEVATIONS
AE301 WALL SECTIONS

AE302 WALL SECTIONS

AE401 ENLARGED RESTROOM & STAIR PLAN AND DETAILS AE501 PRECAST PANEL AND WINDOW DETAILS

AE502 DETAILS
AE601 DOOR AND WINDOW SCHEDULES & DETAILS

AR101 ROOF PLAN & DETAILS

AI401 FLOOR AND WALL PATTERNS

AI801 CASEWORK FLEVATIONS & SCHEDUL

AI801 CASEWORK ELEVATIONS & SCHEDULES
AI900 FOOD SERVICE EQUIPMENT PLAN
AI901 FOOD SERVICE EQUIPMENT SCHEDULES
AI902 FOOD SERVICE FOURMENT SPOT LOCATION

Al901 FOOD SERVICE EQUIPMENT SCHEDULES
Al902 FOOD SERVICE EQUIPMENT SPOT LOCATION
Al903 FOOD SERVICE EQUIPMENT ELEVATIONS

FIRE PROTECTION

FP101 FIRE PROTECTION FLOOR PLAN & DETAILS

PLUMBING

P P-001 PLUMBING LEGEND, GENERAL NOTES, SCHEDULFS

P-101 UNIT "A" PLUMBING FOUNDATION PLAN P-102 UNIT "A" PLUMBING FIRST FLOOR PLAN

MECHANICAL

M-101 UNIT "A" MECHANICAL FIRST FLOOR PLAN M-401 MECHANICAL BOILER ROOM A-102 PLAN & PIPING DIAGRAMS

M-501 MECHANICAL EQUIPMENT ROOM A-201 LAYOUT AND DETAILS M-601 MECHANICAL GENERAL NOTES, LEGEND AND

SCHEDULES
M-602 MECHANICAL SCHEDULES
M-603 MECHANICAL DETAILS

M-801 MECHANICAL TEMPERATURE CONTROL DIAGRAMS MR101 MECHANICAL ROOF PLAN

WICH OF MEDITATIONE TO

ELECTRICAL

E E-001 ELECTRICAL SYMBOL, SCHEDULE, DETAILS AND NOTES

ES101 ELECTRICAL SITE PLAN

E-101 MCKENZIE CAREER CENTER PARTIAL ELECTRICAL FIRST FLOOR PLAN
EL101 UNIT "A" ELECTRICAL FIRST FLOOR LIGHTING PLAN

EL102 UNIT "A" ELECTRICAL SECOND FLOOR LIGHTING PLAN EP101 UNIT "A" ELECTRICAL FIRST FLOOR POWER PLAN EP102 UNIT "A" ELECTRICAL SECOND FLOOR POWER PLAN E-401 ELECTRICAL AUXILIARY PLAN OF ELECTRICAL ROOM &

BOILER ROOM AREAS
E-601 ELECTRICAL SCHEDULES, DETAILS, & NOTES
E-602 ELECTRICAL SCHEDULES, DETAILS, & NOTES
E-701 ELECTRICAL DISTRIBUTION DIAGRAMS

SOUTH CIVIL

C C-001 CIVIL DETAILS
CS101 CIVIL SITE SURVEY
CD101 CIVIL DEMOLITION PLAN
CG101 CIVIL LAYOUT PLAN
CL101 CIVIL LAYOUT PLAN
CU101 CIVIL UTILITY PLAN

STRUCTURAL

FOR STRUCTURAL GENERAL NOTES, LEGENDS, SCHEDULES AND TYPICAL DETAILS: SEE S-001 UNIT "A" FOUNDATION/SLAB PLAN UNIT "A" ROOF FRAMING PLAN UNIT "A" MASONRY PANEL REINFORCING/LINTEL PLAN FOR STRUCTURAL SECTIONS AND DETAILS: SEE S-301, S302, S-303

ARCHITECTURAL

A AE101 DEMOLITION PLAN & UNIT "A" FIRST FLOOR PLAN
AE201 EXTERIOR ELEVATIONS
AE301 WALL SECTIONS
AE302 WALL SECTIONS
AE501 DOOR & WINDOW SCHEDULES
AR101 ROOF PLAN & DETAILS
FOR FLOOR AND WALL PATTERNS: SEE NORTH AI401
FOR CASEWORK ELEVATIONS & SCHEDULES: SEE
NORTH AI801
FOR FOOD SERVICE EQUIPMENT PLAN: SEE NORTH
AI900

FOR FOOD SERVICE EQUIPMENT SCHEDULES: SEE NORTH A1902
FOR FOOD SERVICE EQUIPMENT SPOT LOCATION: SEE NORTH A1902
FOR FOOD SERVICE EQUIPMENT ELEVATIONS: SEE

FIRE PROTECTION

FP101 FIRE PROTECTION FLOOR PLAN & DETAILS

PLUMBING

FOR PLUMBING LEGEND, GENERAL NOTES, SCHEDULES: SEE NORTH P-001
P-101 UNIT "A" PLUMBING FOUNDATION AND FIRST FLOOR PLANS

MECHANICAL


M-101 UNIT "A" MECHANICAL FIRST FLOOR PLAN
AND MECHANICAL EQUIPMENT ROOM LAYOUT
AND DETAILS
FOR MECHANICAL GENERAL NOTES, LEGEND AND
SCHEDULES: SEE NORTH M-601
FOR MECHANICAL SCHEDULES: SEE NORTH M-60
FOR MECHANICAL DETAILS: SEE NORTH M-603
FOR MECHANICAL TEMPERATURE CONTROL DIAGRAMS:
SEE NORTH M-801
MR101 MECHANICAL ROOF PLAN

ELECTRICAL

E-001 ELECTRICAL SYMBOL, SCHEDULE, DETAILS
AND NOTES
E-101 LAWRENCE CENTRAL HIGH SCHOOL PARTIAL

ELECTRICAL FIRST FLOOR PLAN
EL101 UNIT "A" ELECTRICAL FIRST FLOOR LIGHTING PLAN
EP101 UNIT "A" FIRST FLOOR POWER PLAN
E-601 ELECTRICAL SCHEDULES, DETAILS, & NOTES

E-602 ELECTRICAL DETAILS
E-701 ELECTRICAL DISTRIBUTION DIAGRAMS

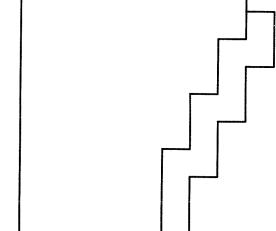

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ARCHITECTURE • ENGINEERING • INTERIOR DESIGN

PROJECT

LAWRENCE CENTRALIZED KINDERGARTEN

NORTH & SOUTH CAMPUS ADDITIONS

METROPOLITAN SCHOOL DISTRICT OF LAWRENCE TOWNSHIP

MARION COUNTY, INDIANA

GIBRALTAR DESIGN

9102 N. Meridian St., Ste. 300
Indianapolis, IN 46260
Homepage www.GibraltarDesign.com
Email info@GibraltarDesign.com
Phone 317.580.5777 Fax 317.580.5778

Homepage www.GibraltarDesign.
Email info@GibraltarDesign.
Phone 317.580.5777 Fax 317.580.5

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AND LOCATION MAP

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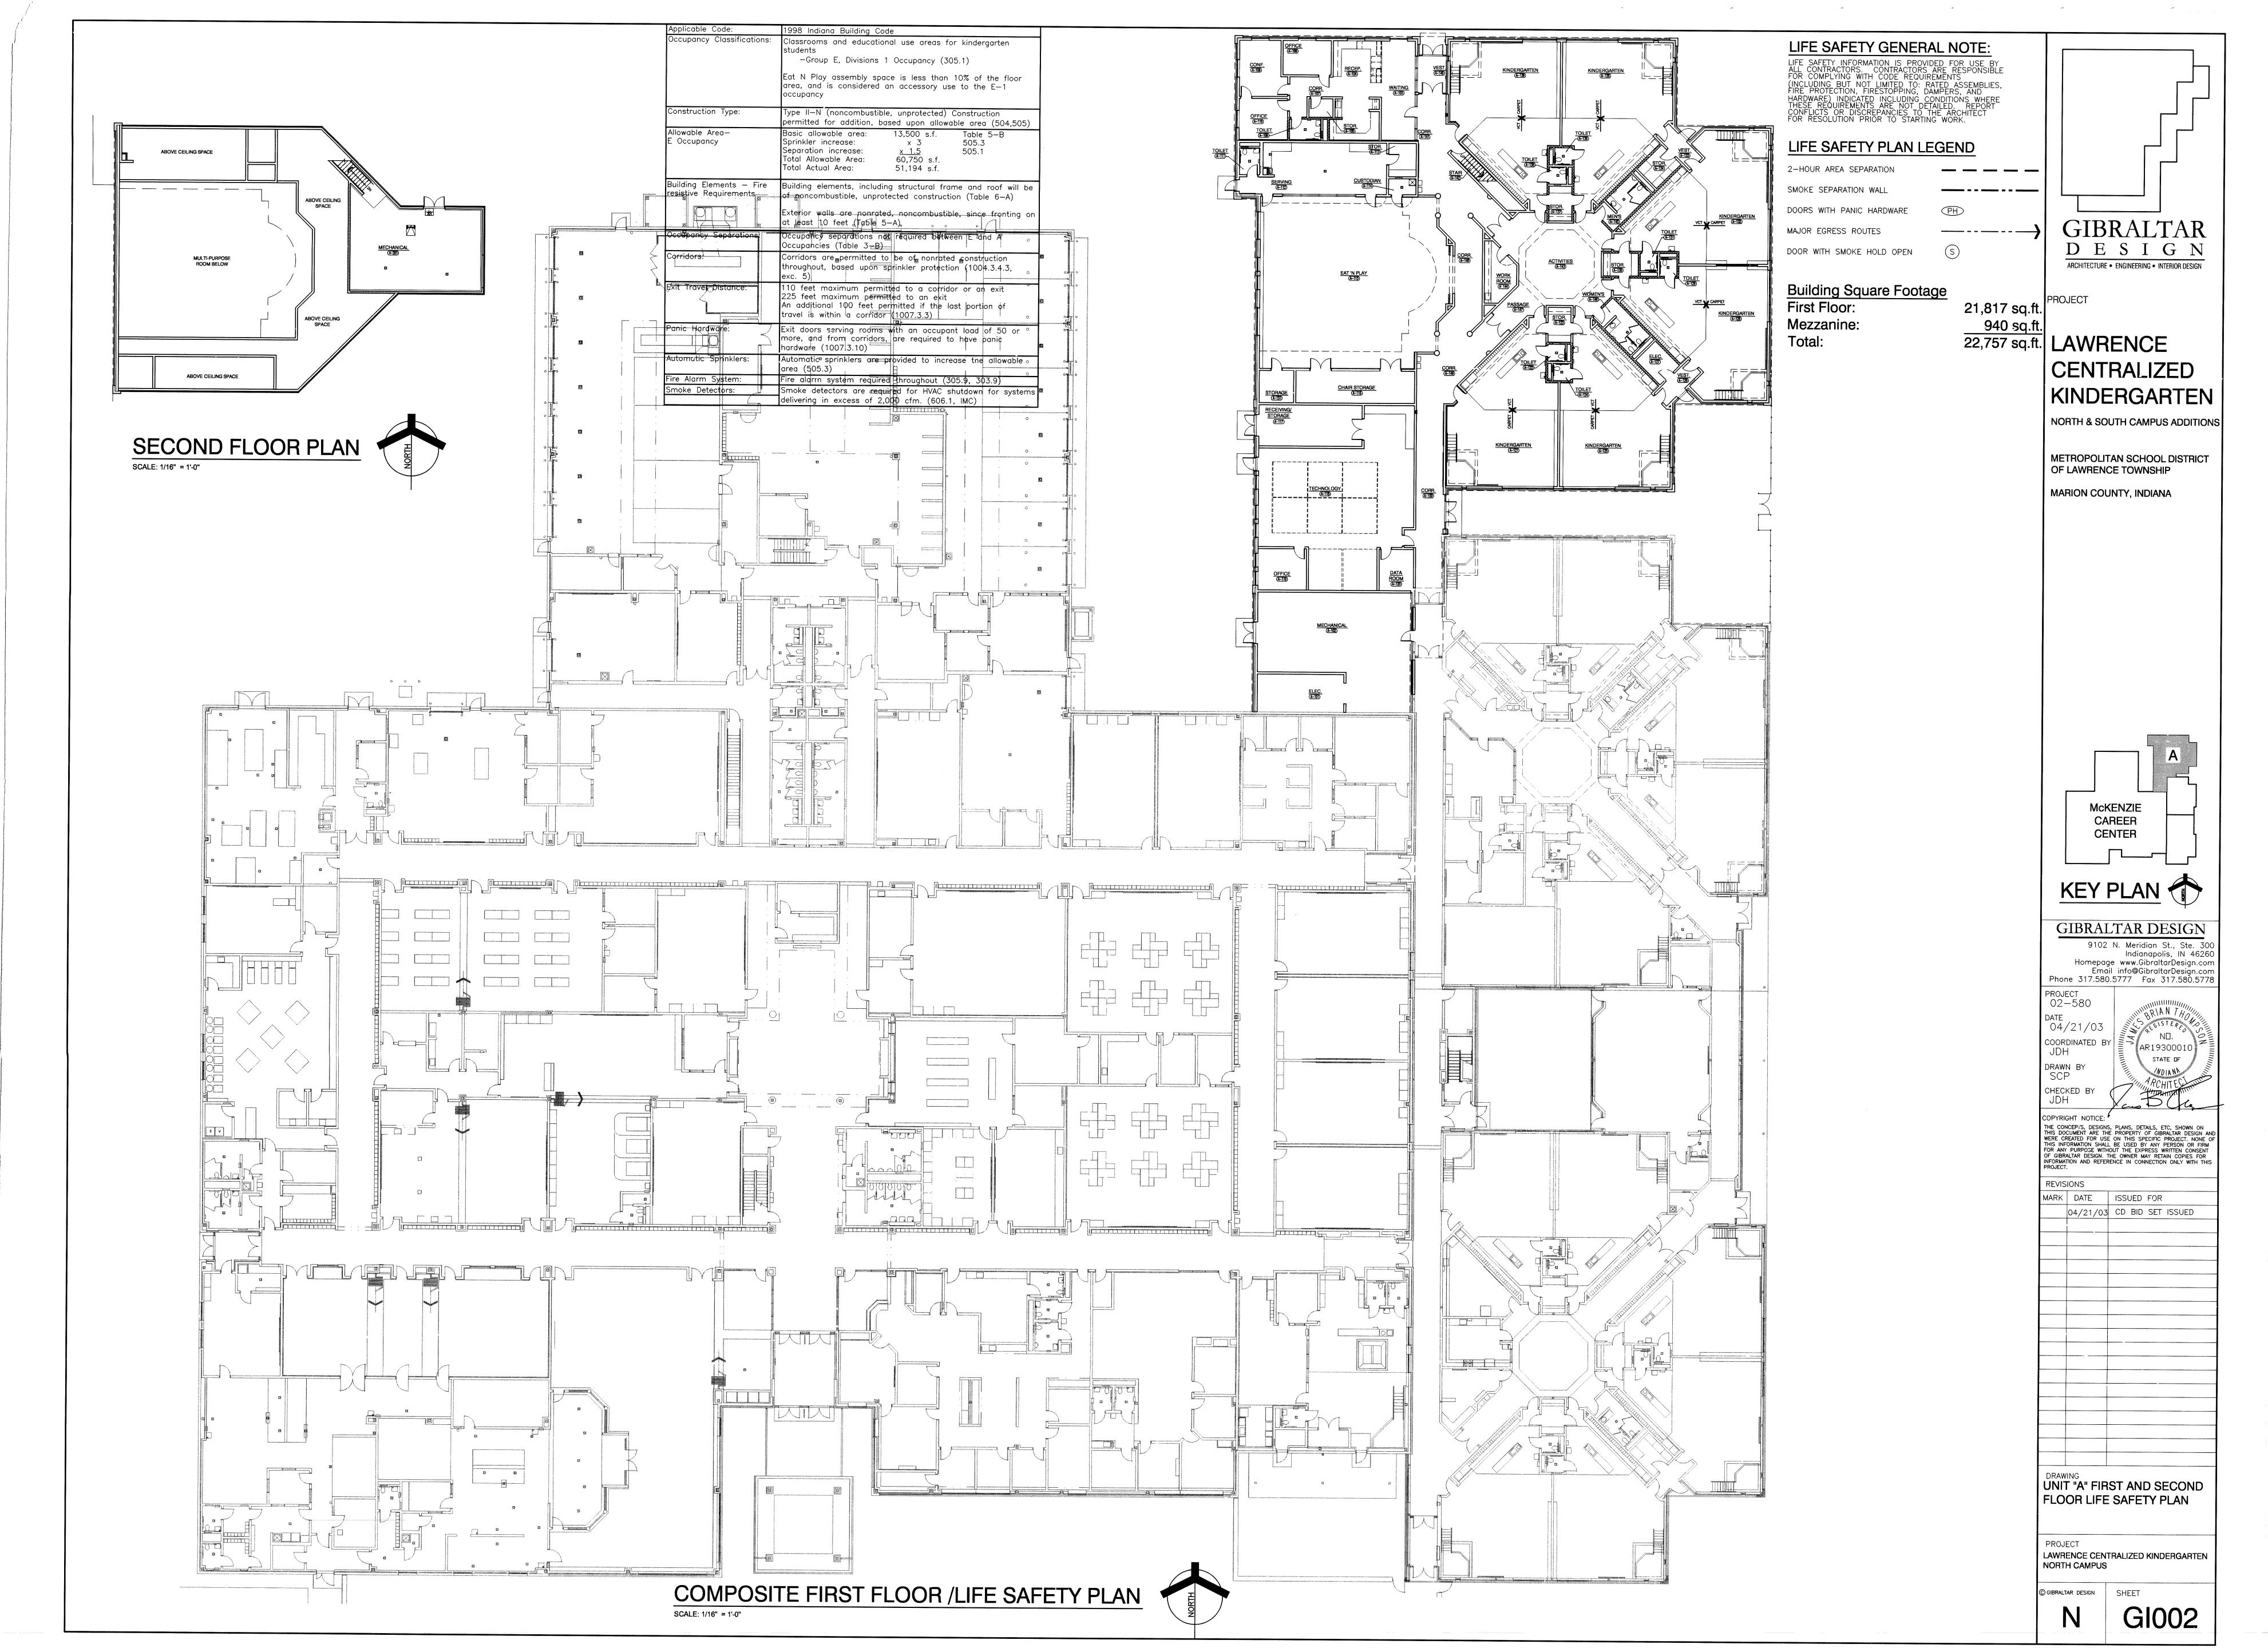
LAWRENCE CENTRALIZED KINDERGARTEN


NORTH & SOUTH CAMPUS ADDITIONS

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CENTRALIZED KINDERGARTEN


KEY PLAN


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CERAMIC TILE

6" METAL STUD (B)

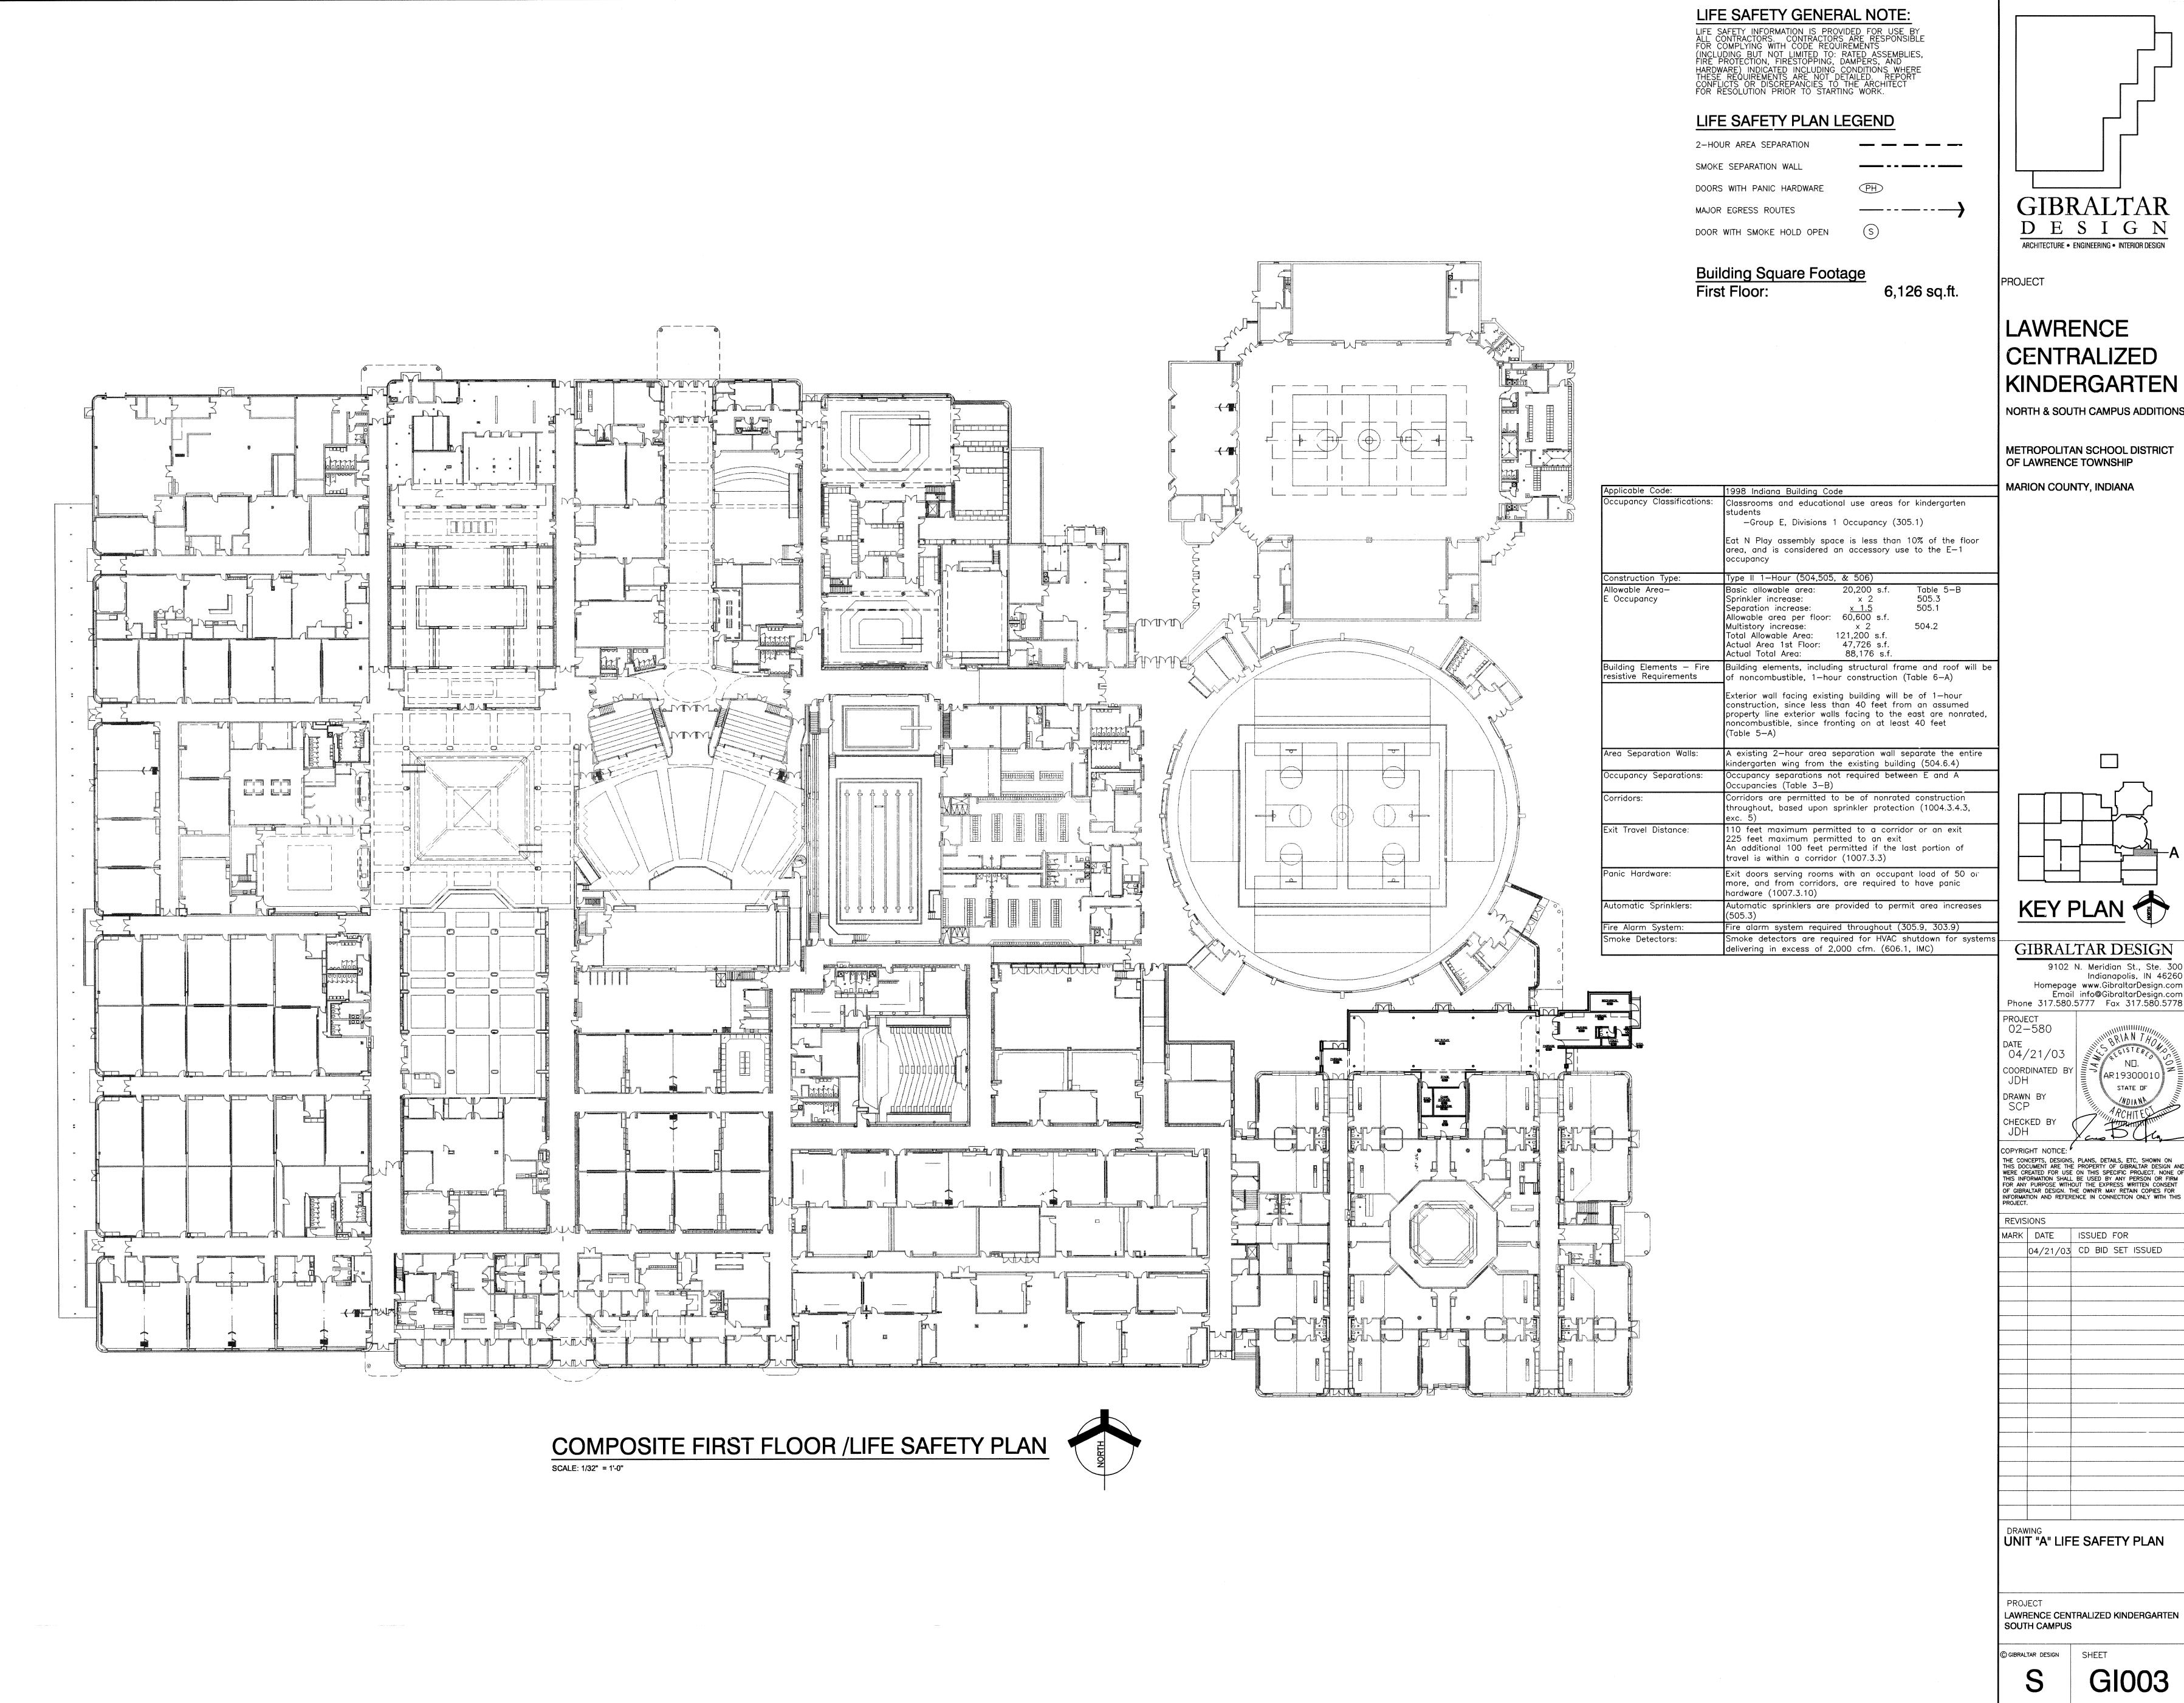BACKÉRBOARD

STRUCTURE ABOVE.

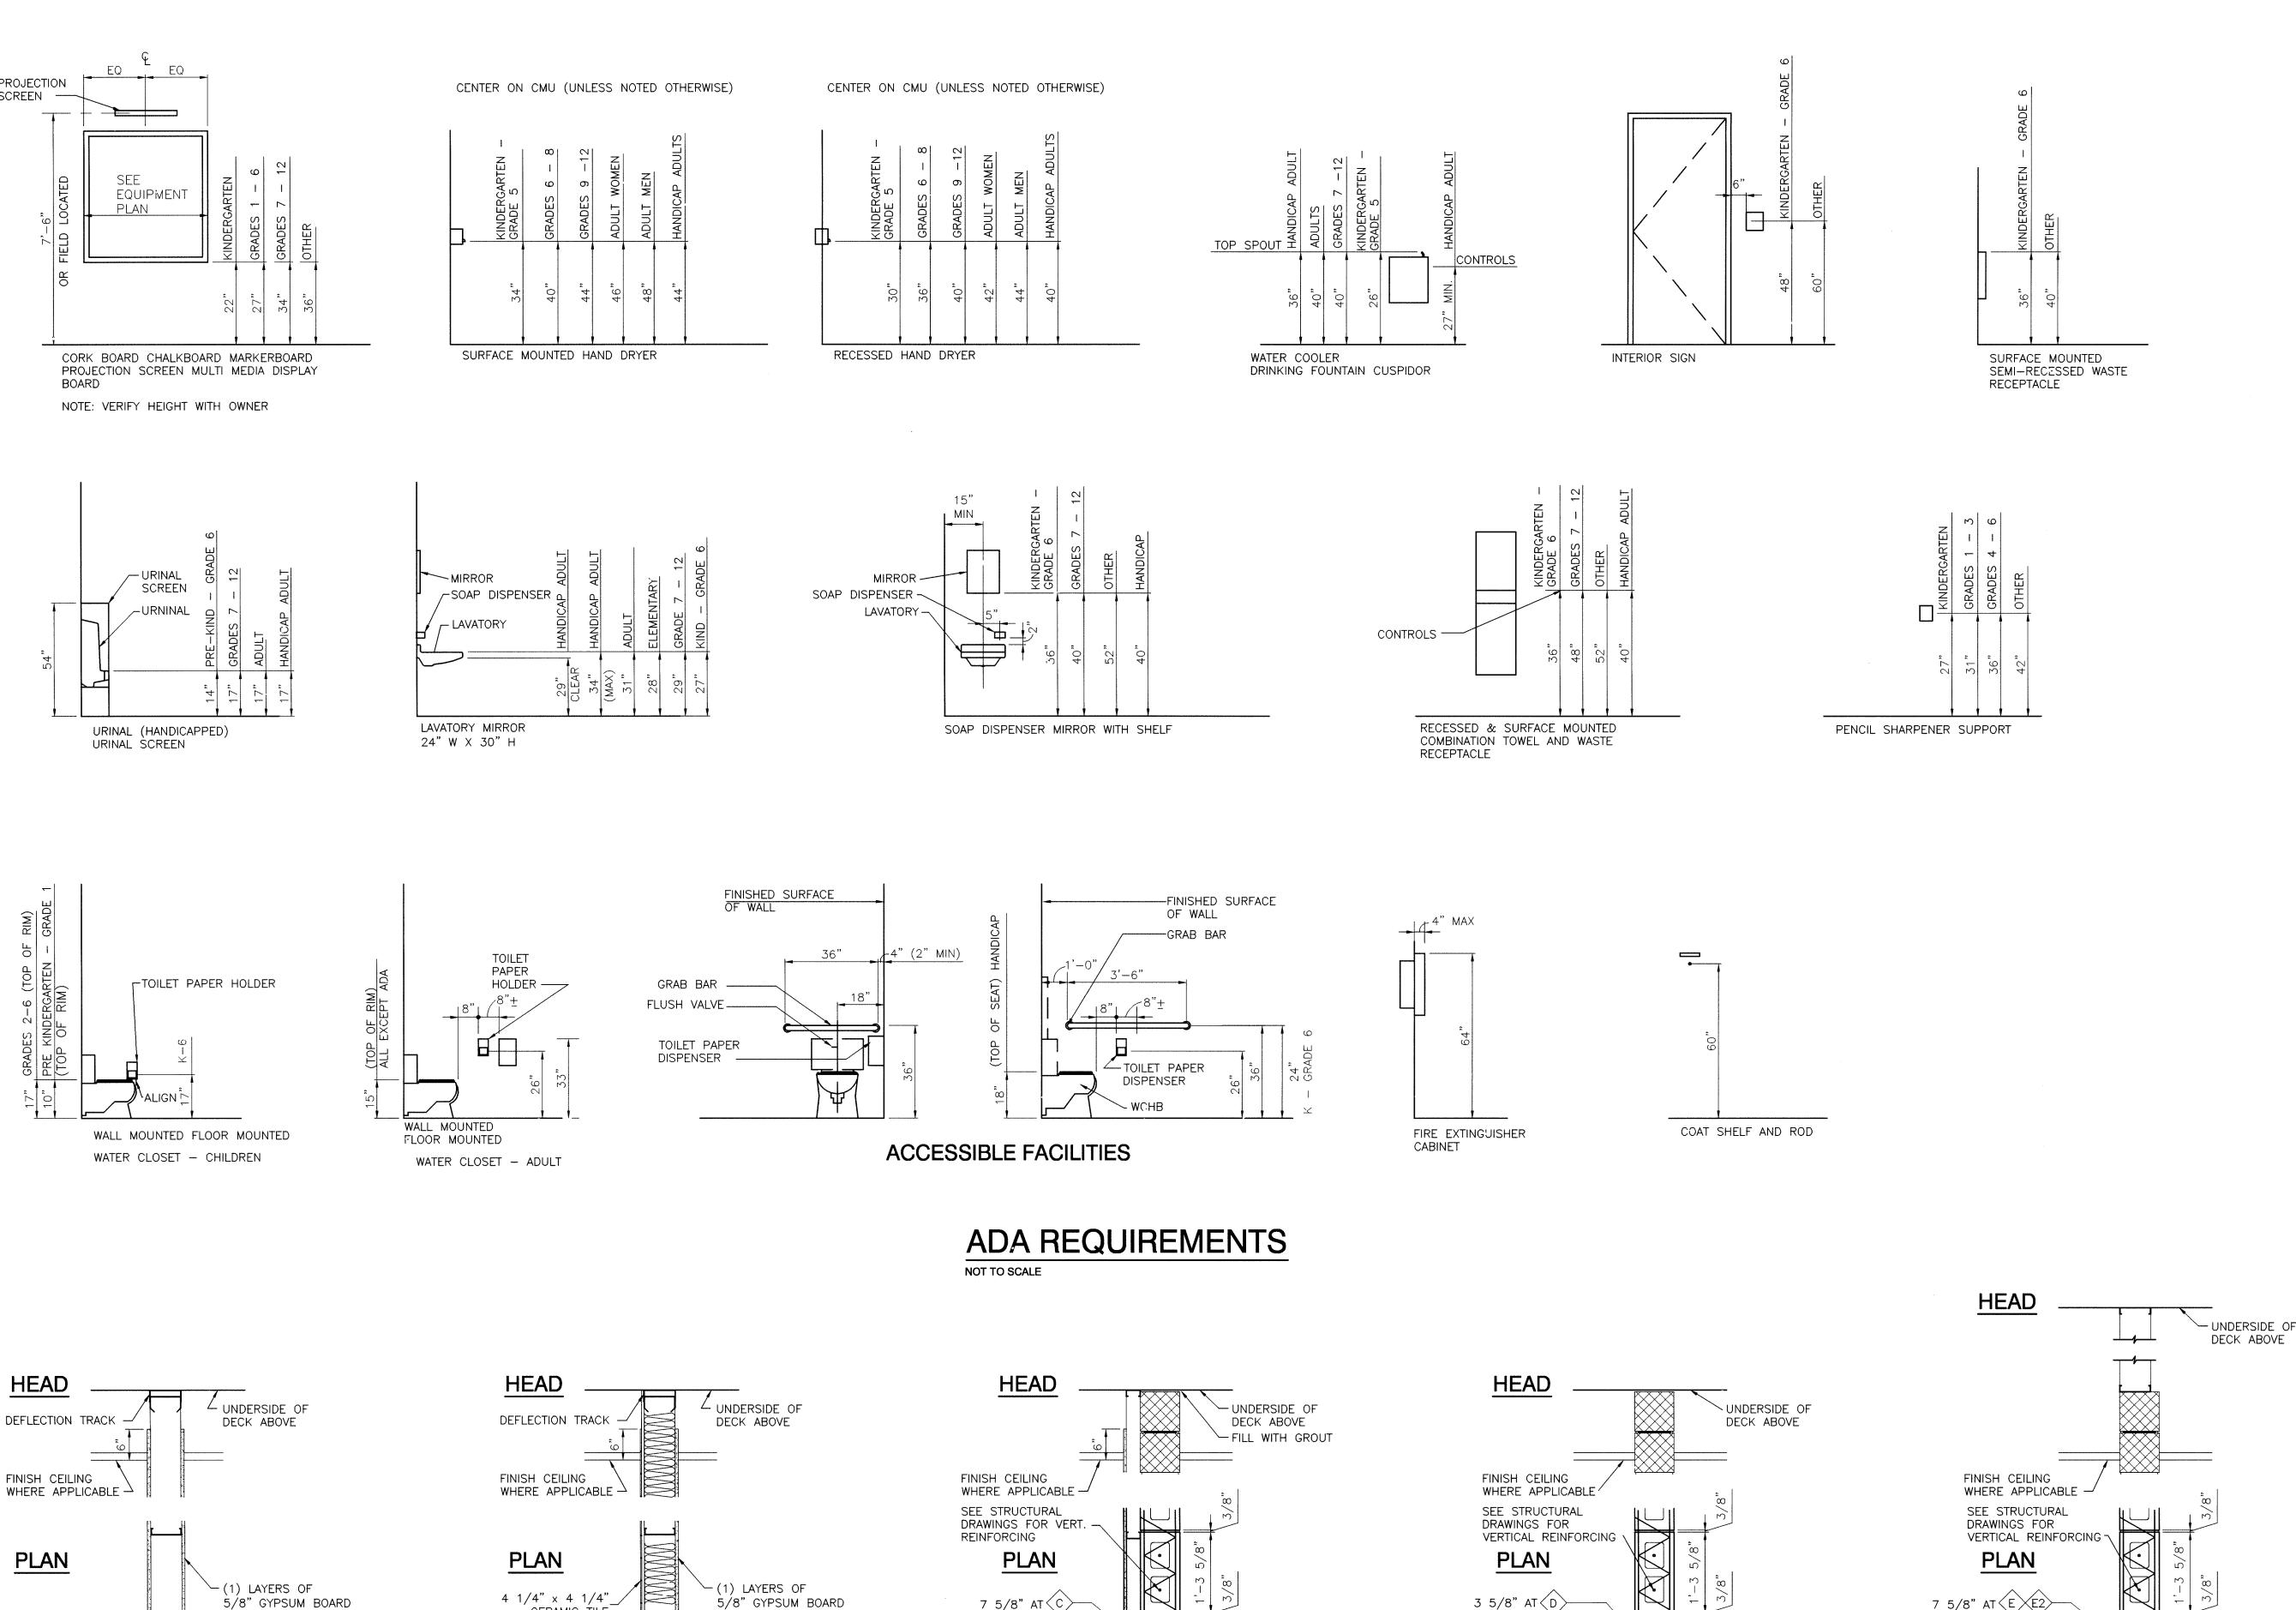BASE AS SCHEDULED -

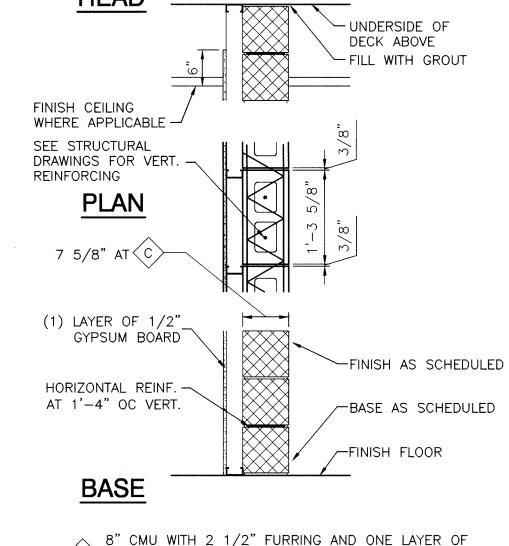BASE

FINISH AS SCHEDULED

BASE AS SCHEDULED

6" METAL STUD WITH ONE LAYER OF BACKER BOARD

B > ONE SIDE WITH CERAMIC TILE. THE OTHER SIDE HAS

(1) ONE LAYER OF 5/8" AND EXTENDS TIGHT TO

A > 7 1/4" A4 6 3/4"

- FINISH AS SCHEDULED

BASE AS SCHEDULED

FINISH FLOOR

6" METAL STUD WITH ONE LAYERS OF 5/8" GYPSUM

6" METAL STUD WITH BATT INSULATION. ONE LAYER

(A2) OF 5/8" GYPSUM BOARD ON ONE SIDE AND EXTENDS

SIMILIAR TO "A" BUT WITH 1/2" BACKERBOARD AND 4 1/4" x 4 1/4" CERAMIC TILE ONE SIDE.

SIMILIAR TO "A" BUT WITH 1/2" BACKERBOARD AND 4 1/4" x 4 1/4" CERAMIC TILE BOTH SIDES.

(A) BOARD BOTH SIDES AND EXTENDS TIGHT TO

(A1) SIMILIAR TO "A" BUT WITH BATT INSULATION.

TIGHT TO STRUCTURE ABOVE.

6" METAL STUD (A)


FINISH AS SCHEDULED -

BASE AS SCHEDULED -

STRUCTURE ABOVE.

BASE

- \sim 8" CMU WITH 2 1/2" FURRING AND ONE LAYER OF $\langle C \rangle$ 1/2" GYPSUM BOARD ONE SIDE. 8" CMU TIGHT TO UNDERSIDE OF DECK ABOVE.
- 8" CMU WITH 2 1/2" FURRING AND ONE LAYER OF $\langle C1 \rangle$ 1/2" BACKERBOARD WITH 4 1/4" x 4 1/4" CERAMIC TILE ONE SIDE. 8" CMU TIGHT TO UNDERSIDE OF DECK ABOVE.
- 8" CMU WITH 2 1/2" FURRING AND ONE LAYER OF (C2) 5/8" GYPSUM BOARD ONE SIDE. THE OTHER SIDE WITH 1/2" GYPSUM BOARD DIRECTLY APPLIED TO CMU WALL. 8" CMU TIGHT TO UNDERSIDE OF DECK ABOVE.
- (C3) SIMILIAR TO "C2" BUT WITH 6" CMU.

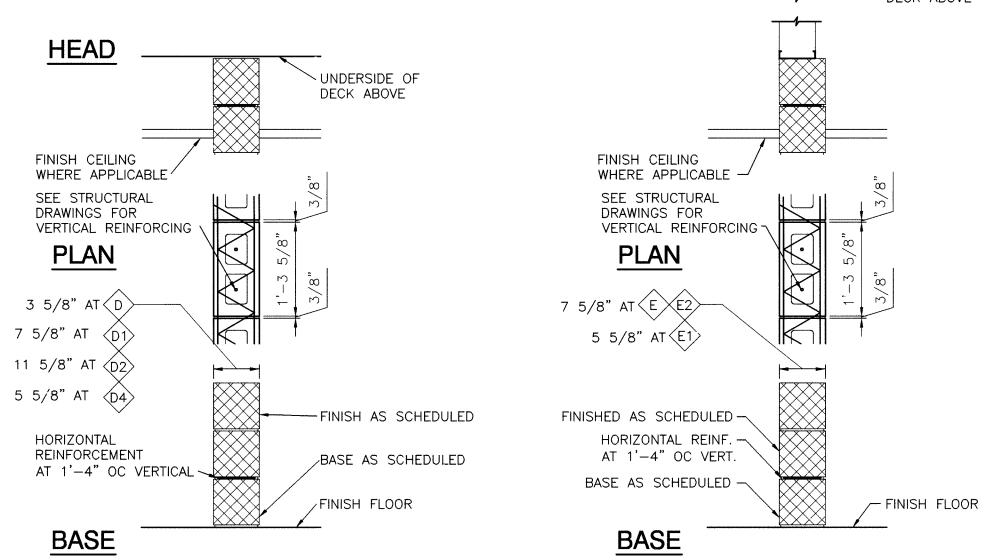

(D) 4" CMU - TIGHT TO UNDERSIDE OF DECK ABOVE. E S" CMU - STOP (2) COURSING ABOVE CEILING, CONTINUE WALL UP WITH 6" MTL. STUD TO $0\,\mathrm{i}\!>8"$ CMU - TIGHT TO UNDERSIDE OF DECK ABOVE. UNDERSIDE OF DECK ABOVE. (D2) 12" CMU WITH ONE LAYER OF 1/2" BACKERBOARD 6" CMU WITH ONE LAYER OF 1/2" BACKERBOARD AND 4 1/4" \times 4 1/4" CERAMIC TILE ONE SIDE. 12"


CMU TIGHT TO UNDERSIDE OF DECK.

CMU TIGHT TO UNDÉRSIDE OF DECK.

(D5) SIMILIAR TO "D4" EXCEPT WITH 8" CMU.

AND 4 1/4" \times 4 1/4" CERAMIC TILE ONE SIDE. 6"

- $\stackrel{\leftarrow}{}$ AND 4 1/4" x 4 1/4" CERAMIC TILE ONE SIDE. STC (2) COURSING ABOVE CEILING, CONTINUE WALL UP SIMILIAR TO "D1" EXCEPT ONE LAYER OF 1/2" GYPSUM BOARD DIRECTLY APPLIED ON ONE SIDE. WITH 6" MTL. STUD TO UNDERSIDE OF DECK ABOVE. 8" CMU WITH ONE LAYER OF 1/2" BACKERBOARD 6" CMU WITH ONE LAYER OF 1/2" BACKERBOARD
 - AND 4 1/4" x 4 1/4" CERAMIC TILE ONE SIDE. STC (2) COURSING ABOVE CEILING, CONTINUE WALL UP WITH 6" MTL. STUD TO UNDERSIDE OF DECK ABOVE.

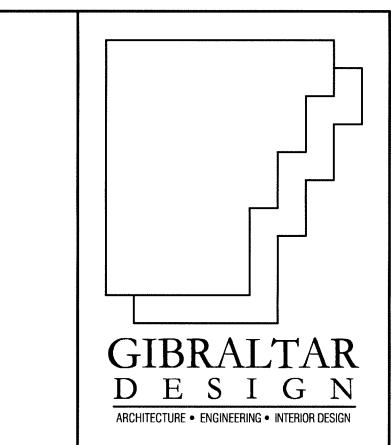

PROJECT


LAWRENCE CENTRALIZED **KINDERGARTEN**

NORTH & SOUTH CAMPUS ADDITIONS

METROPOLITAN SCHOOL DISTRICT

MARION COUNTY, INDIANA

OF LAWRENCE TOWNSHIP

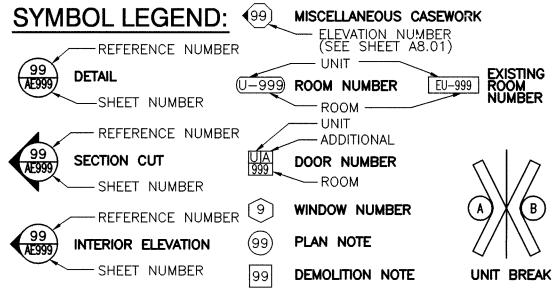

GENERAL NOTES: (APPLY TO ENTIRE DRAWING SET)

3. EACH TRADE SHALL COORDINATE WITH THE APPROPRIATE

5. THE BOTTOM OF ALL CONVECTOR FAN COIL, AND UNIT HEATER RECESSES SHALL BE INSTALLED A MINIMUM OF 6" AND A MAXIMUM OF 12" ABOVE FLOOR LINE. PLACE MASONRY LINTELS AT UNCUT COURSING HEIGHT. COORDINATE OPENINGS WITH APPROPRIATE CONTRACTOR(S).

MASONRY WALLS BEARING ON A THICKENED SLAB AT SLAB DEPRESSIONS REQUIRE CUT MASONRY UNITS SO THAT COURSING BEGINS AT THE FLOOR LINE.

ALL ITEMS OF EQUIPMENT OR MATERIALS NOT MARKED OR INDICATED AS EXISTING ARE NEW AND SHALL BE FURNISHED BY THE APPROPRIATE CONTRACTOR.

10. PLUMBING AND ELECTRICAL ITEMS (SUCH AS SINKS, TOILETS, PANELS, ETC.) MAY APPEAR "DASHED" FOR DEMOLITION ON SEVERAL DRAWINGS INCLUDING ARCHITECTURAL SHEETS. REMOVAL OF THESE ITEMS SHALL BE BY THE APPROPRIATE

MATERIAL INDICATIONS:

IN GENERAL, THE MATERIAL INDICATIONS SHOWN BELOW ARE TYPICAL. HOWEVER, ALL MATERIAL INDICATIONS PRESENTED HERE MAY NOT BE USED ON THIS PARTICULAR PROJECT. THESE SYMBOLS TYPICALLY INDICATE THE MATERIALS WHEN SECTIONED THROUGH ON PLANS, DETAILS AND WALL

	FACE BRICK	FIRE BRICK	LIGHTWEIGHT BLOCK	TERRAZZ
***	CONCRETE	EIFS	CONCRETE BLOCK	MARBLE
	WOOD BLOCKING	BLANKET INSULATION	PLASTER OR GYPSUM BOARD	FACING TILE
0 0 0 0	CUT STONE	FINISH WOOD	RIGID INSULATION	

PLAN EXAMPLES:

EXISTING WALL TO BE REMOVED

NEW SOUNDPROOF

NEW STUD WALL

EXISTING WALL

LINE SYMBOLOGY "SCREENED" BACKGROUND LINES (LIGHT GRAY LINES) INDICATE EXISTING CONSTRUCTION WALLS, PIPES, LIGHTS, ETC

HEAVY DASHED LINES INDICATE DEMOLITION ITEMS ON DEMOLITION DRAWINGS.
DEMOLITION DRAWINGS ALSO INDICATE DEMOLITION DRAWINGS ALSO INDICATE
DEMOLITION WORK WITH "LIGHT" DASHED
LINES WHEN DEMOLITION WORK IS NOT
SPECIFICALLY RELATED TO THE CURRENT SHEET. (FOR EXAMPLE: WALLS DEING REMOVED APPEAR AS HEAVY DASHED LINES ON THE ARCHITECTURAL PLANS AND APPEAR AS LIGHT DASHED LINES ON HVAC, LIGHTING, ETC. PLANS.)

SOLID LINES ON NEW ("NON-DEMOLITION")
DRAWINGS INDICATE NEW WORK.

ARCHITECTURAL ABBREVIATIONS

THE ARCHITECTURAL ABBREVIATIONS LISTED BELOW ARE TYPICAL.

HIS PA	ARTICULAR PROJECT. NAL ABBREVIATIONS	SEE	ROOM FINISH SCHED	DULE L	EGENDS FOR
ACOUS AFF	ACOUSTICAL ABOVE FINISHED FLOOR	GA GALV GYP	GAGE GALVANIZED GYPSUM	PTN QT QTY	PARTITION QUARRY TILE QUANTITY
ALUM ALT ANOD ARCH	ALUMINUM ALTERNATE ANODIZED ARCHITECTURAL	HM HORIZ ID INSUL	HOLLOW METAL HORIZONTAL INSIDE DIAMETER INSULATE (FD)	ŘB RC RD REINF	RUBBER BASE ROOF CONDUCTOR ROOF DRAIN REINFORCE (ING)
BD BLK BLKHD AB	BOARD BLOCK BULKHEAD STEEL CHANNEL CARINET	INT JAN KCP	INTERIOR JANITOR KEENE'S CEMENT PLASTER	RESIL REV RM RO	RESILIENT REVISION ROOM ROUGH OPENING
ÉB EM ER FOI	CABINET CHALKBOARD CEMENT CERAMIC CONTRACTOR FURNISHED OWNER	L LAV LTWT M MARB	STEEL ANGLE LAVATORY LIGHTWEIGHT STEEL M-SHAPE MARBLE	RV SF	ROOF VENT SQUARE FEET SIMILAR SMOOTH SPECIFICATION SQUARE STAINI FSS STEEL
CLG CLRM	INSTALLED CENTERLINE CEILING CONTROL JOINT CLASSROOM CONCRETE	MB MAS MAX MC	MARKERBOARD MASONRY MAXIMUM MISC STEEL CHANNEL	SM SPEC SS/S STD STL STOR	STANDARD STEEL STORAGE
CONC CONF CONT CORK CSWK	CONCRETE CONFERENCE CONTINUOUS CORKBOARD CASEWORK CERAMIC TILE	MECH MET MIN MISC MO	MECHANICAL METAL MINIMUM MISCELLANEOUS MASONRY OPENING	SYNTH SYS TEL TER	SYNTHETIC SYSTEM TELEPHONE TERRAZZO
DEG DEMO DF	DEGREE DEMOLITION DRINKING	MTD NA NTS	MOISTURE RESISTANT MOUNTED NOT APPLICABLE	TS TYP UNFIN	STEEL STRUCTURAL TUB TYPICAL UNFINISHED
DIA DN EIFS	FOUNTAIN DIAMETER DOWN EXTERIOR INSULATION	OC OD OFCI	NOT TO SCALE ON CENTER OUTSIDE DIAMETER OWNER FURNISHED CONTRACTOR INSTALLED	VB VCT VERT VFOI	VINYL BASE VINYL COMPOSITION TILI VERTICAL VENDOR FURNISHE
LEC Q	AND FINISH SYSTEM ELECTRICAL EQUAL	OFOI	OWNER FURNISHED OWNER INSTALLED		VENDOR FURNISHE OWNER INSTALLEI VENDOR FURNISHEI VENDOR INSTALLEI VINYL
QUIP WC	EQUIPMENT ELECTRIC WATER COOLER	OFVI	OWNER FURNISHED VENDOR INSTALLED	VNR VWC	VENEER VINYL WALL COVERING
XIST J XT	EXISTING EXPANSION JOINT EXTERIOR	OFF ORD	OFFICE OVERFLOW ROOF DRAIN	W W/o	STEEL W-SHAPE WITH WITHOUT
XT D E EC	FLOOR DRAIN FIRE EXTINGUISHER FIRE EXTINGUISHER CABINET	PERF PL PLAM PLAS	PERFORATED PLATE PLASTIC LAMINATE PLASTER	WD WSCT WWF	WOOD WAINSCOT WELDED WIRE FABRIC
RP	FIBERGLASS REINFORCED PANEL	POR	PORCELAIN PRECAST		17.0100

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9102 N. Meridian St., Ste. 30

Homepage www.GibraltarDesign.com

Email info@GibraltarDesign.com Phone 317.580.5777 Fax 317.580.5778

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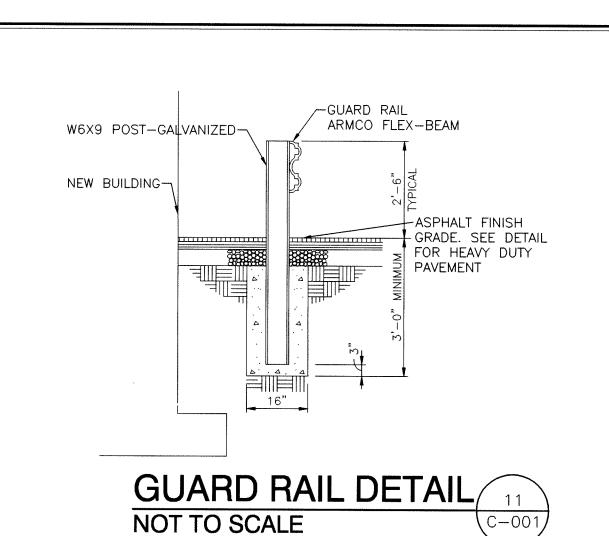
GENERAL NOTES, ABBREV., SYMBOLOGY LEGEND, WALL TYPES, AND ADA REQUIREMENTS


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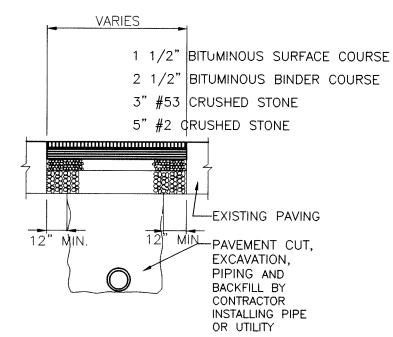
GI004

WALL TYPES SCALE: 3/4" = 1'-0"







TYPICAL OUTSIDE CLEANOUT NOT TO SCALE

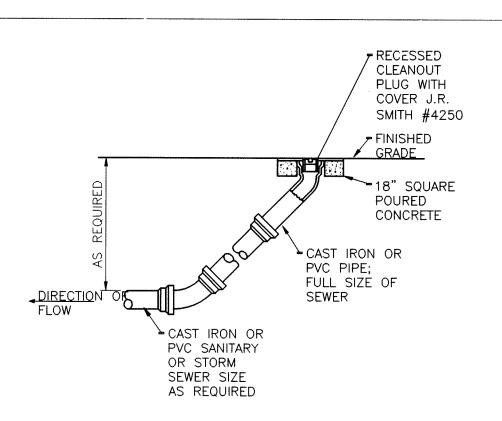


CUT AND REPAIR HEAVY / **DUTY PAVEMENT DETAIL** NOT TO SCALE

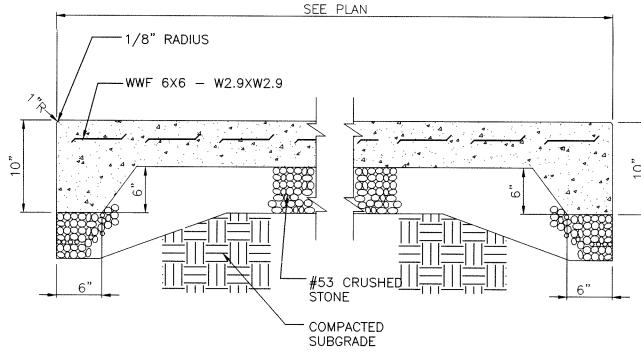

"4" CONCRETE SLAB NOT TO SCALE

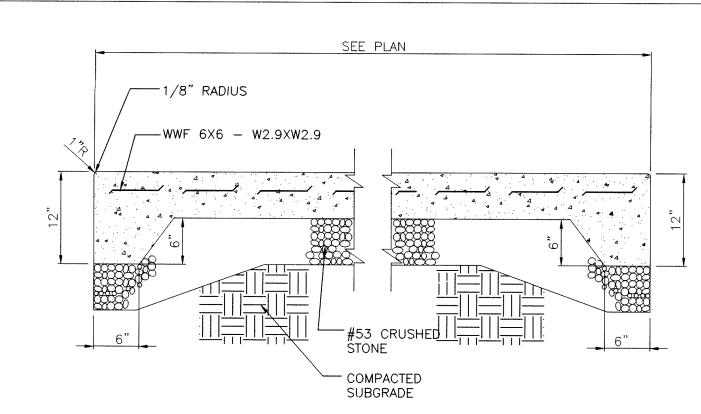

"6" CONCRETE SLAB DETAIL 15 NOT TO SCALE

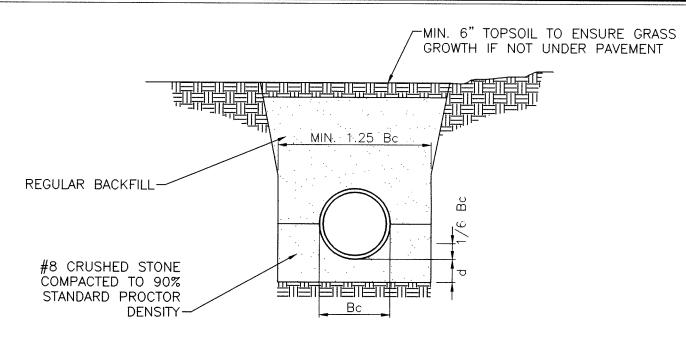

ALL BEDDING AND INITIAL BACKFILL SHALL BE INSTALLED IN 6" TO 12" BALANCED LIFTS A MINIMUM 9" CLEARANCE SHALL BE PROVIDED ON EACH SIDE OF THE INSTALLED PIPE


DEPTH OF BEDDING MATERIAL BELOW PIPE 27" AND SMALLER

66" AND LARGER

LEGEND Bc = OUTSIDE DIAMETER D = INSIDE DIAMETER d = DEPTH OF BEDDING MATERIAL BELOW PIPE

REINFORCED CONCRETE PIPE (RCP) TRENCH DETAIL

GREATER THAN 5' FROM EDGE OF PAVEMENT NOT TO SCALE

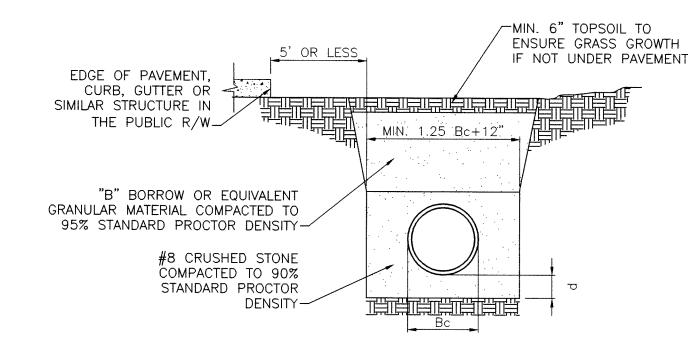

GREATER THAN 5' OF EDGE OF PAVEMENT NOTE:


> ALL BEDDING AND INITIAL BACKFILL SHALL BE INSTALLED IN 6" TO 12" BALANCED LIFTS A MINIMUM 9" CLEARANCE SHALL BE PROVIDED ON EACH SIDE OF THE INSTALLED PIPE

DEPTH OF BEDDING MATERIAL BELOW PIPE


27" AND SMALLER 30" TO 60" 66" AND LARGER


<u>LEGEND</u> Bc = OUTSIDE DIAMETER D = INSIDE DIAMETER d = DEPTH OF BEDDING MATERIAL BE!_OW PIPE


REINFORCED CONCRETE PIPE (9) (RCP) TRENCH DETAIL WITHIN THAN 5' OF EDGE OF PAVEMENT NOT TO SCALE

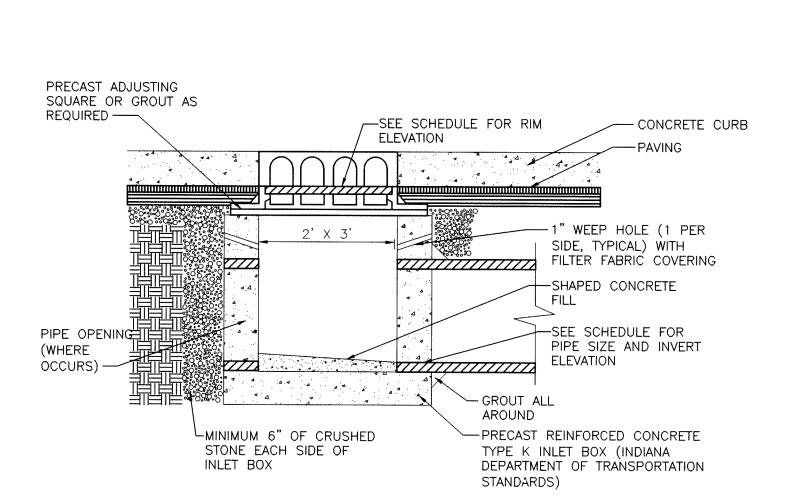





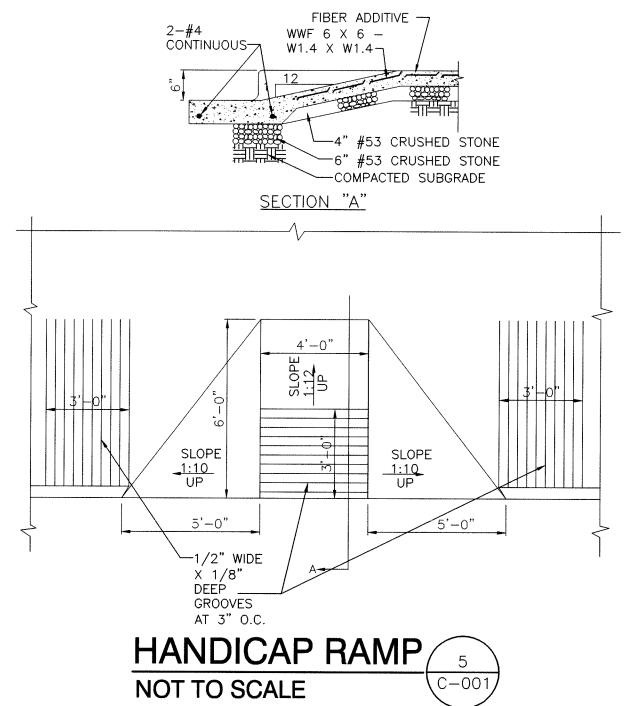


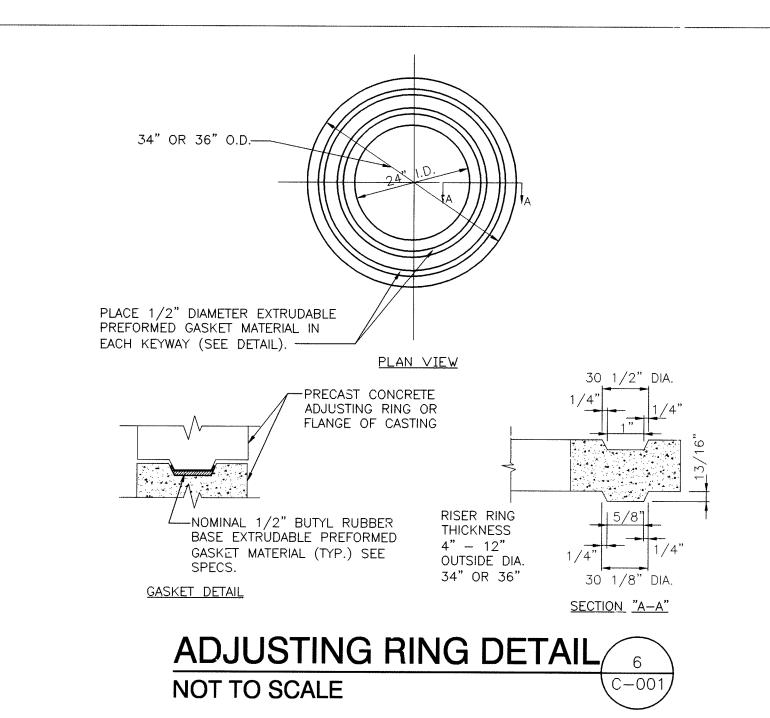

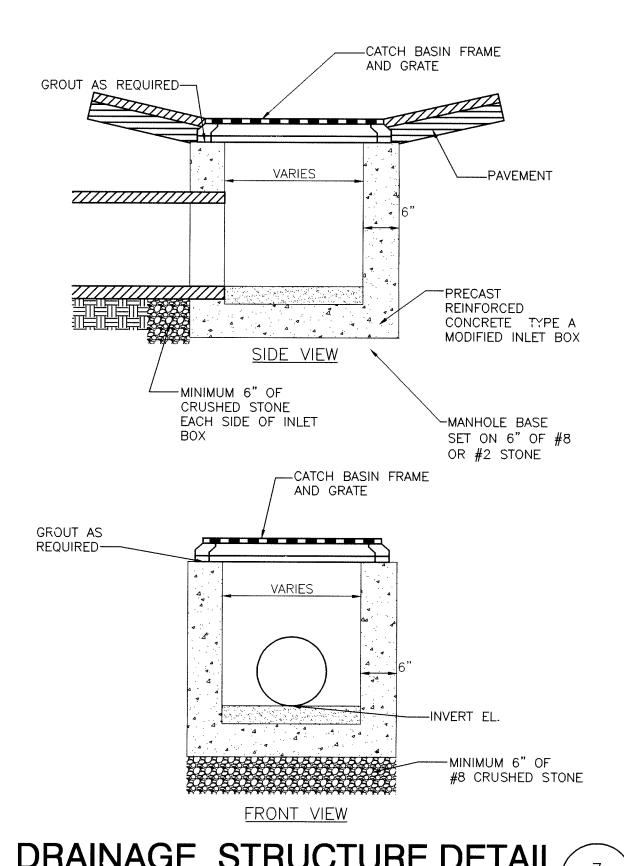

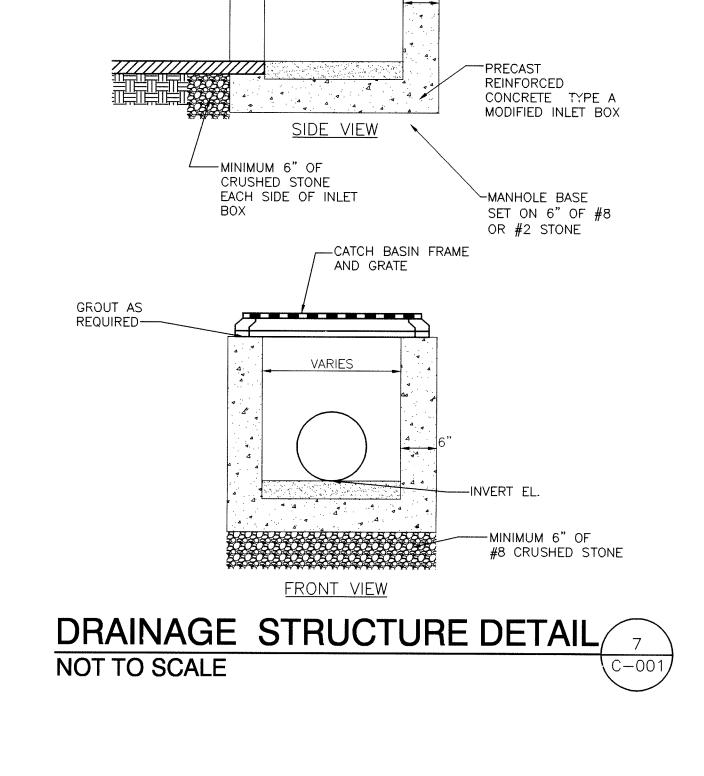

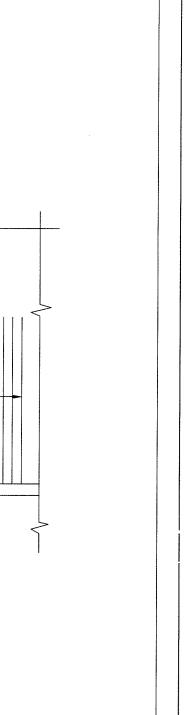

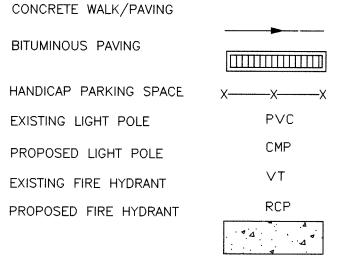

LEGEND

EXISTING ELEVATION


FINISH ELEVATION

EXISTING TOP OF CURB

FINISH TOP OF CURB

----- 726.0 ----- EXISTING CONTOUR LINE

726.0 FINISH CONTOUR LINE

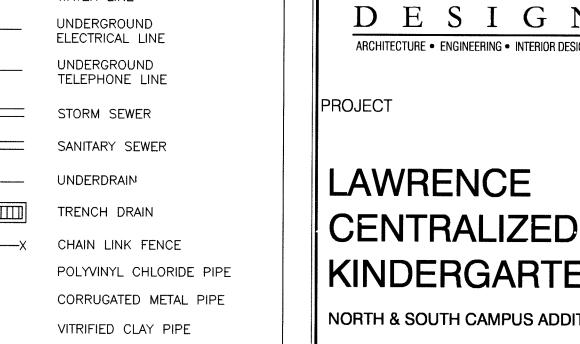


CONSTRUCTION FENCE


TREES AND SHRUBS

REINFORCED CONCRETE PIPE


CONCRETE SLAB

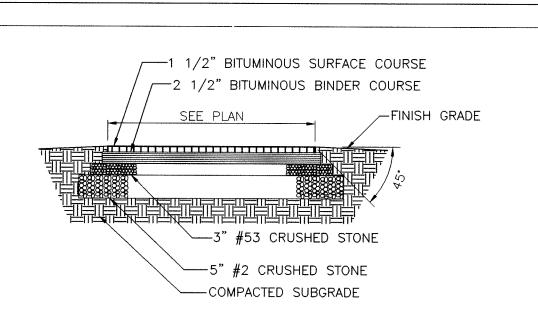




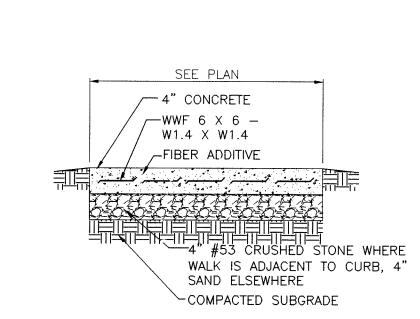



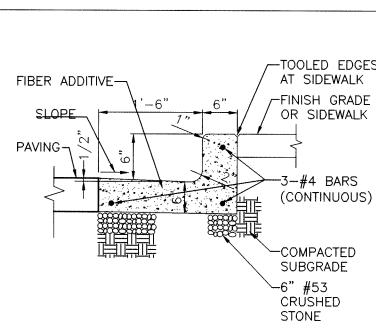


CHAIRBACK CURB/ NOT TO SCALE C - 001,

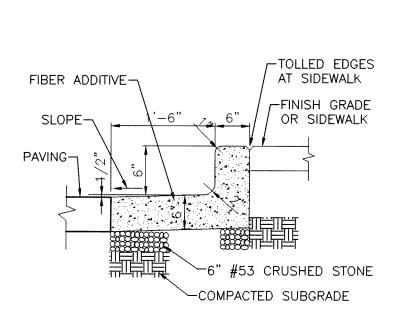

CHAIRBACK CURB (4) NOT TO SCALE



GIBRALTAR DESIGN C-001

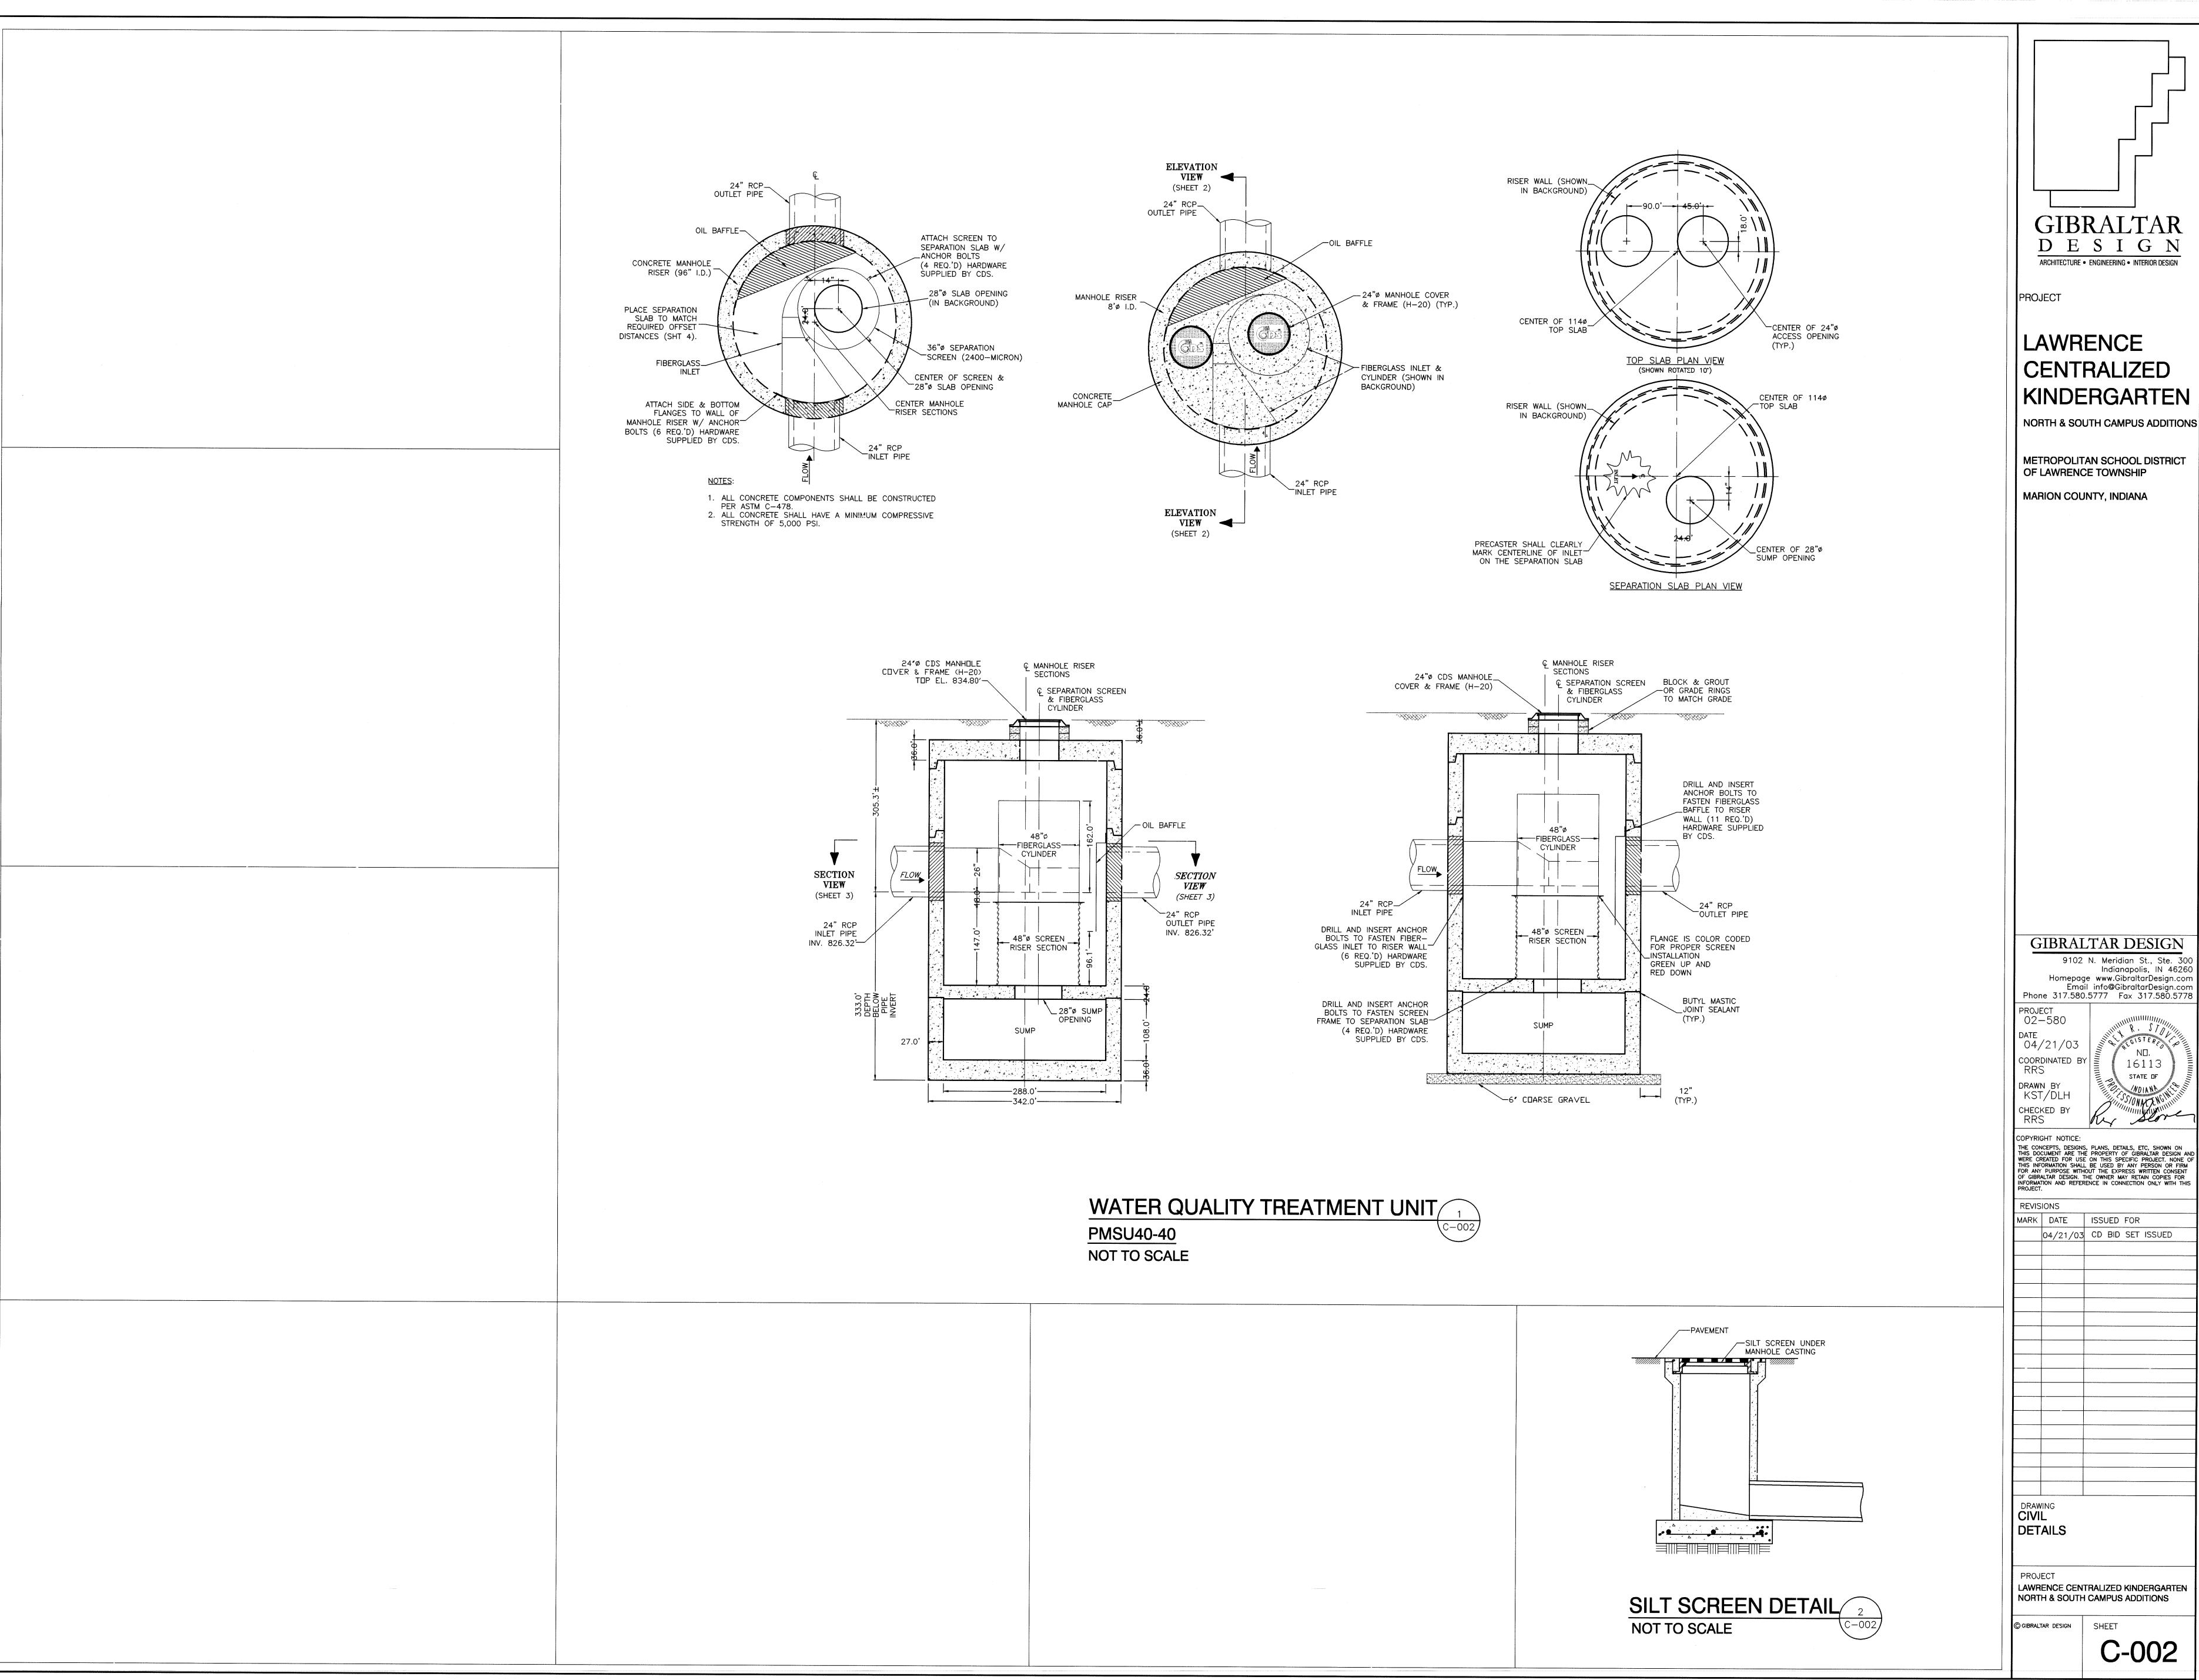



LAWRENCE CENTRALIZED KINDERGARTEN

NORTH & SOUTH CAMPUS ADDITIONS

METROPOLITAN SCHOOL DISTRICT


GIBRALTAR DESIGN

STATE OF

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MARK DATE ISSUED FOR 04/21/03 CD BID SET ISSUED


C-002

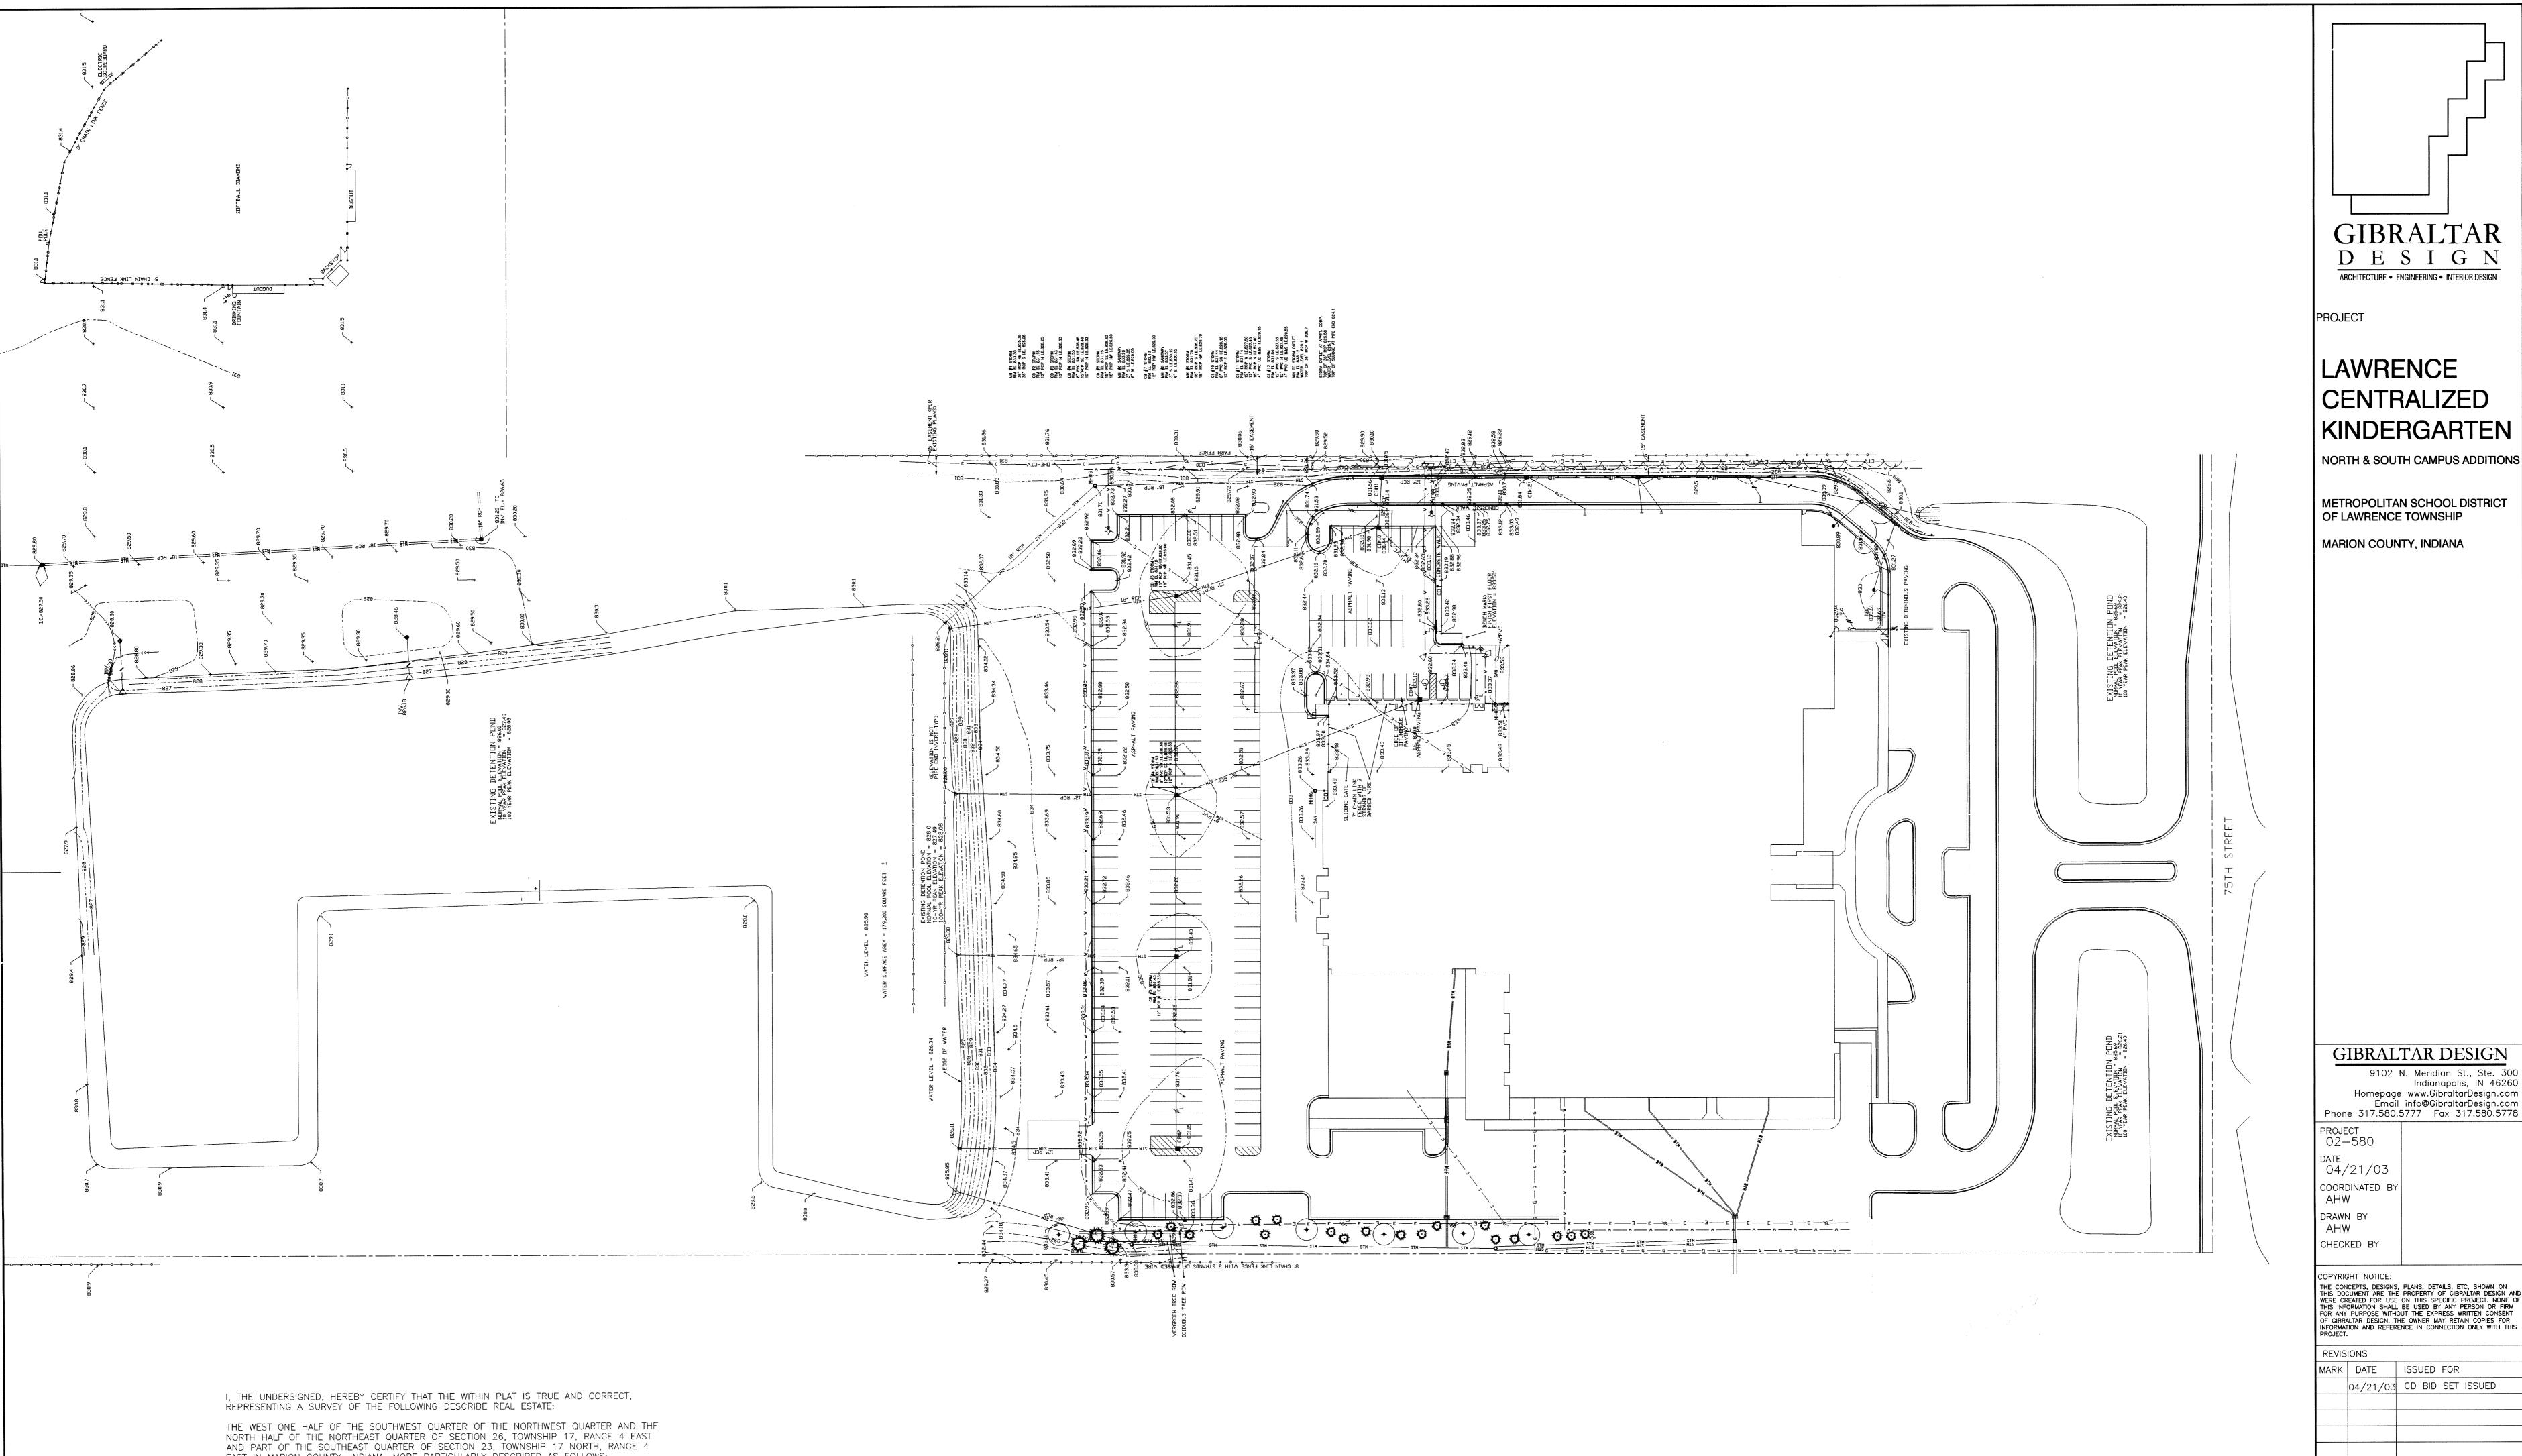


EAST IN MARION COUNTY, INDIANA, MORE PARTICULARLY DESCRIBED AS FOLLOWS:

BEGINNING AT THE SOUTHWEST CORNER OF THE NORTHEAST QUARTER OF SECTION 26, TOWNSHIP 17 NORTH, RANGE 4 EAST; THENCE NORTH 00 DEGREE 11 MINUTES 48 SECONDS EAST (ASSUMED BEARING) AND ON AND ALONG THE WEST LINE OF THE NORTHEAST QUARTER OF THE SAID SECTION 26, 2644.00 FEET TO THE NORTHWEST CORNER OF THE NORTHEAST QUARTER OF THE SAID SECTION 26; THENCE SOUTH 89 DEGREES 59 MINUTES 30 SECONDS EAST ON ALONG THE NORTH LINE OF THE NORTHEAST QUARTER OF SAID SECTION 26 AND THE SOUTH LINE OF THE SOUTHEAST QUARTER OF SECTION 23, TOWNSHIP 17 NORTH, RANGE 4 EAST, 1878.91 FEET; THENCE NORTH 00 DEGREES 00 MINUTES 52 SECONDS EAST PARALLEL WITH THE EAST LINE OF THE SOUTHEAST QUARTER OF SAID SECTION 23, 102.00 FELT; THENCE SOUTH 89 DEGREES 59 MINUTES 30 SECONDS EAST PARALLEL WITH THE SOUTH LINE OF THE SOUTHEAST QUARTER OF SAID SECTION 23, 600.00 FEET TO THE EAST LINE OF THE SOUTHEAST QUARTER OF SAID SECTION 23; THENCE SOUTH 00 DEGREES 00 MINUTES 52 SECONDS WEST ON AND ALONG THE EAST LINE OF THE SOUTHEAST QUARTER OF SAID SECTION 23;102.00 FEET TO THE NORTHEAST CORNER OF THE NORTHEAST QUARTER OF SECTION 26, TOWNSHIP 17 NORTH, RANGE 4 EAST; THENCE SOUTH 00 DEGREES 13 MINUTES 12 SECONDS WEST ON AND ALONG THE EAST LINE OF THE NORTHEAST QUARTER OF SAID SECTION 26, 1321.82 FEET TO THE SOUTHEAST CORNER OF THE NORTH HALF OF THE NORTHEAST QUARTER OF SAID SECTION 26; THENCE NORTH 89 DEGREES 59 MINUTES 45 SECONDS WEST ON AND ALONG THE SOUTH LINE OF THE NORTH HALF OF THE NORTHEAST QUARTER OF SAID SECTION 26. 1858.78 FEET TO THE NORTHEAST CORNER OF THE WEST HALF OF THE SOUTHWEST QUARTER OF THE NORTHEAST QUARTER OF SAID SECTION 26; THENCE SOUTH 00 DEGREES 12 MINUTES 09 SECONDS WEST AND ALONG THE EAST LINE OF THE WEST HALF OF THE SOUTHWEST QUARTER OF THE NORTHEAST QUARTER OF SAID SECTION 26, 1321.96 FEET TO THE SOUTHEAST CORNER OF THE WEST HALF OF THE SOUTHWEST QUARTER OF THE NORTHEAST QUARTER OF SAID SECTION 26; THENCE NORTH 90 DEGREES 00 MINUTES 00 SECONDS WEST ON AND ALONG THE SOUTH LINE OF THE WEST HALF OF THE SOUTHWEST QUARTER OF THE NORTHEAST QUARTER OF SAID SECTION 26, 619.46 FEET TO THE PLACE OF BEGINNING, CONTAINING 95.42 ACRES, MORE OR LESS. SUBJECT TO ALL LEGAL EASEMENTS AND RIGHTS OF WAY.

I WILL FURTHER CERTIFY THAT CORNERS WERE ESTABLISHED AND MARKED AS INDICATED ON THE WITHIN PLAT. CERTIFIED MAY 3, 1972

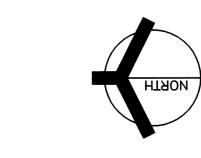

CIVIL SITE SURVEY

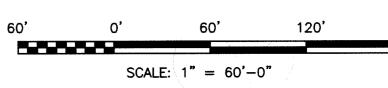

LAWRENCE CENTRALIZED KINDERGARTEN NORTH & SOUTH CAMPUS ADDITIONS

DRAWING

SITE SURVEY

GIBRALTAR DESIGN SHEET

9102 N. Meridian St., Ste. 30


Homepage www.GibraltarDesign.com


04/21/03 CD BID SET ISSUED


Indianapolis, IN 46260


GIBRALTAR


D E S I G N ARCHITECTURE • ENGINEERING • INTERIOR DESIGN

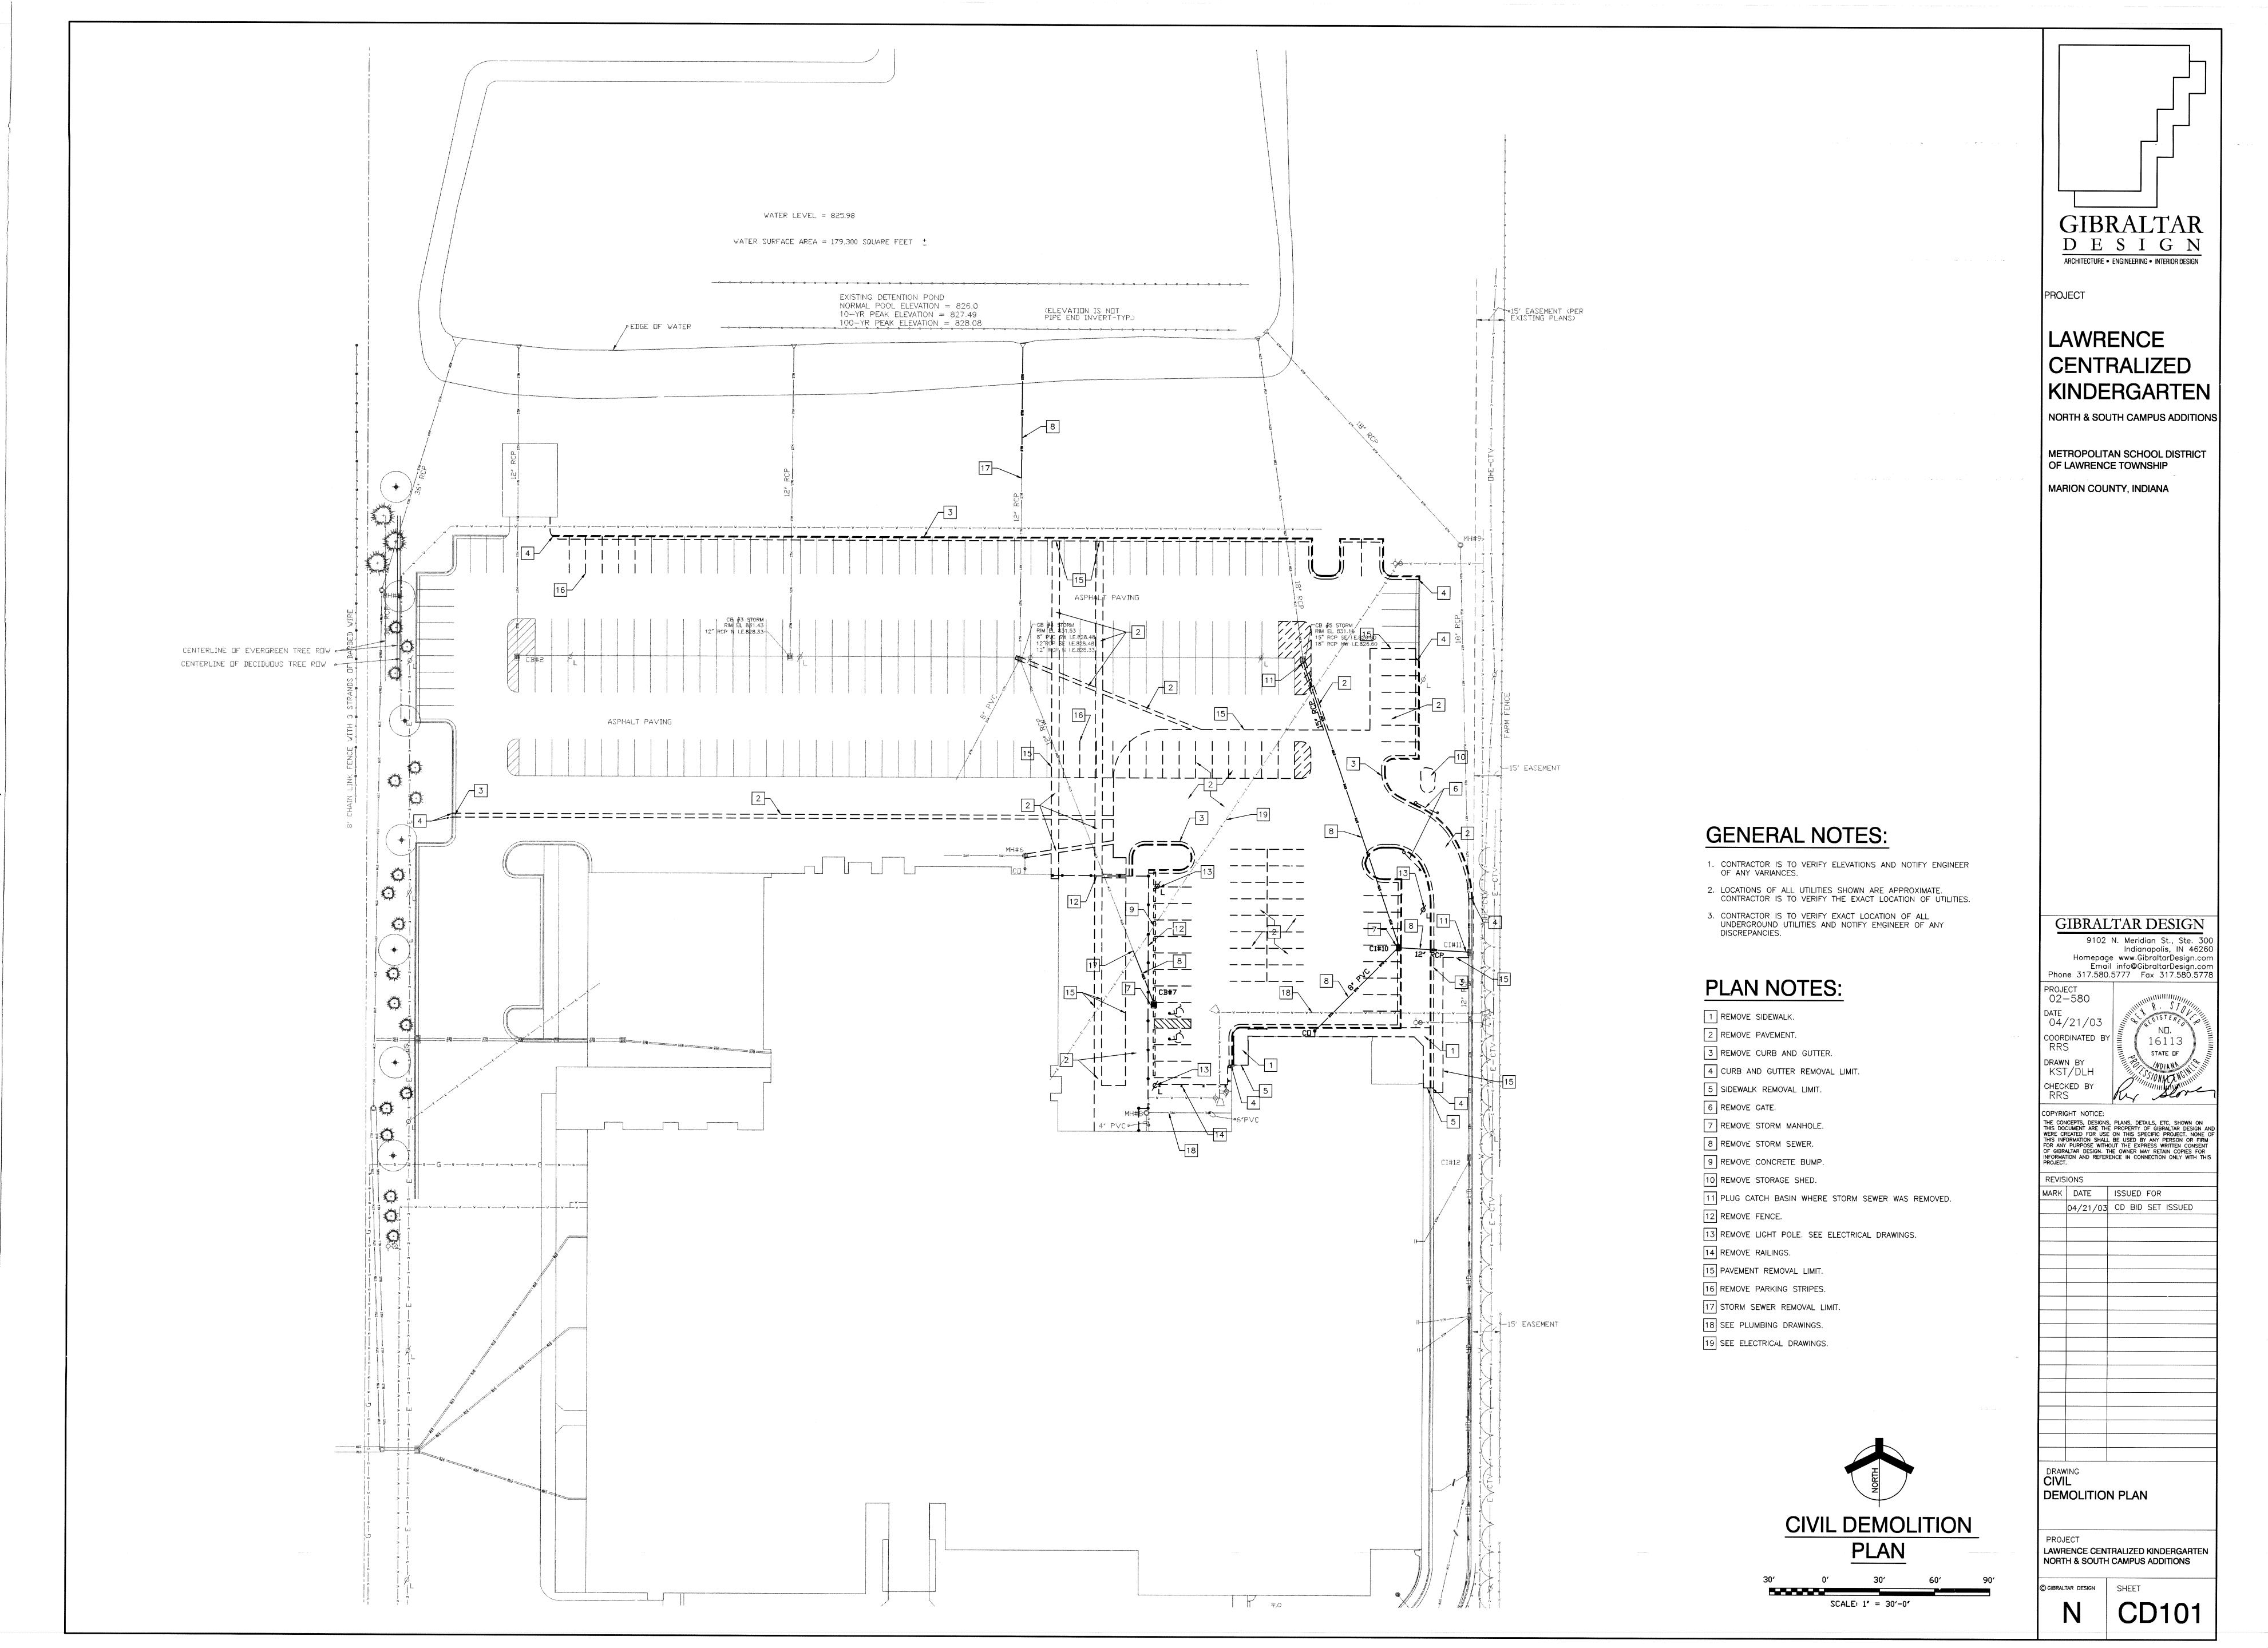


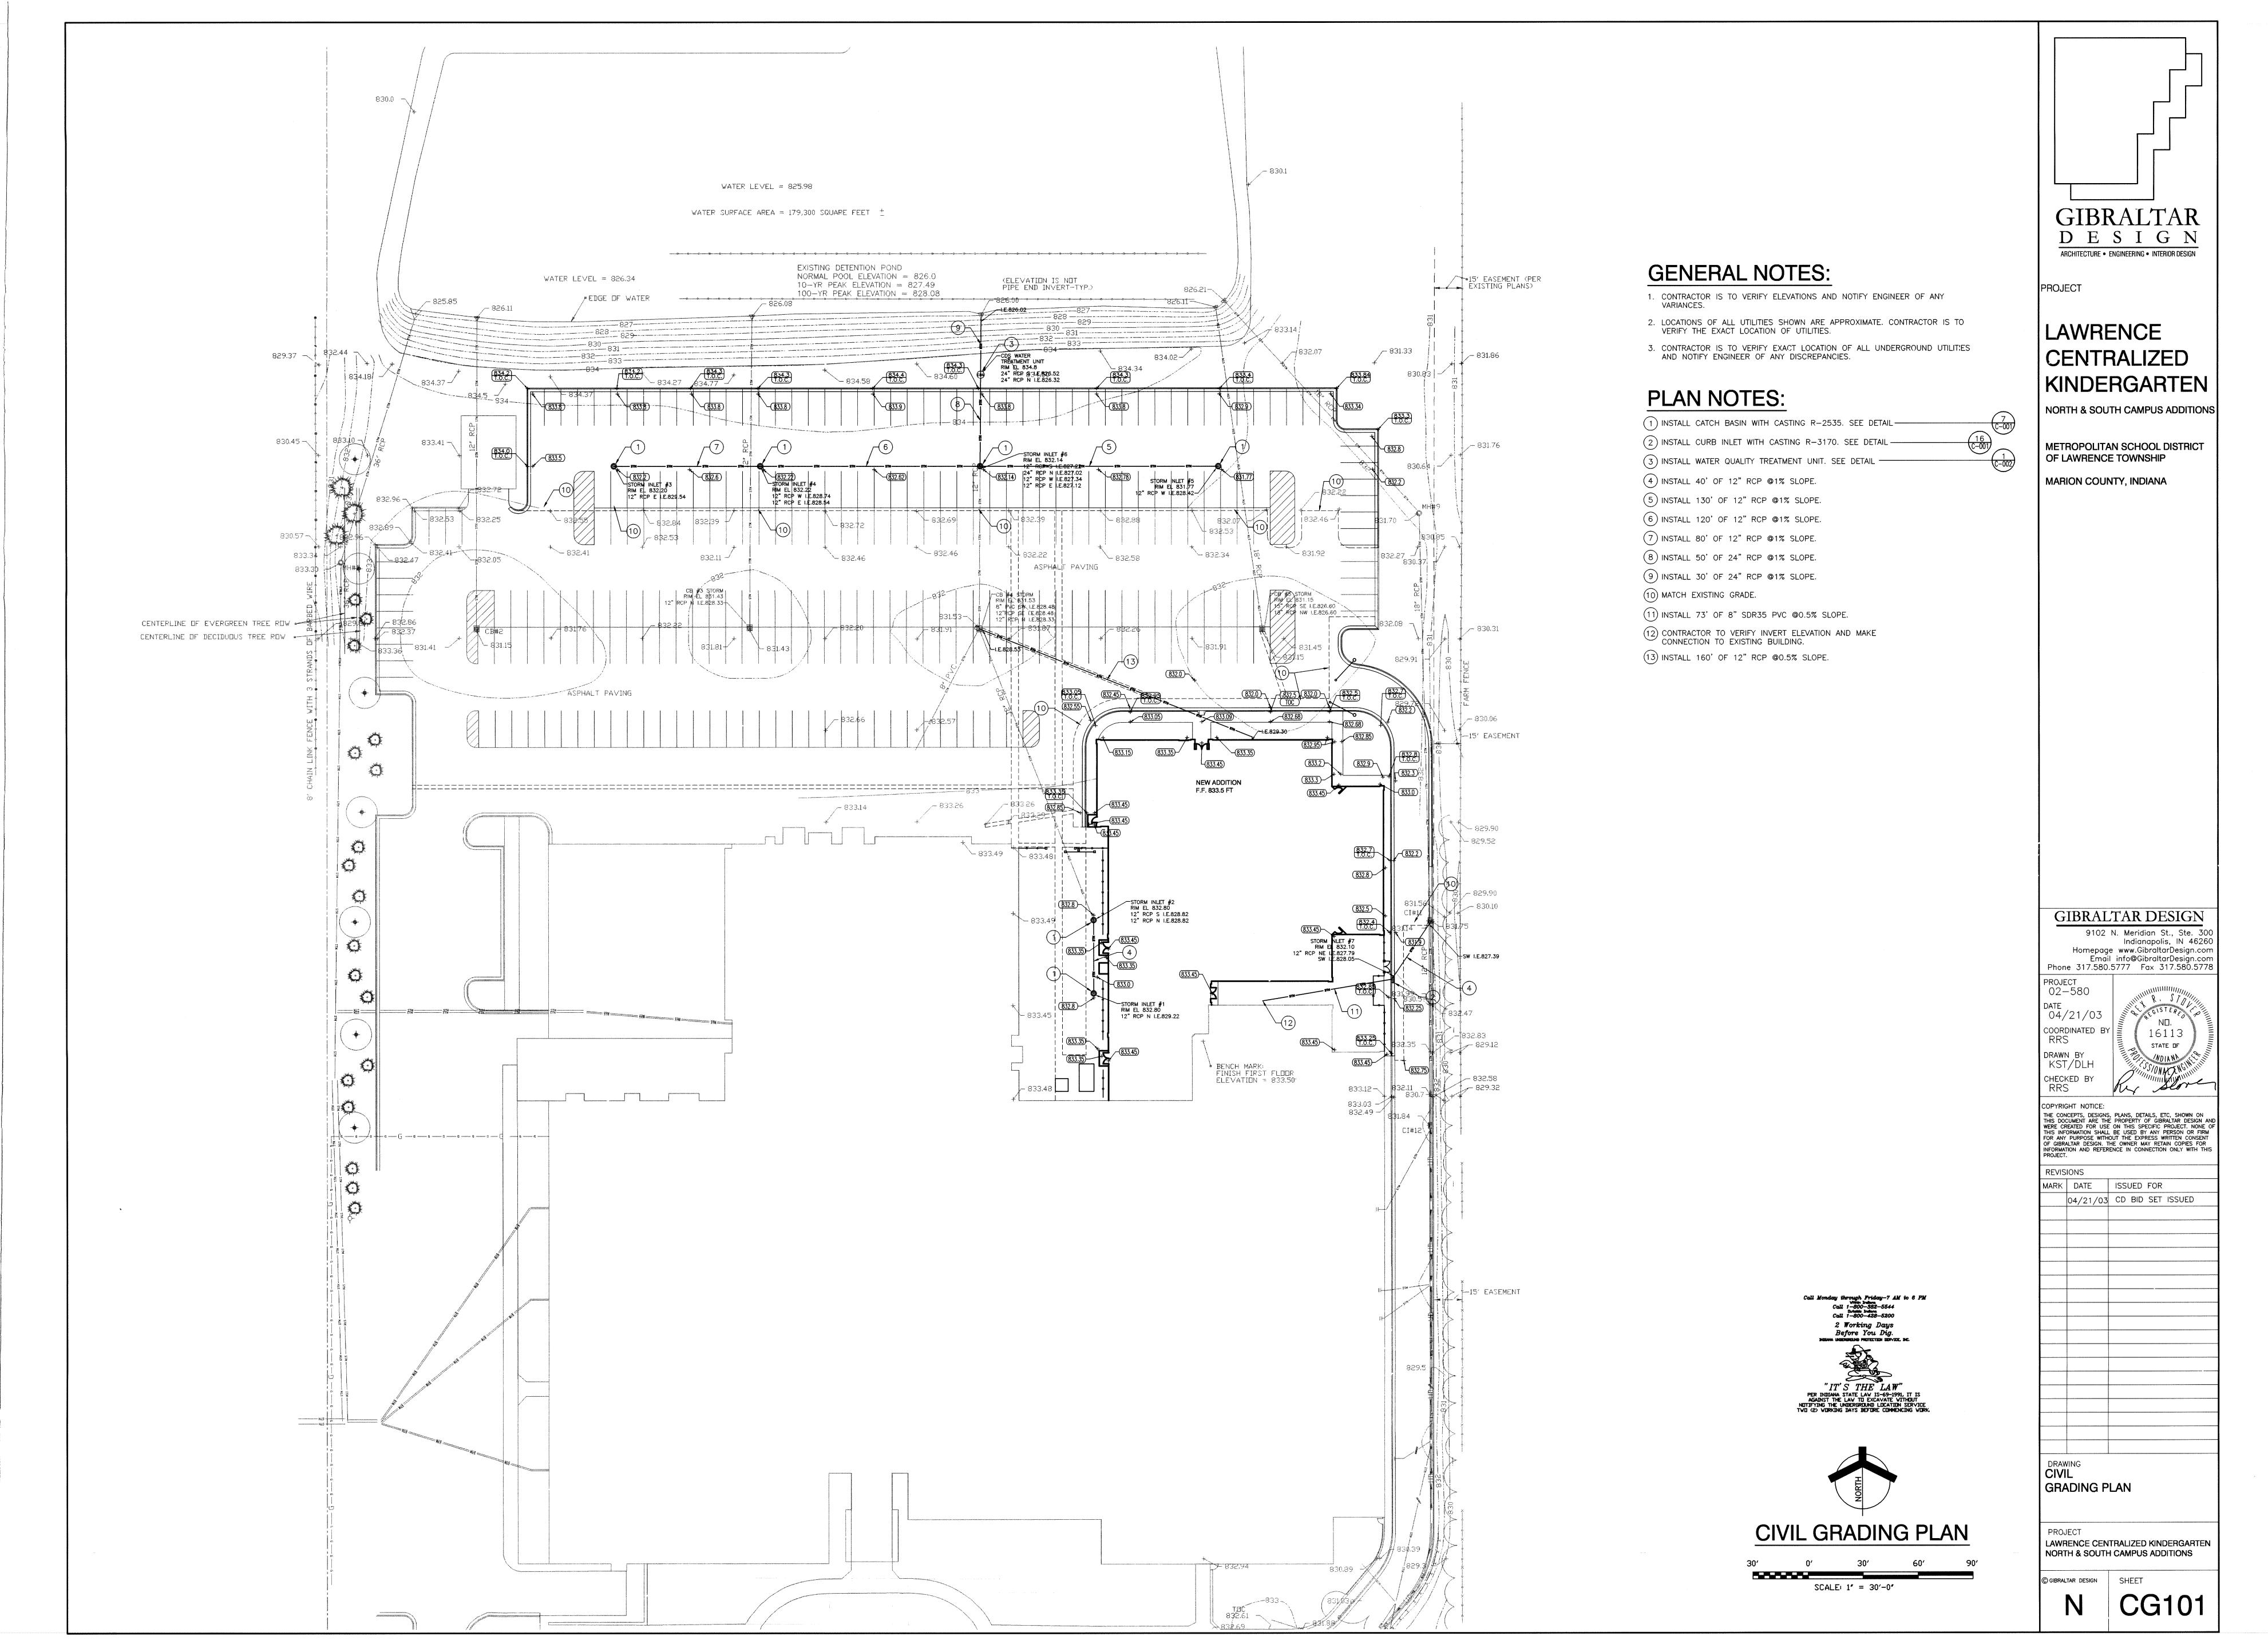


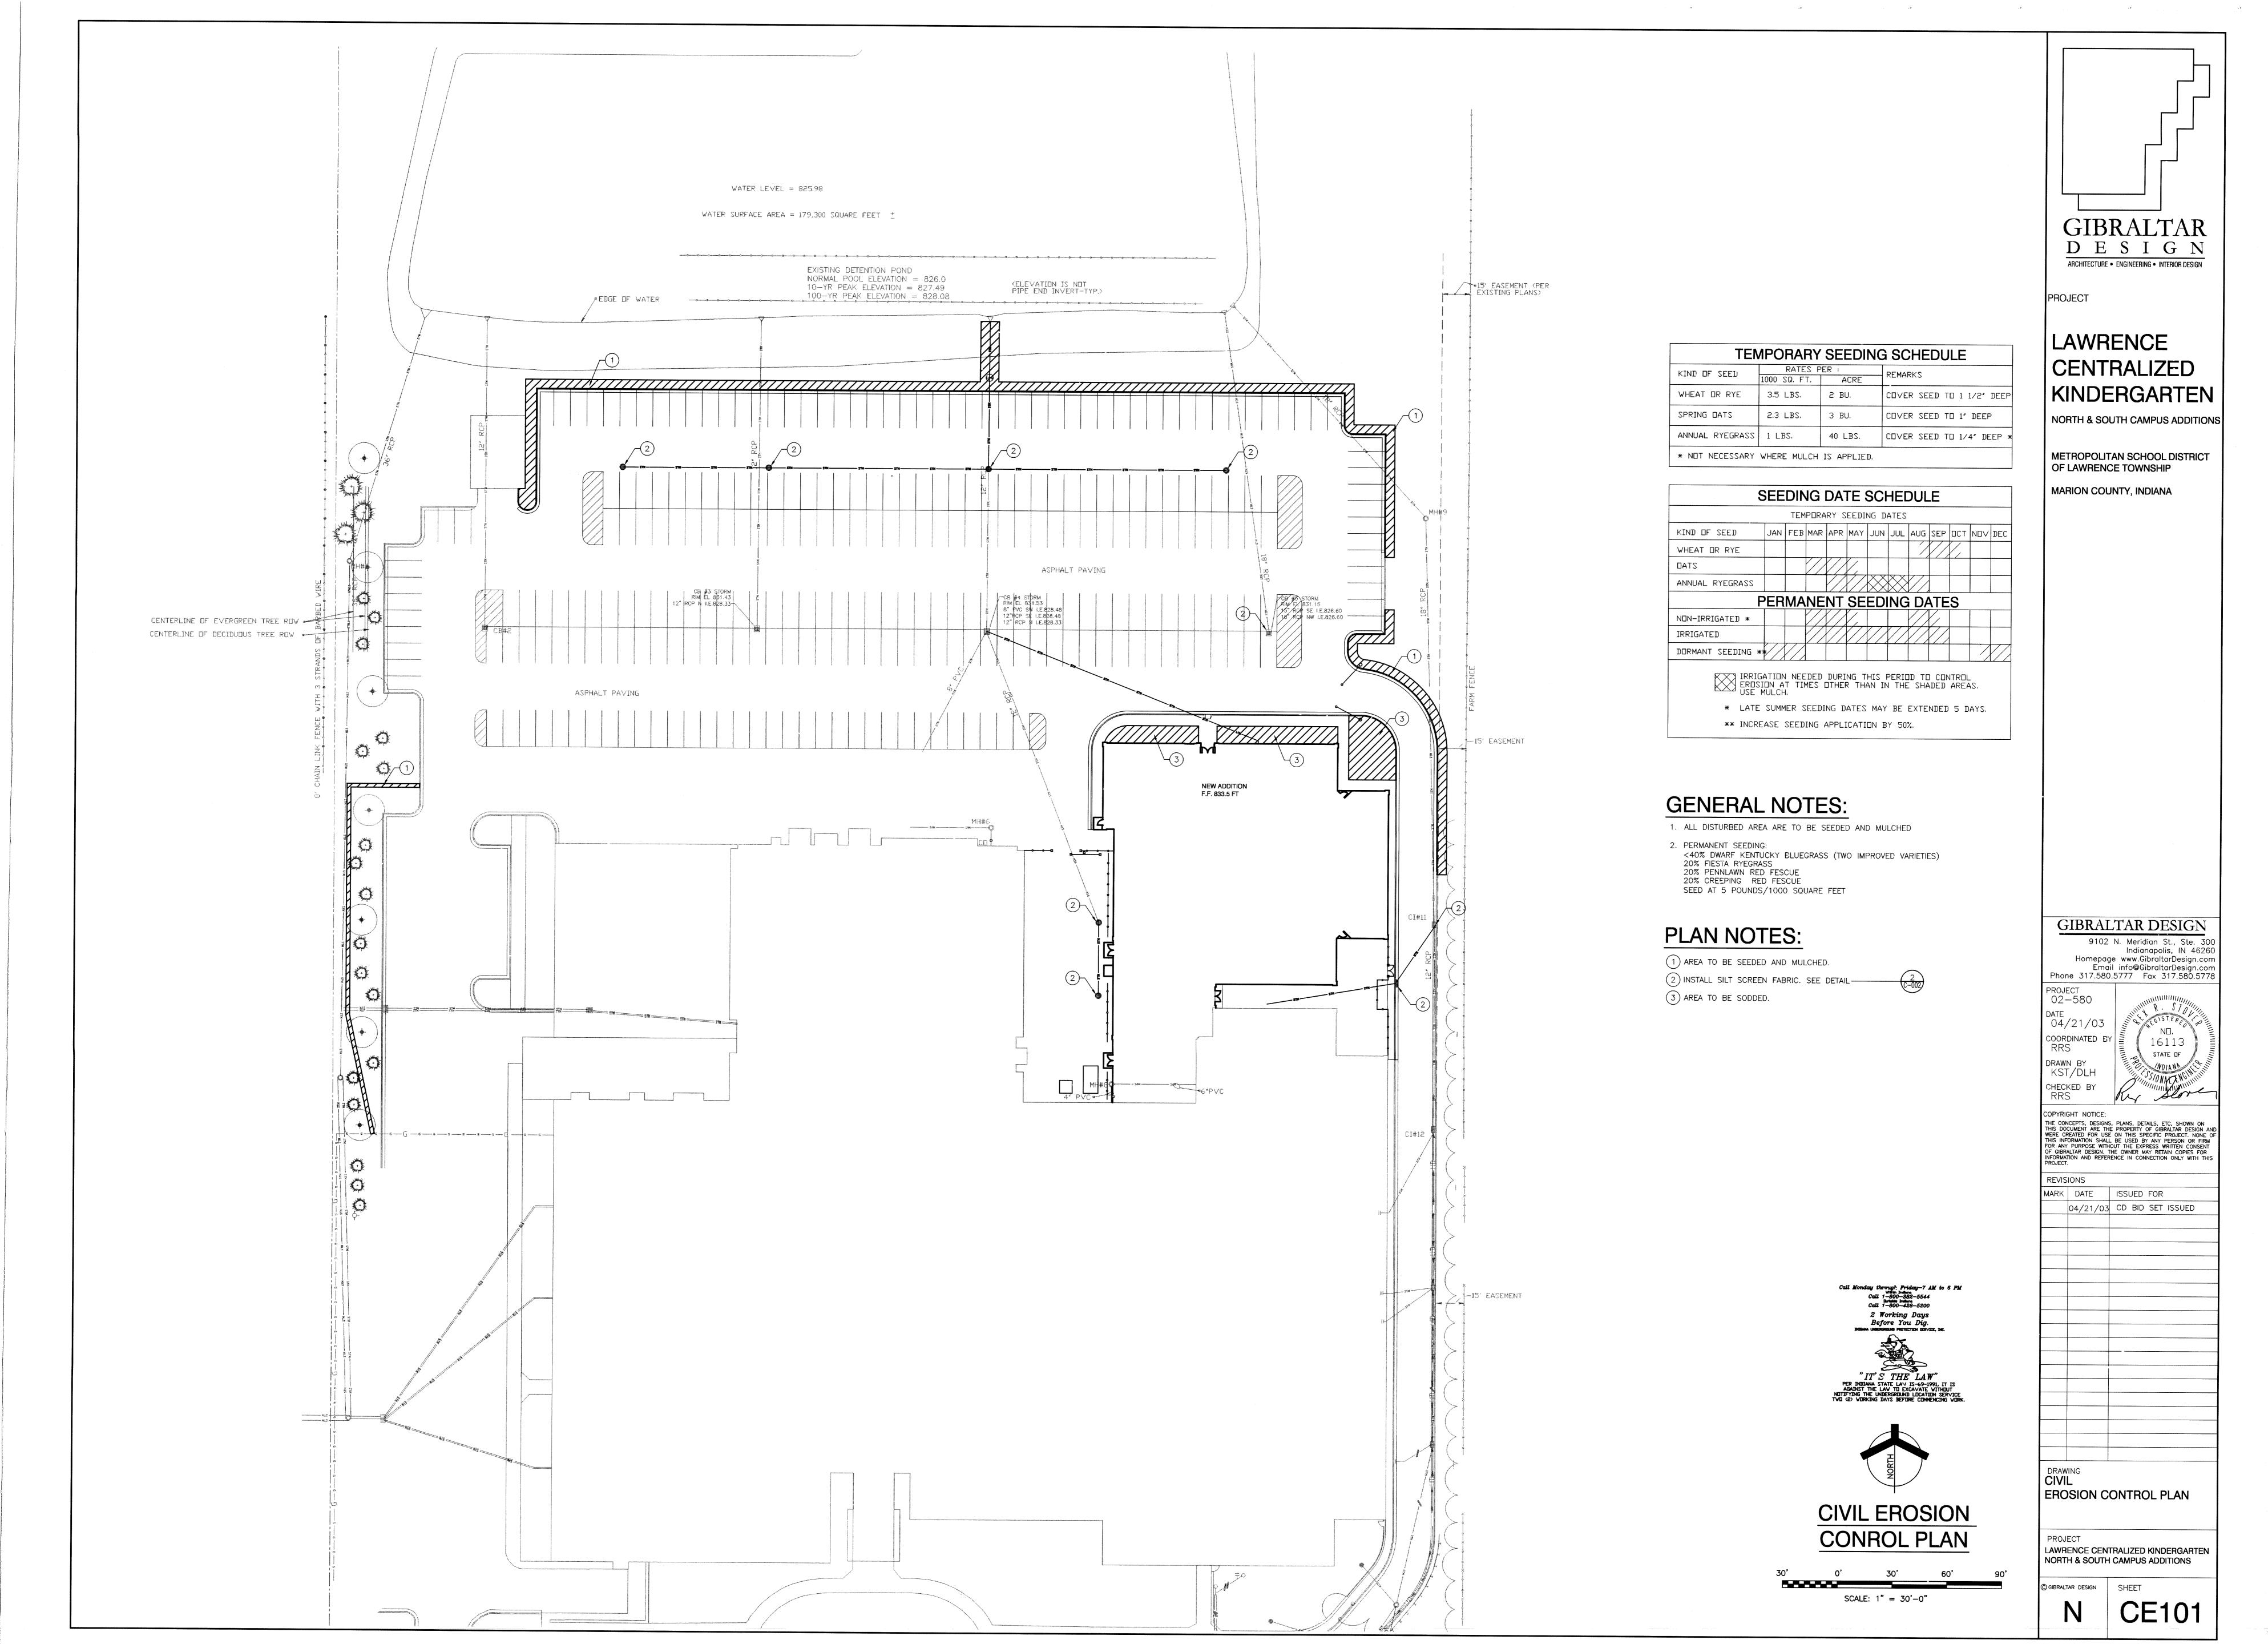


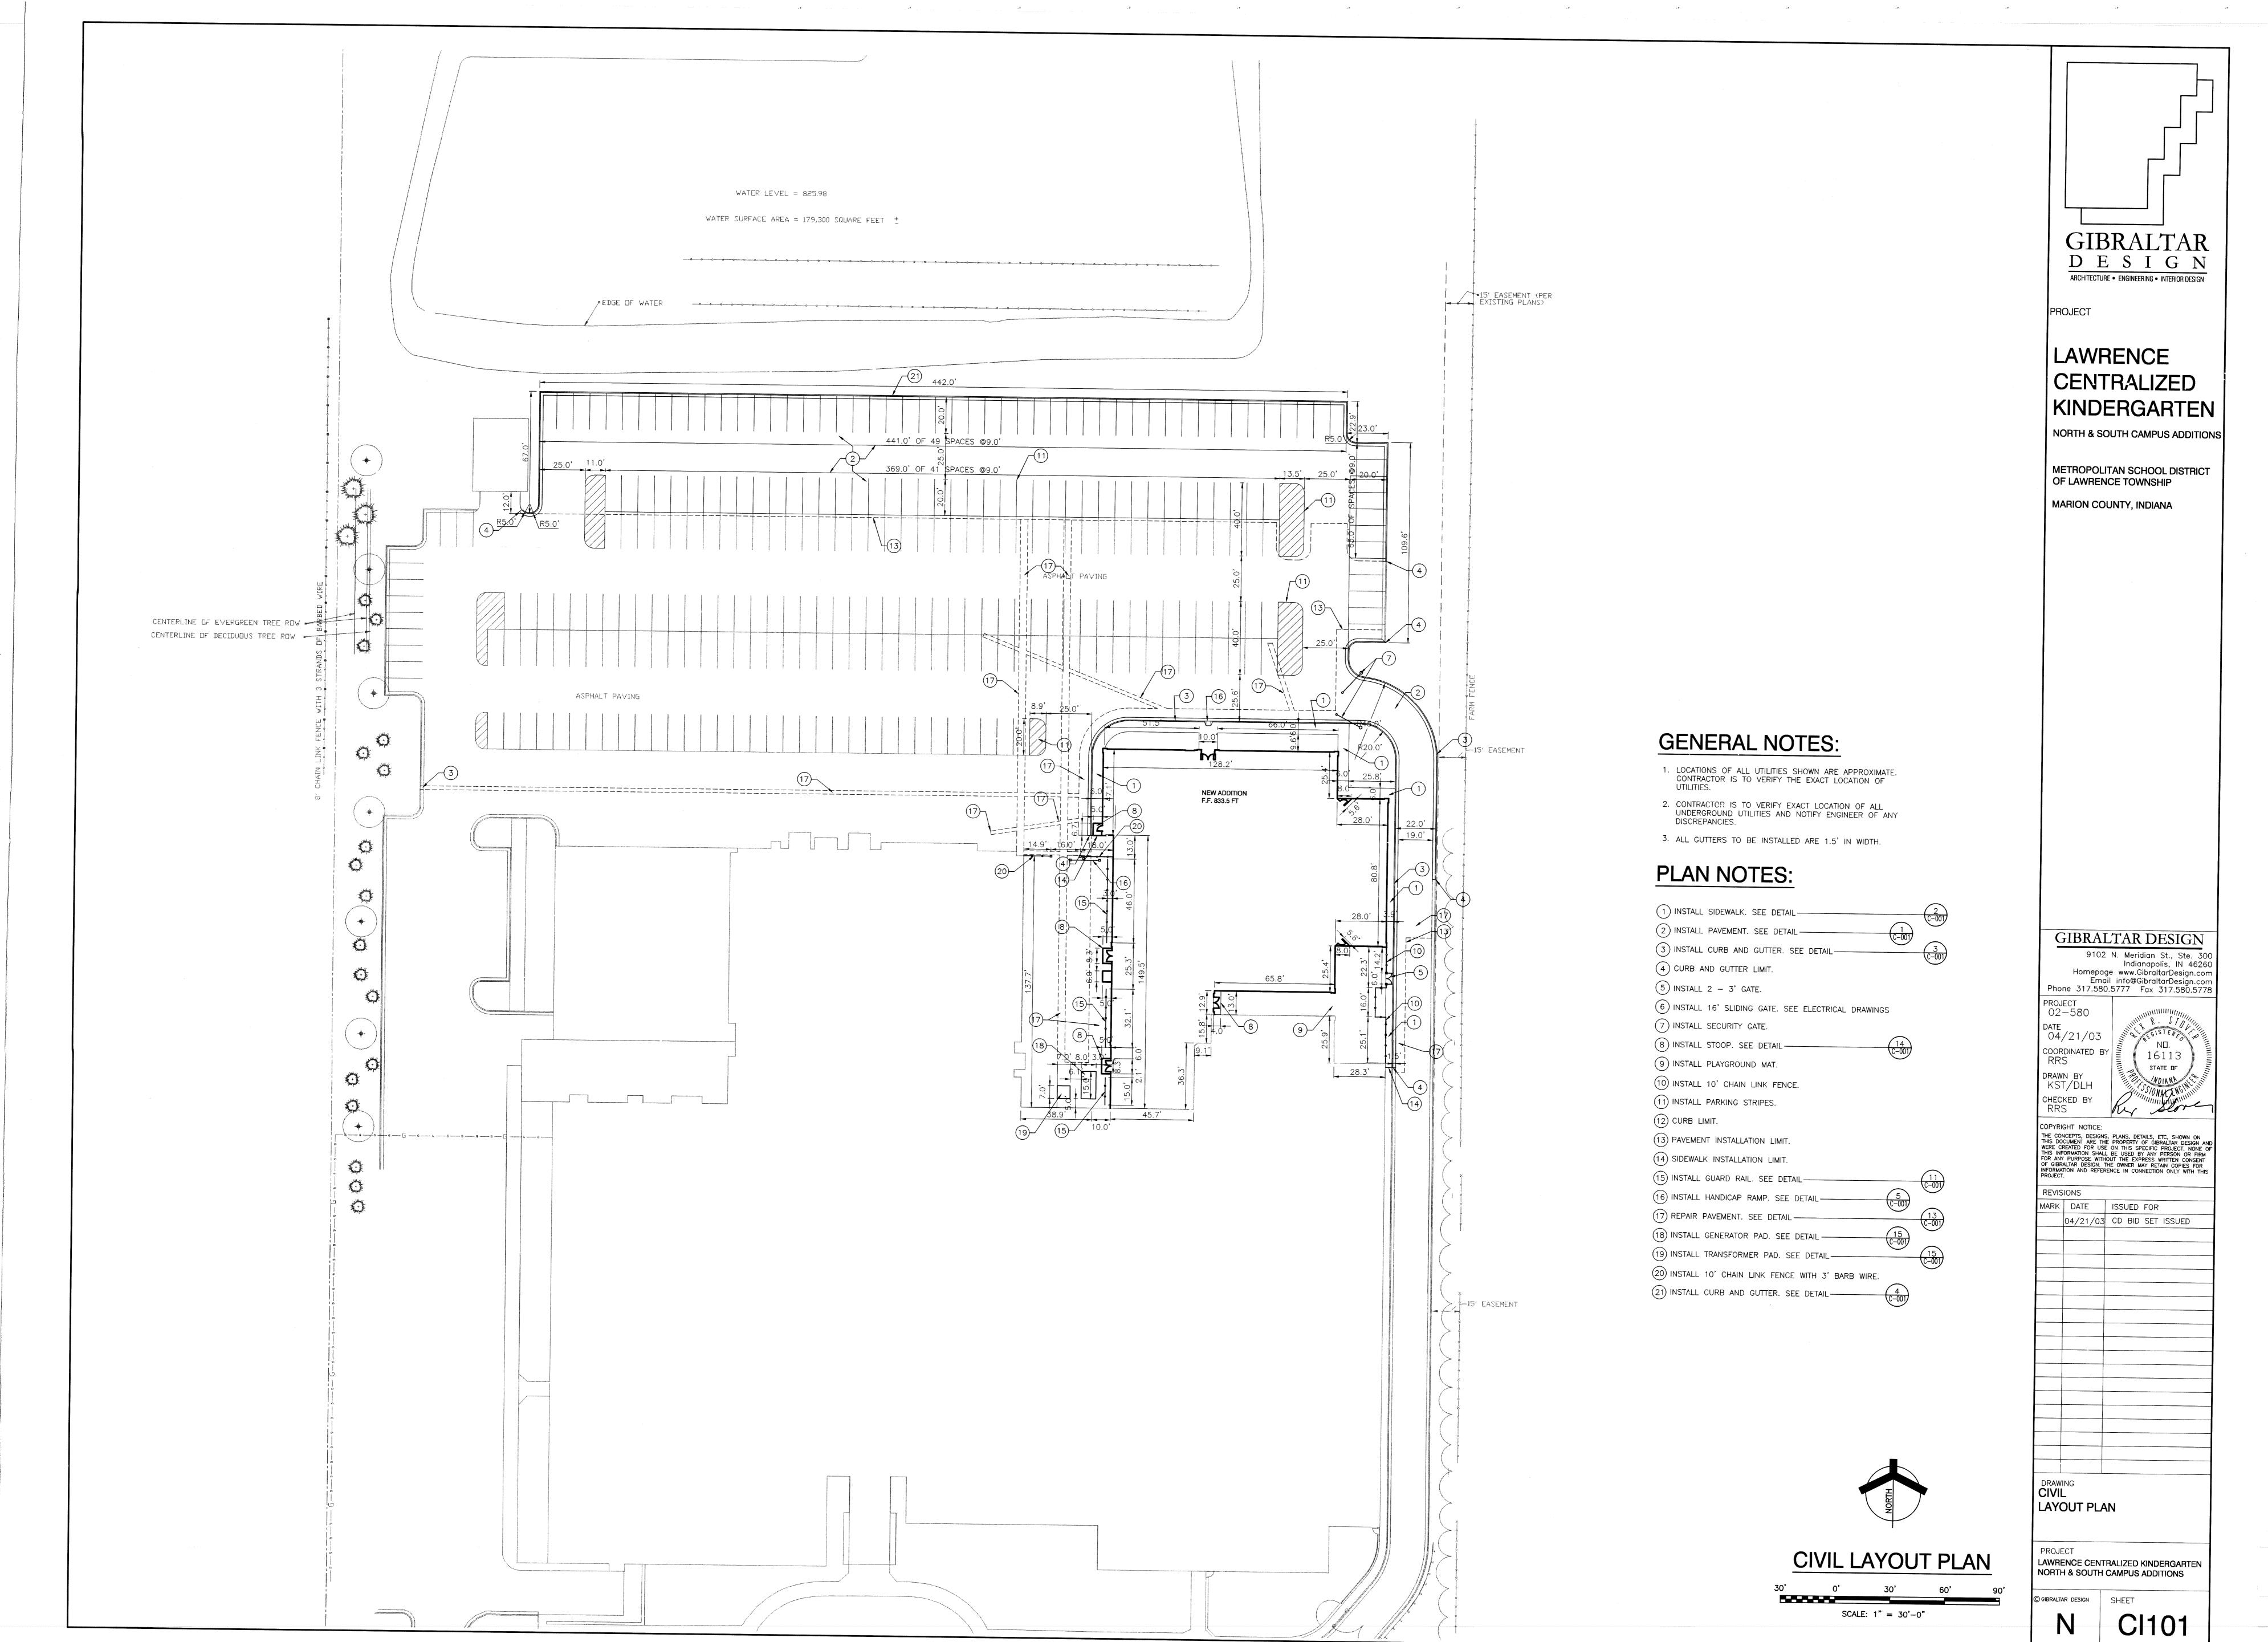


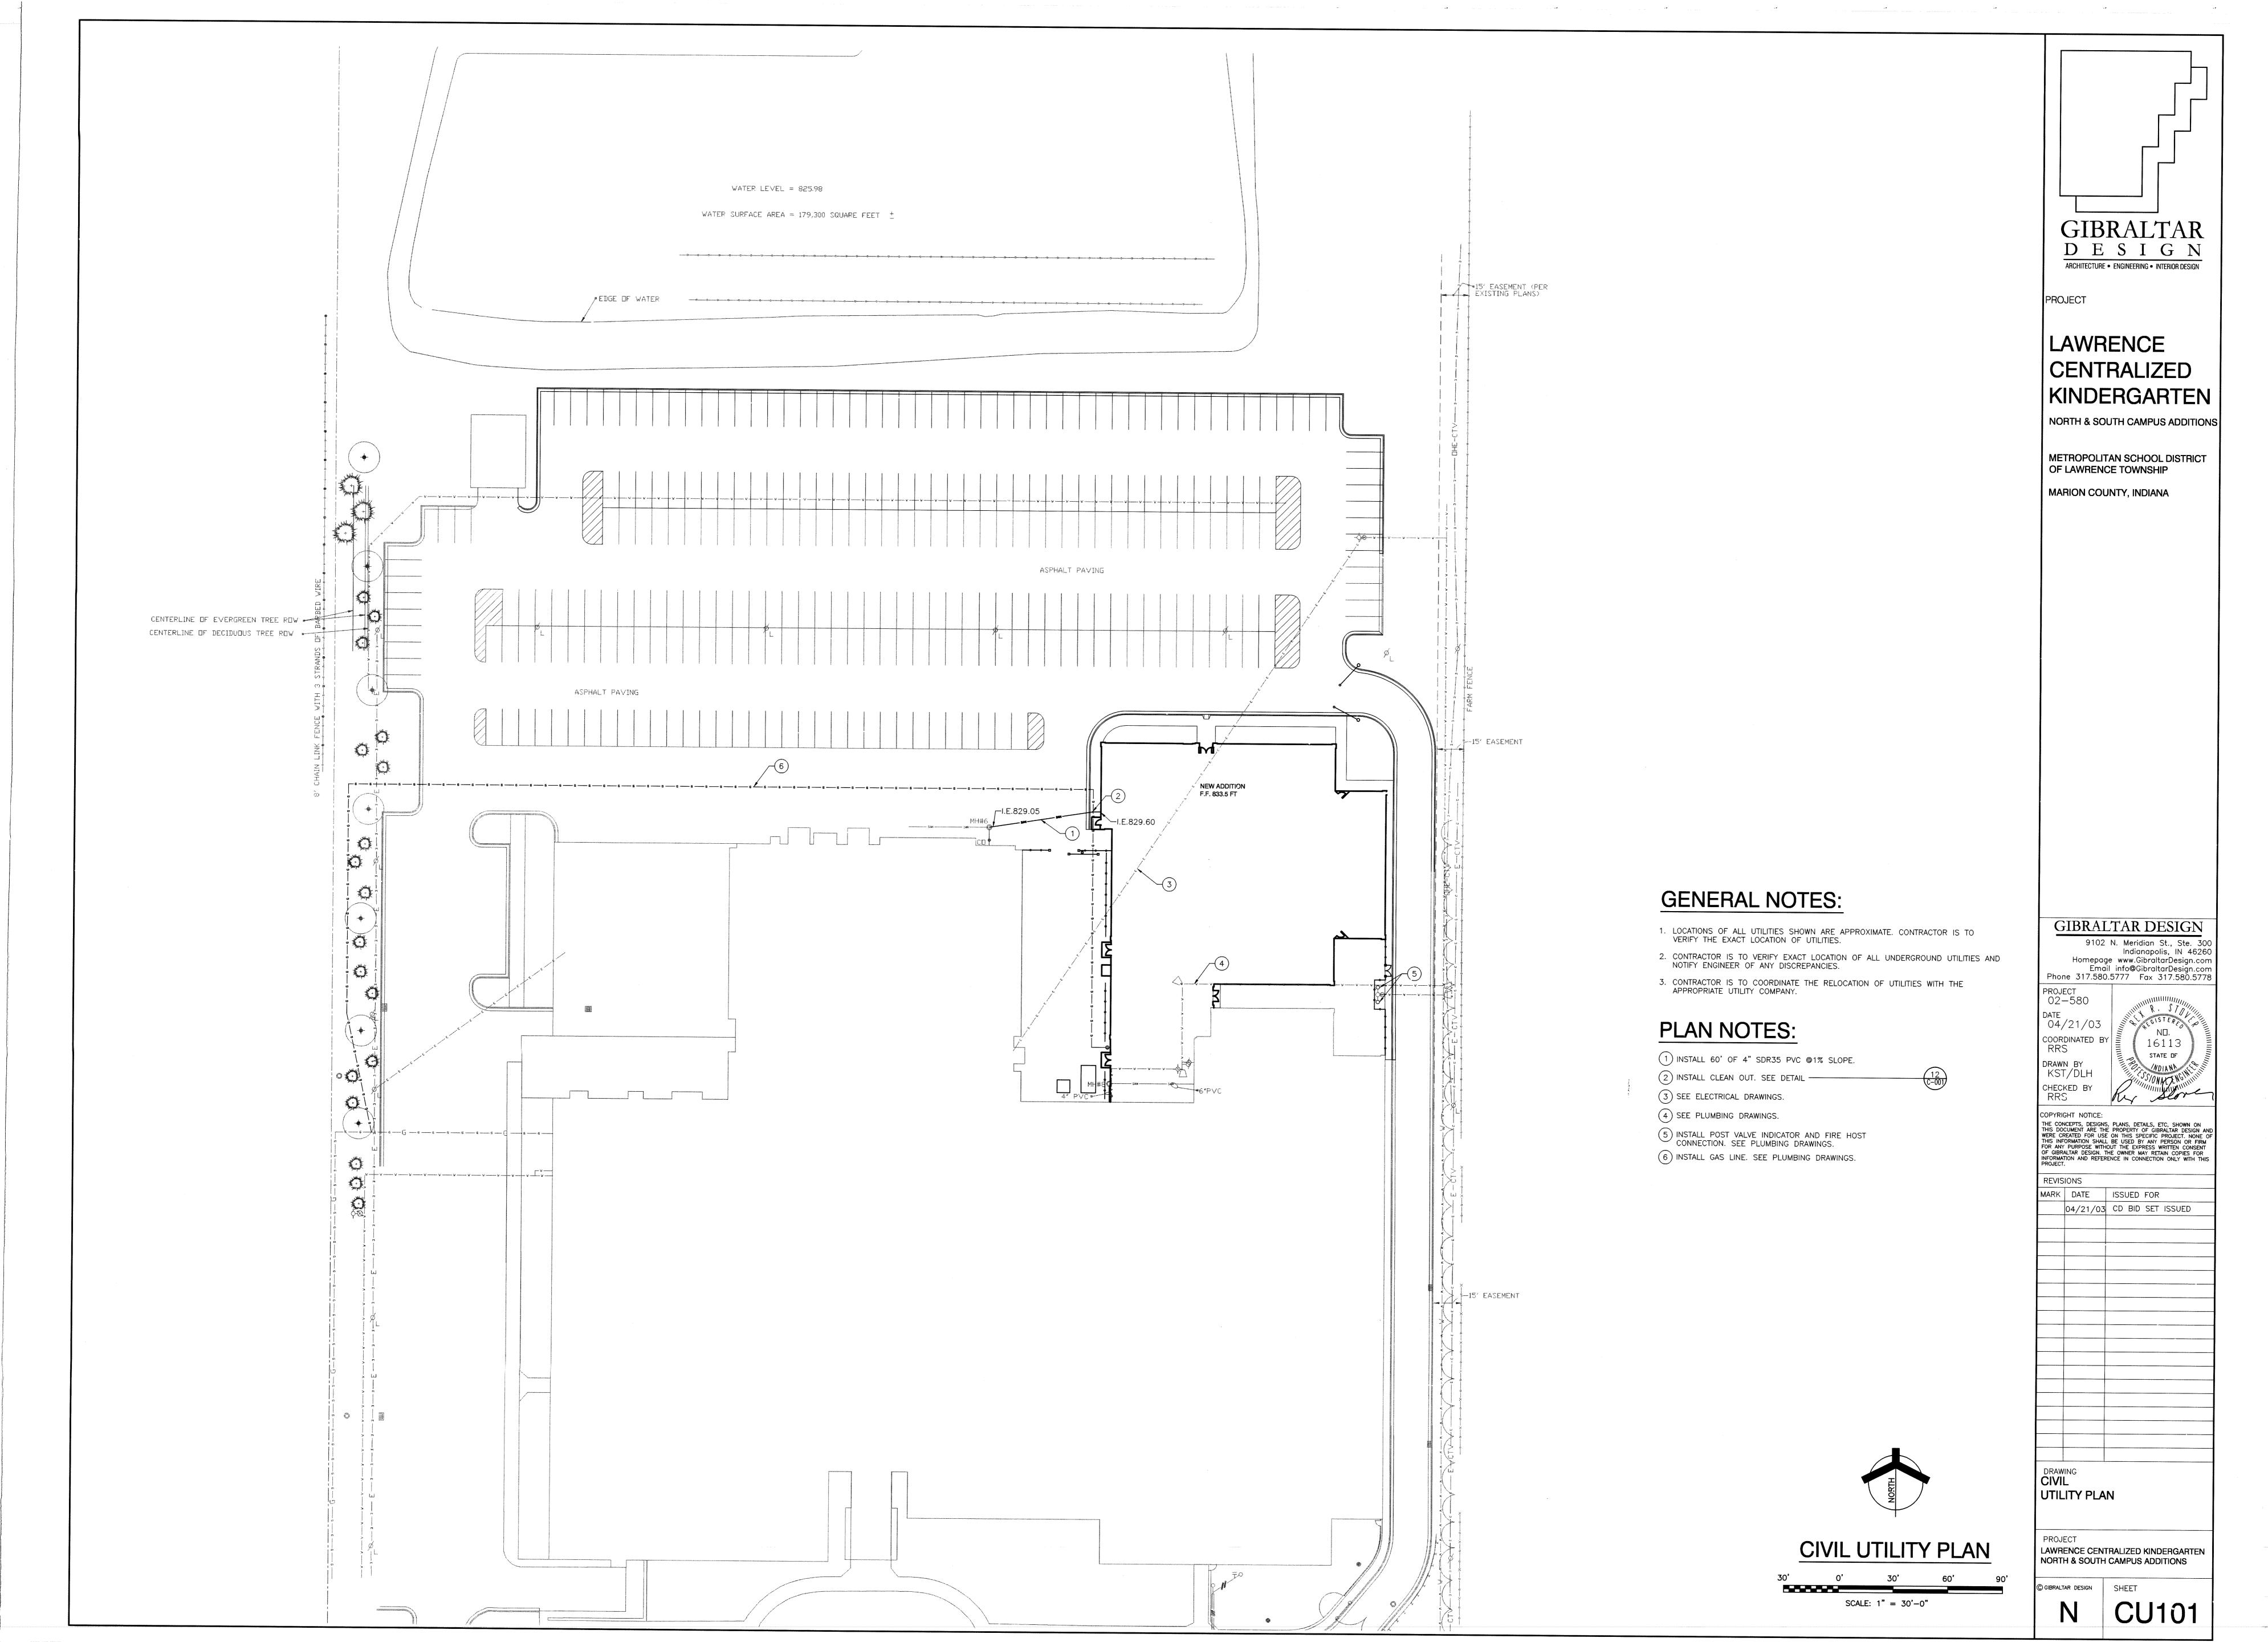


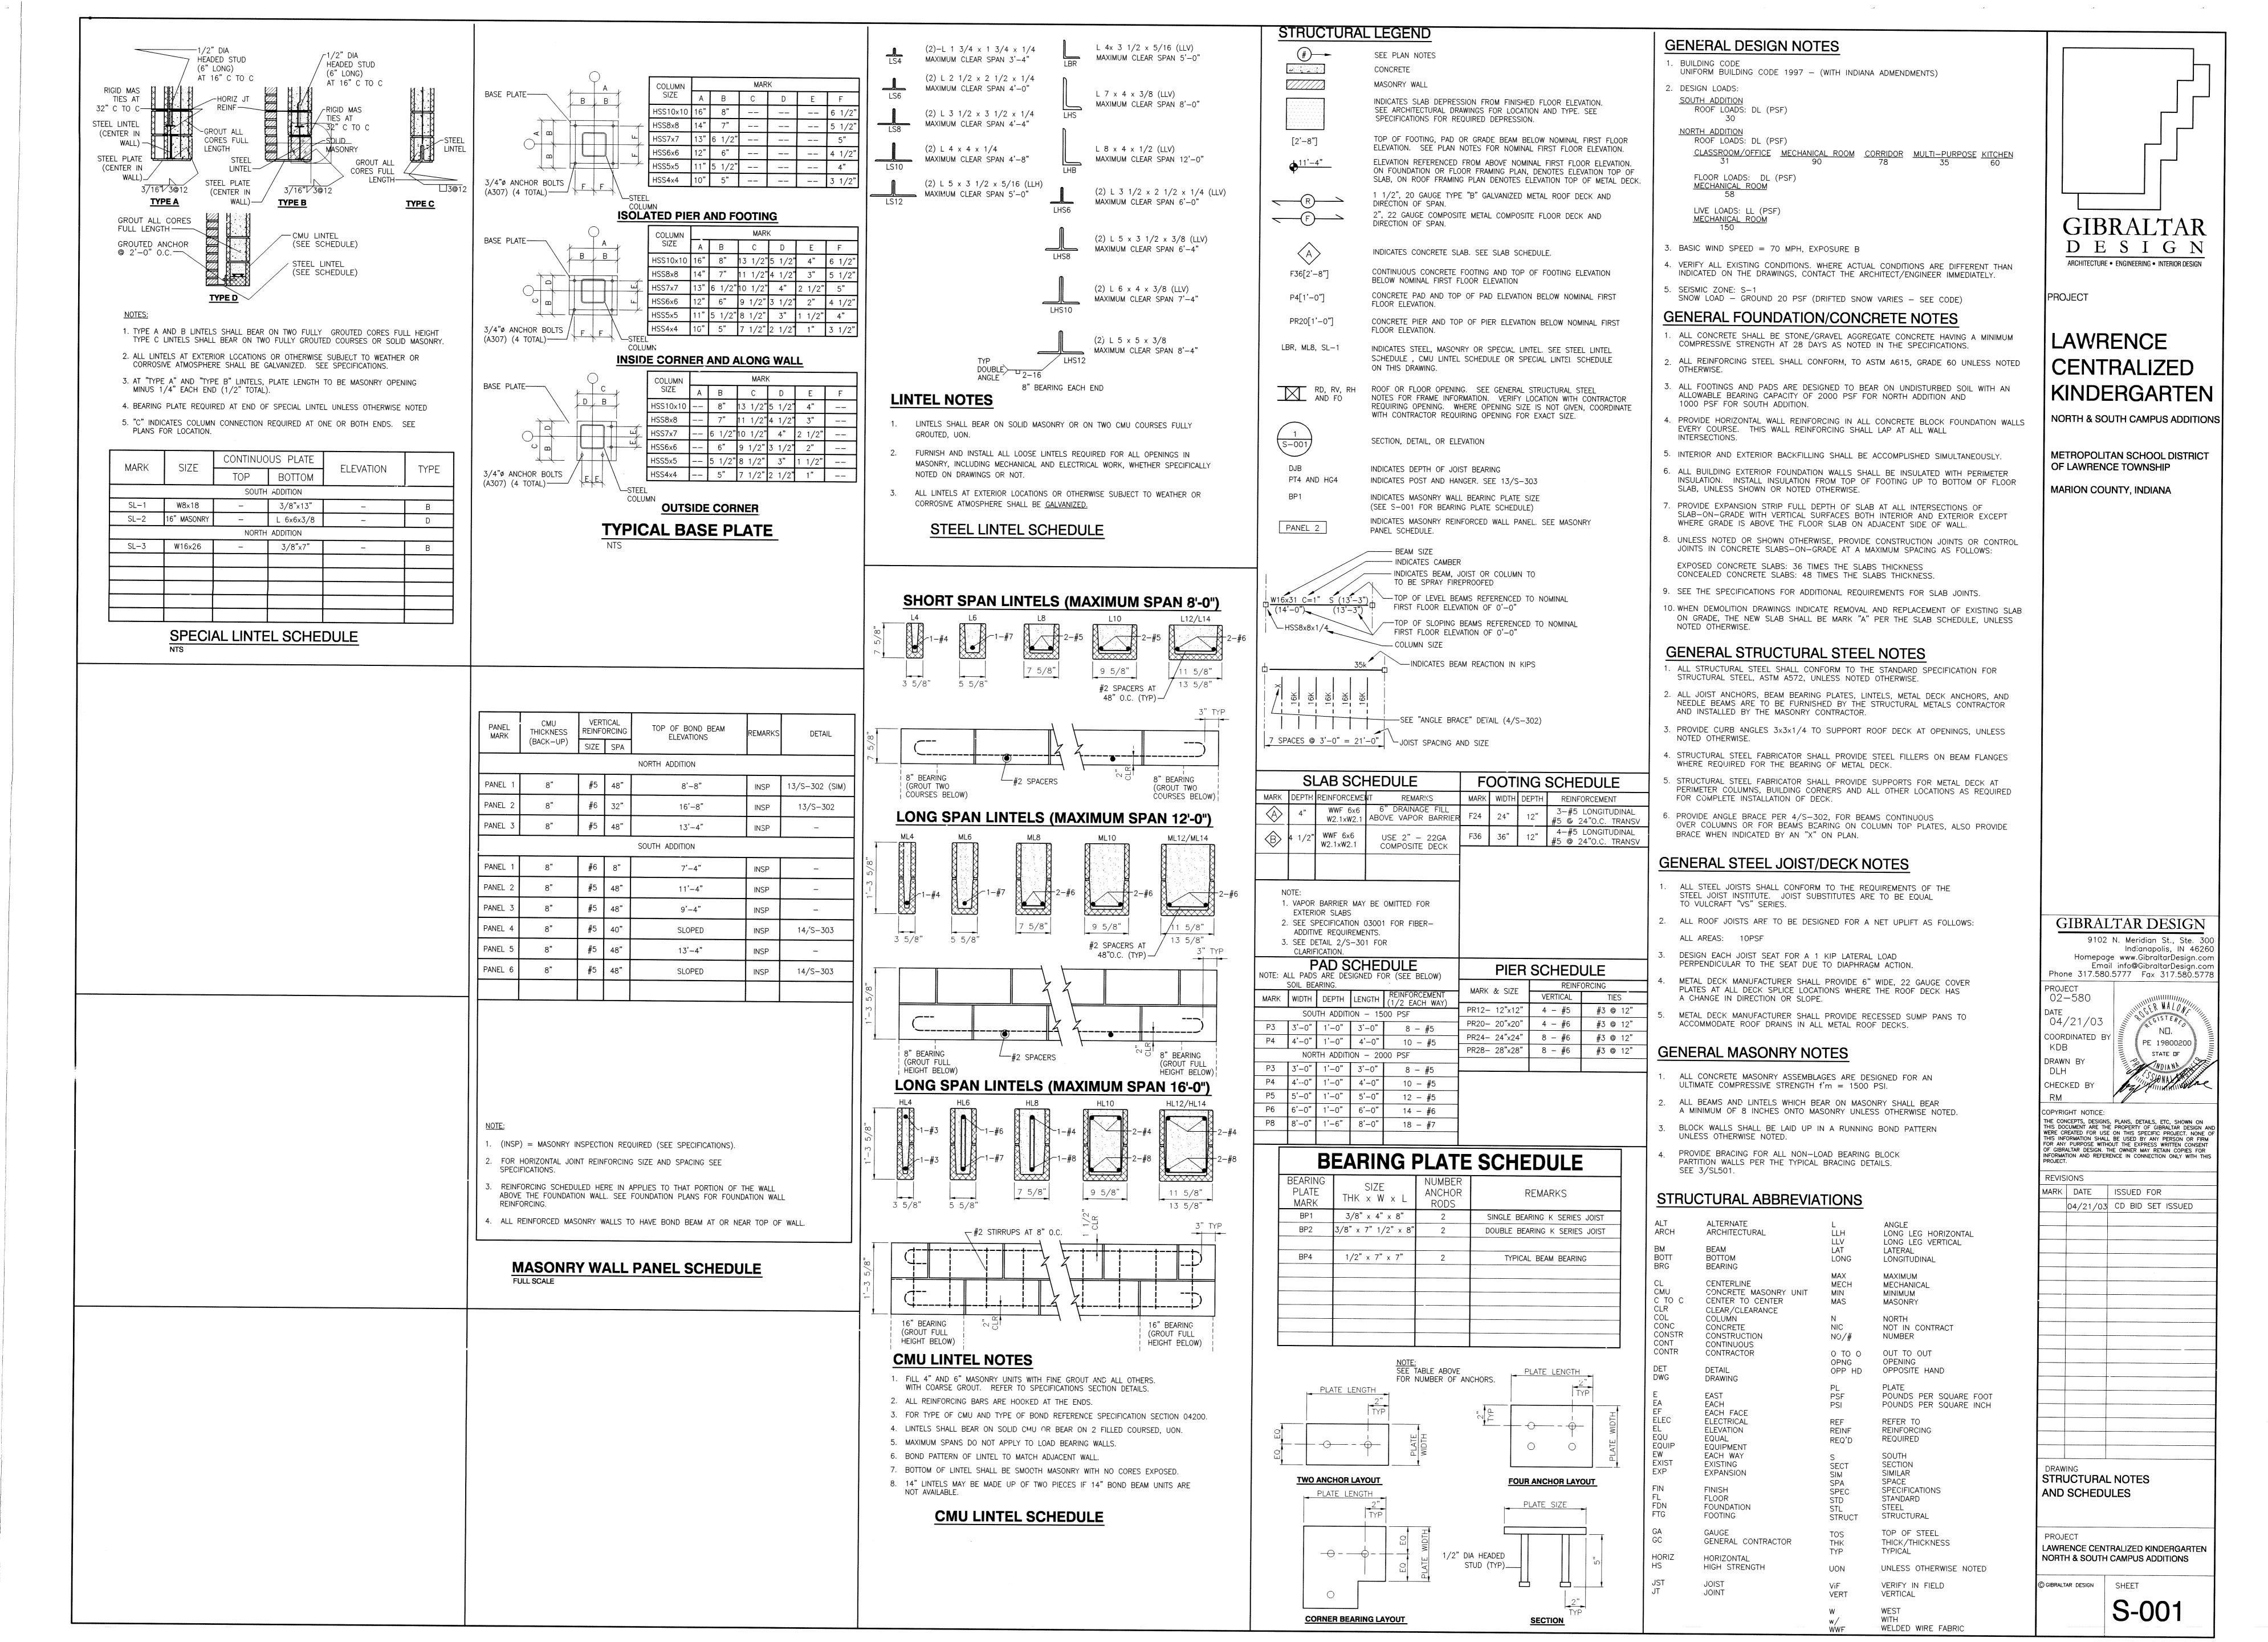

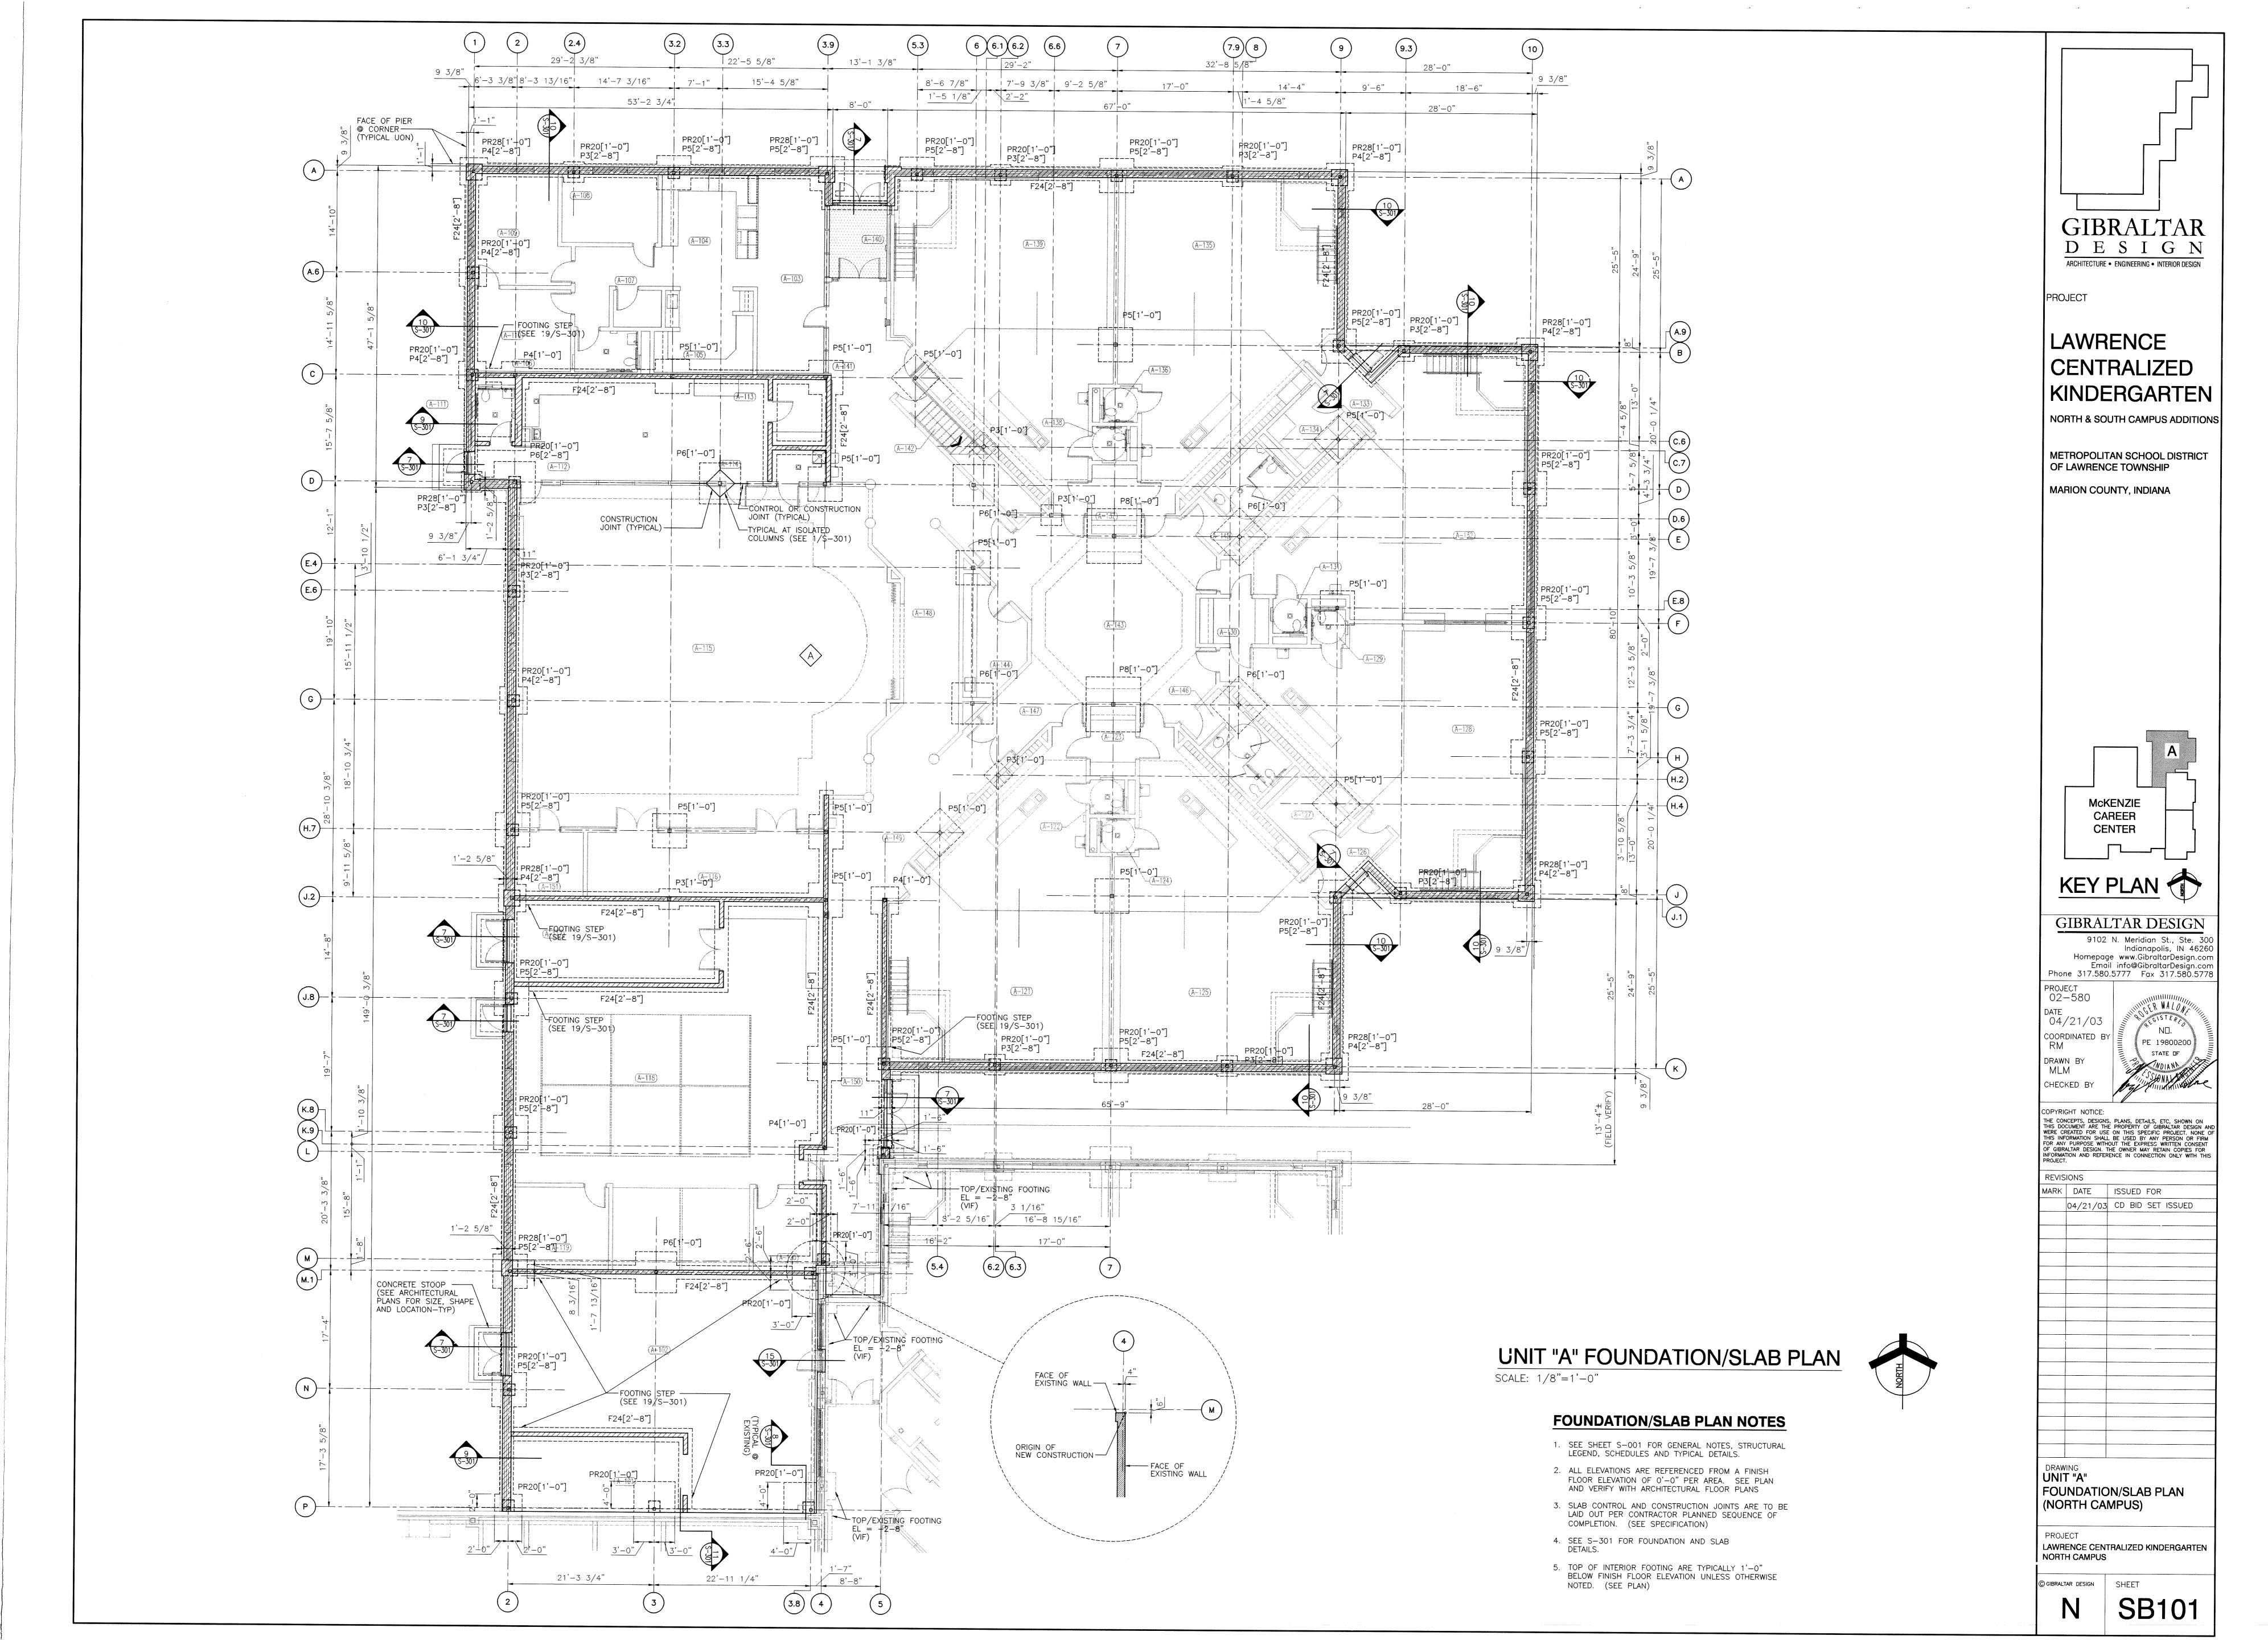

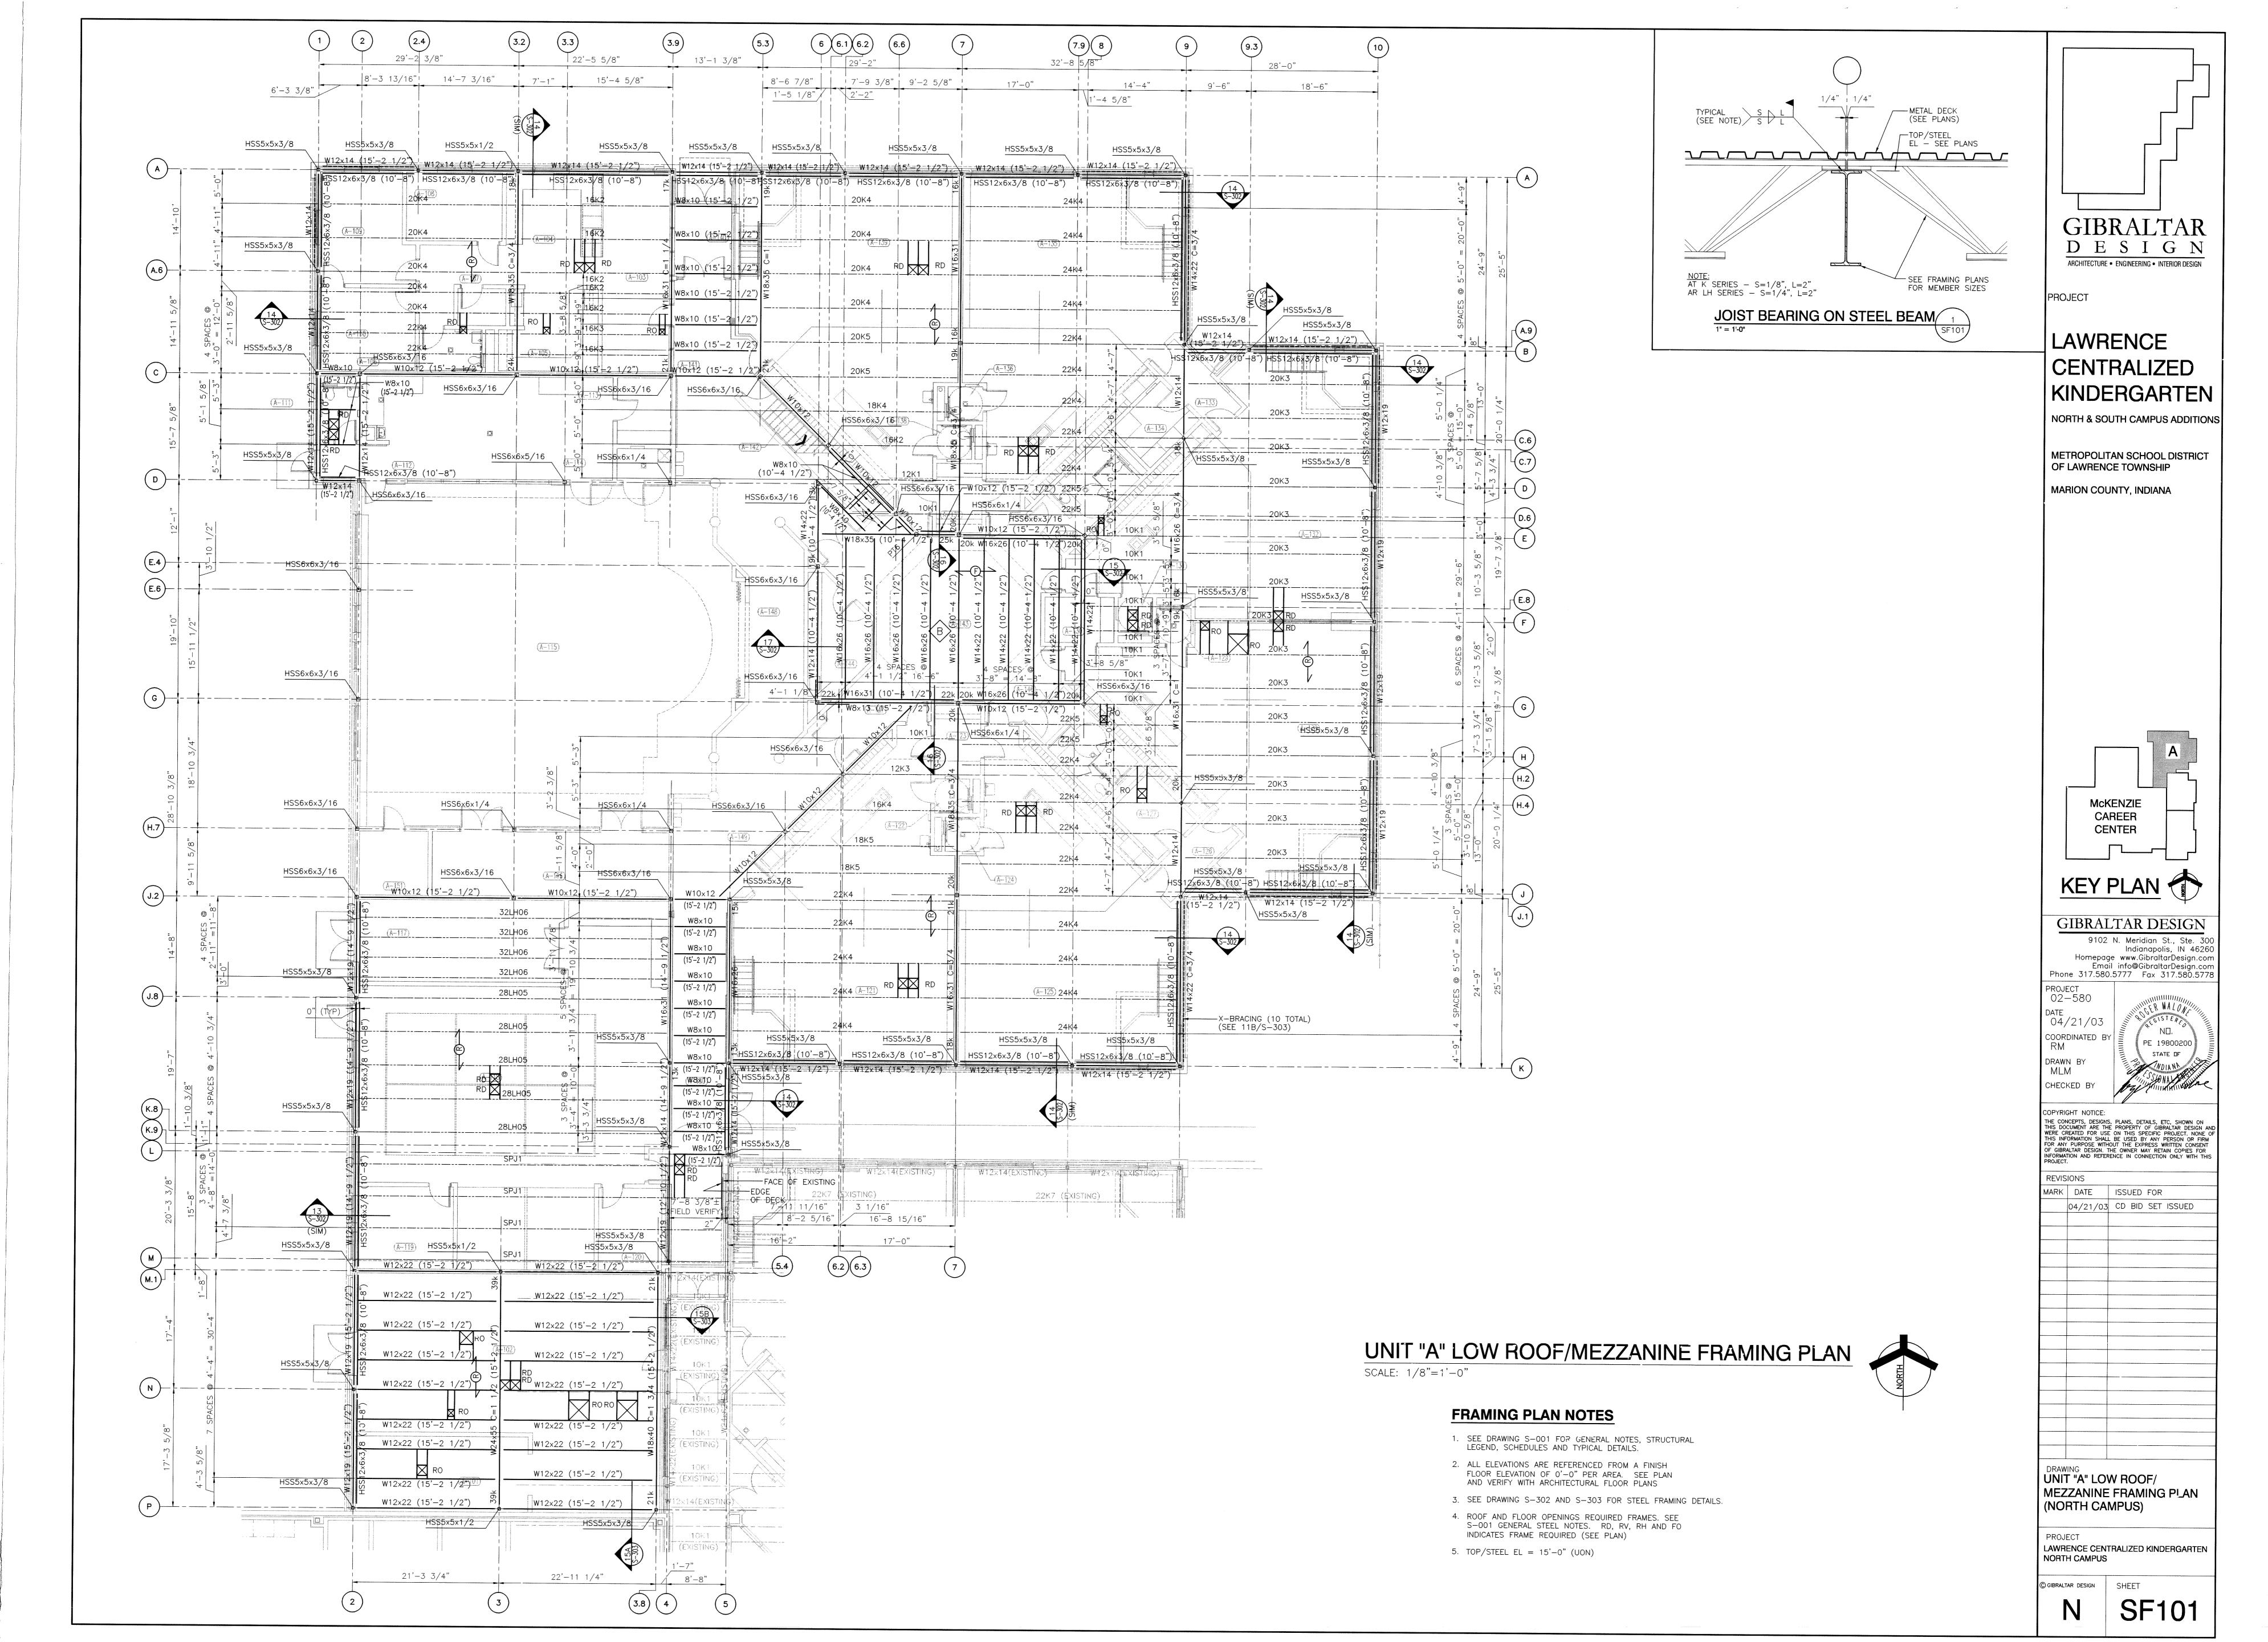

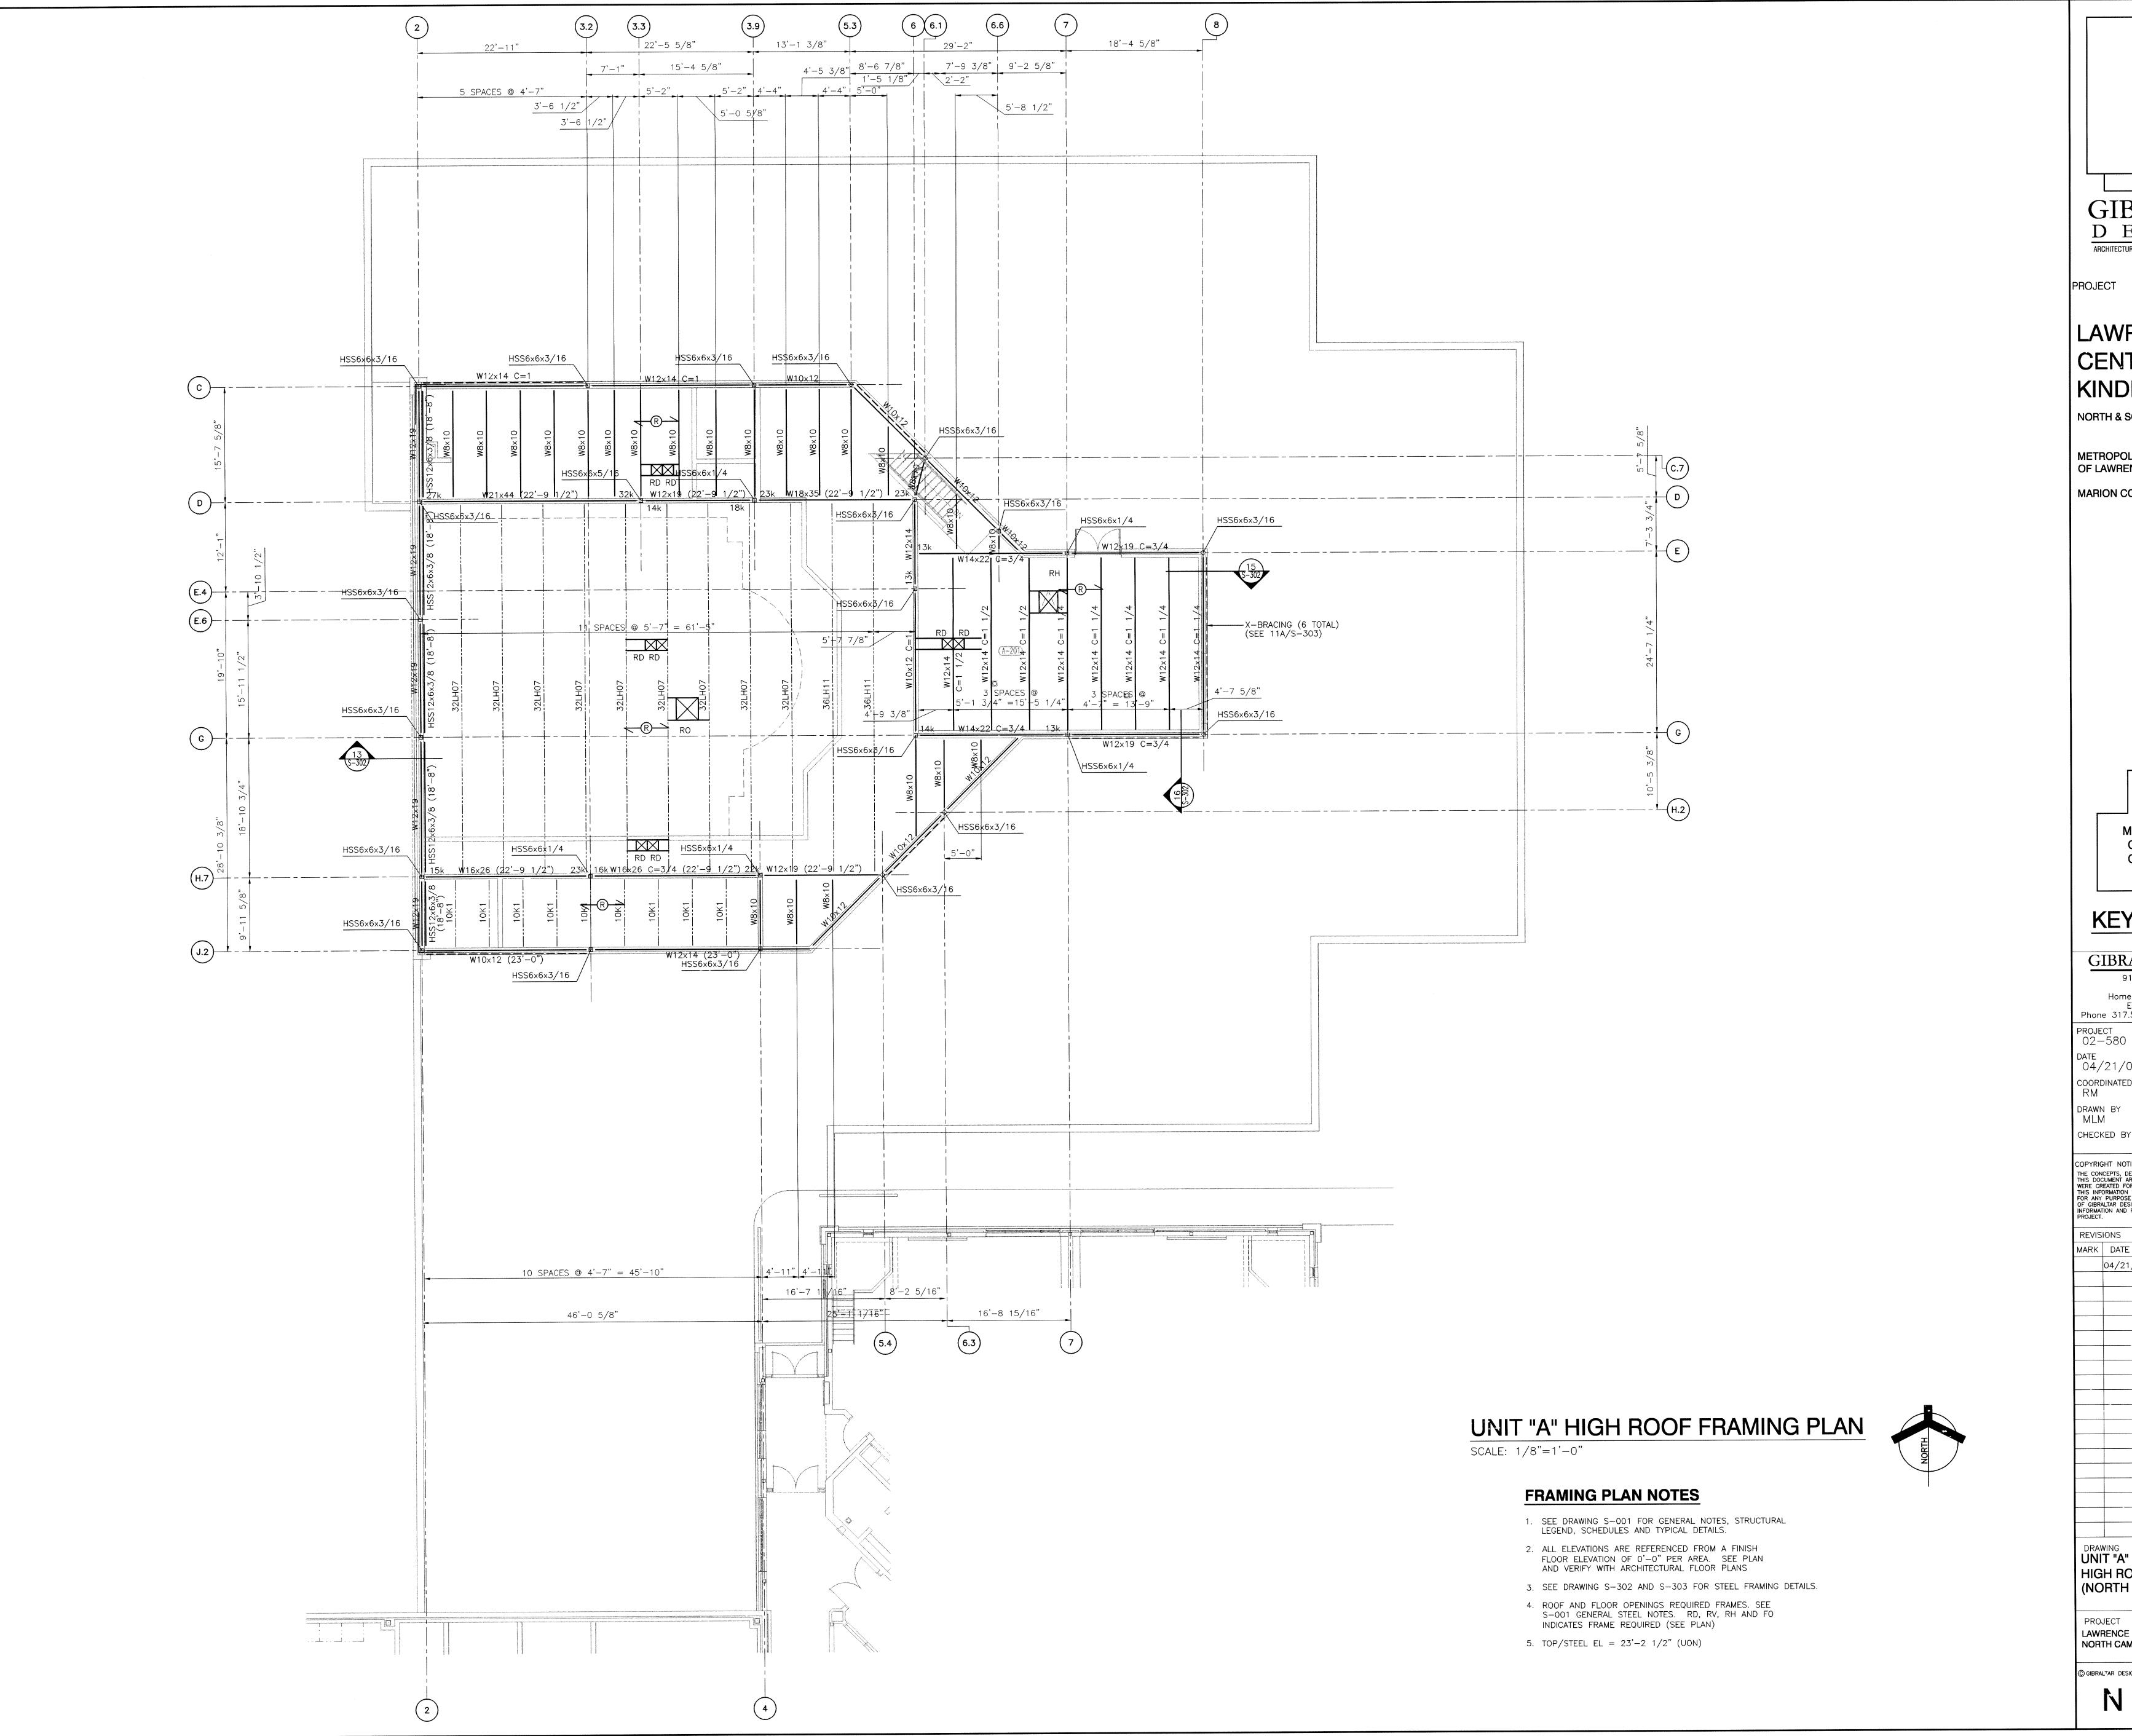

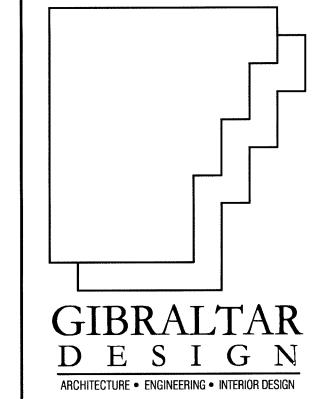


LAWRENCE CENTRALIZED KINDERGARTEN

NORTH & SOUTH CAMPUS ADDITIONS

METROPOLITAN SCHOOL DISTRICT OF LAWRENCE TOWNSHIP

MARION COUNTY, INDIANA

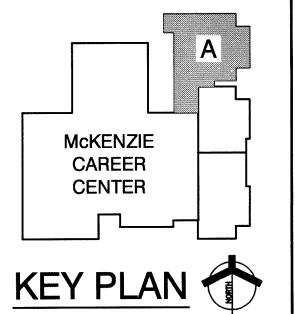

GIBRALTAR DESIGN 9102 N. Meridian St., Ste. 300 Indianapolis, IN 46260 Homepage www.GibraltarDesign.com Email info@GibraltarDesign.com Phone 317.580.5777 Fax 317.580.5778

PROJECT 02-580 04/21/03

COORDINATED BY


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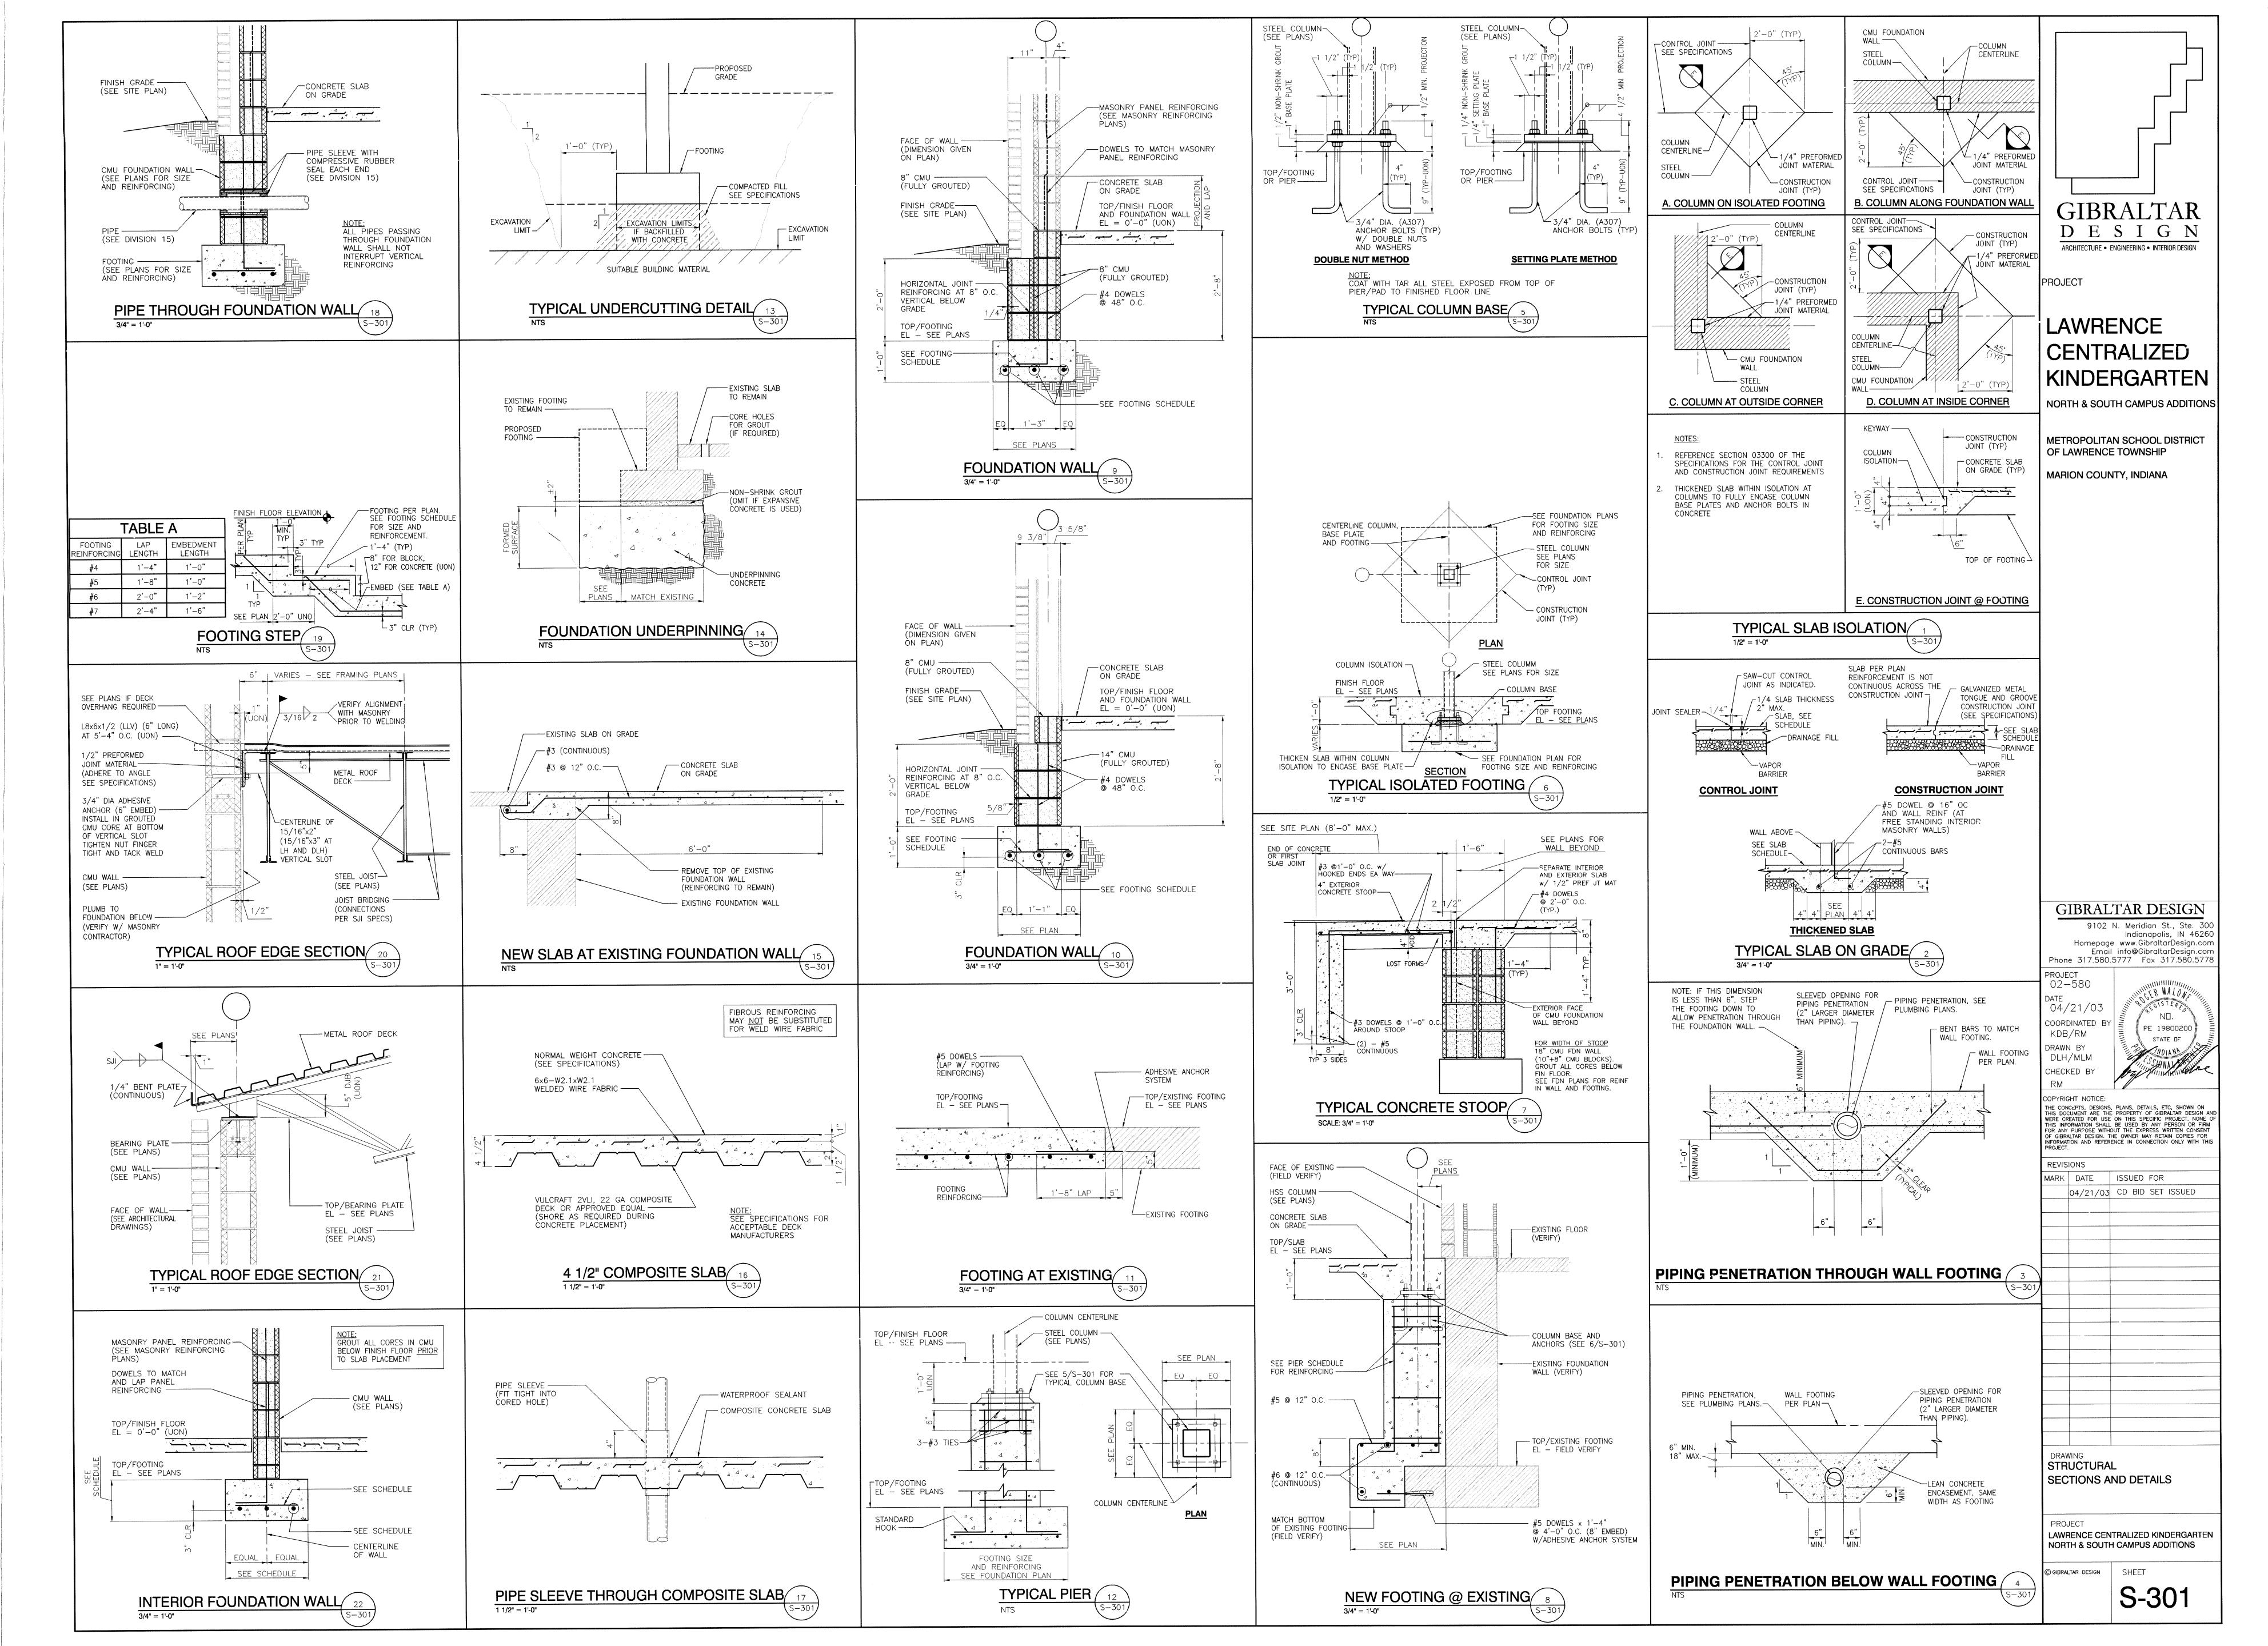
REVISIONS MARK DATE ISSUED FOR 04/21/03 CD BID SET ISSUED


UNIT "A" HIGH ROOF FRAMING PLAN


(NORTH CAMPUS) PROJECT LAWRENCE CENTRALIZED KINDERGARTEN


NORTH CAMPUS C GIBRALTAR DESIGN




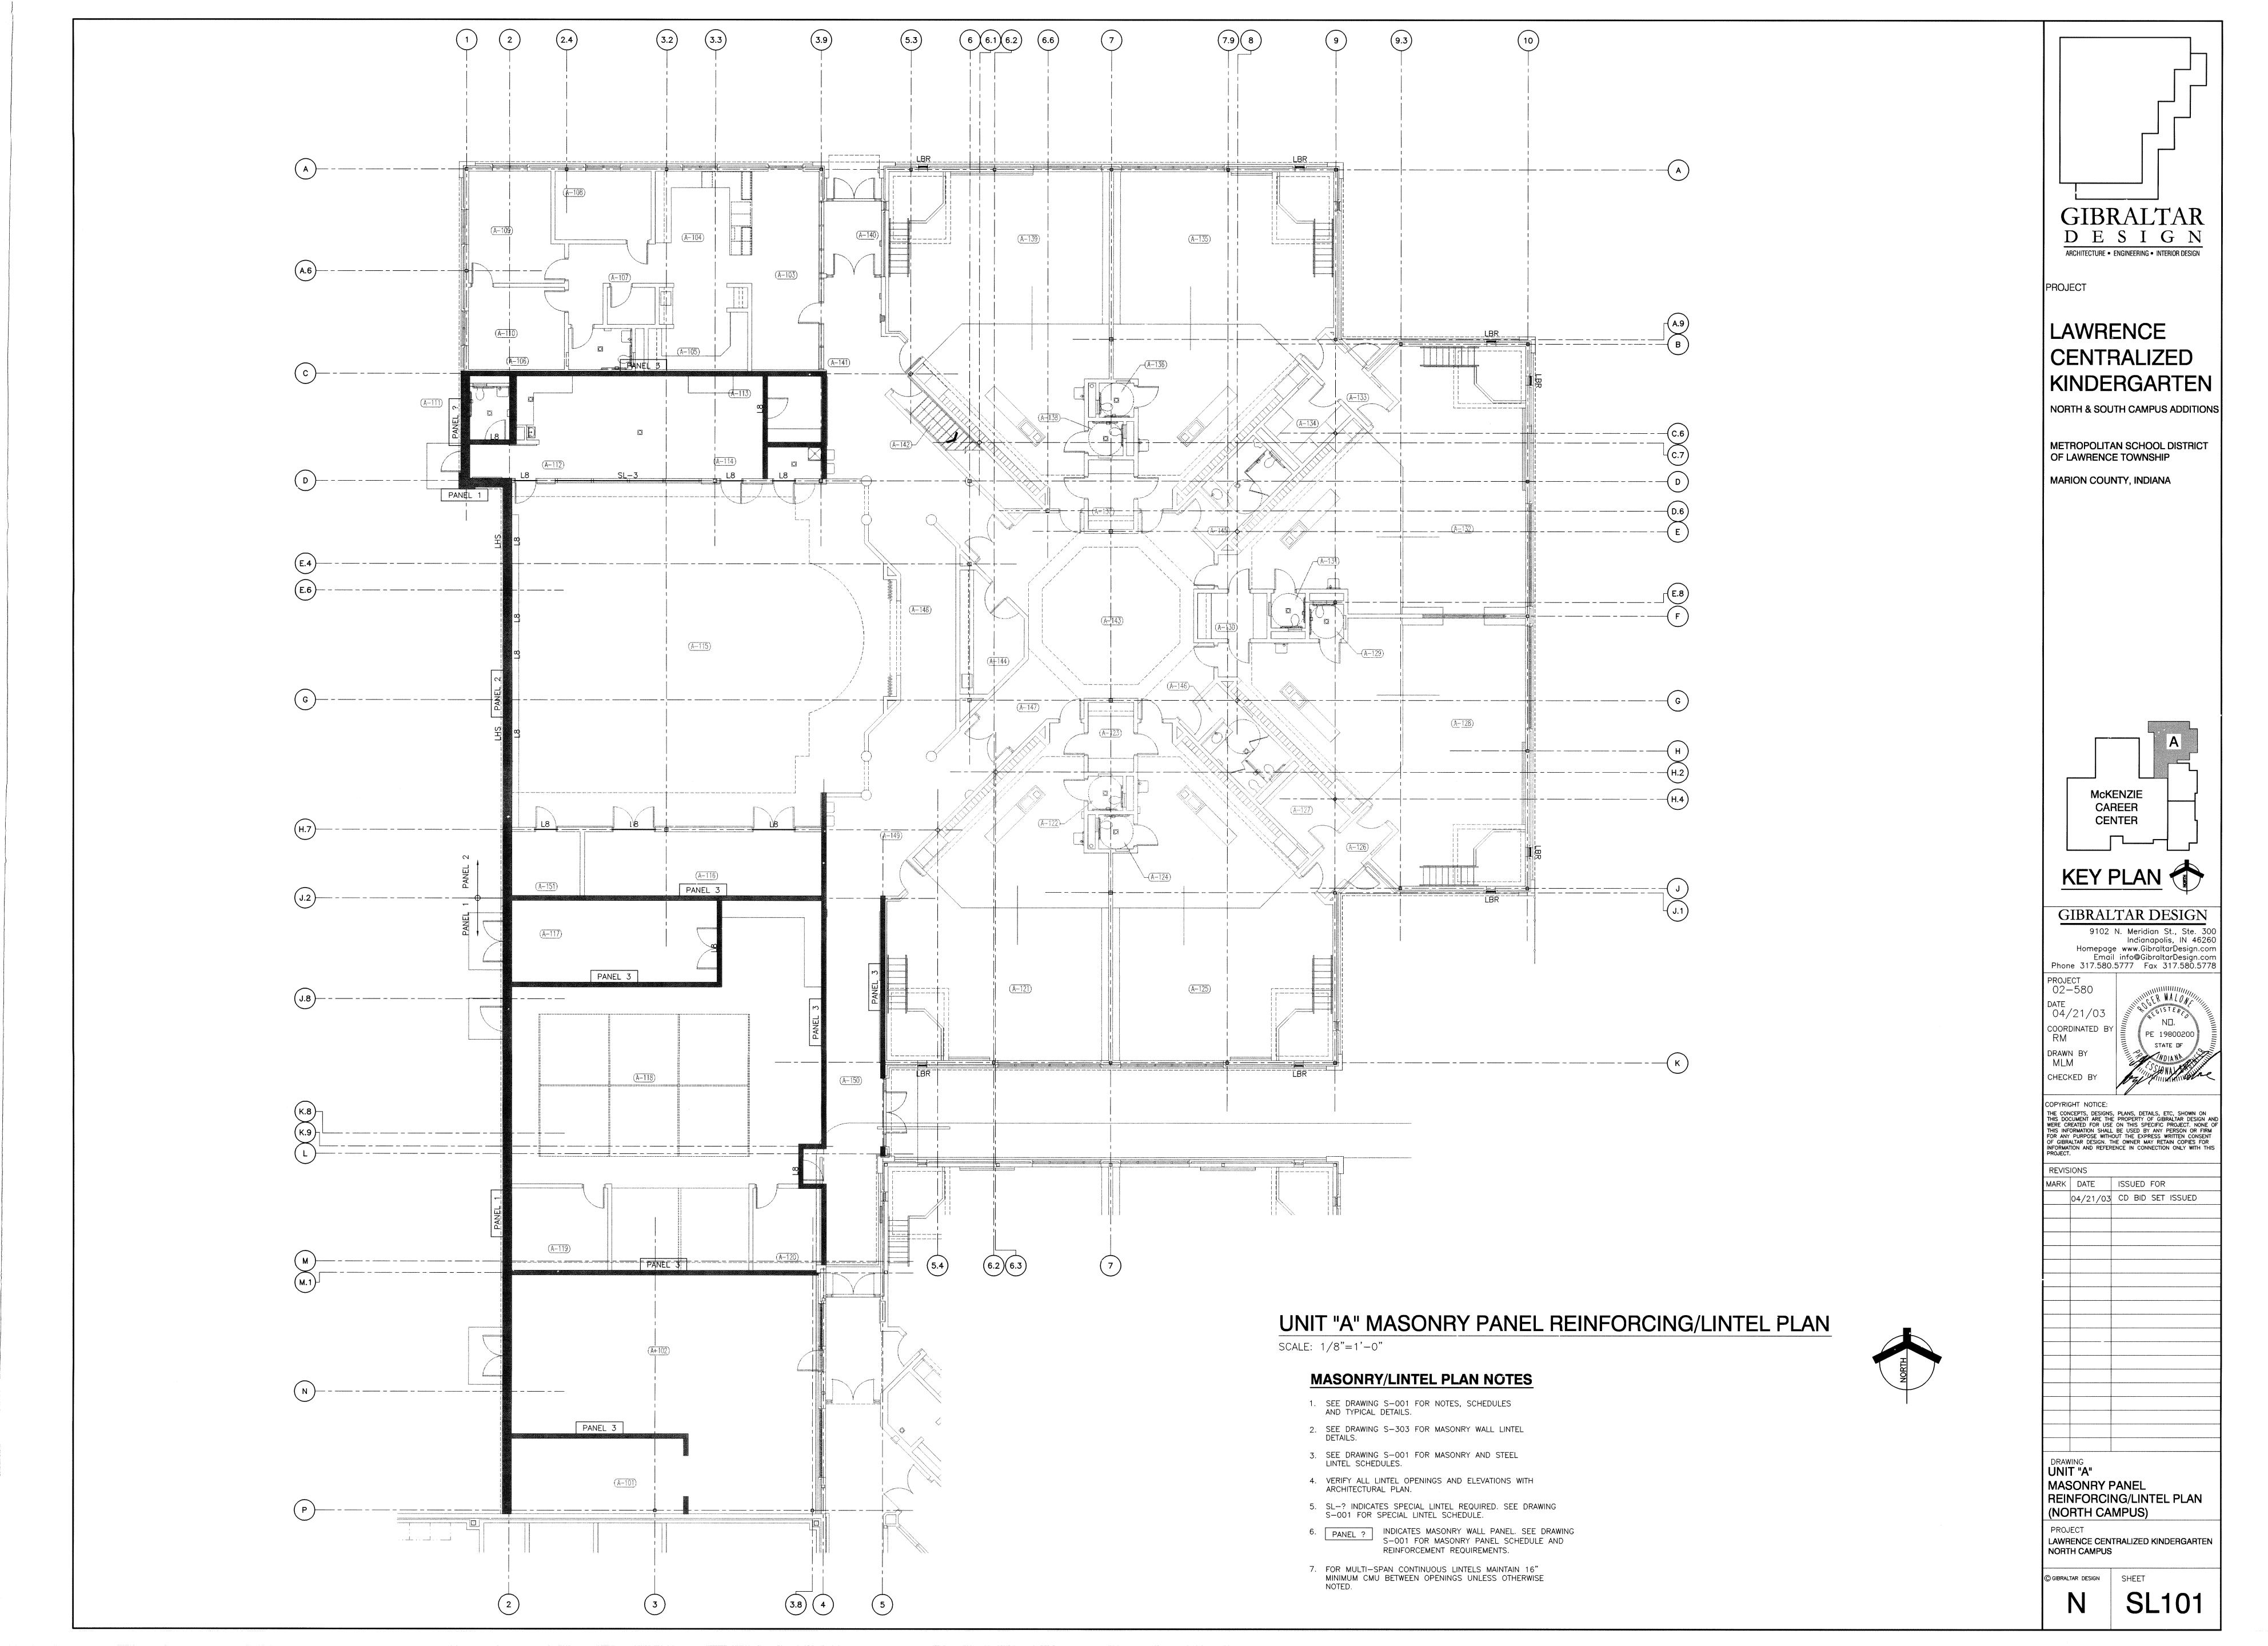

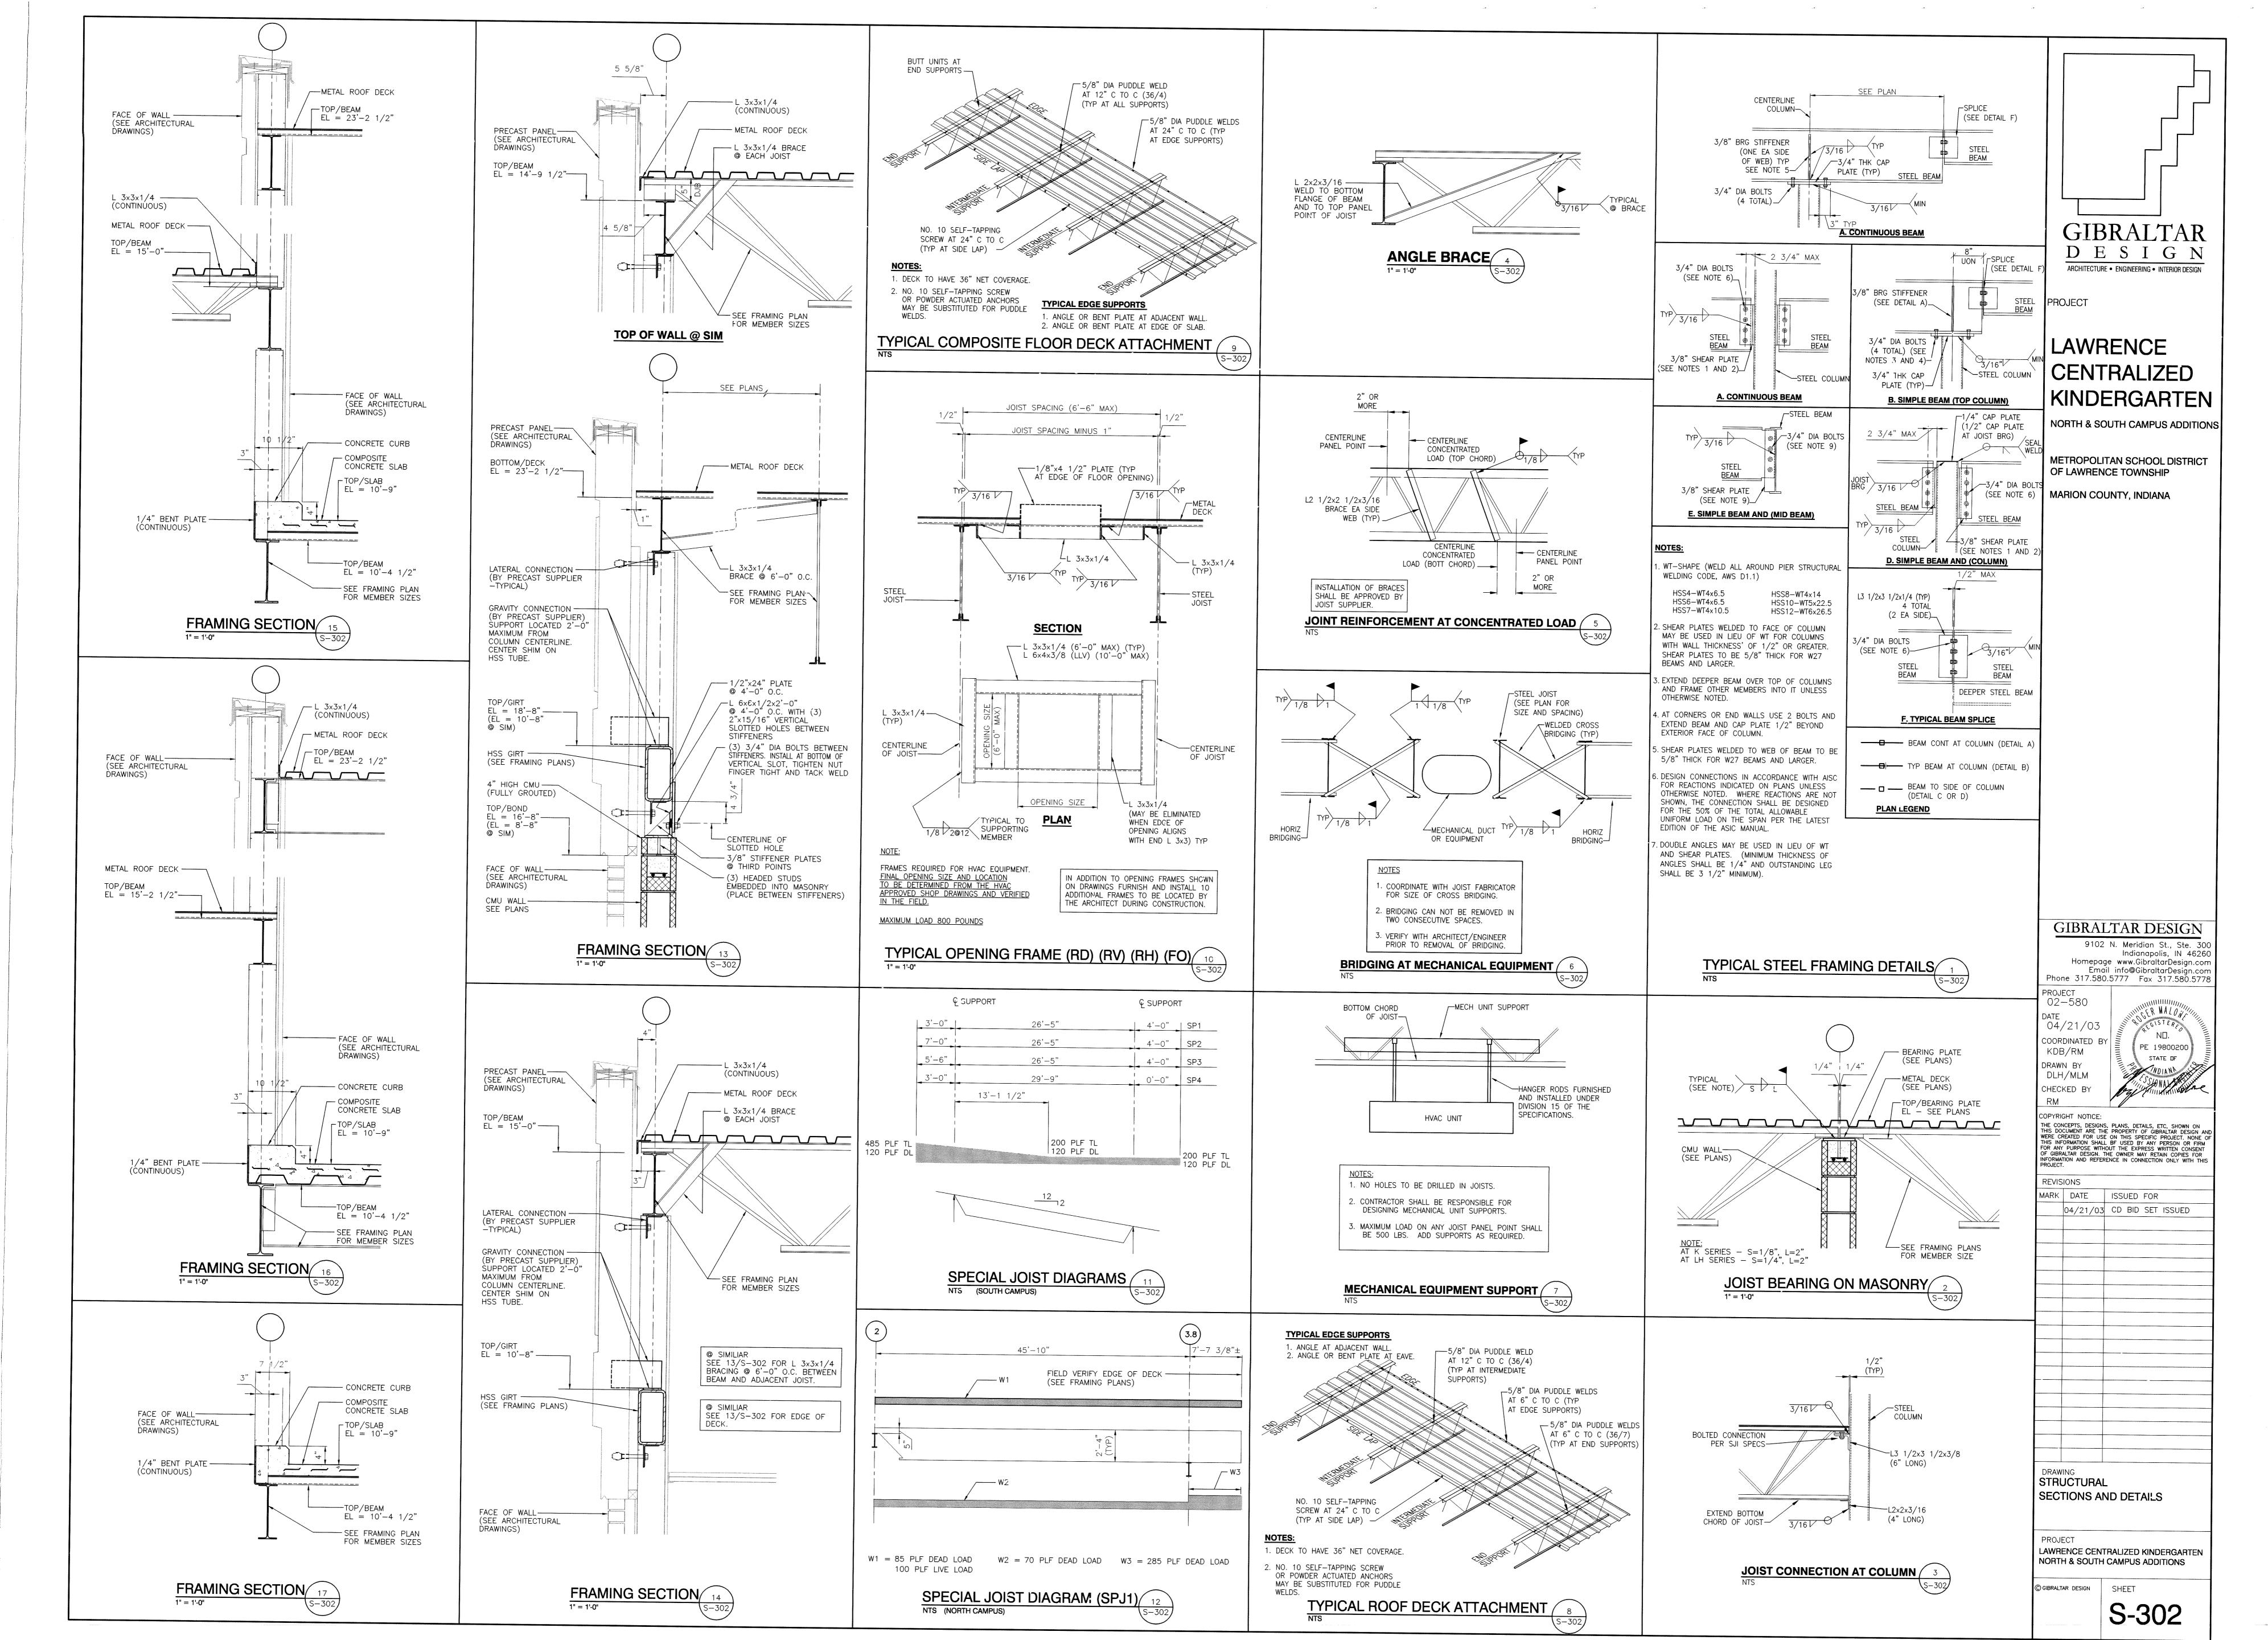

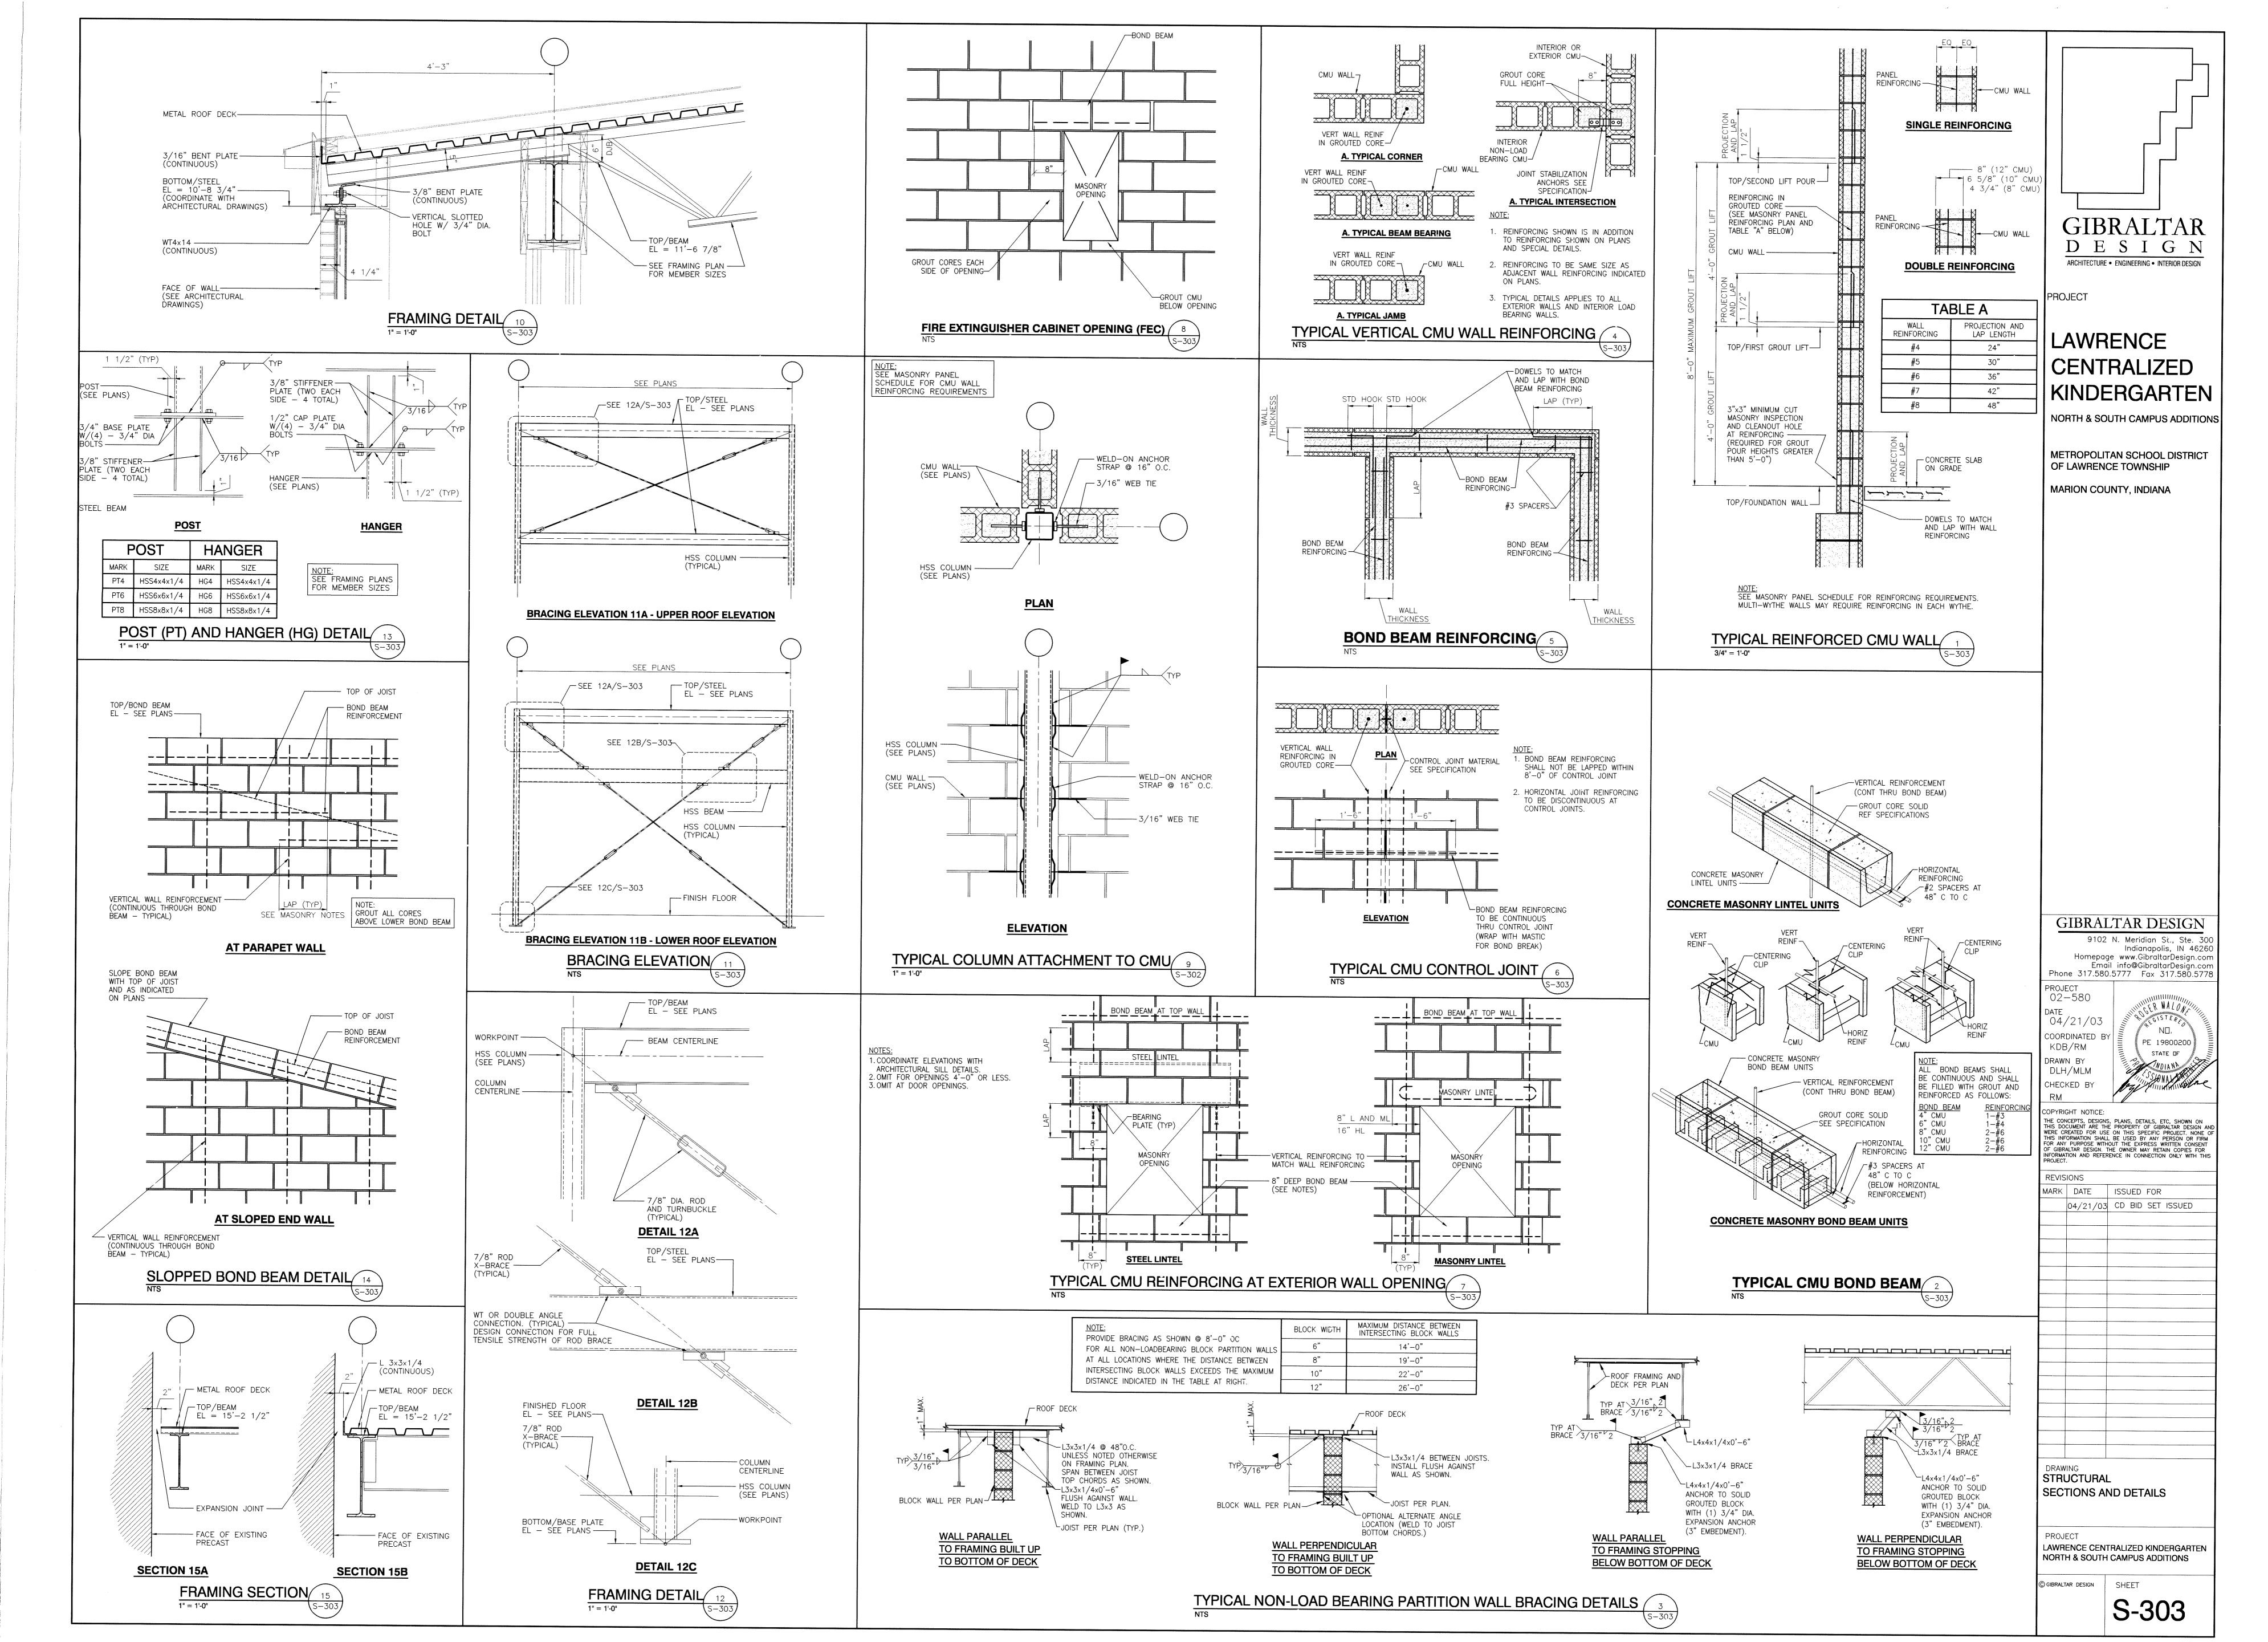

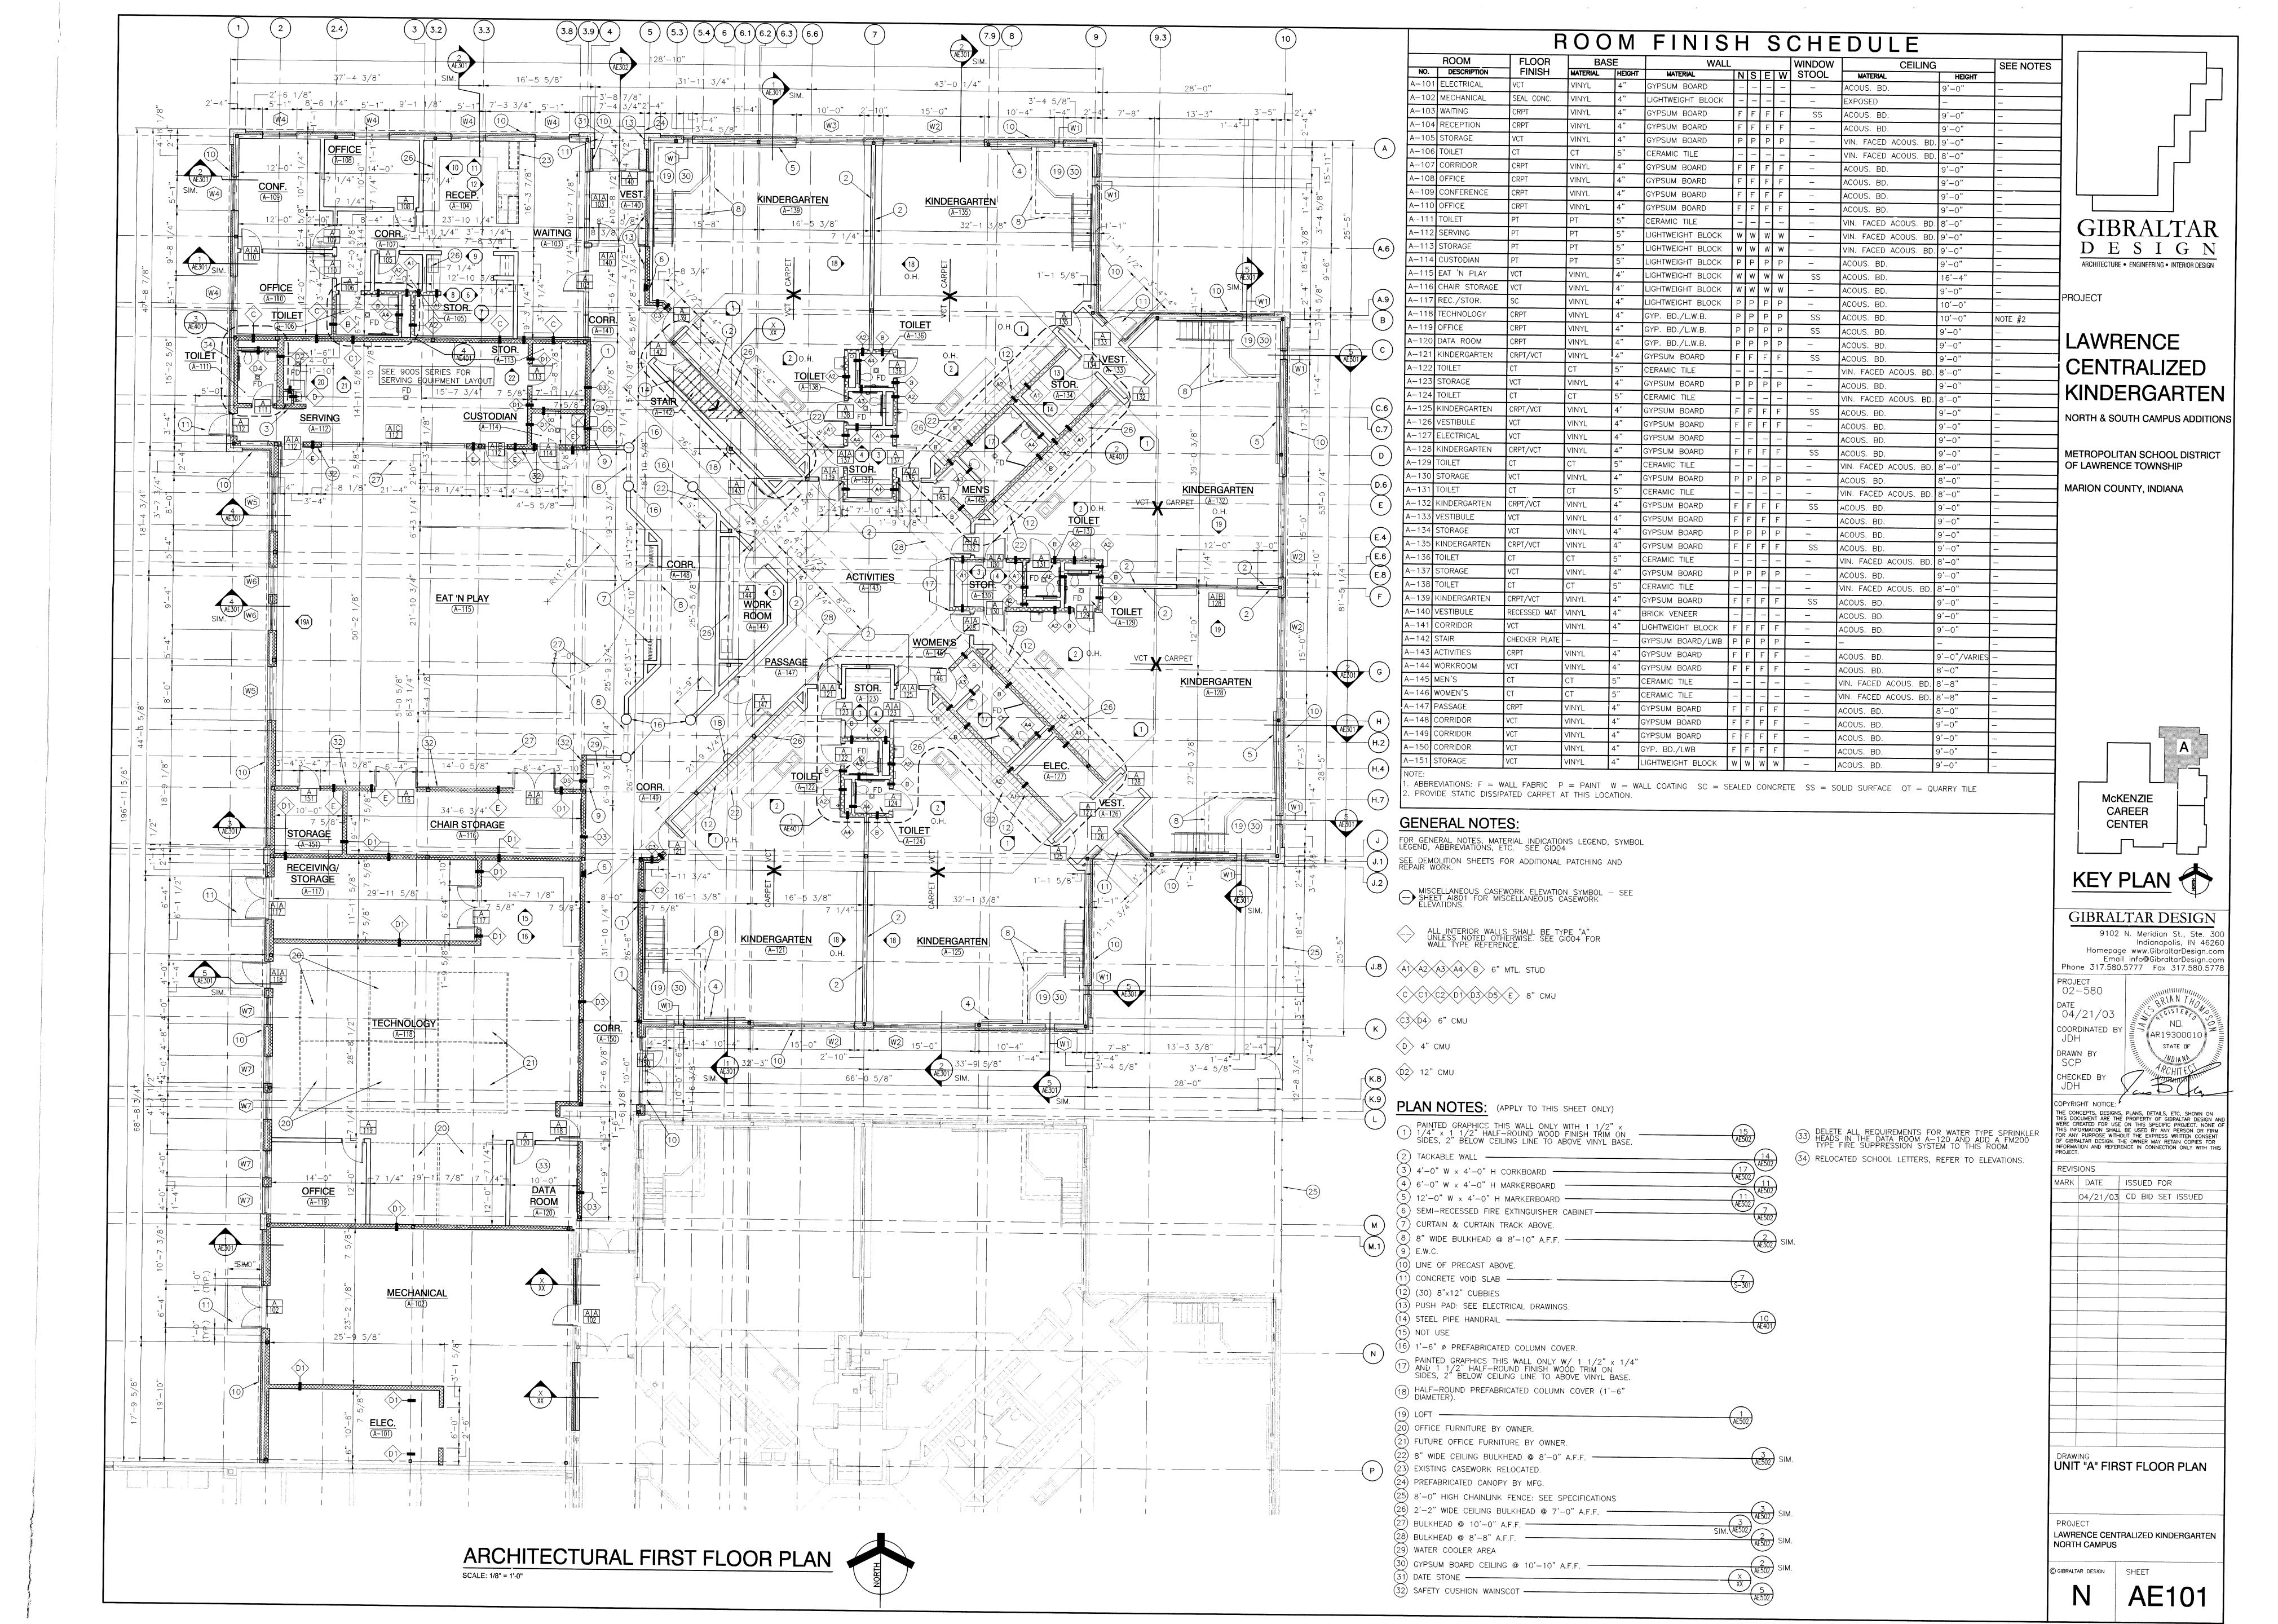

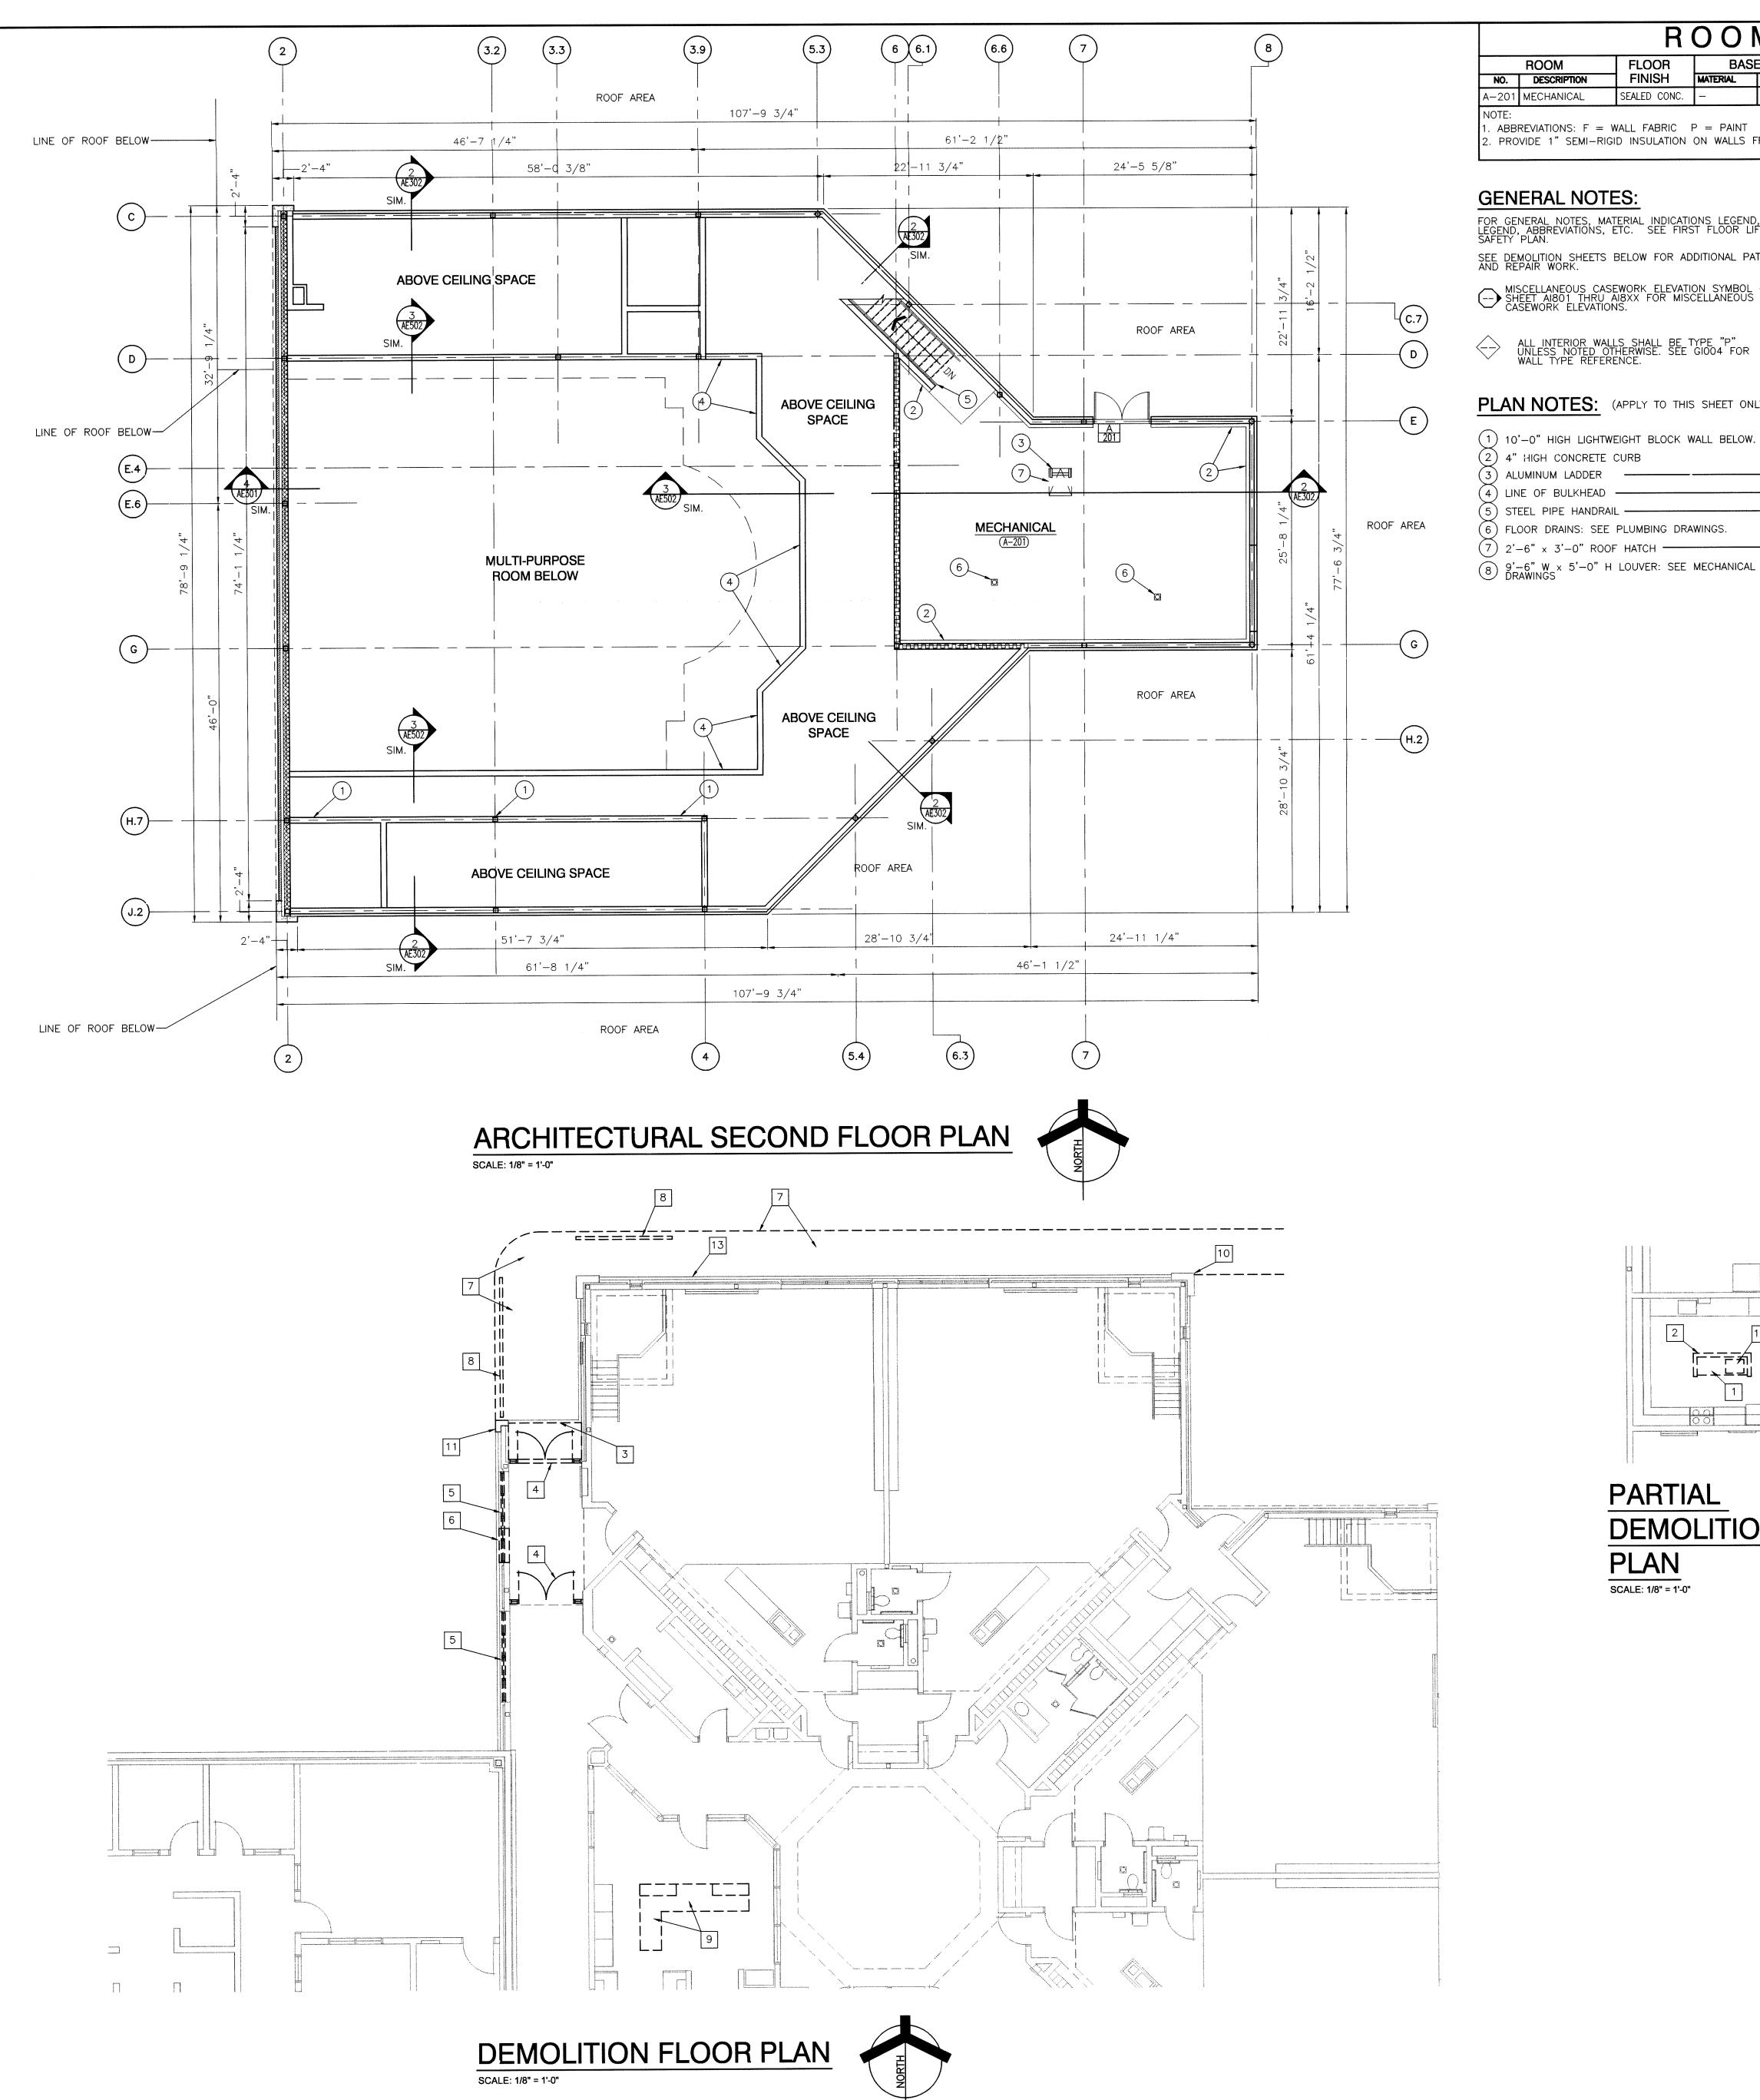



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	ROOM	FLOOR	BAS	SE	WAI	LL				WINDOW	CE	LING	SEE NOTES
NO.	DESCRIPTION	FINISH	MATERIAL	HEIGHT	MATERIAL	N	S	E	W	STOOL	MATERIAL	HEIGHT	
A-201	MECHANICAL	SEALED CONC.	_		GYPSUM BOARD	Р	Р	Р	Р	****	EXPOSED		#2

. ABBREVIATIONS: F = WALL FABRIC P = PAINT W = WALL COATING SC = SEALED CONCRETE SS = SOLID SURFACE. PROVIDE 1" SEMI-RIGID INSULATION ON WALLS FROM TOP OF CURB TO UNDERSIDE OF ROOF DECK ABOVE.

GENERAL NOTES:

FOR GENERAL NOTES, MATERIAL INDICATIONS LEGEND, SYMBOL LEGEND, ABBREVIATIONS, ETC. SEE FIRST FLOOR LIFE SAFETY PLAN.

SEE DEMOLITION SHEETS BELOW FOR ADDITIONAL PATCHING AND REPAIR WORK.

MISCELLANEOUS CASEWORK ELEVATION SYMBOL - SEE SHEET AI801 THRU AI8XX FOR MISCELLANEOUS CASEWORK ELEVATIONS.

PLAN NOTES: (APPLY TO THIS SHEET ONLY)

1) 10'-0" HIGH LIGHTWEIGHT BLOCK WALL BELOW.	
2 4" HIGH CONCRETE CURB	
3 ALUMINUM LADDER ———————————————————————————————————	$\frac{(X)}{XX}$
4 LINE OF BULKHEAD -	(3 (AE502)
(5) STEEL PIPE HANDRAIL —	(10) (AE401)
(6) FLOOR DRAINS: SEE PLUMBING DRAWINGS.	\sim

desentations at agrant description in the control to the control t

DEMOLITION

PARTIAL

SCALE: 1/8" = 1'-0"

GENERAL DEMOLITION NOTES:

FOR GENERAL NOTES, MATERIAL INDICATIONS LEGEND, SYMBOL LEGEND, ABBREVIATIONS, ETC. SEE FIRST FLOOR LIFE SAFETY PLAN.

UNLESS NOTED OTHERWISE ON THIS SHEET, THE GENERAL CONTRACTOR IS RESPONSIBLE FOR ALL DEMOLITION AND REMOVAL WORK INDICATED ON THIS SHEET.

REMOVE EXISTING MATERIAL AS REQUIRED FOR NEW INSTALLATION. EXISTING DRAIN TO BE REMOVE PRIOR TO NEW CONSTRUCTION. SEE PLUMBING DRAWINGS.

DEMOLITION PLAN NOTES:

(APPLY TO THIS SHEET ONLY)

- 1 REMOVE CASEWORK IN ITS ENTIRETY. 2 REMOVE LOW HEIGHT WALL IN ITS ENTIRETY.
- REMOVE CONCRETE STOOP IN ITS ENTIRETY PRIOR TO NEW CONSTRUCTION. REMOVE FOUNDATION TO A MINIMUM 8" BELOW NEW FINISH FLOOR.
- 4 REMOVE EXISTING DOORS, FRAMES, AND ALL RELATED ACCESSORIES AND RETURN TO OWNER.
- 5 REMOVE WINDOW SASH AND GLAZING. REMOVE FOUNDATION WALL TO A MINIMUM OF 8" BELOW NEW FINISH FLOOR.
- 7 REMOVE CONCRETE WALK. SEE CIVIL DRAWINGS.
- 8 REMOVE GUARDRAIL. 9 REMOVE RECEPTION COUNTER AND SAVE FOR REINSTALLATION IN RECEPTION A-1C4. SEE SHEET AE101.
- 10 REMOVE AND RETURN SECURITY CAMERA TO OWNER FOR REINSTALLATION AT NEW LOCATION.
- 11 REMOVE PRECAST CORNER PANEL.
- REMOVE SINK AND ALL PIPING PLUG, PLUG AND/OR CAP BELOW AND/OR BEHIND ALL NEW FINISH SURFACES.
- REMOVE BUILDING SIGN. SAVE FOR REINSTALLATION AT NEW LOCATION. SEE AE101 FOR NEW LOCATION.




PROJECT

LAWRENCE CENTRALIZED **KINDERGARTEN**

NORTH & SOUTH CAMPUS ADDITIONS

METROPOLITAN SCHOOL DISTRICT OF LAWRENCE TOWNSHIP

MARION COUNTY, INDIANA

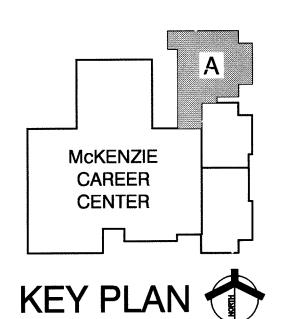

GIBRALTAR DESIGN Indianapolis, IN 46260
Homepage www.GibraltarDesign.com
Email info@GibraltarDesign.com
Phone 317.580.5777 Fax 317.580.5778

PROJECT 02-580	
DATE 04/21/03	11111
COORDINATED BY JDH	THIIIIIIIIIIIIIIIIIIIIII
DRAWN BY SCP	
CHECKED BY	


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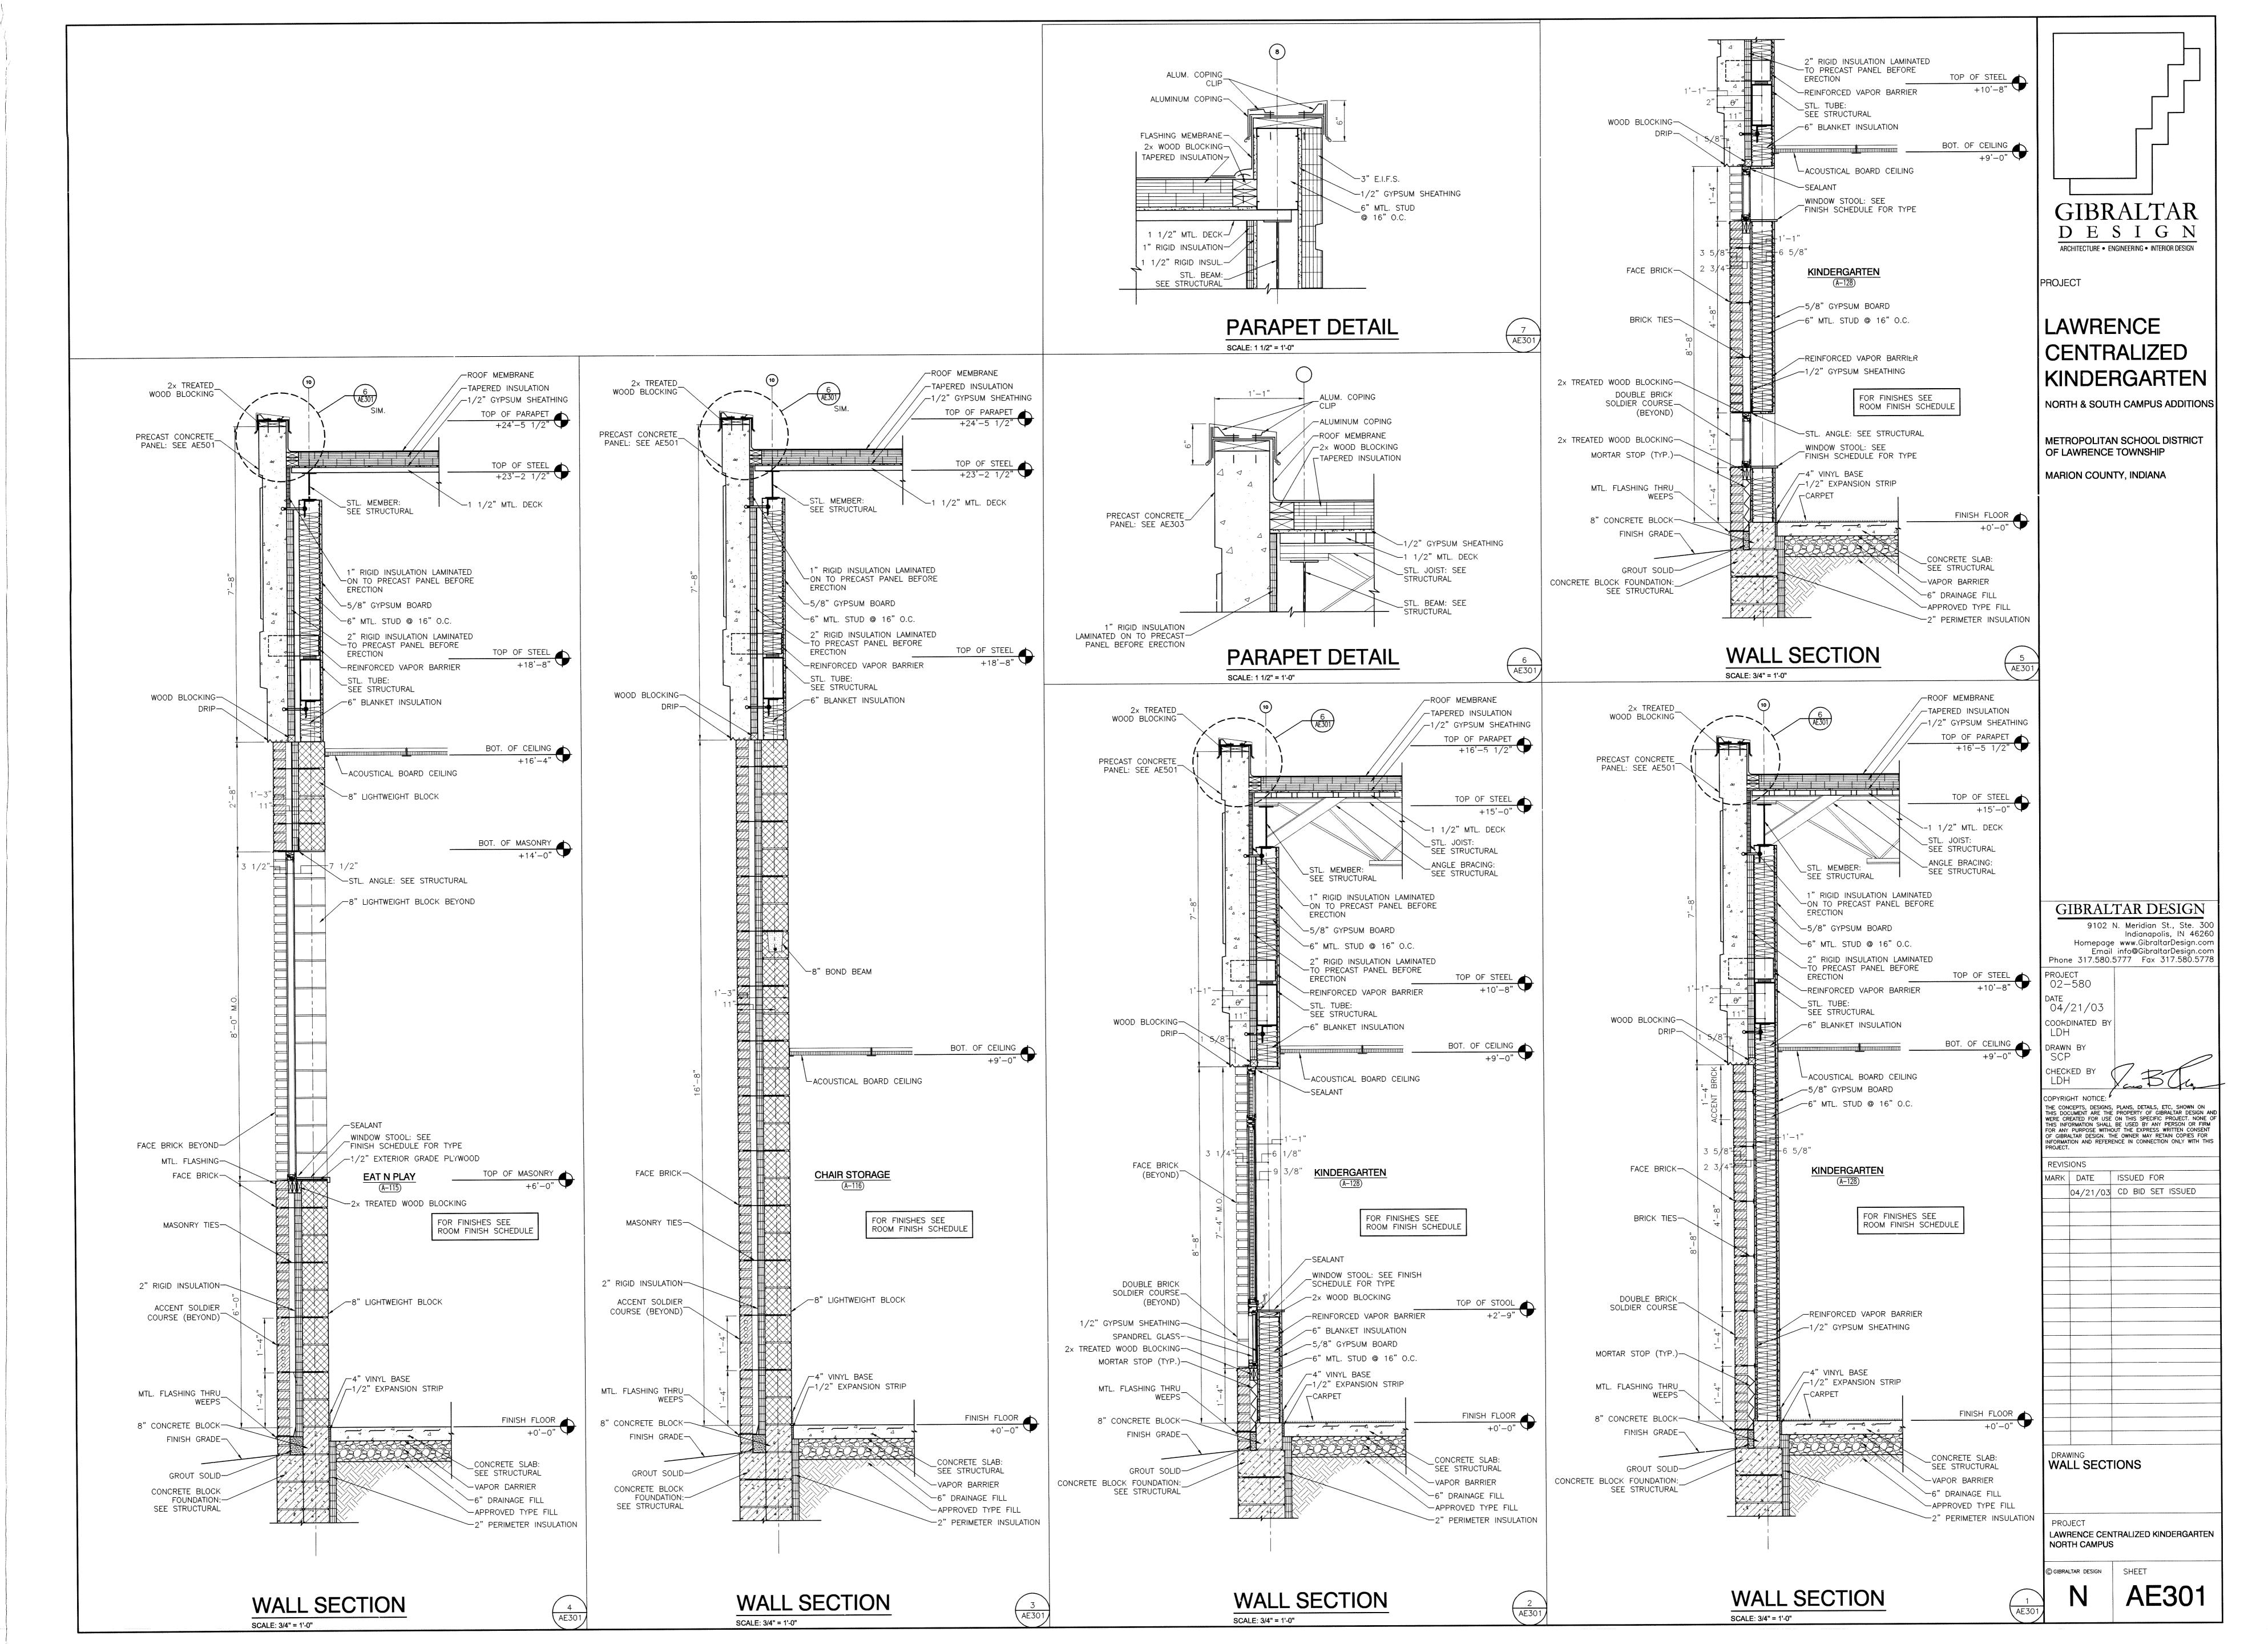
DRAWING UNIT "A" SECOND FLOOR PLAN & DEMOLITION PLAN


LAWRENCE CENTRALIZED KINDERGARTEN


NORTH CAMPUS


AE102




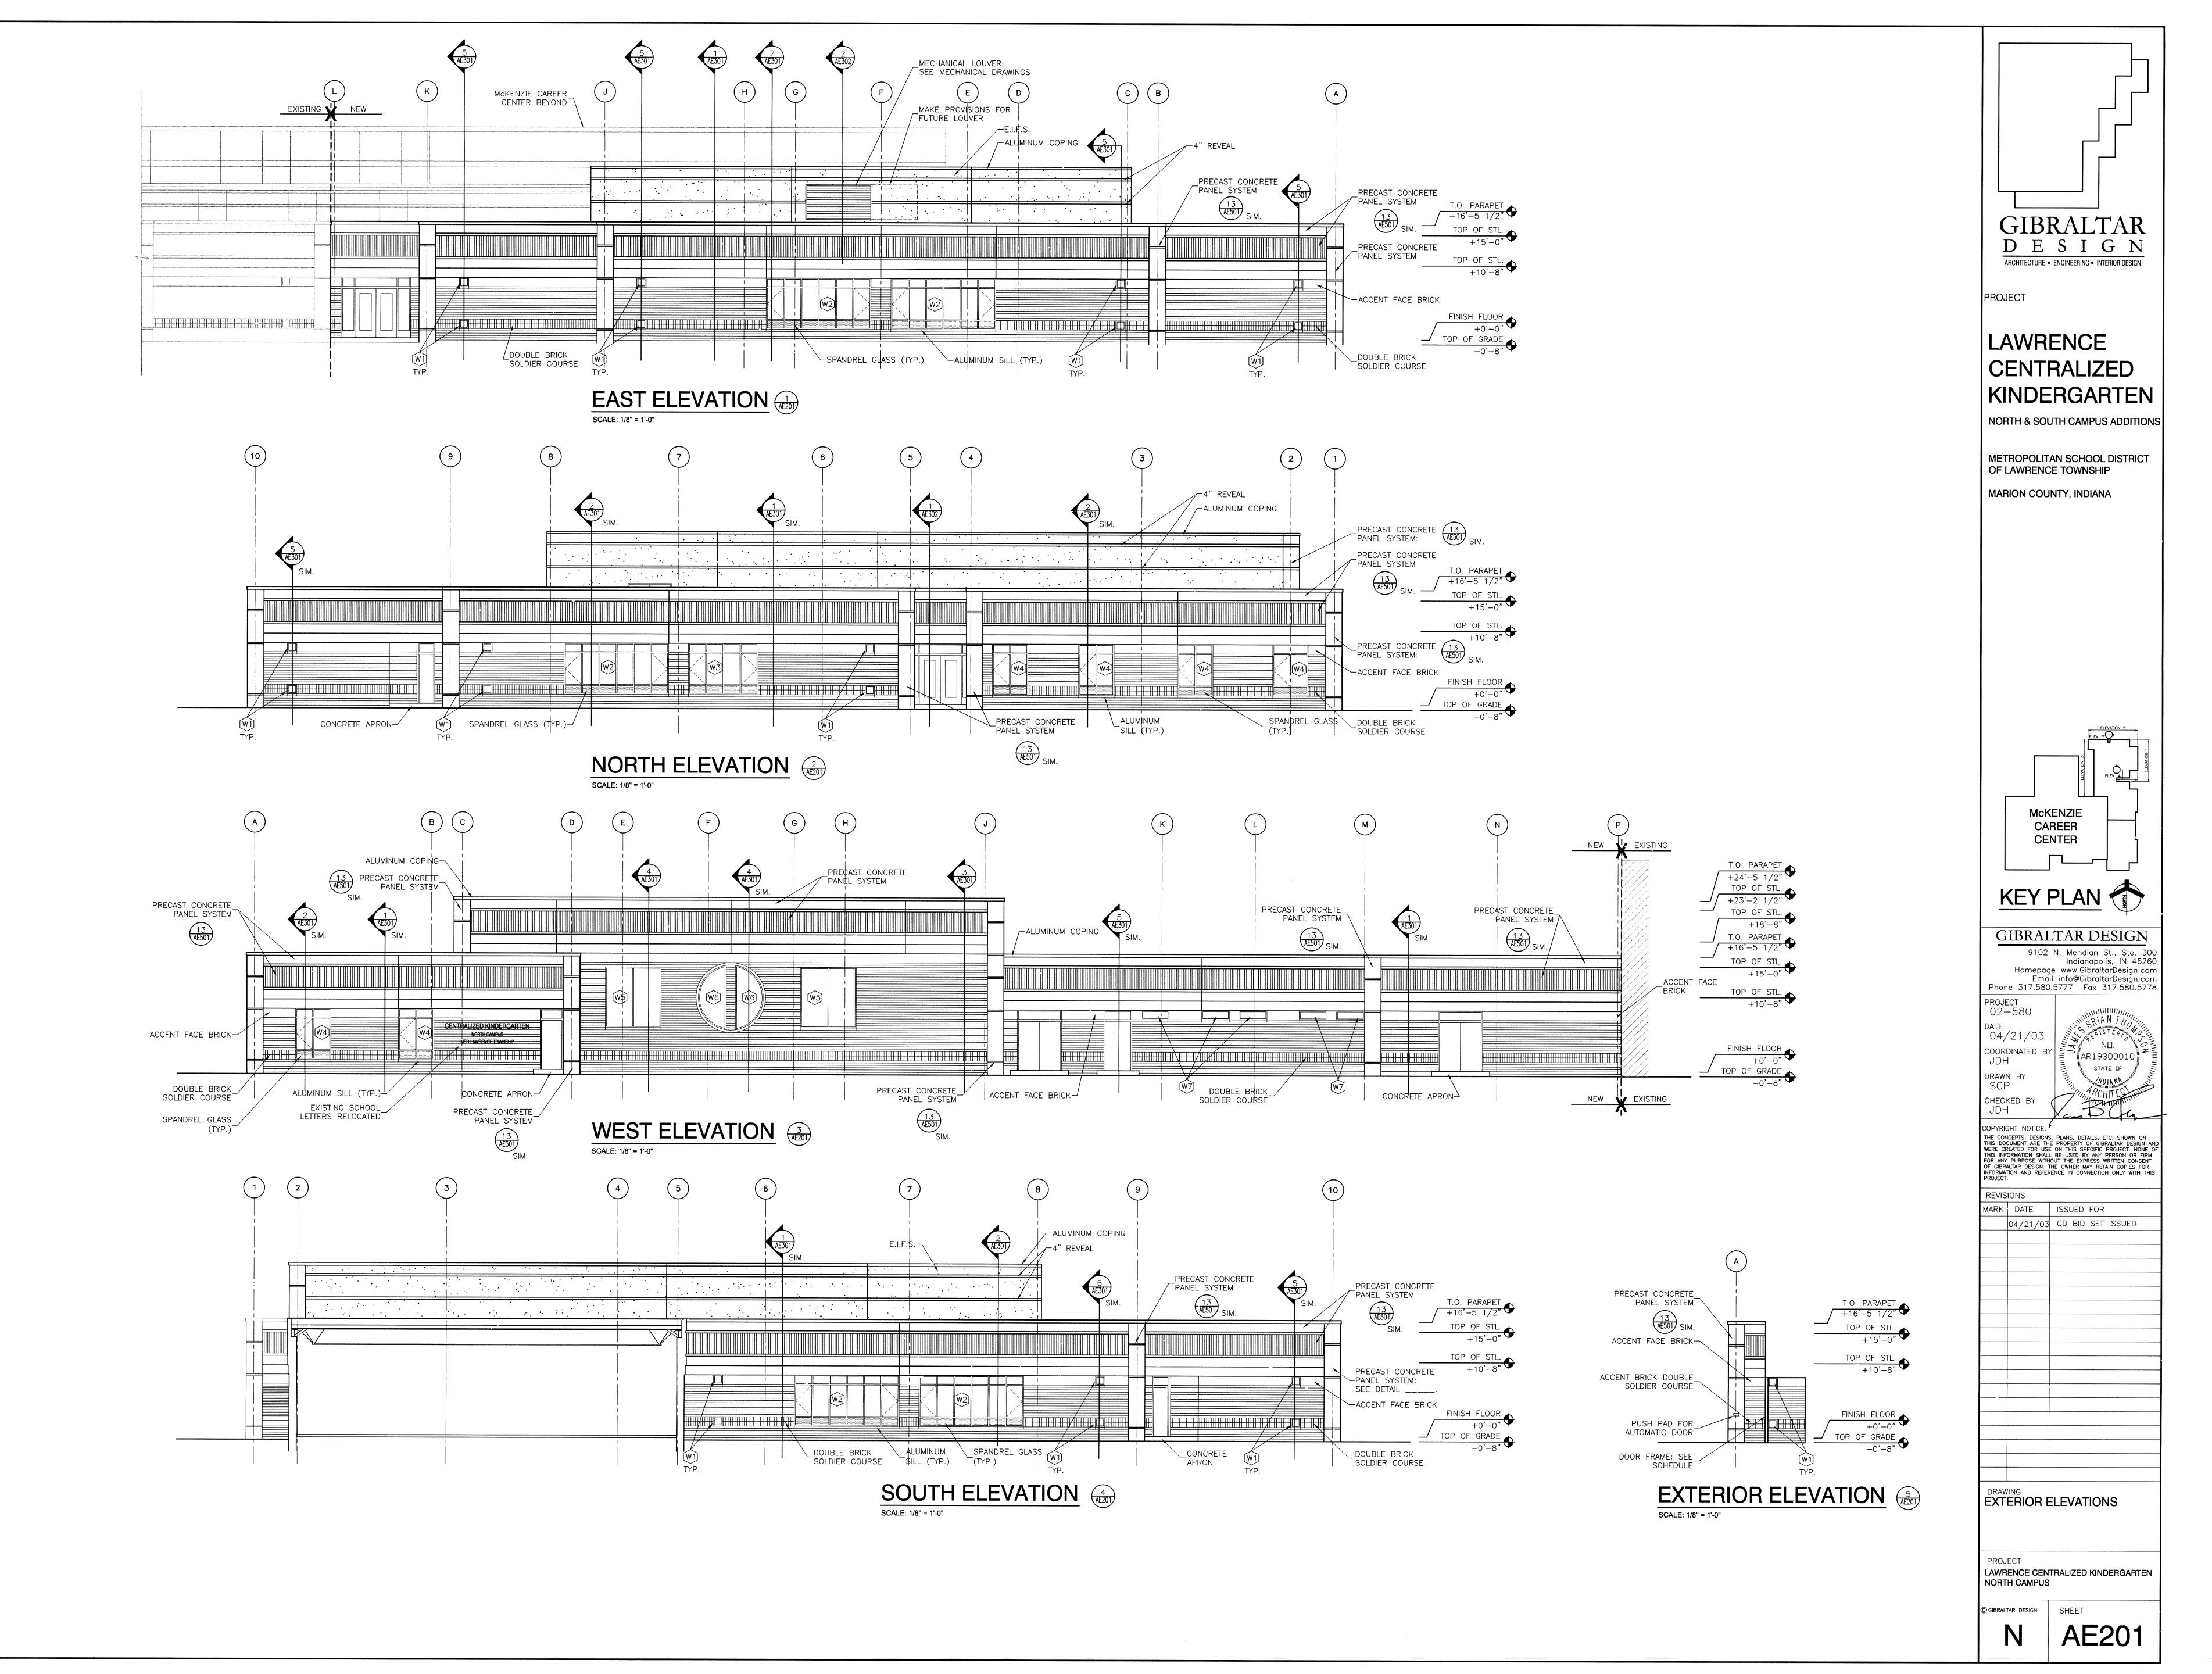


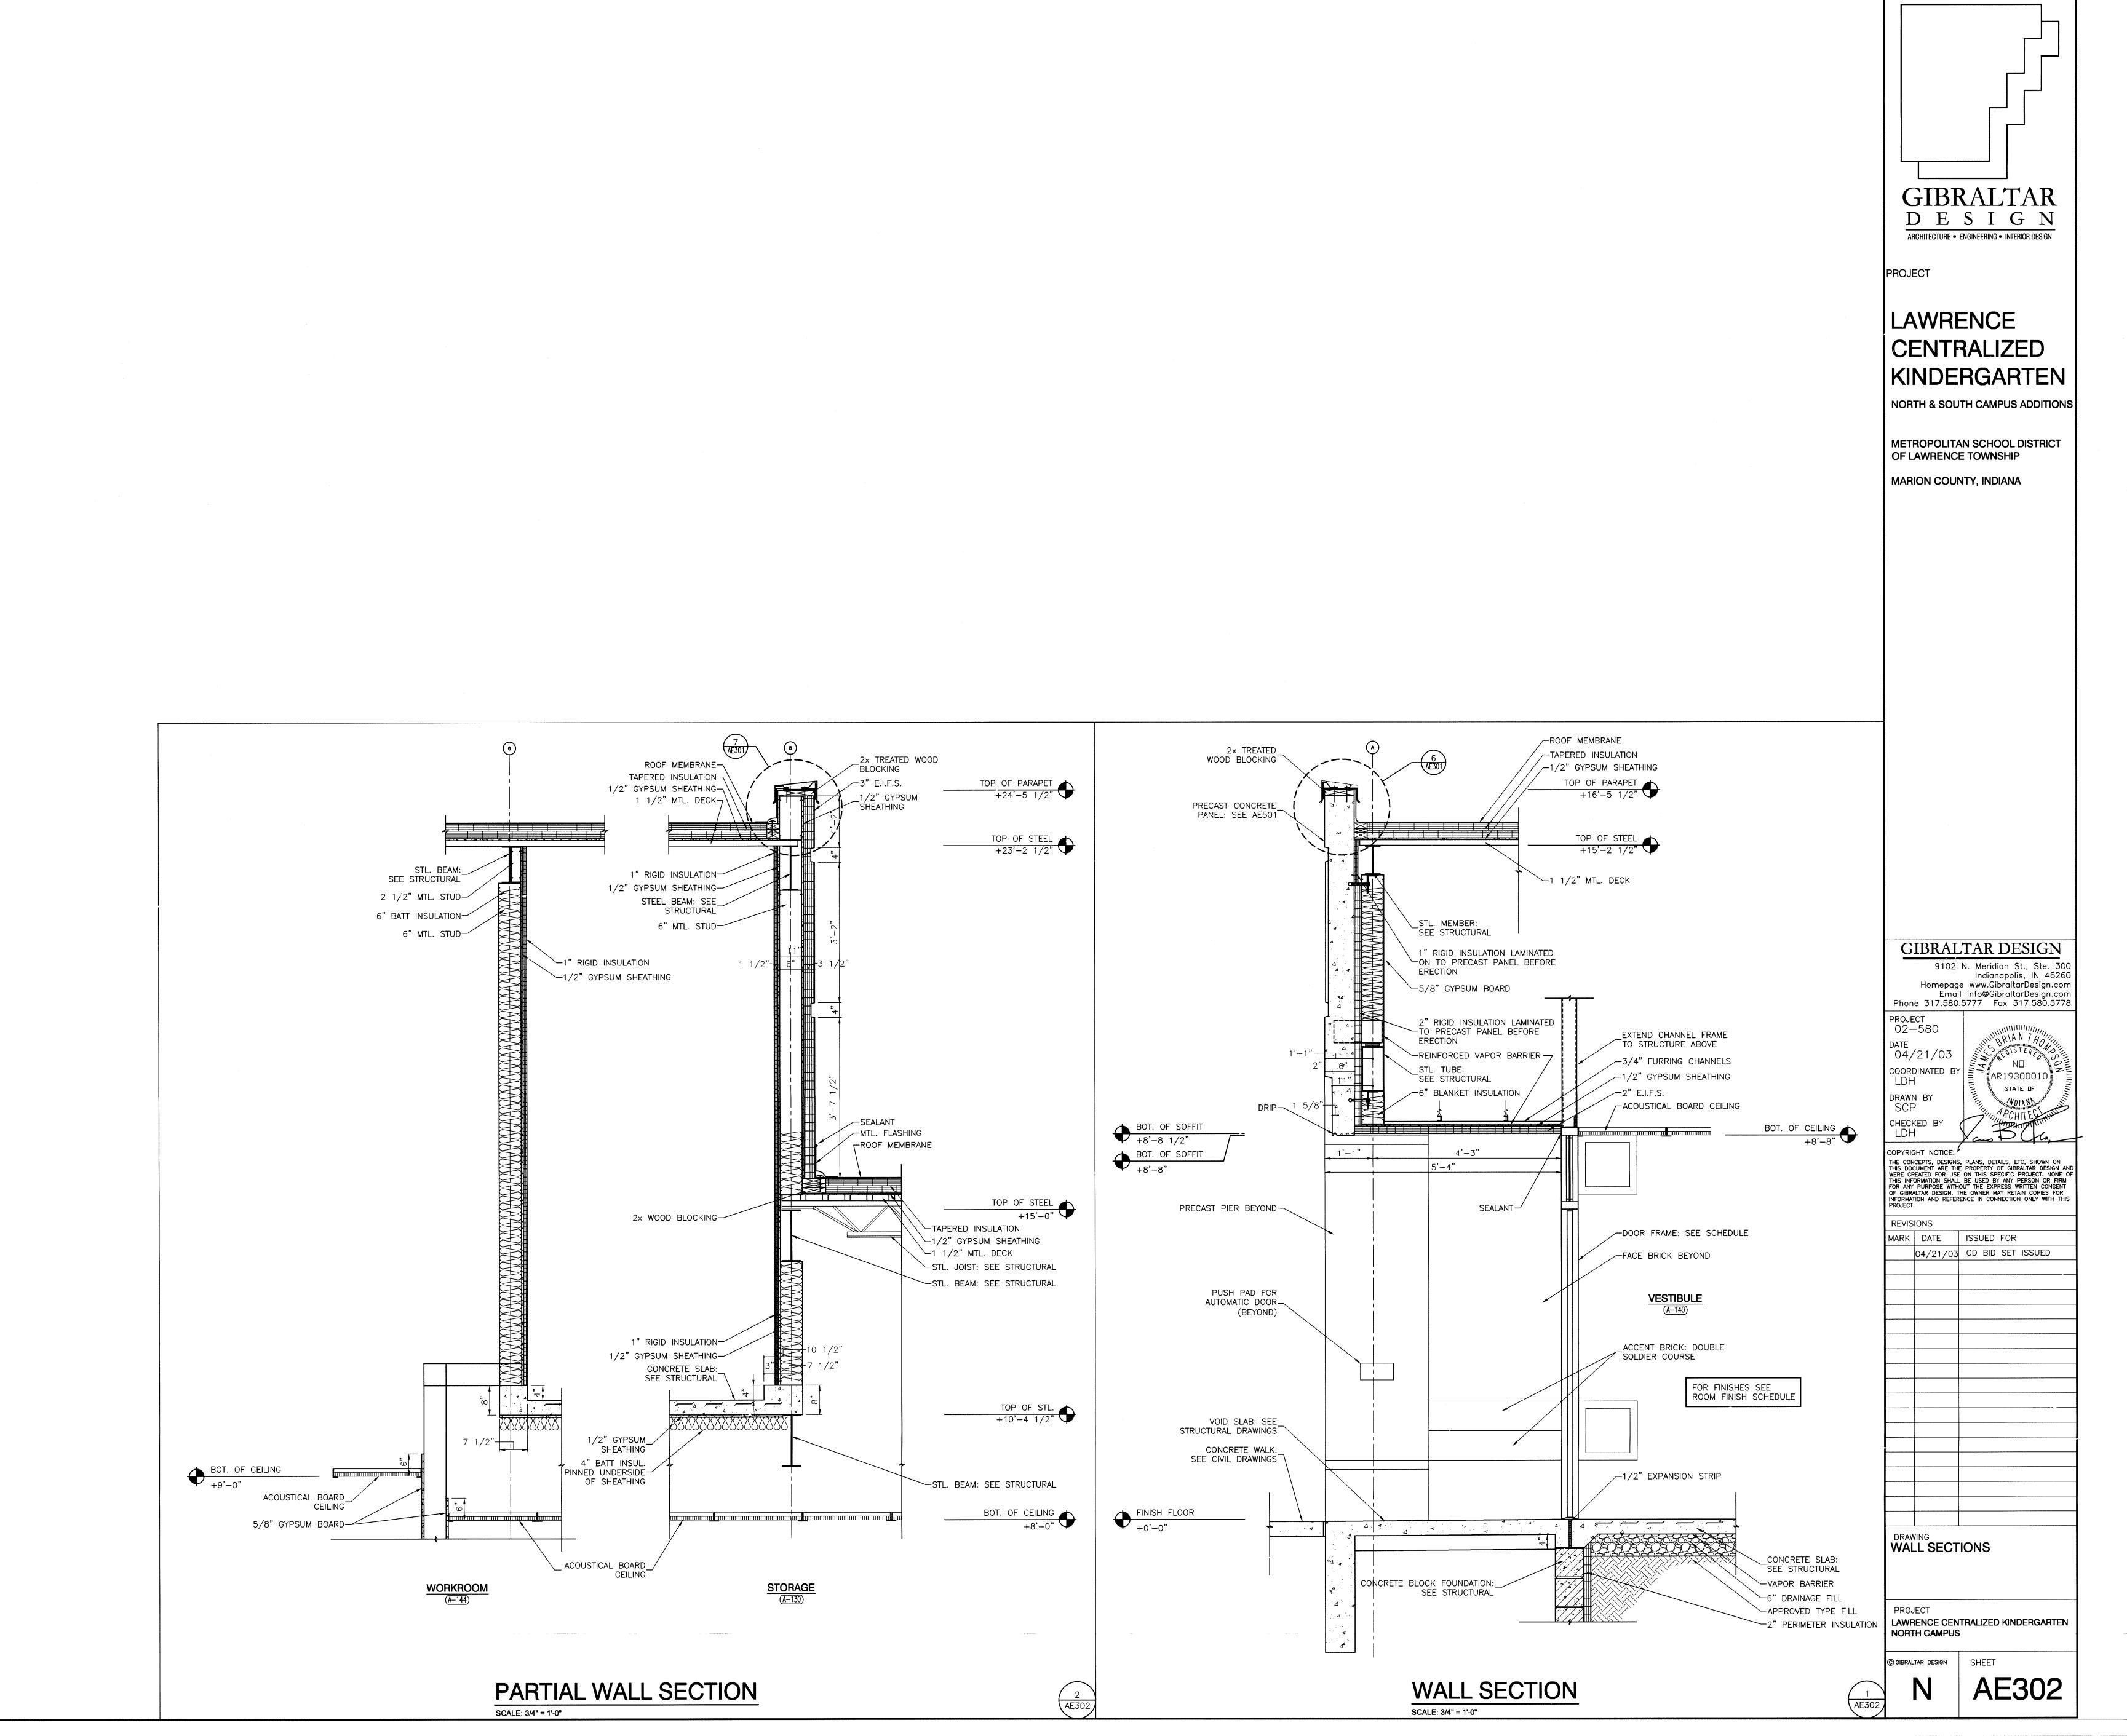


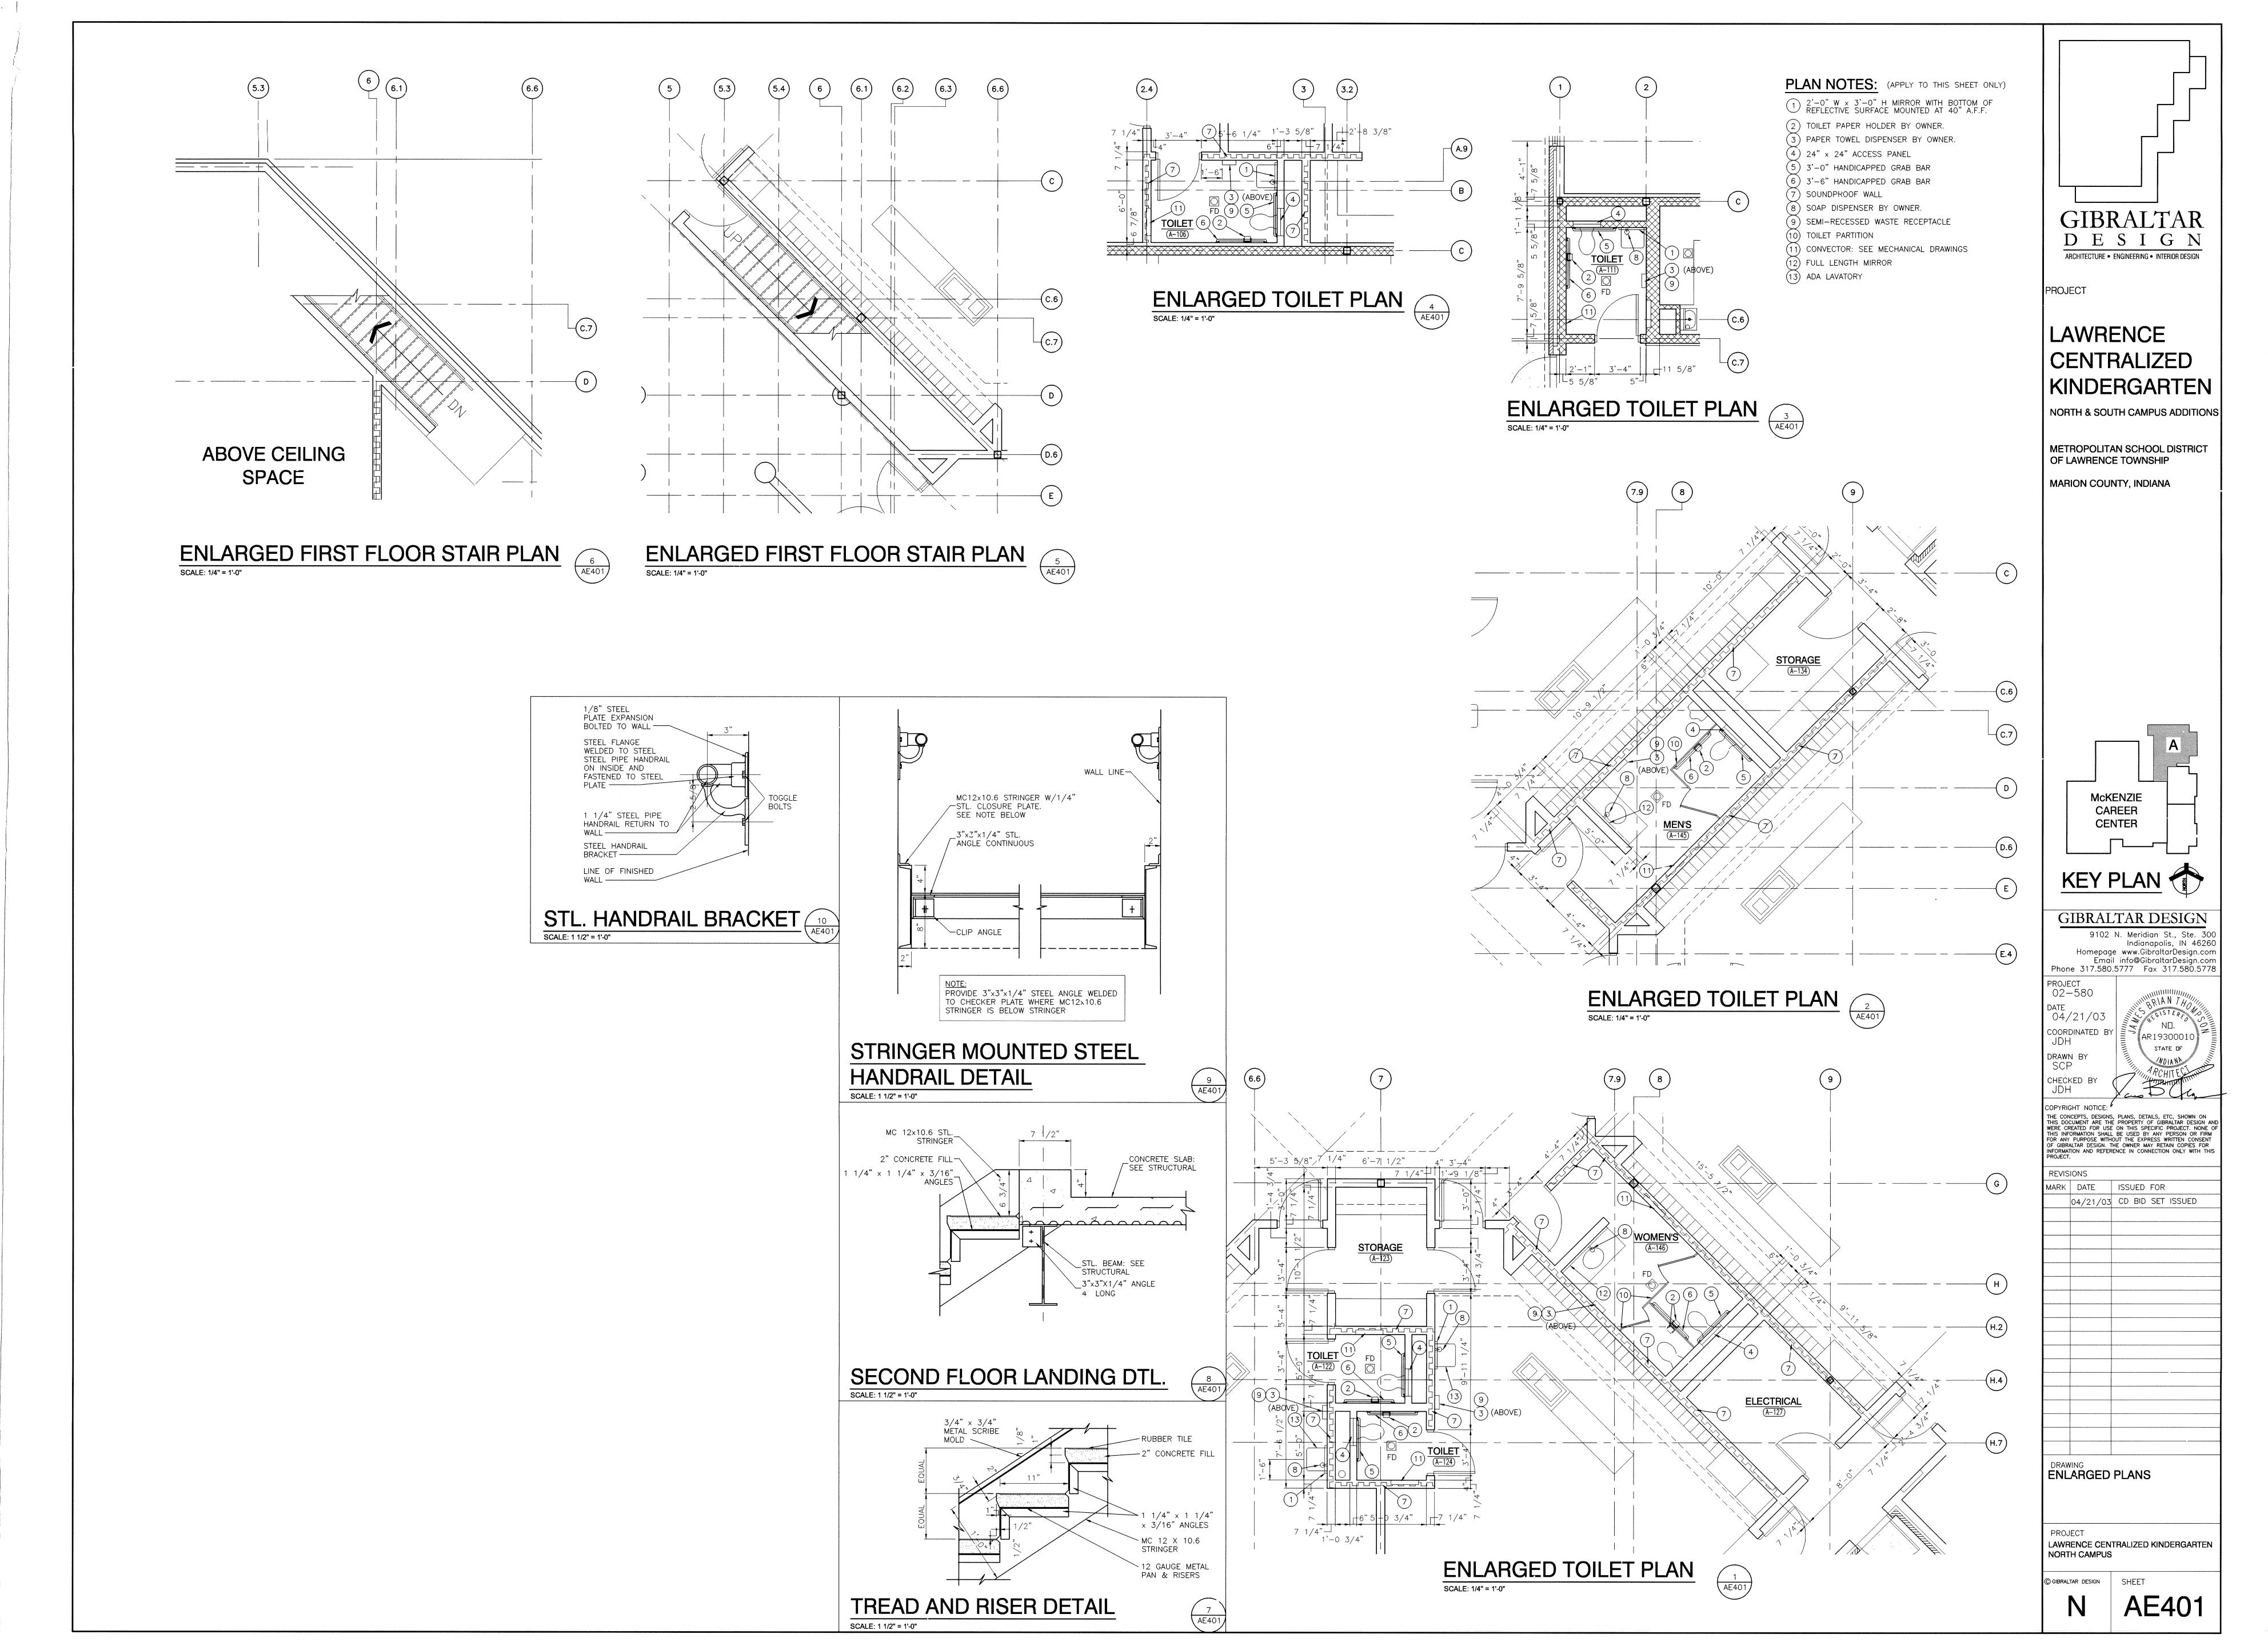


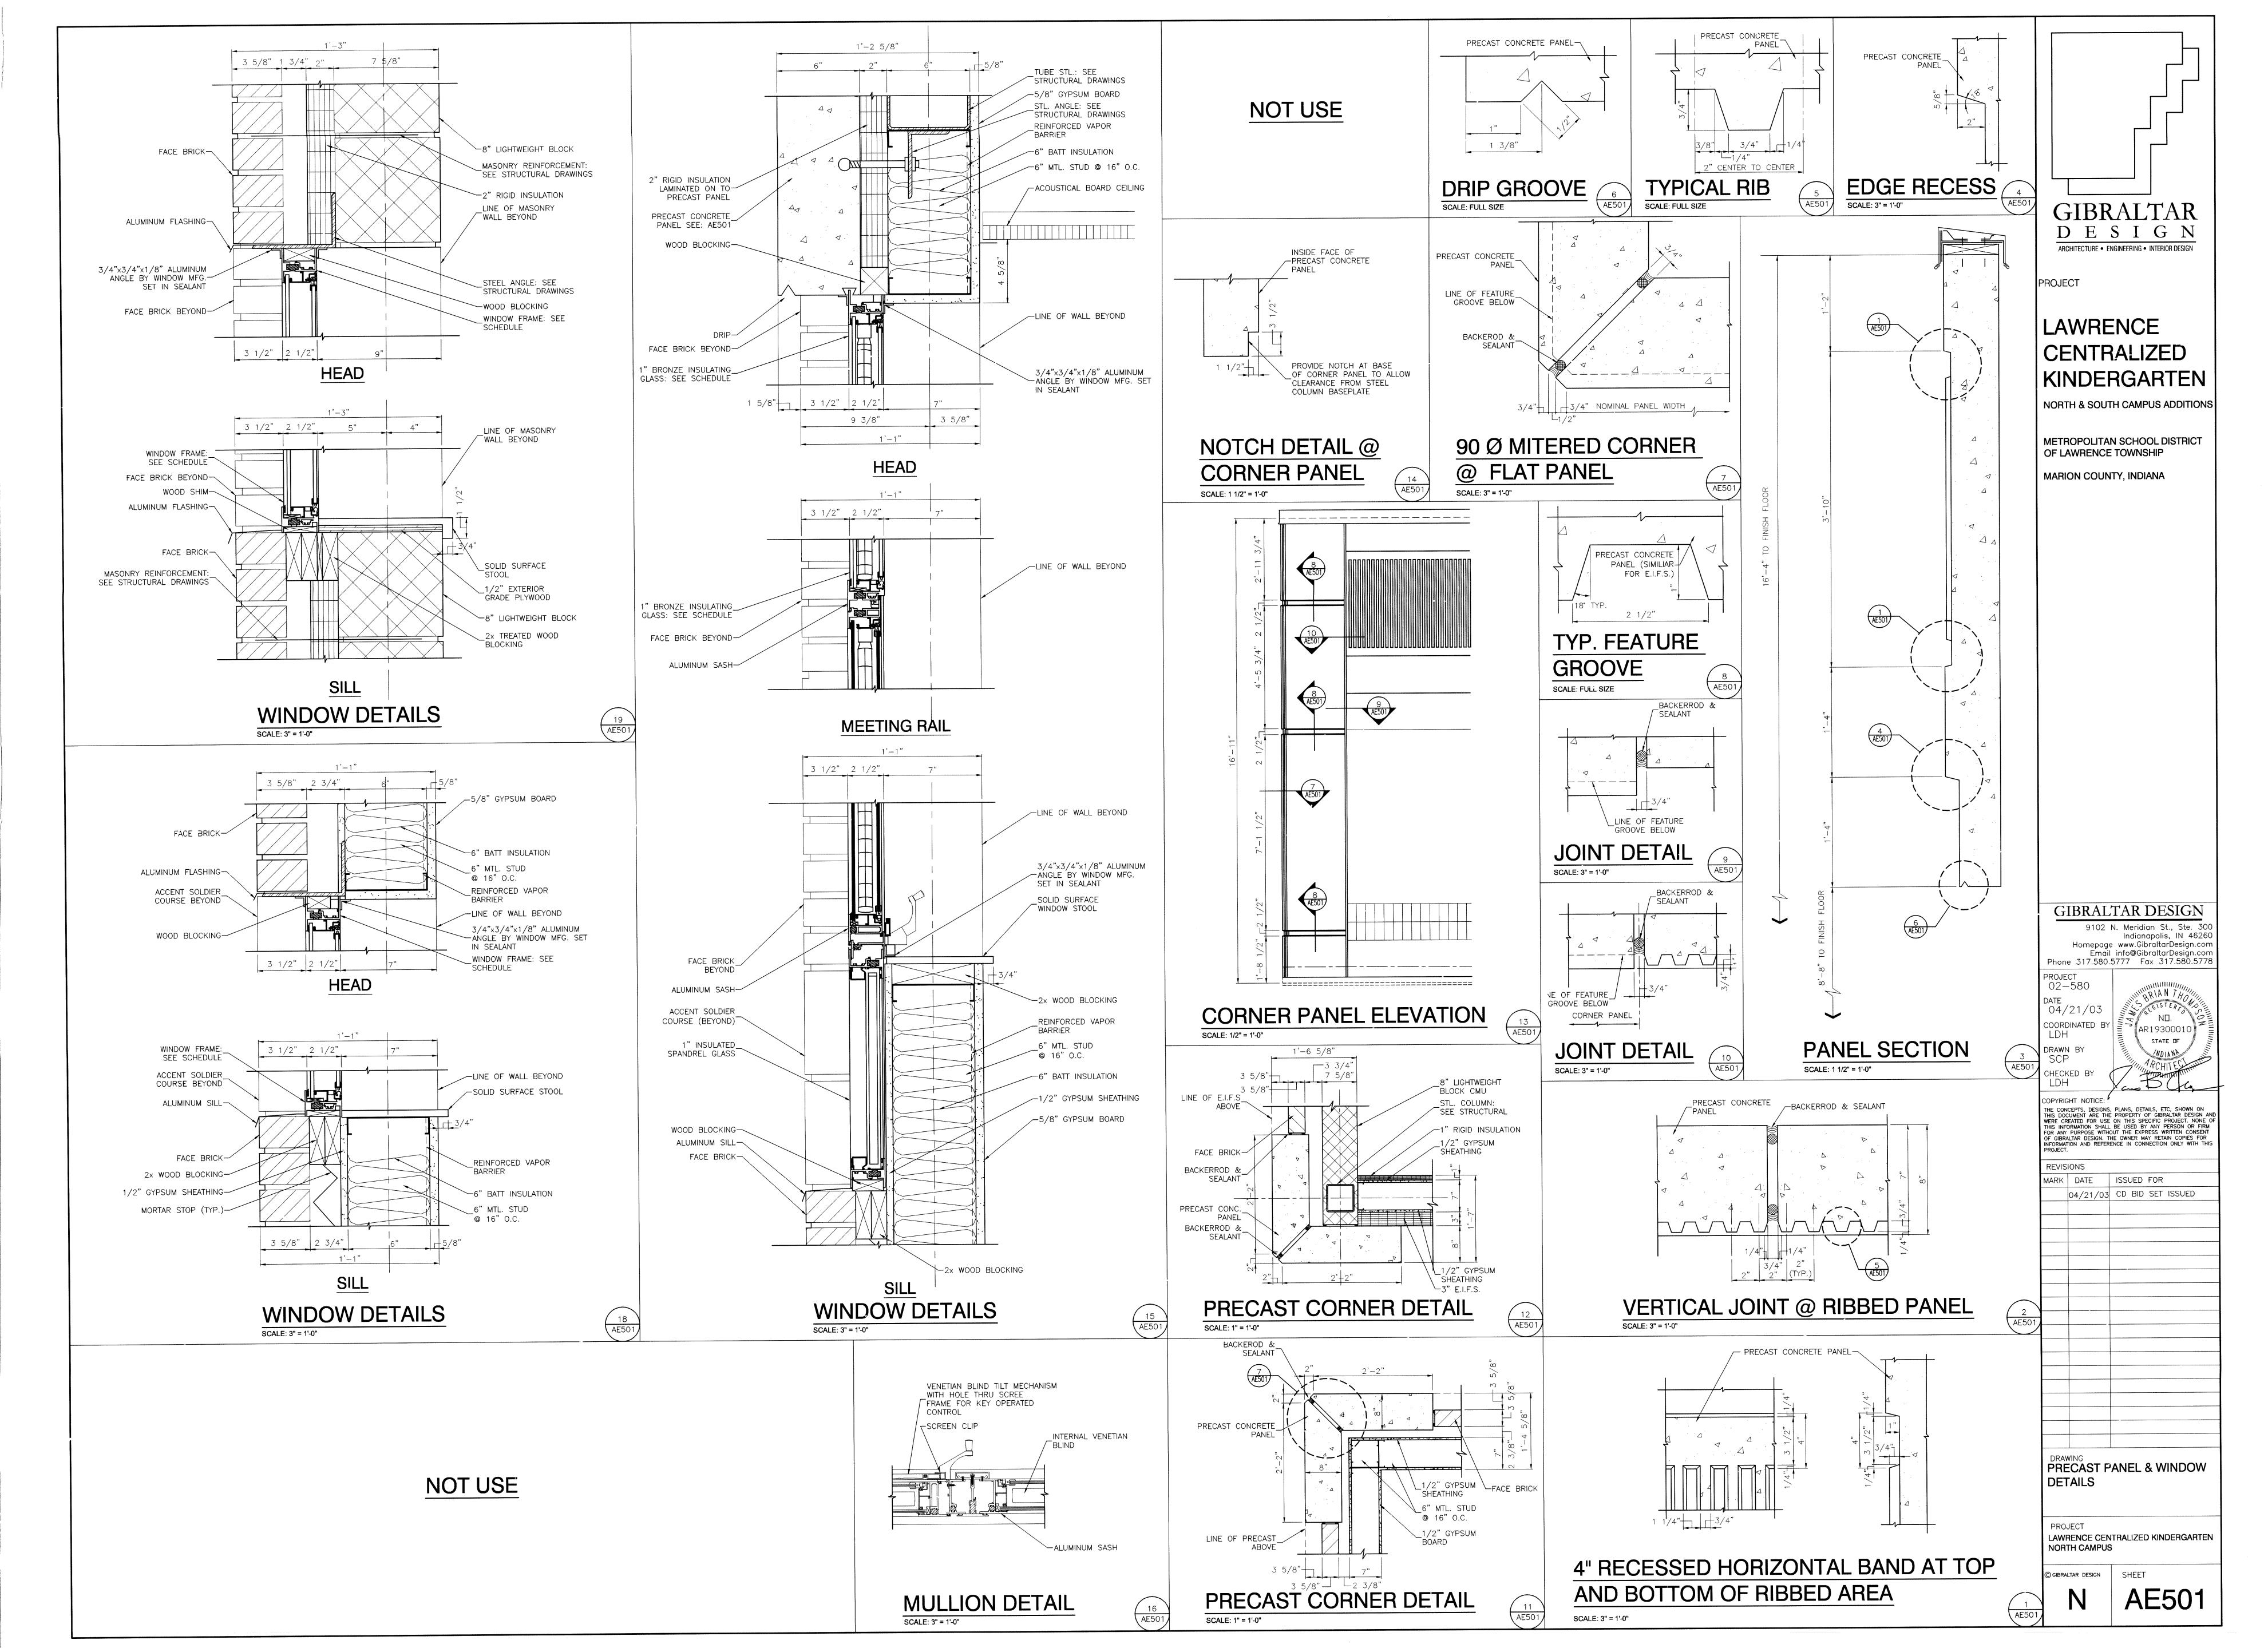


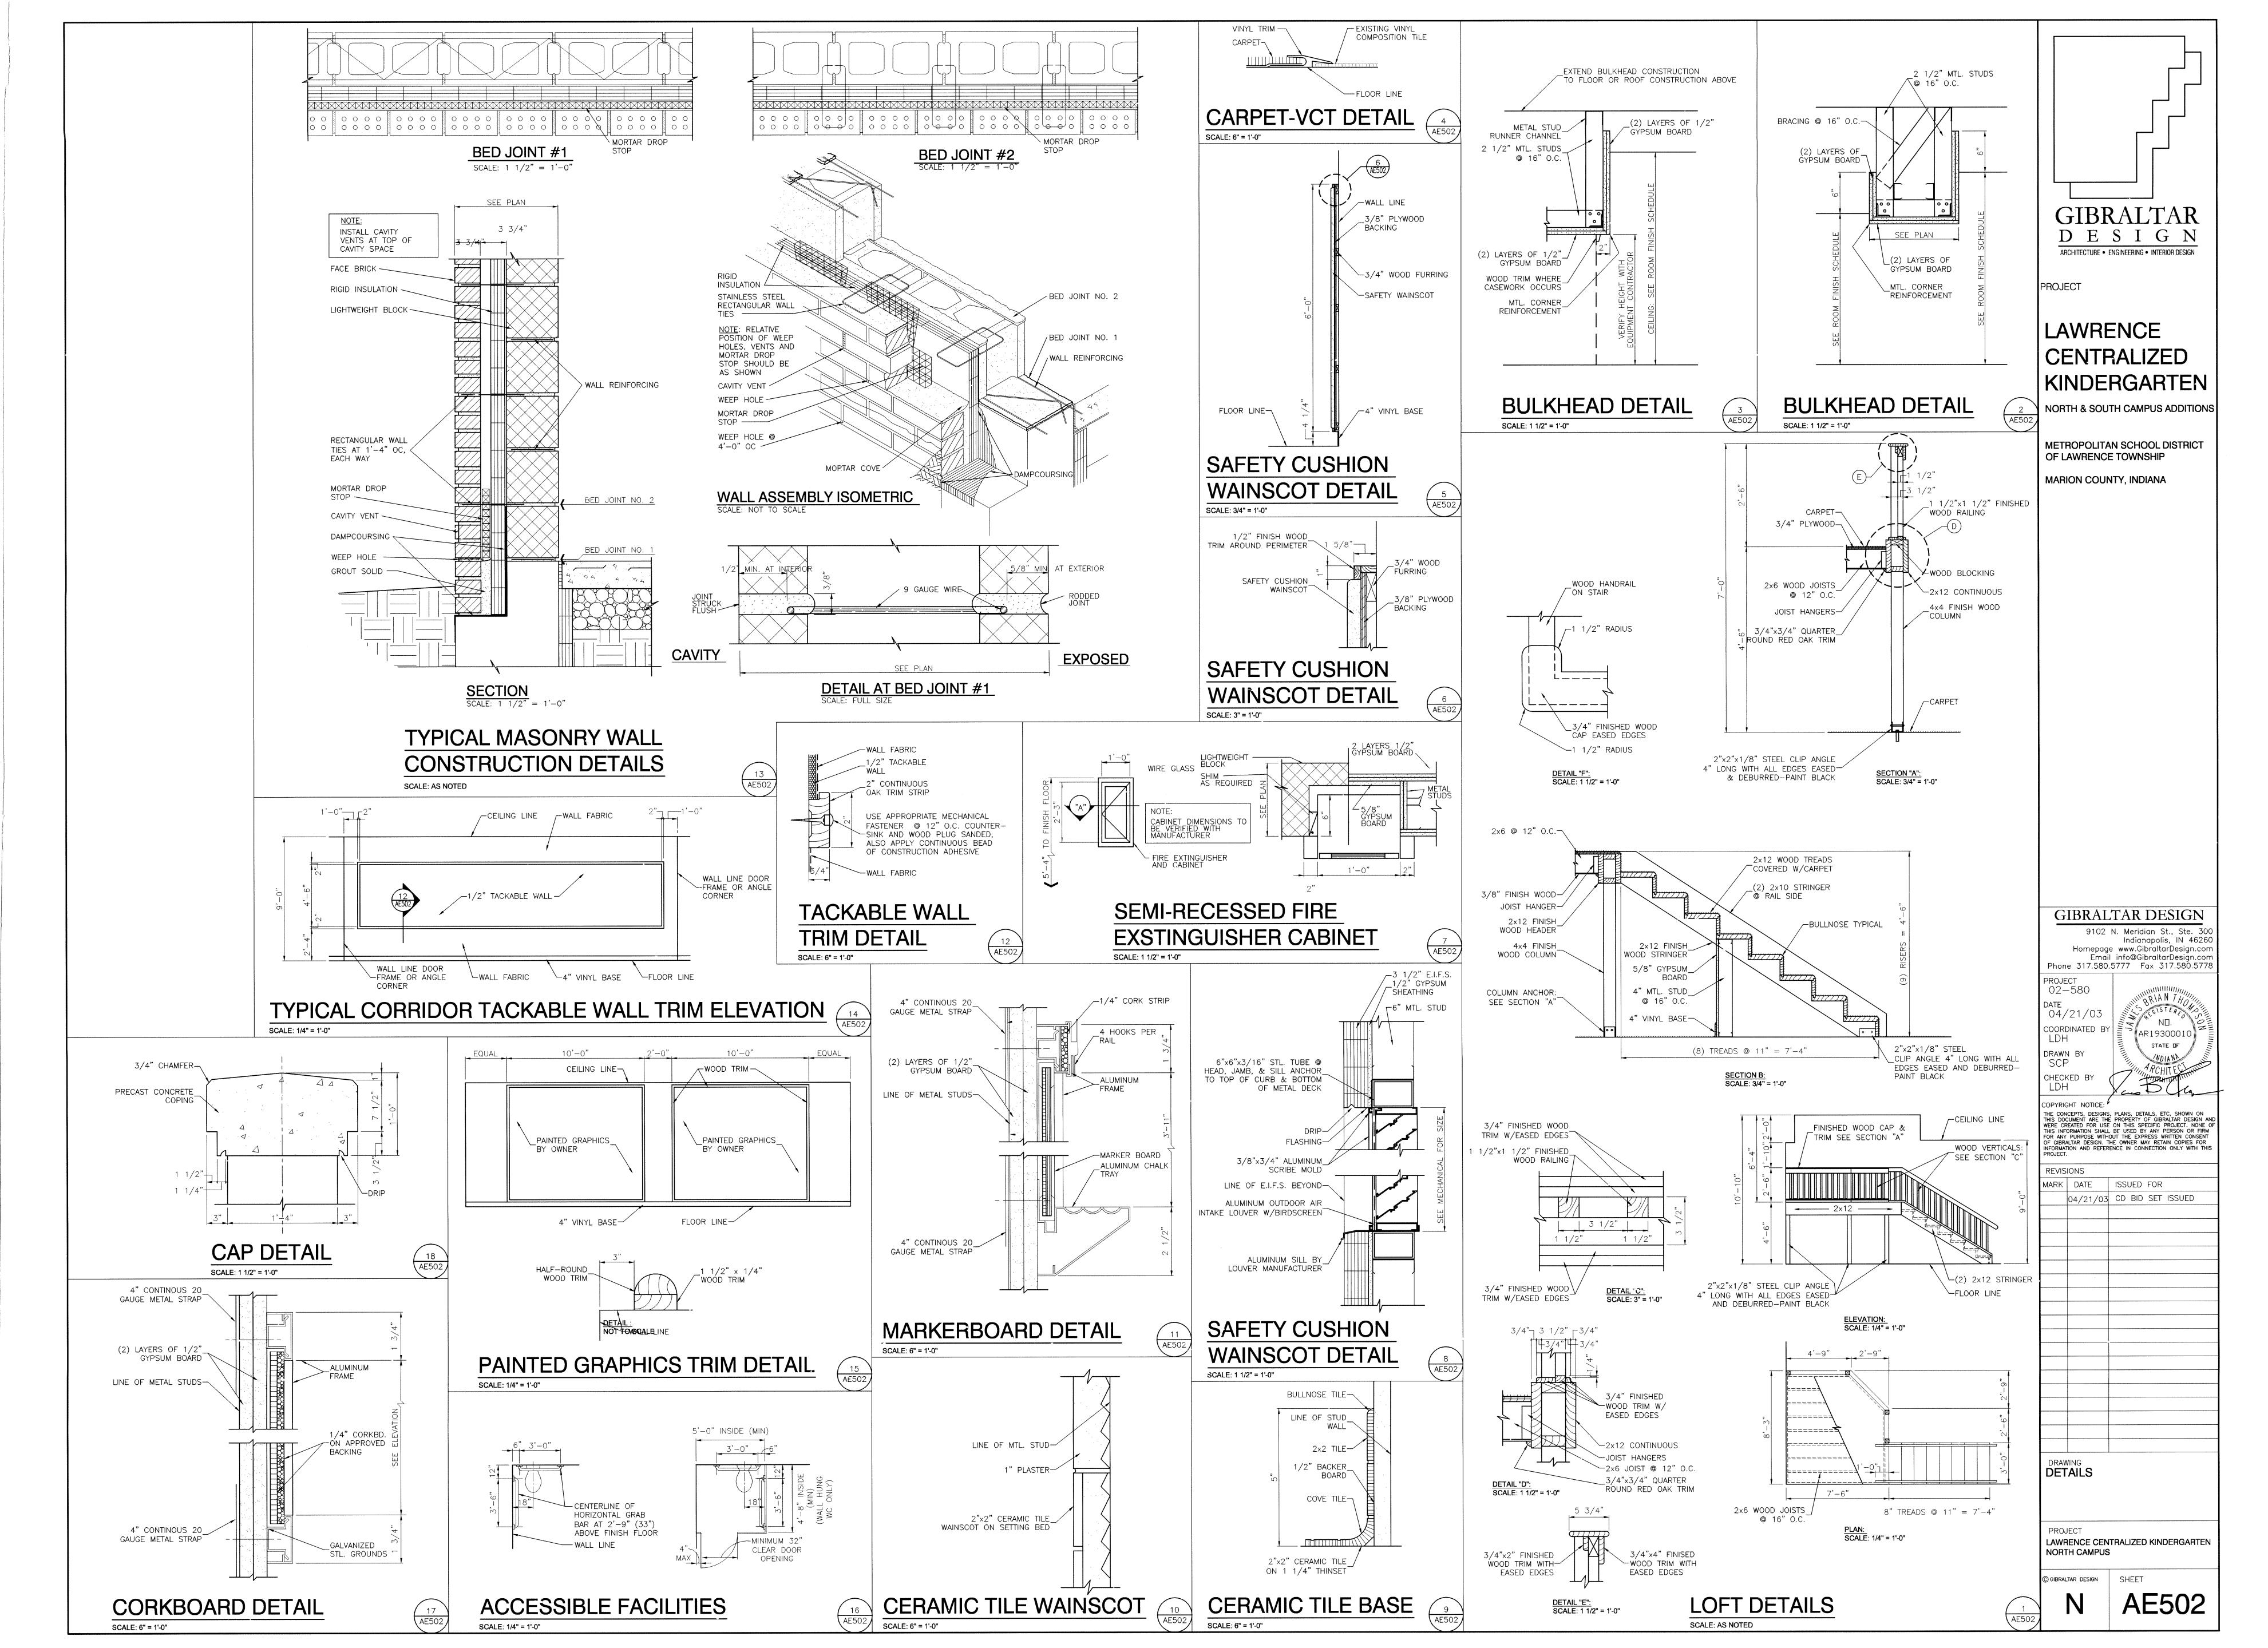


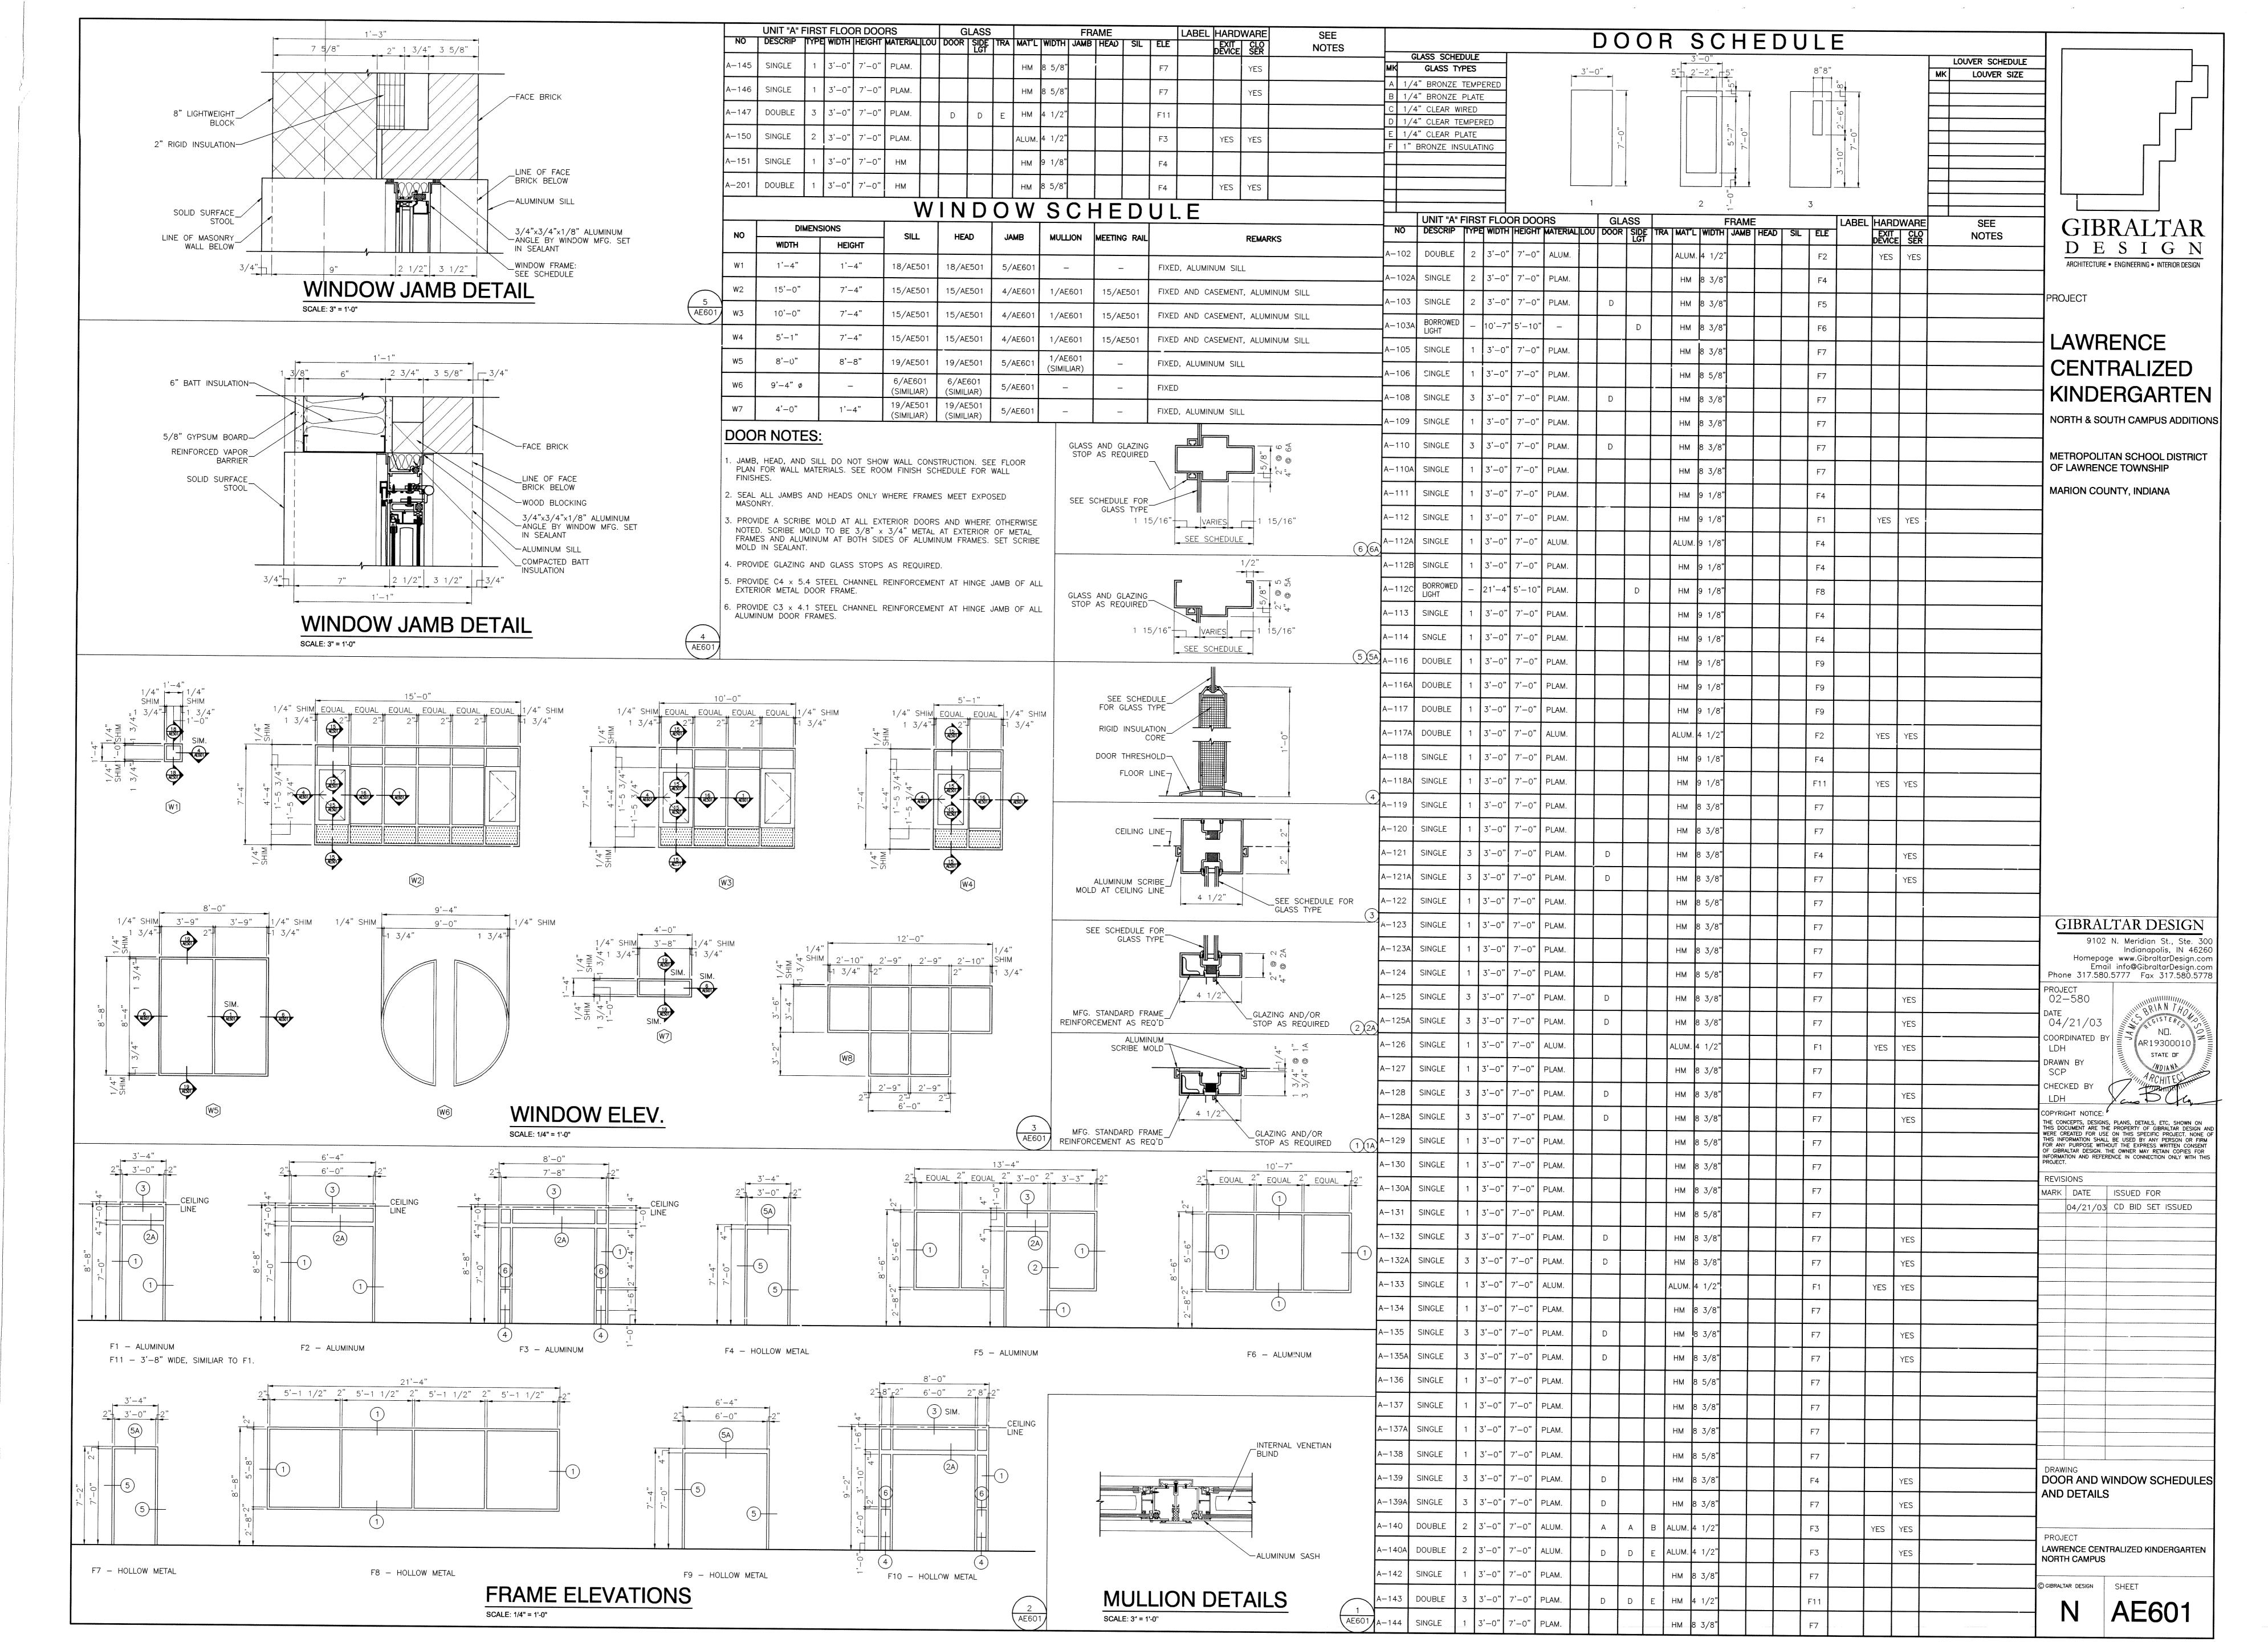


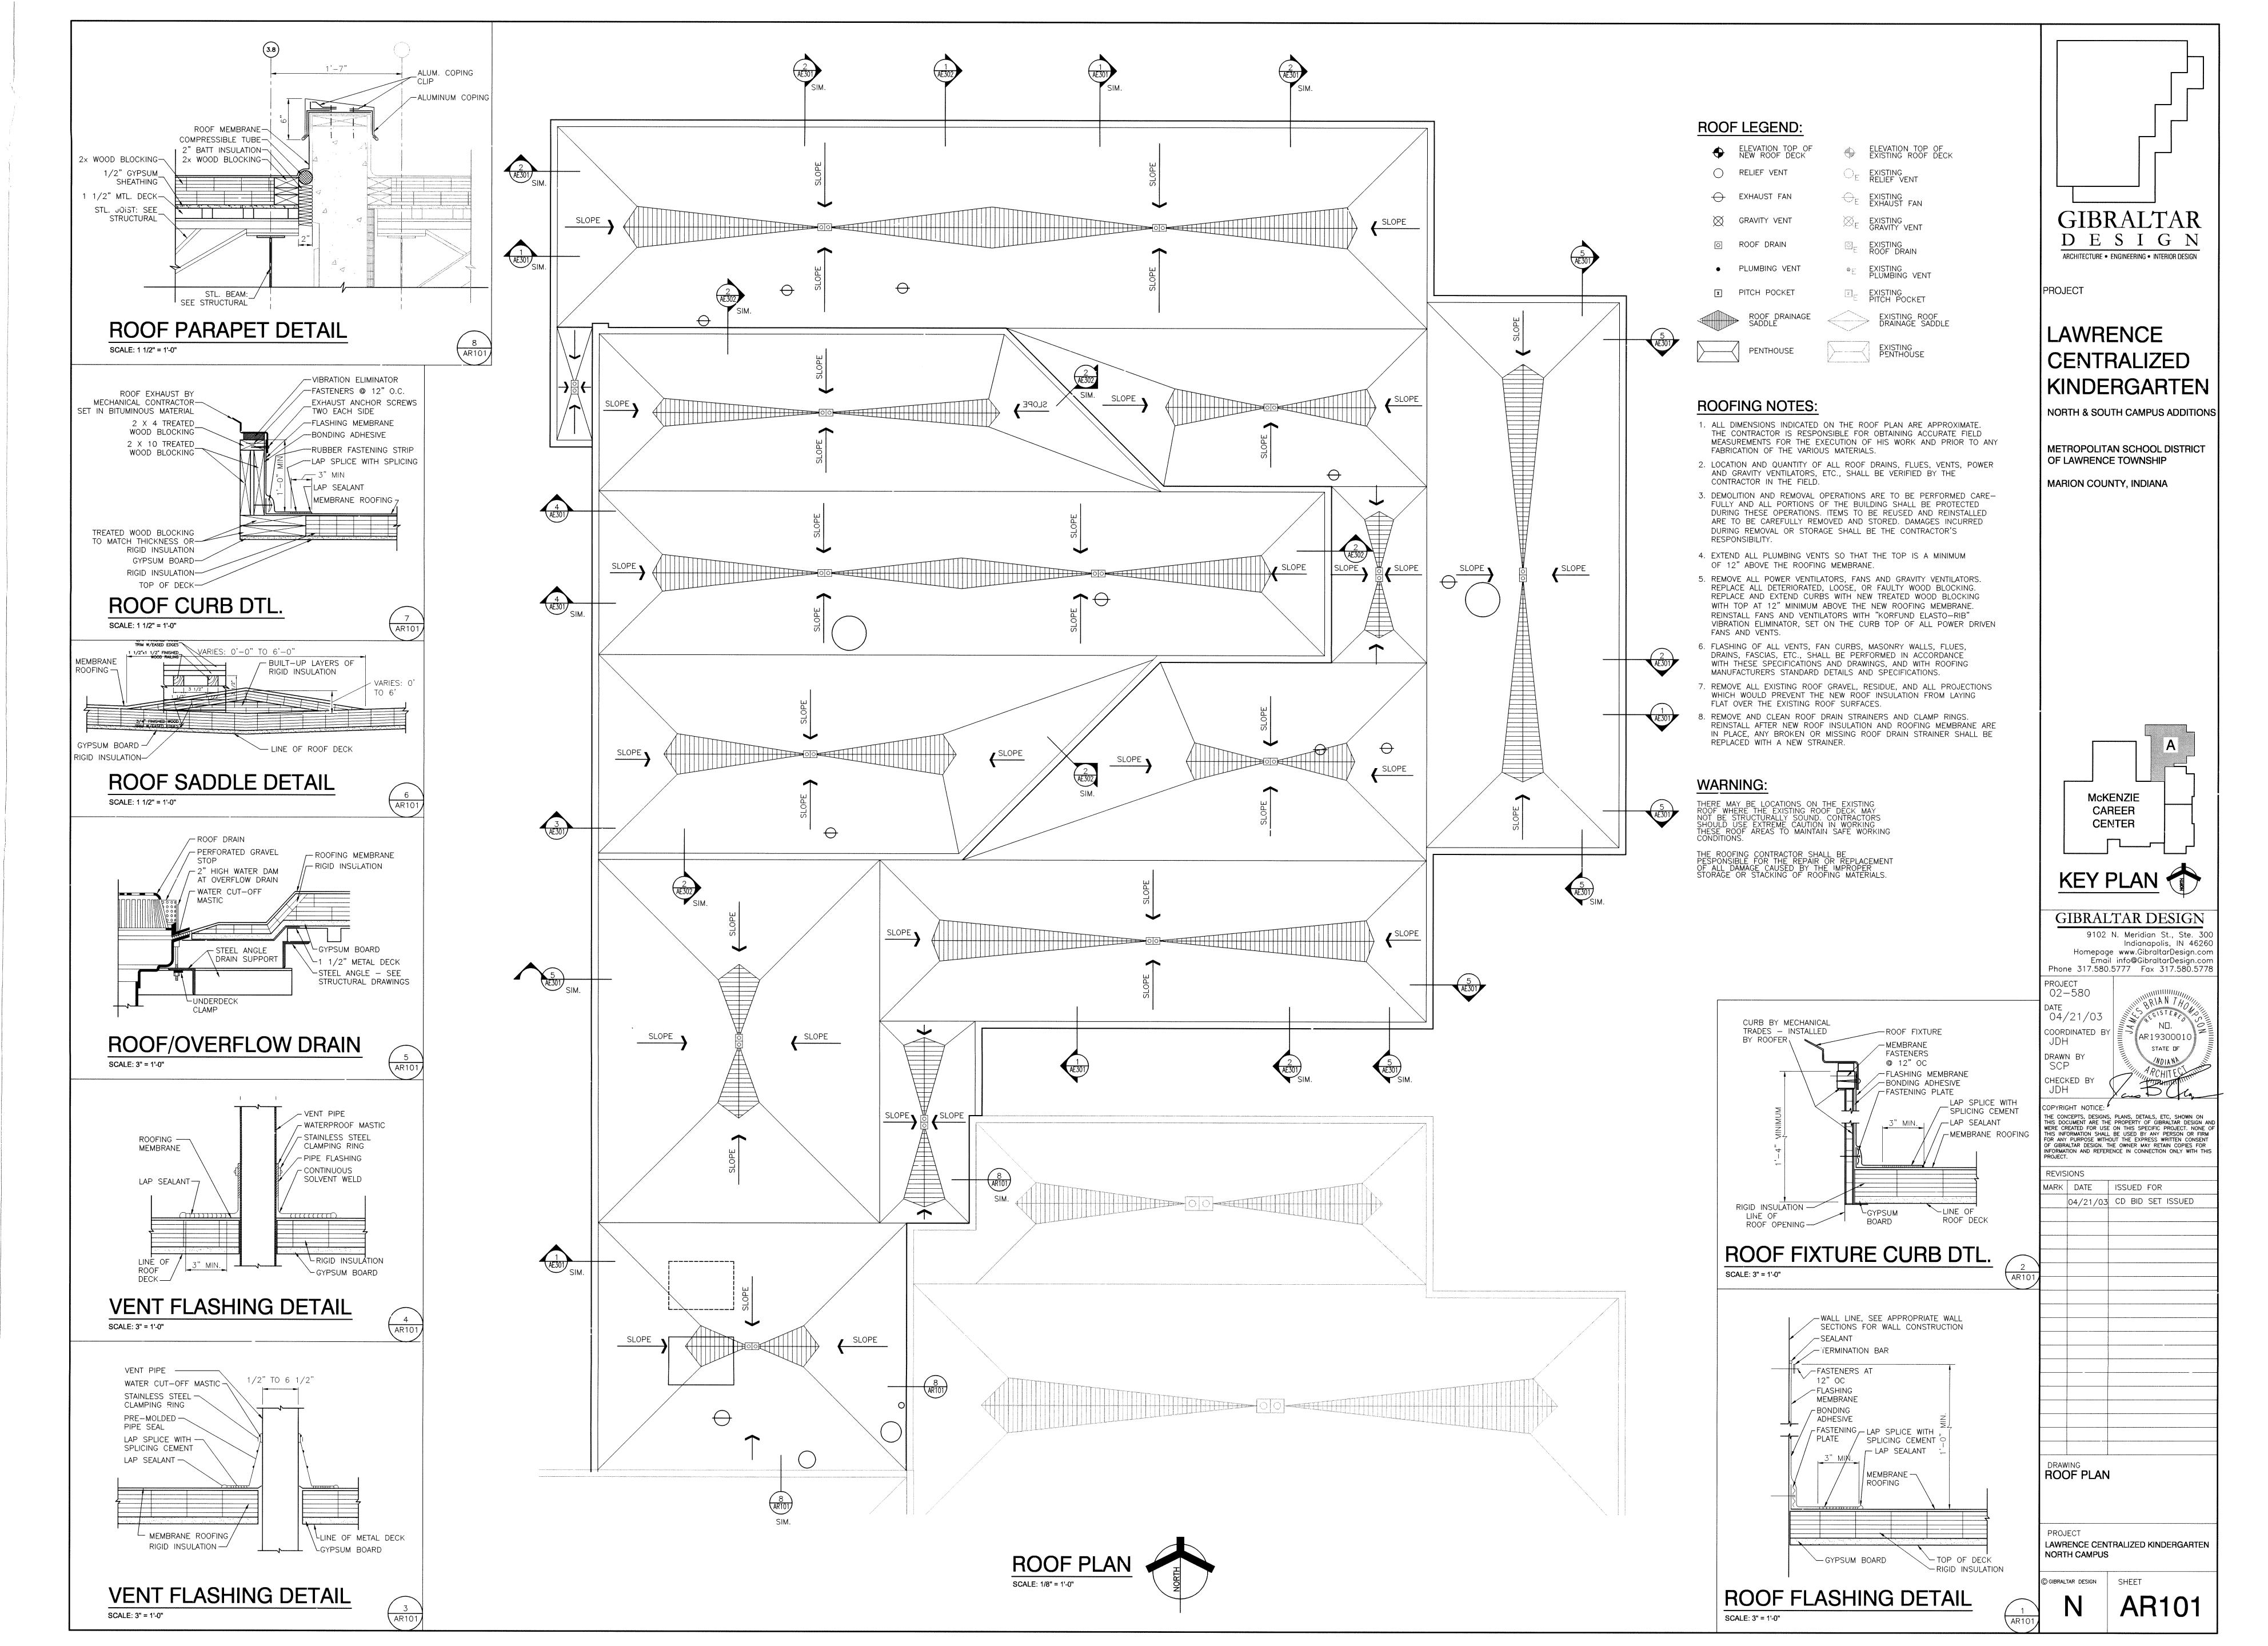

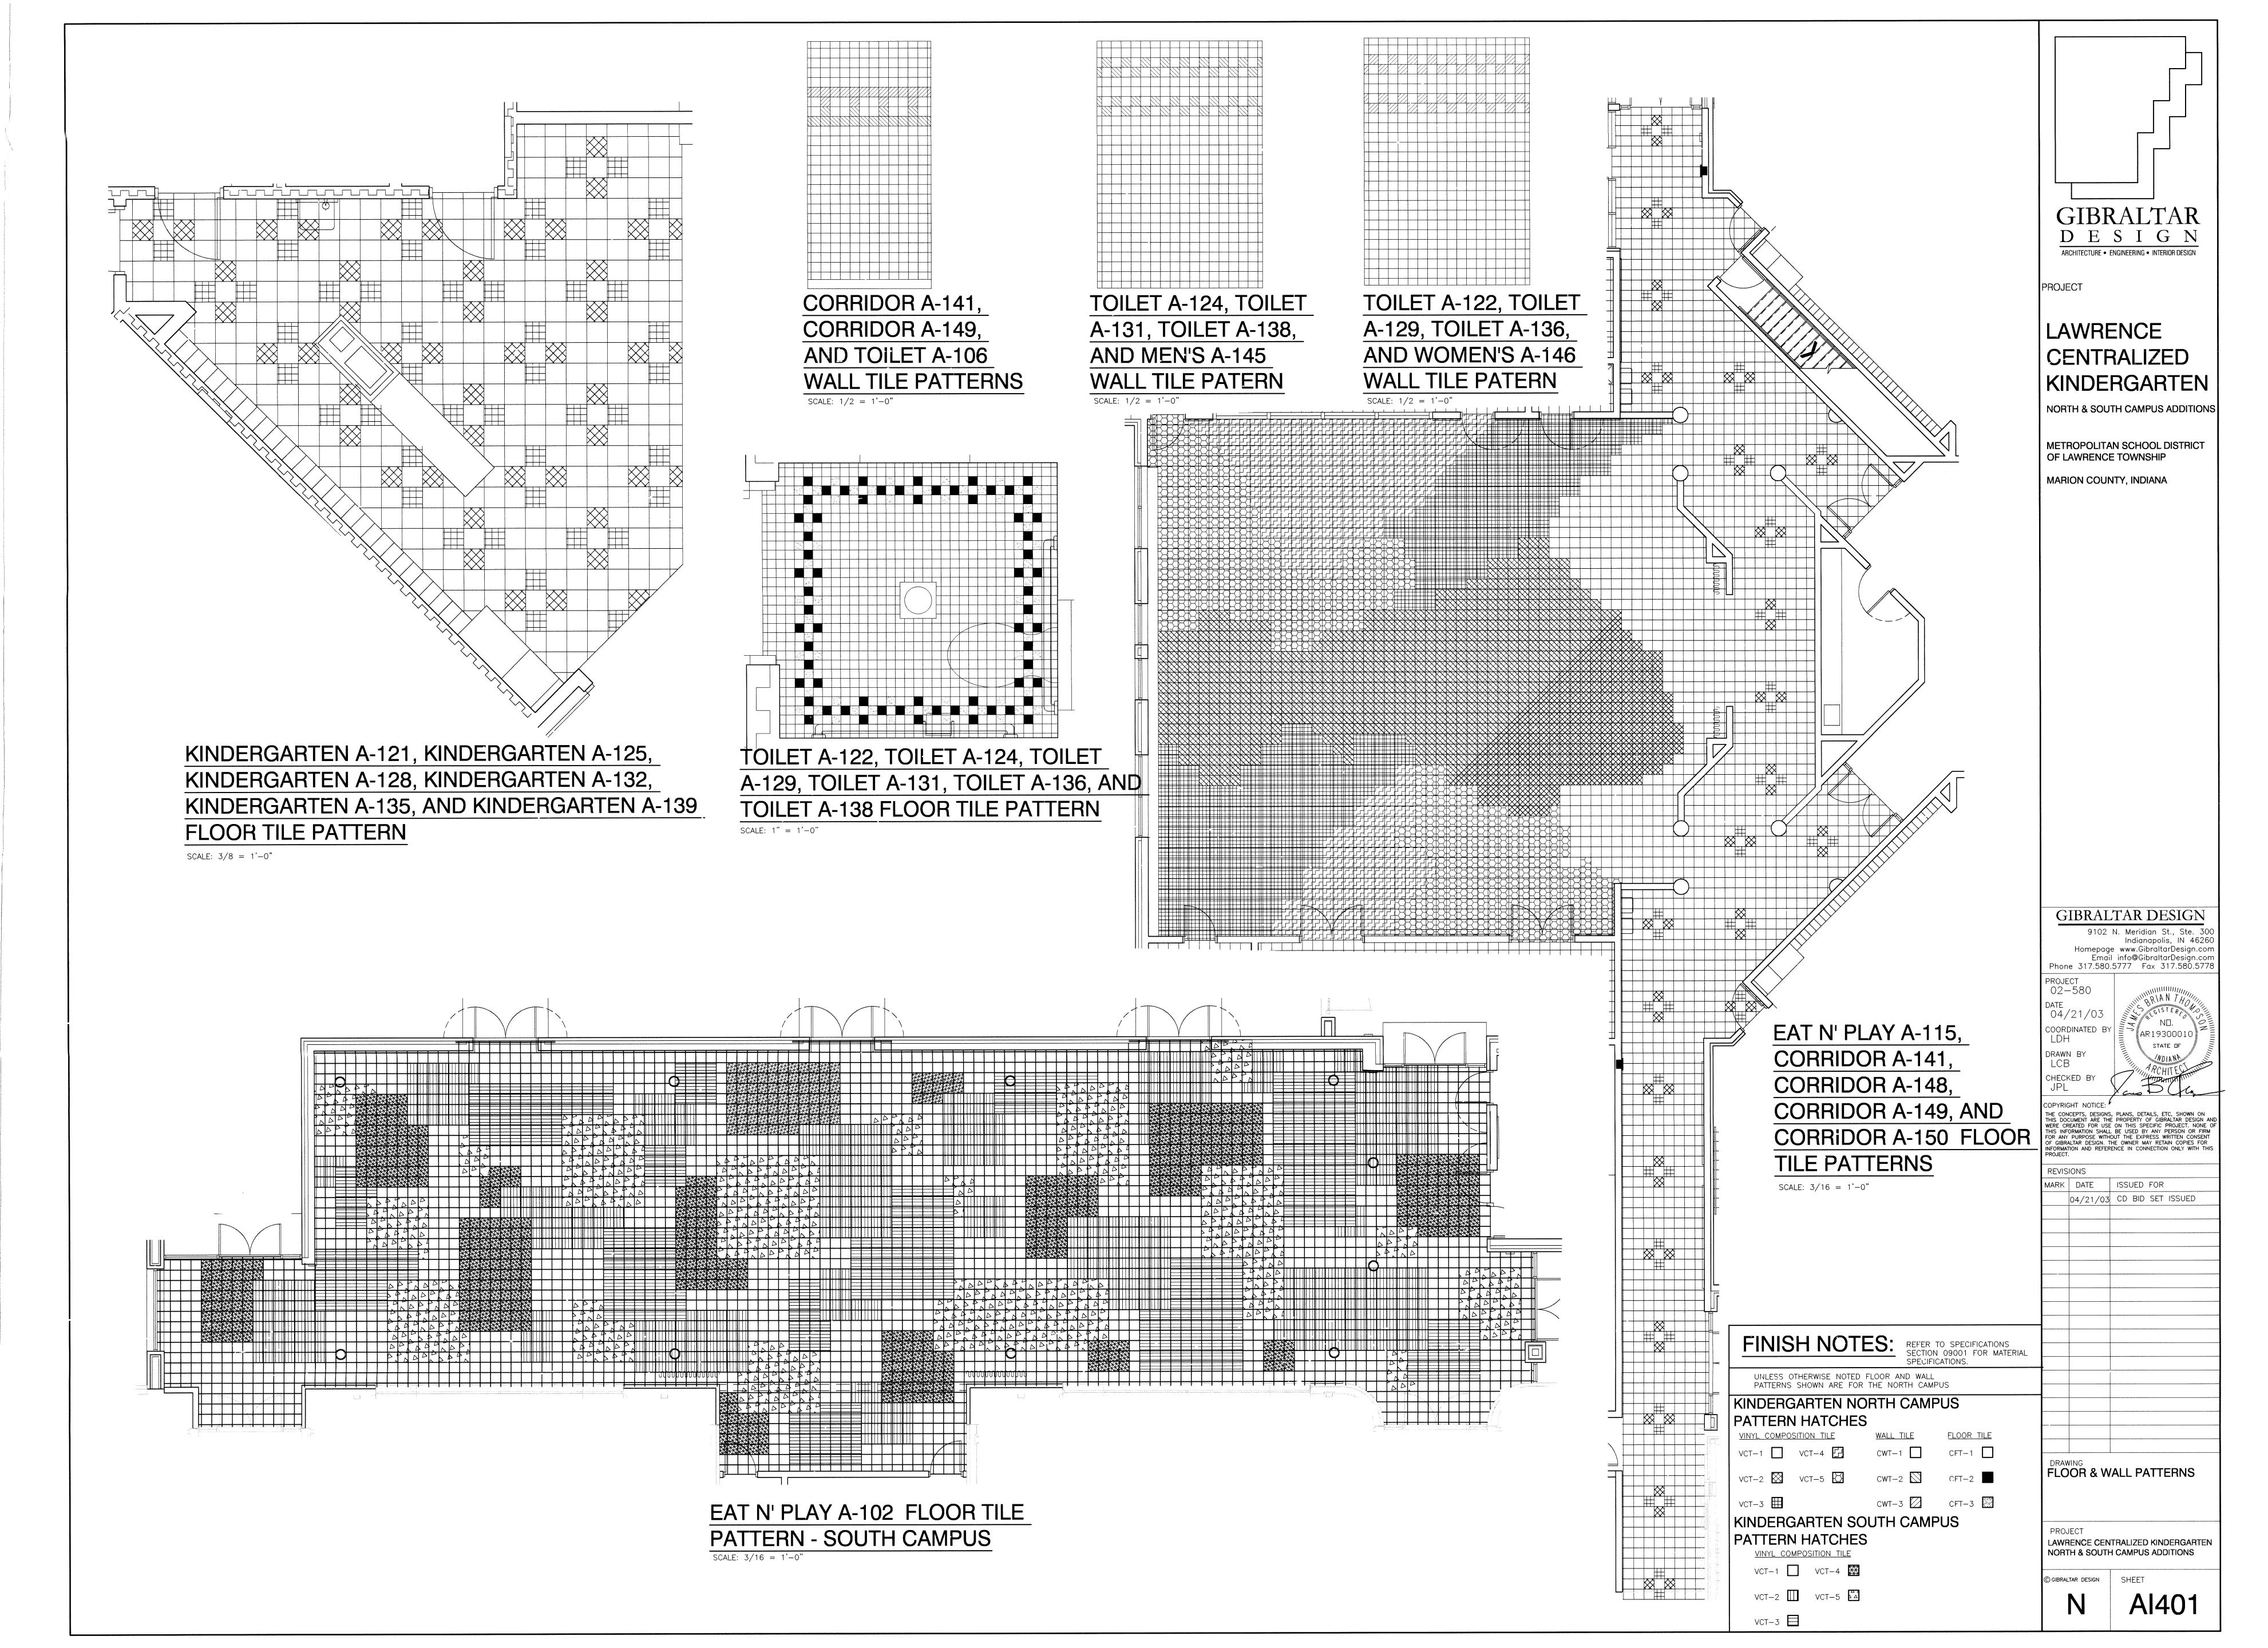

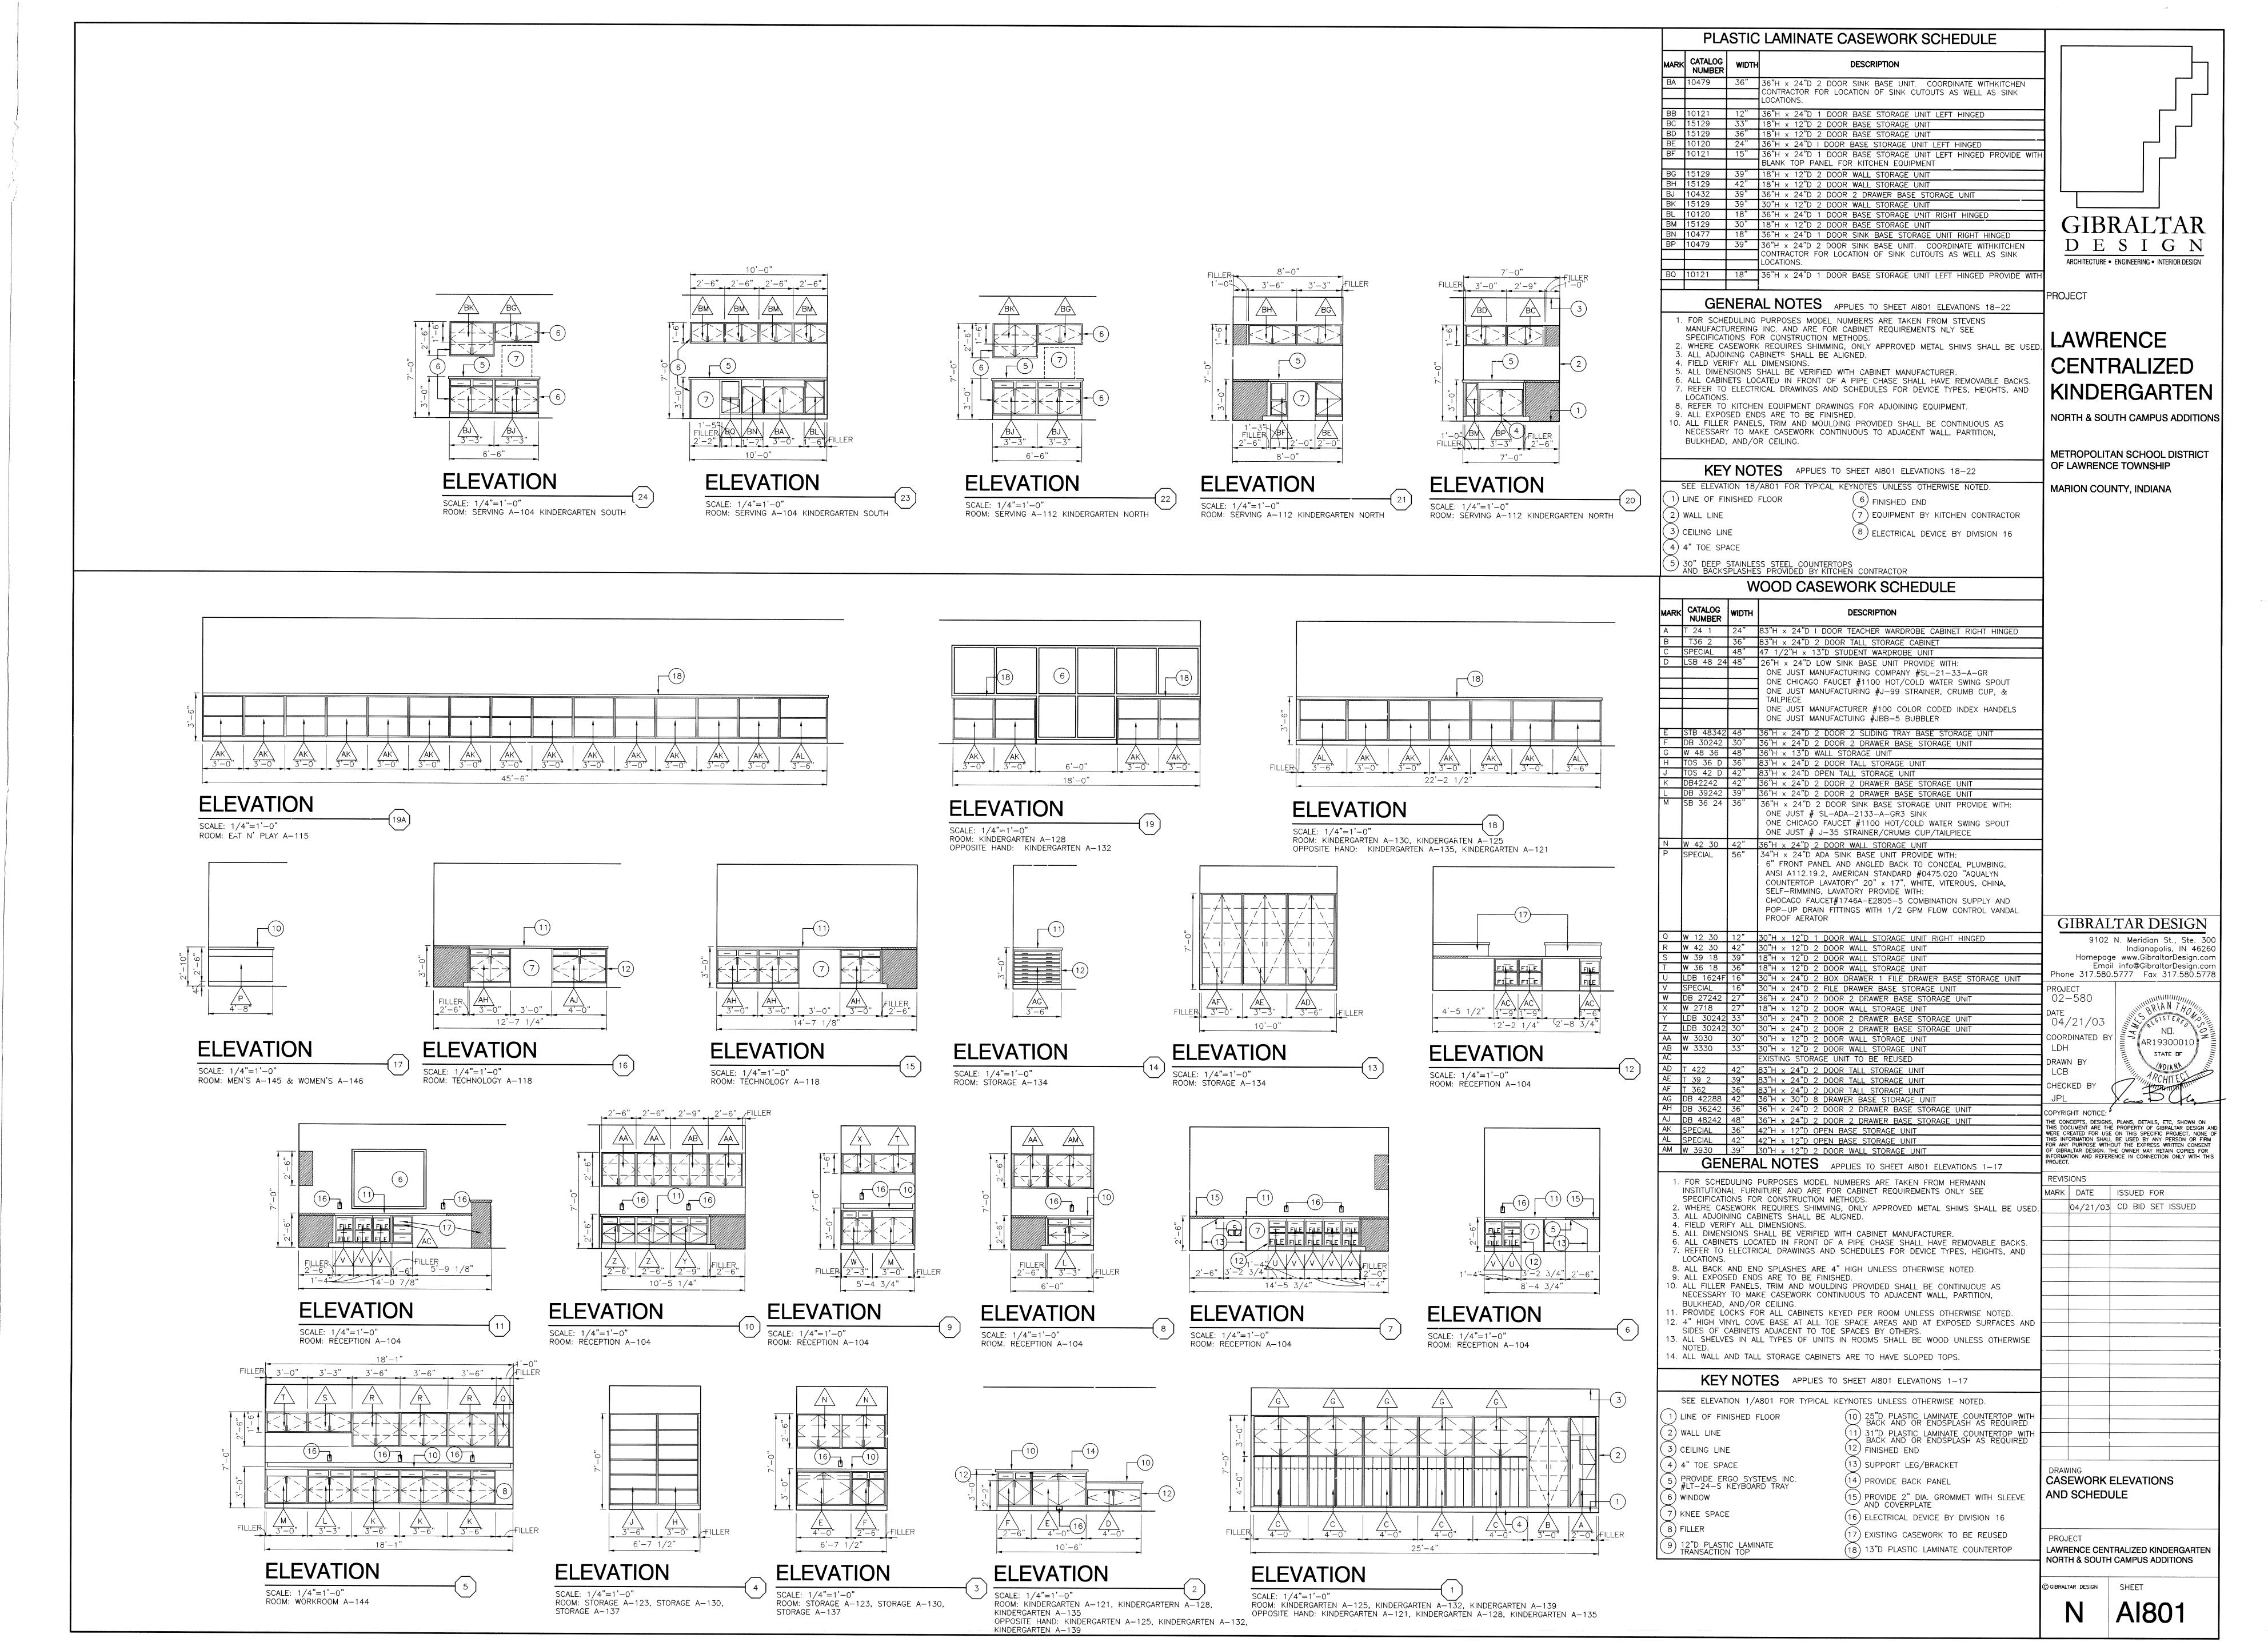

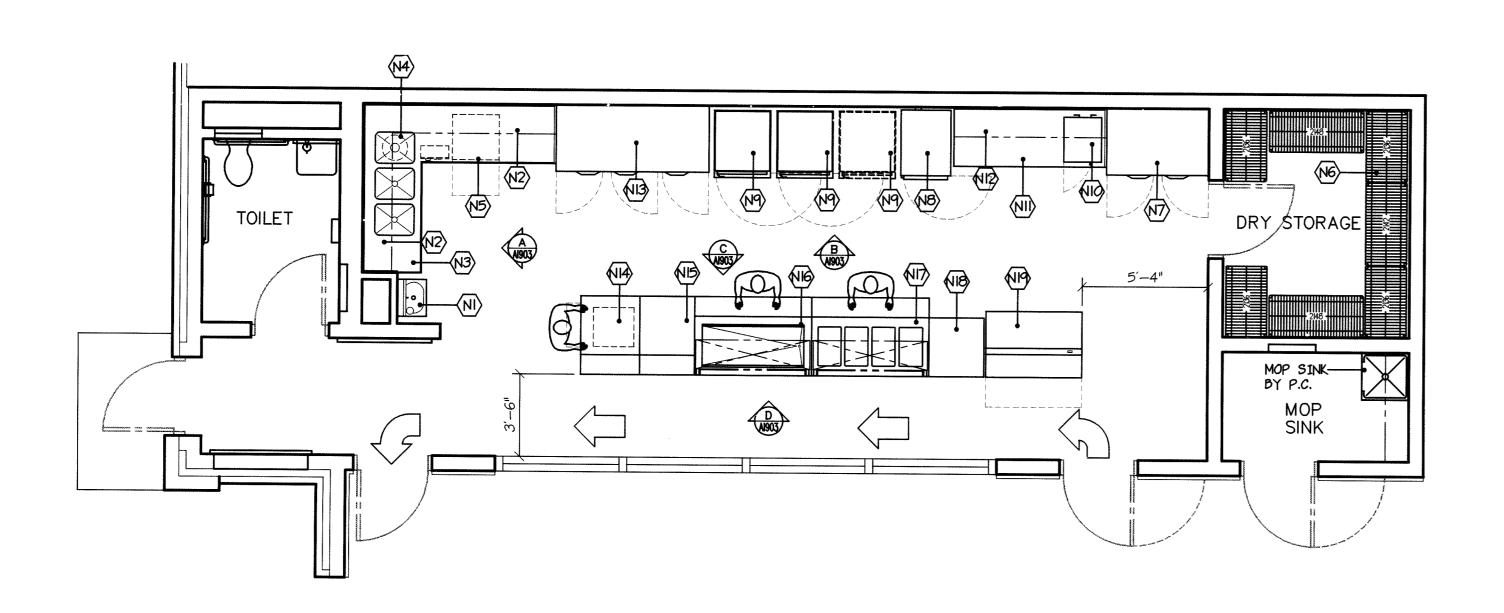

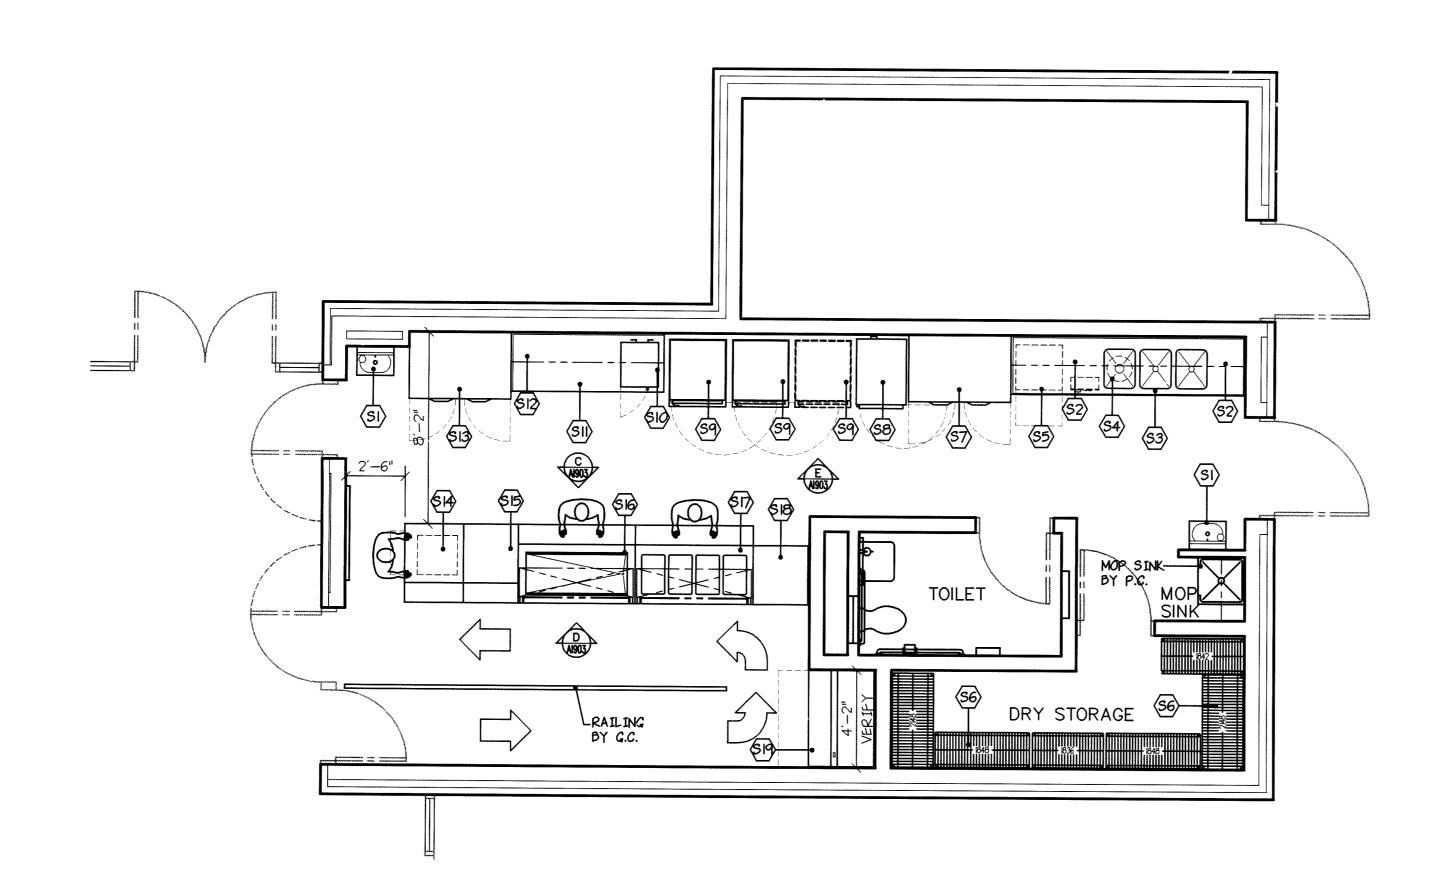


EQUIPMENT LIST NORTH CAMPUS

			ZIOT KOTKIT OATT
	ITEM	QUAN.	DESCRIPTION
	(NI)	I	HAND SINKS (BY P.C.)
	(N2)	2	WALL CABINETS (BY MILLWORK)
	(N3)	1	S/S COUNTER TOP WITH SINKS
	N4	1	DISPOSER
	(N5)	I	UNDERCOUNTER DISHMACHINE
	(N6)	I LOT	SHELVING
	\N7\	1	REFRIGERATOR/FREEZER
	(N8)	I	MOBILE COOK & HOLD OVEN
	(19)	2	MOBILE HEATED CABINETS
	(NIO)	1	CONVECTION MICROWAVE OVEN
	(Nii)	· 1	S/S COUNTER TOP
	(NI2)	1	WALL CABINET (BY MILLWORK)
	(NI3)	1	REFRIGERATOR
	(NI4)	1	CASHIER'S COUNTER
	NIS	1	FLAT TOP COUNTER
	(NI6)	I	COLD FOOD COUNTER
	(NI7)	1	HOT FOOD COUNTER
	(NIB)	I	FLAT TOP COUNTER
	(NIA)	l	MOBILE MILK COOLER
-			

<u> 1PUS</u>

EG	2UIPT	1ENT	LIST SOUTH CAM
	ITEM	QUAN.	DESCRIPTION
	(Si)	2	HAND SINKS (BY P.C.)
	\(\sigma \)	2	WALL CABINETS (BY MILLWORK)
	(53)	1	S/S COUNTER TOP WITH SINKS
	(54)	1	DISPOSER
	(35)	1	UNDERCOUNTER DISHMACHINE
	(56)	I LOT	SHELVING
	(57)	ı	REFRIGERATOR/FREEZER
	(58)	I	MOBILE COOK & HOLD OVEN
	(59)	2	MOBILE HEATED CABINETS
	(\$10)	1	CONVECTION MICROWAVE OVEN
	SII	1	S/S COUNTER TOP
	(\$12)	1	WALL CABINET (BY MILLWORK)
	(SI3)	1	REFRIGERATOR
	(SI4)	1	CASHIER'S COUNTER
	(515)	1	FLAT TOP COUNTER
	(\$16)	1	COLD FOOD COUNTER
	(SI7)	I	HOT FOOD COUNTER
	(SIB)	1	FLAT TOP COUNTER
	(519)	1	MOBILE MILK COOLER

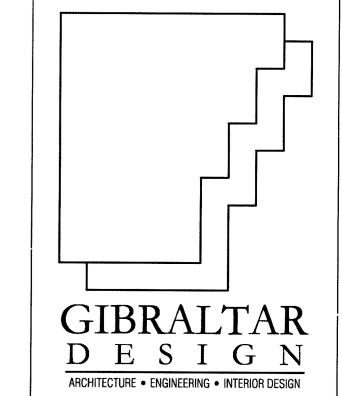

LAWRENCE CENTRALIZED KINDERGARTEN

NORTH & SOUTH CAMPUS ADDITIONS

METROPOLITAN SCHOOL DISTRICT OF LAWRENCE TOWNSHIP MARION COUNTY, INDIANA

Kitchen Equipment Consultants & Designers 6868 W. 96TH STREET
ZIONSVILLE, INDIANA 46077
(317) 873-5909
FAX: (317) 873-5909 www.foodserviceconsultinggroupinc.com

GIBRALTAR DESIGN

9102 N. Meridian St., Ste. 300 Indianapolis, IN 46260 Homepage www.GibraltarDesign.com Email info@GibraltarDesign.com Phone 317.580.5777 Fax 317.580.5778

PROJECT 02-580

DATE 04/21/03 COORDINATED BY DRAWN BY DGW CHECKED BY

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REVISIONS

MARK DATE ISSUED FOR

DRAWING FOODSERVICE EQUIPMENT PLAN

LAWRENCE CENTRALIZED KINDERGARTEN NORTH & SOUTH CAMPUS ADDITIONS

© GIBRALTAR DESIGN SHEET

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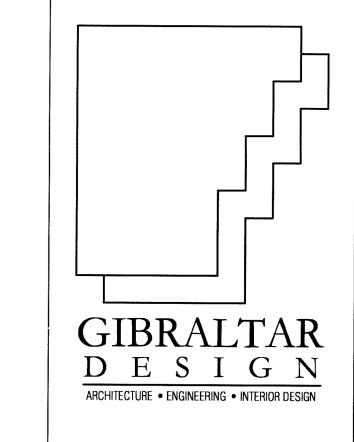
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TEM OLIAN	. DESCRIPTION		MODEL					REMENTS			ROUGH-IN						EQUIREMENTS				VENTILATION (
10. QUAN	. DESCRIPTION	MANUFACTURER	NUMBER	VOLT	PH.	H.P.	AMP.	K.W.	CORD PLUG	DIRECT CONN.	REFERENCE	W.A	TER 140° H V		VASTE T INDIREC	T SIZE	GAS BTU	SLIDDI Y	STEAM	ROUGH-IN REFERENCE		UPPLY	REMARKS	
NI) I	HAND SINKS	N.I.C.	BY P.C.									1/2"	1/2"	I-1/2'		I SIZL	D10	3011 L1	INLIONN	PI & PIA			THE THE IS CHOOLED BY CO. VEGETY OF CHECK THE	
12 2	WALL CABINETS	N.I.C.	BY MILLWORK	-								7 -	 '/-	+ ","						PIAPIA			THIS ITEM IS SUPPLIED BY P.C. VERIFY SERVICE REQUIREMENTS.	
13	S/S TOP WITH SINKS	FABRICATED	CUSTOM									3/4"	3/4"		F.S.					P3 & P3A			NO SERVICE REQUIRED.	
N4 > I	DISPOSER	SAVAJOR	200-SA-6.5-ARSS	208	3	2	6.6			X	E4	1/2"	+ -, -	3"	1.0.					P3 & P3A P4 & P4A		-	STAINLESS STEEL TOP ON MILLWORK BASE.	
N5 I	UNDERCOUNTER DISHMACHINE	CHAMPION	UH-200B	208	3	3/4	40.3			X	E5	-/-	3/4"	+ -	F.S.				-	<u> </u>			F.F.E.C. TO PROVIDE SOLENOID VALVE & VACUUM BREAKER.	
N6 LOT	SHELVING	METRO	SUPER ERECTA										"		1.0.					P5 & P5A				-
N7 I	REFRIGERATOR/FREEZER	CONTINENTAL	DL2RFE-SA-HD	120		/4 & 1/3	6.9/7.6			X	E7 & E7A												NO SERVICE REQUIRED.	
NB) I	MOBILE COOK & HOLD OVEN	CRESCOR	CO-151-F-1818	208	3		17	6.2	X		E8											-	E.C. TO CONNECT EACH SIDE SEPERATELY.	
N9) 2	MOBILE HEATED CABINETS	CRESCOR	H-137-UA-12C	120			12	1.5	X		1	E9				-								
NIO I	CONVECTION MICROWAVE OVEN	AMANA	ACE208	208			16.3	3.4	Y Y		EIO	L-1												
NII) I	S/S COUNTER TOP	FABRICATED	CUSTOM				10.0																	
NI2 I	WALL CABINET	N.I.C.	BY MILLWORK																				STAINLESS STEEL TOP ON MILLWORK BASE.	
NI3 I	REFRIGERATOR	CONTINENTAL	DL3RE-SA-HD	120		1/2	12.4				513												NO SERVICE REQUIRED.	
NHA I	CASHIER'S COUNTER	COLORPOINT	28-CSS	120	'	1/2	16				E13													
NIS) I	FLAT TOP COUNTER	COLORPOINT	K28-ST	120	'		10				F14													
NI6 I	COLD FOOD COUNTER	COLORPOINT	60-CFMA	120		1/4	7										-					·	NO SERVICE REQUIRED.	
NI7 I	HOT FOOD COUNTER	COLORPOINT	5E4-CPA	120/208		'/ '	22				E16				F.D.					P16				
NIB) I	FLAT TOP COUNTER	COLORPOINT	K28-ST	.20,200			22		_ ^		E17			-	F.D.		-			P17				
NI9)	MOBILE MILK COOLER	TRUE	TMC-49-S	120		1/3	8.2		, , , , , , , , , , , , , , , , , , ,		E19												NO SERVICE REQUIRED.	

NOTE: NOT ALL ITEM ACCESSORIES ARE CALLED OUT ON THIS SCHEDULE, REFER TO DRAWINGS AND WRITTEN SPECIFICATIONS.

		FC		F	\triangle			ES) E	= Q	JIF		EN	JT	S	CH	EDU		EF		2 5	50U	\top	CAMPUS	
TEM OLLA	I DESCRIPTION	MANUEACTURER	MODEL			ELECTF	RICAL REQ	UIREMENTS	5		BUICH-IN				М	ECHANICAL	REQUIREMENT:				DOLLOLL IN	VENTILAT	TION CFM		
10. QUA	N. DESCRIPTION	MANUFACTURER	NUMBER	VOLT	PH.	H.P.	AMP.	K.W.	CORD PLUG	DIRECT CONN.	REFERENCE		ATER		WASTE CT INDIRE	CT SIZE	GAS BTU	SLIDE	STEAM PLY RETURN		ROUGH-IN REFERENCE		SUPPLY	REMARKS	'
SI 2 22 2 33 I	HAND SINKS	N.I.C.	BY P.C.									1/2"	1/2"	I-1/:		JI SIZE	1 010	3011	LI INLIONI	I PRESSURE	PI & PIA			THE TITM TO CHOOL TO BY AT IF OF VEGET V OF OUT OF OUTCOME.	
2	WALL CABINETS	N.I.C.	BY MILLWORK										1 -								FIXFIA	, , , , , , , , , , , , , , , , , , , ,		THIS ITEM IS SUPPLIED BY OTHERS VERIFY SERVICE REQUIREMENTS. NO SERVICE REQUIRED.	
<u> </u>	S/S TOP WITH SINKS	FABRICATED	CUSTOM									3/4"	3/4"		F.S.						P3 & P3A			STAINLESS STEEL TOP ON MILLWORK BASE.	
<u>}</u>	DISPOSER	SAVAJOR	200-SA-6.5-ARSS	208	3	2	6.6			Х	E4	1/2"	'	3"							P4 & P4A				
5 1	UNDERCOUNTER DISHMACHINE	CHAMPION	UH-200B	208	3	3/4	40.3			Х	£5	,	3/4"		F.S.						P5 & P5A			F.F.E.C. TO PROVIDE SOLENOID VALVE & VACUUM BREAKER.	
6) I LO	SHELVING	METRO	SUPER ERECTA							-					1.0.						PJ & PJA			NO CEOVITOE OF OUTCED	
57) 1	REFRIGERATOR/FREEZER	CONTINENTAL	DL2RFE-SA-HD	120	ı	1/4 & 1/3	6.9/7.6			X	E7 & E7A													NO SERVICE REQUIRED.	
88	MOBILE COOK & HOLD OVEN	CRESCOR	CO-151-F-1818	208	3		17	6.2	X	,	E8													E.C. TO CONNECT EACH SIDE SEPERATELY.	
39) 2	MOBILE HEATED CABINETS	CRESCOR	H-137-UA-12C	120	ı		12	1.5	X			E9													
10)	CONVECTION MICROWAVE OVEN	AMANA	ACE208	208	ı		16.3	3.4	X		EIO														
1) 1	S/S COUNTER TOP	FABRICATED	CUSTOM																						
312) 1	WALL CABINET	N.I.C.	BY MILLWORK																					STAINLESS STEEL TOP ON MILLWORK BASE.	
1 (21	REFRIGERATOR	CONTINENTAL	DL2RE-SA-HD	120		1/3	9.8			X	EI3									-				NO SERVICE REQUIRED.	
S I4	CASHIER'S COUNTER	COLORPOINT	28-CSS	120		-	16		X	,.	E14														
S15 I	FLAT TOP COUNTER	COLORPOINT	K28-ST						,																
S16 I	COLD FOOD COUNTER	COLORPOINT	60-CFMA	120		1/4	7		X		E16				F.D.					.	016			NO SERVICE REQUIRED.	
S17) I	HOT FOOD COUNTER	COLORPOINT	5E4-CPA	120/208		,	22		X		E17				F.D.						P16				
S18 I	FLAT TOP COUNTER	COLORPOINT	K28-ST						'		-1/				Γ.ν.						P17				
S19 1	MOBILE MILK COOLER	TRUE	TMC-49-S	120	+ -	1/3	8.2		Y		E19													NO SERVICE REQUIRED.	

NOTE: NOT ALL ITEM ACCESSORIES ARE CALLED OUT ON THIS SCHEDULE, REFER TO DRAWINGS AND WRITTEN SPECIFICATIONS.

ABBREVIATIONS									
F.D.	FLOOR DRAIN								
F.F.D.	FUNNEL FLOOR DRAIN								
F.S.	12" X 12" X 8" DEEP FLOOR SINK								
F.F.E.C.	FOOD FACILITY EQUIPMENT CONTRACTOR								
G.C.	GENERAL CONTRACTOR								
E.C.	ELECTRICAL CONTRATOR								
P.C.	PLUMBING CONTRACTOR								
M.C.	MECHANICAL CONTRACTOR								



LAWRENCE CENTRALIZED KINDERGARTEN

NORTH & SOUTH CAMPUS ADDITIONS

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Kitchen Equipment Consultants & Designers
6868 W. 96TH STREET
ZIONSVILLE, INDIANA 46077
(317) 873-5909
FAX: (317) 873-5909

www.foodserviceconsultinggroupinc.com

GIBRALTAR DESIGN 9102 N. Meridian St., Ste. 300 Indianapolis, 1N 46260
Indianapolis, IN 46260
Homepage www.GibraltarDesign.com
Email info@GibraltarDesign.com
Phone 317.580.5777 Fax 317.580.5778 02-580 04/21/03 COORDINATED BY ACM DRAWN BY DGW CHECKED BY

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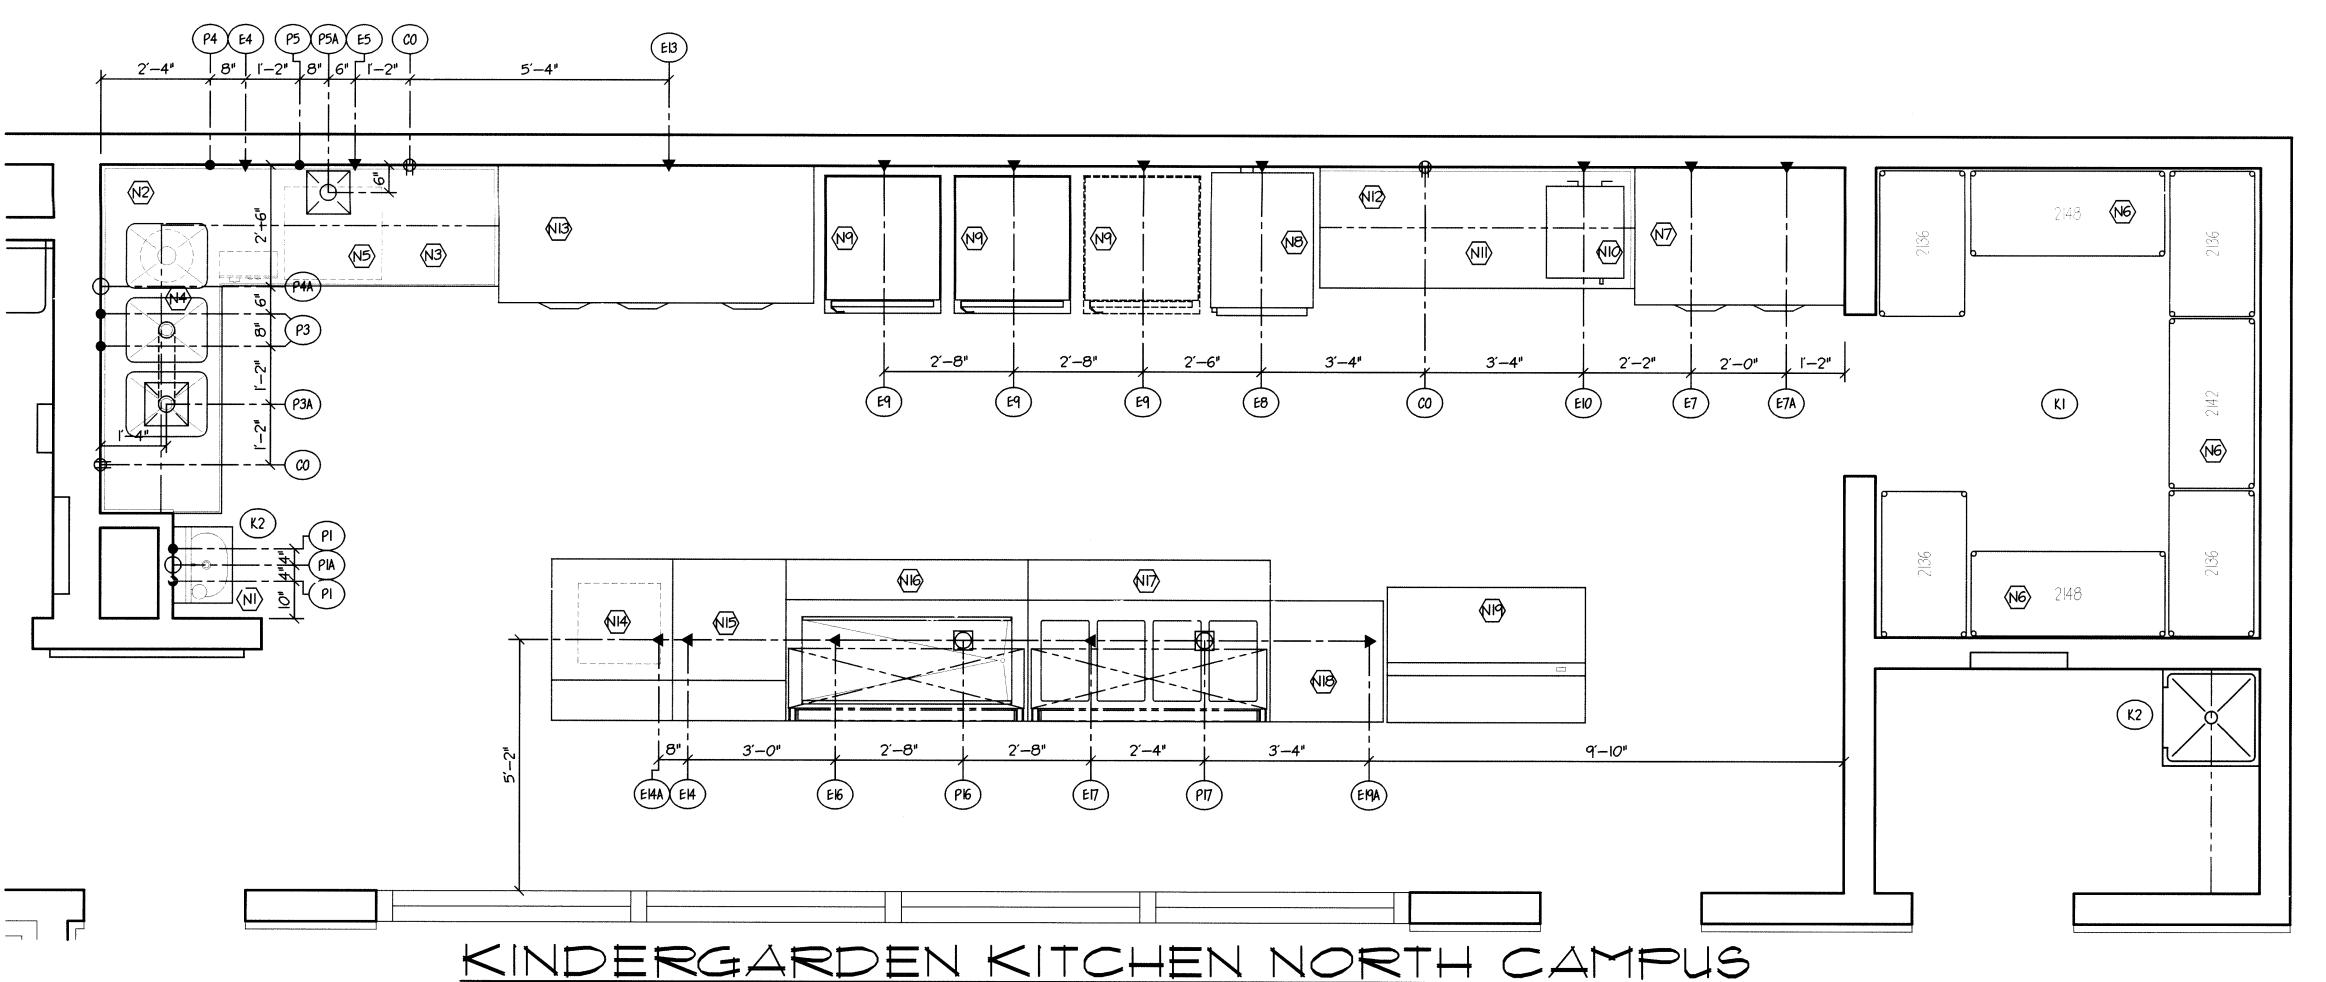
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DRAWING FOODSERVICE EQUIPMENT SCHEDULE

PROJECT LAWRENCE CENTRALIZED KINDERGARTEN NORTH & SOUTH CAMPUS ADDITIONS

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AI901



EQUIPMENT LIST NORTH CAMPUS

DESCRIPTION HAND SINKS (BY P.C.) WALL CABINETS (BY MILLWORK) S/S COUNTER TOP WITH SINKS UNDERCOUNTER DISHMACHINE SHELVING REFRIGERATOR/FREEZER MOBILE COOK & HOLD OVEN MOBILE HEATED CABINETS CONVECTION MICROWAVE OVEN S/S COUNTER TOP WALL CABINET (BY MILLWORK) REFRIGERATOR CASHIER'S COUNTER FLAT TOP COUNTER COLD FOOD COUNTER HOT FOOD COUNTER FLAT TOP COUNTER MOBILE MILK COOLER

SCALE: 1/2" = 1-0"

SPOT LOCATION NOTES

- KI H.V.A.C. TO HEAT, COOL AND/OR VENTILATE THE DRY STORAGE ROOM TO MAINTAIN A TEMPERATURE OF 68 DEG. TO 72 DEG.
- K2 THIS ITEM IS NOT PART OF THE F.F.E.C. CONTRACT AND IS TO BE SUPPLIED AND INSTALLED BY OTHERS. ELECTRICAL ROUGH—IN NOTES:
- CO 120V-IPH 16.0 AMP DUPLEX RECP. @ (+48" A.F.F.) "CONVENIENCE OUTLET".
- E4 208V-3PH 2 H.P. 6.6 AMP SERVICE @ (+24" A.F.F.). E.C TO EXTEND TO DISPOSER (ITEM #4)THRU CONTROL. E.C. TO EXTEND POWER TO F.F.E.C. FURNISHED SOLENOID VALVE. (SEE GENERAL NOTES 11,12,13 & 14).
- E5 208V-3PH 3/4 H.P. 4C.3 AMP SERVICE @ (+8" A.F.F.) E.C. TO EXTEND TO UNDERCOUNTER DISHMACHINE (ITEM #5). (SEE GENERAL NOTES 11,12,13 & 14).
- 120V-1PH 1/4 H.P. 6.9 AMP SERVICE @ (+90" A.F.F.) E.C. TO EXTEND TO REFRIGERATOR CONNECTION ON REFRIGERATOR/ FREEZER (ITEM #7). (SEE GENERAL NOTES 11,12,13 & 14).
- E7A 120V-1PH 1/3 H.P. 7.6 AMP SERVICE @ (+90" A.F.F.) E.C. TO EXTEND TO FREEZER CONNECTION ON REFRIGERATOR/
- FREEZER (ITEM #7). (SEE GENERAL NOTES 11,12,13 & 14).
- E8 208V-3PH 6.2 KW 17 AMP RECP. @ (+36" A.F.F.) FOR MOBILE COOK & HOLD OVEN (ITEM #8).
- E9 120V-IPH 1.5 KW 12 AMP RECP. @ (+36" A.F.F.) FOR MOBILE HEATED CABINET (ITEM #9). EIO 208V-IPH 3.4 KW 16.3 AMP RECP. @ (+48" A.F.F.) FOR MICROWAVE OVEN (ITEM #10).

EHA EH

- E13 120V-IPH 1/2 H.P. 12.4 AMP SERVICE @ (+90" A.F.F.) E.C. TO EXTEND TO REFRIGERATOR (ITEM #13). (SEE GENERAL
- EI3A 120V-1PH 1/3 H.P. 9.8 AMP SERVICE @ (+90" A.F.F.) E.C. TO EXTEND TO REFRIGERATOR (ITEM #13). (SEE GENERAL
- E14 (STUB-UP) 120V-IPH 16 AMP "DEDICATED CIRCUIT" PEDESTAL MOUNTED RECP. FOR CASH HANDLING SYSTEM (ITEM #14). THIS ITEM IS TO BE SUPPLIED AND INSTALLED BY VENDOR. F.F.E.C. AND E.C. TO FIELD VERIFY SERVICE REQUIREMENTS WITH SUPPLIER PROIR TO INSTALLATION.

- E14A (STUB-UP) 1/2" CONDUIT. E.C. TO PROVIDE AND INSTALL 1/2" CONDUIT FROM THIS POINT TO KITCHEN OFFICE FOR COMPUTER COMMUNICATION WIRING. E.C. TO FIELD VERIFY DESIRED LOCATION IN OFFICE WITH OWNER.
- E16 (STUB-UP) 120V-1PH 1/4 H.P. 7 AMP PEDESTAL MOUNTED RECP. FOR MOBILE COLD FOOD COUNTER (ITEM #16).
- EI7 (STUB-UP) 120/208V-IPH 22 AMP PEDESTAL MOUNTED RECP. FOR MOBILE HOT FOOD COUNTER (ITEM #17)
- E19 120V-1PH 1/3 H.P. 8.2 AMP RECP. @ (+16" A.F.F.) FOR MOBILE MILK COOLER (ITEM #19). EI9A (STUB-UP) 120V-1PH 1/3 H.P. 8.2 AMP PEDESTAL MOUNTED RECP. FOR MOBILE MILK COOLER (ITEM #19).
- PLUMBING ROUGH—IN NOTES: PI 1/2" HOT AND COLD WATER @ (+18" A.F.F.) P.C. TO EXTEND FOR FAUCET MOUNTED ON HAND SINK (ITEM #1). THIS ITEM
- PIA I-1/2" WASTE @ (+15" A.F.F.) P.C. TO EXTEND DRAIN LINE FROM HAND SINK (ITEM #1) TO THIS POINT.
- P3 3/4" HOT AND COLD WATER @ (+18" A.F.F.) P.C. TO EXTEND TO FAUCET MOUNTED ON WORKTABLE (ITEM #3).

IS NOT PART OF THE F.F.E.C. CONTRACT AND IS TO BE SUPPLIED AND INSTALLED BY OTHERS.

- P3A 12"X 12"X 8" DEEP FLOOR SINK WITH HALF GRATE P.C. EXTEND DRAIN FROM WORKTABLE SINK (ITEM #3) TO THIS POINT.
- P4 1/2" COLD WATER @ (+24" A.F.F.) P.C. TO EXTEND TO DISPOSER (ITEM #4) THRU F.F.E.C. FURNISHED SOLENOID VALVE

- P4A 3" WASTE @ (+15" A.F.F.). P.C. TO EXTEND DRAIN FROM DISPOSER (ITEM #4) TO THIS POINT.
- P5 3/4" HOT WATER @ (+10" A.F.F.) P.C. TO EXTEND TO UNDERCOUNTER DISHMACHINE (ITEM #5).
- P5A 12"X 12"X 8" DEEP FLOOR SINK WITH HALF GRATE. P.C. TO EXTEND DRAIN LINE FROM UNDERCOUNTER DISHMACHINE (ITEM #5) TO THIS POINT.
- PIG FLOOR DRAIN. P.C. TO EXTEND DRAIN LINE FROM MOBILE COLD FOOD COUNTER (ITEM #16) TO THIS POINT. PI7 FLOOR DRAIN. P.C. TO EXTEND DRAIN LINE FROM MOBILE COLD FOOD COUNTER (ITEM #17) TO THIS POINT.

(P5) P5A) E5) CO) E4 (P4A) P4

FLOOR SINK

SYMBOL LEGEND

CONVENIENCE DUPLEX OUTLET

▲ ELECTRICAL SERVICE

WATER SERVICE

DIRECT WASTE

FLOOR DRAIN

<u>ABBREVIATIONS</u>

ABOVE FINISHED FLOOR

D.F.A. DROP FROM ABOVE AMPERAGE KILOWATT:

H.P.

FOOD SERVICE EQUIPMENT CONTRACTOR

GENERAL CONTRACTOR

E.C. ELECTRICAL CONTRATOR P.C. PLUMBING CONTRACTOR

HOT WATER

GENERAL NOTES

- ALL ELECTRICAL RECEPTACLES & JUNCTION BOXES SHOWN ARE RATED IN ACCORDANCE WITH EQUIPMENT MANUFACTURER'S SPECIFICATIONS.
- 2 ELECTRICAL SHOWN IS FOR FOOD SERVICE EQUIPMENT ONLY. ELECTRICAL SERVICE REQUIRED FOR ROOM LIGHTING, CONVENIENCE OUTLETS, & ETC. TO BE ADDITIONAL.
- 3 P.C. TO INSTALL FAUCETS, VACUUM BREAKERS, SOLENOID VALVES, SPRAY RINSES & DISPOSERS
- 4 P.C. TO FURNISH & INSTALL ALL TAILPIECES, TRAPS, SHUT-OFFS, LOOP VENTS, FLOOR DRAINS & FLOOR SINKS AS REQUIRED.
- 5 ALL HOT WATER IS 120 DEGREE UNLESS OTHERWISE NOTED.
- 6 FLOOR DRAINS SHOWN ARE FOR FOOD SERVICE EQUIPMENT ONLY. FLOOR DRAINS REQUIRED FOR GENERAL CLEANING & CODE REQUIREMENTS TO BE ADDITIONAL.
- THIS DRAWING IS TO BE USED AS A GUIDE FOR FOOD SERVICE EQUIPMENT ELECTRICAL, PLUMBING & VENTILATION ROUGH—IN LOCATION. EACH CONTRACTOR SHALL BE RESPONSIBLE FOR HIS/HER WORK TO BE INSTALLED IN ACCORDANCE WITH ALL FEDERAL, STATE & LOCAL CODES.
- 8 ALL DIMENSIONS ARE FROM FINISHED SUPFACES TO CENTER LINE OF SPOT LOCATION UNLESS
- ALL FOOD SERVICE EQUIPMENT SHALL BE FABRICATED & INSTALLED IN STRICT ACCORDANCE WITH THE NATIONAL SANITATION FOUNDATION (N.S.F.) & IN COMPLIANCE WITH STATE & LOCAL CODES.
- 10 ALL WALL RECEPTACLES TO BE FLUSH MOUNTED UNLESS OTHERWISE NOTED.
- OF KITCHEN ELECTRICAL DISTRIBUTION PANEL OR HAVE A FUSED QUICK DISCONNECT FURNISHED & INSTALLED BY E.C. E.C. TO FIELD VERIFY WHERE REQUIRED.

II ALL FOOD SERVICE EQUIPMENT WITH DIRECT ELECTRICAL CONNECTION MUST BE IN LINE SIGHT


- 2 ALL ROUGH-INS ARE SHOWN WHERE THEY ARE TO BE LOCATED ON EACH SIDE OF WALL. PRIMARY PLUMBING & ELECTRICAL SERVICE SHOULD BE ROUGHED IN ON CENTER LINE OF WALL.
- 13 E.C. TO PROVIDE GROUNDING WIRE TO ALL FOOD SERVICE EQUIPMENT IN ADDITION TO THE NUMBER OF WIRES NOTED IN INDIVIDUAL SERVICES.
- 14 ALL ELECTRICAL AMPERAGE NOTED INDICATES AMP "DRAW" & "NOT" CIRCUIT BREAKER SIZE
- UNLESS OTHERWISE NOTED. E.C. TO BE RESPONSIBLE FOR PROPER CIRCUIT BREAKER SIZING. 15 E.C. TO FURNISH & INSTALL GROUND FAULT RECEPTACLE OR FURNISH GROUND FAULT CIRCUIT
- BREAKER FOR ANY RECEPTACLE WITHIN 5'-0" OF SINK. 16 FLOORS IN KITCHEN & SERVING AREAS TO BE "TRANSIT LEVEL". DO NOT SLOPE FLOOR TO
- 17 H.V.A.C. TO COOL, HEAT &/OR VENTILATE FOOD SERVICE DRY STORAGE ROOM TO MAINTAIN A
- TEMPERATURE OF 68 DEGREES TO 72 DEGREES YEAR AROUND. 23 P.C. TO PROVIDE & INSTALL ALL 12" 12" 8" FLOOR SINKS WITH HALF GRATE. ALL FLOOR SINKS TO BE MOUNTED IN FLOOR SUCH THAT THE TOP OF THE RIM WILL BE FLUSH WITH
- 24 ALL WATER LINES MOUNTED ALONG EXTERIOR WALLS ARE TO STUBBED-UP ALONG THE INTERIOR FACE OF THE WALL TO AVOID POTENTIAL FREEZING UNLESS OTHERWISE NOTED.

FINISHED FLOOR ELEVATION. FLOOR SINKS ALSO TO SERVE AS AREA FLOOR DRAINS.

EQUIPMENT LIST SOUTH CAMPUS

FLOOR DRAINS IN THESE AREASIII

DESCRIPTION HAND SINKS (BY P.C.) WALL CABINETS (BY MILLWORK) 3/S COUNTER TOP WITH SINKS DISPOSER UNDERCOUNTER DISHMACHINE I LOT SHELVING REFRIGERATOR/FREEZER MOBILE COOK & HOLD OVEN MOBILE HEATED CABINETS CONVECTION MICROWAVE OVEN S/S COUNTER TOP WALL CABINET (BY MILLWORK) REFRIGERATOR CASHIER'S COUNTER FLAT TOP COUNTER COLD FOOD COUNTER HOT FOOD COUNTER FLAT TOP COUNTER MOBILE MILK COOLER

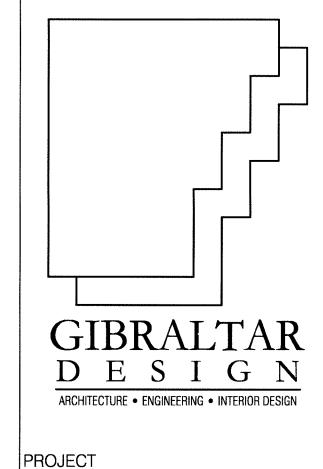


LAWRENCE **CENTRALIZED** KINDERGARTEN

NORTH & SOUTH CAMPUS ADDITIONS

METROPOLITAN SCHOOL DISTRICT OF LAWRENCE TOWNSHIP

MARION COUNTY, INDIANA

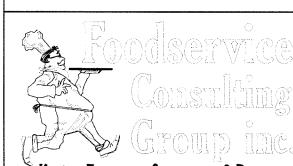

Kitchen Equipment Consultants & Designers 6868 W. 96TH STREET ZIONSVILLE, INDIANA 46077 (317) 873-5909 FAX: (317) 873–5909

www.foodserviceconsultinggroupinc.com

GIBRALTAR DESIGN

9102 N. Meridian St., Ste. 300 Indianapolis, IN 46260 Homepage www.GibraltarDesign.com Email info@GibraltarDesign.com Phone 317.580.5777 Fax 317.580.5778

02-580 04/21/03 COORDINATED BY

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FOODSERVICE **EQUIPMENT** SPOT LOCATION

PROJECT LAWRENCE CENTRALIZED KINDERGARTEN NORTH & SOUTH CAMPUS ADDITIONS

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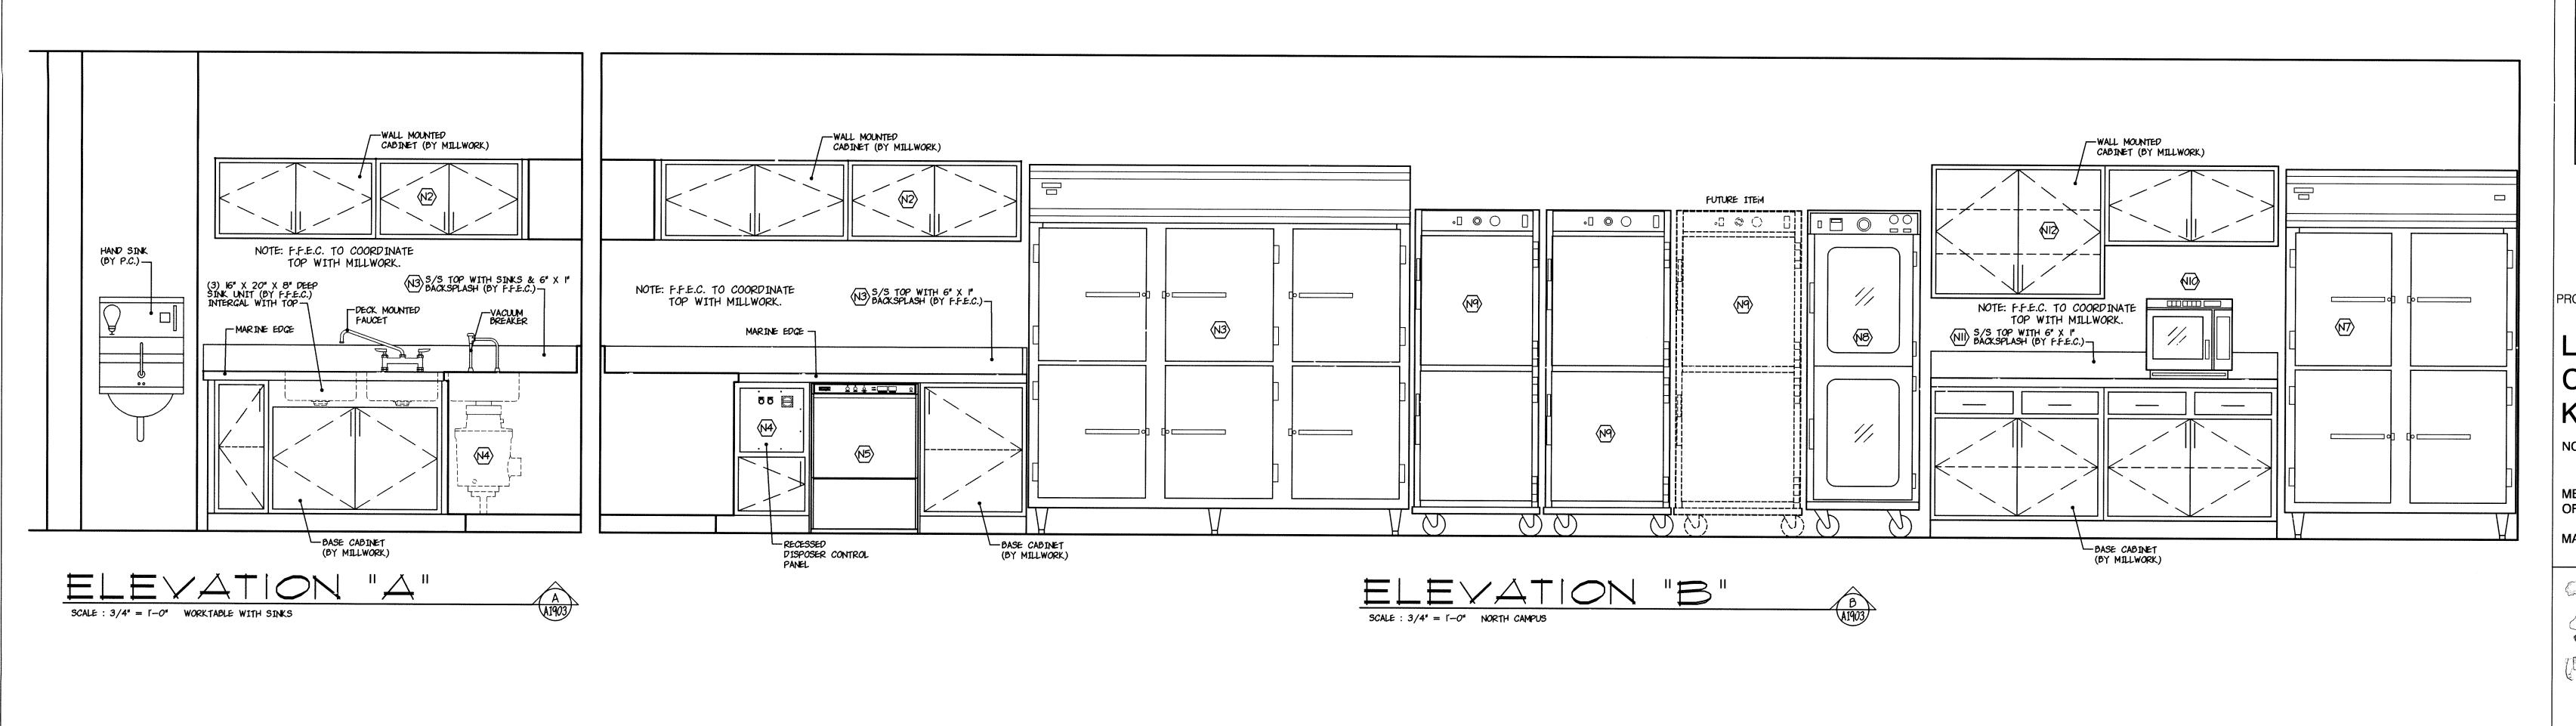
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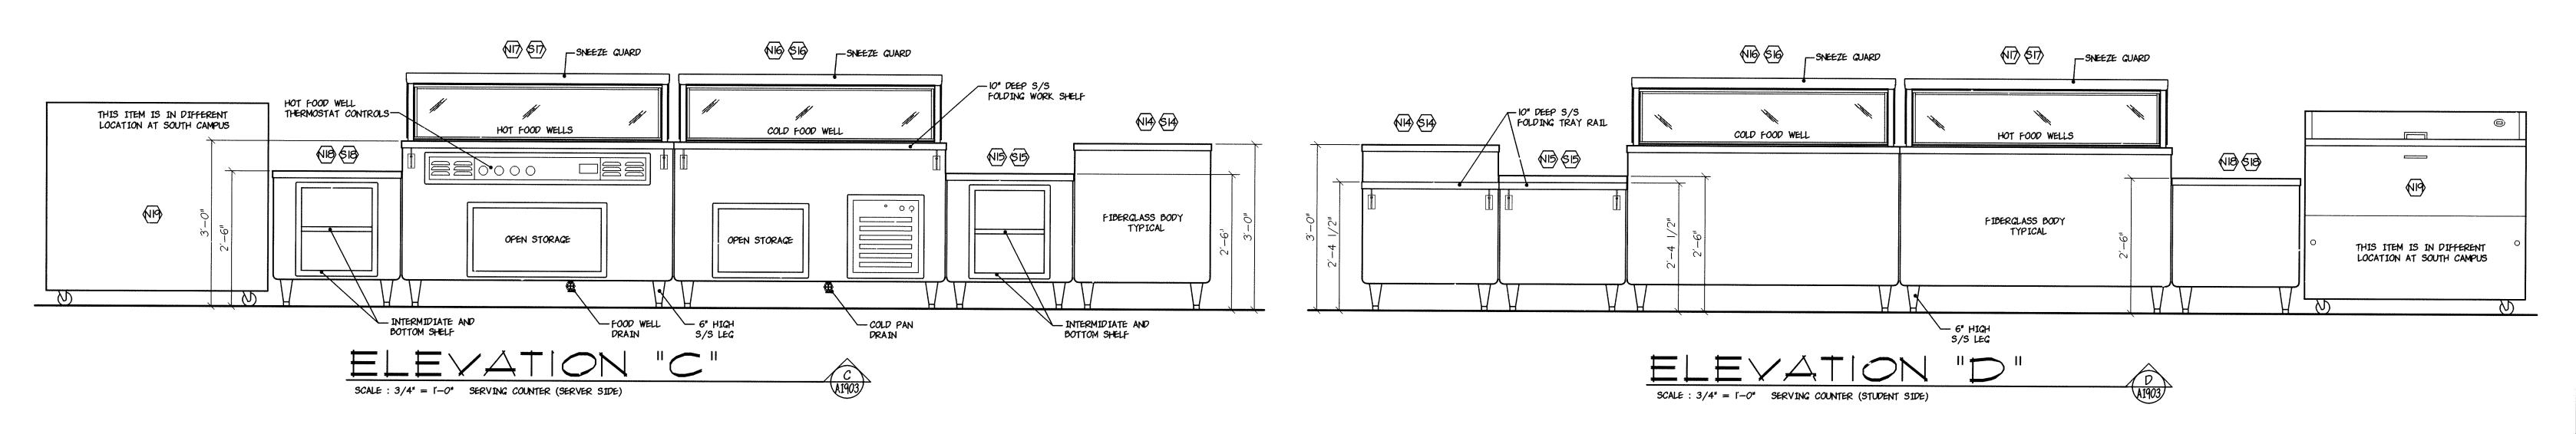
KINDERGARDEN KITCHEN SOUTH CAMPUS


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MARION COUNTY, INDIANA

Kitchen Equipment Consultants & Designers

6868 W. 96TH STREET ZIONSVILLE, INDIANA 46077 (317) 873–5909 FAX: (317) 873-5909

www.foodserviceconsultinggroupinc.com

GIBRALTAR DESIGN 9102 N. Meridian St., Ste. 300

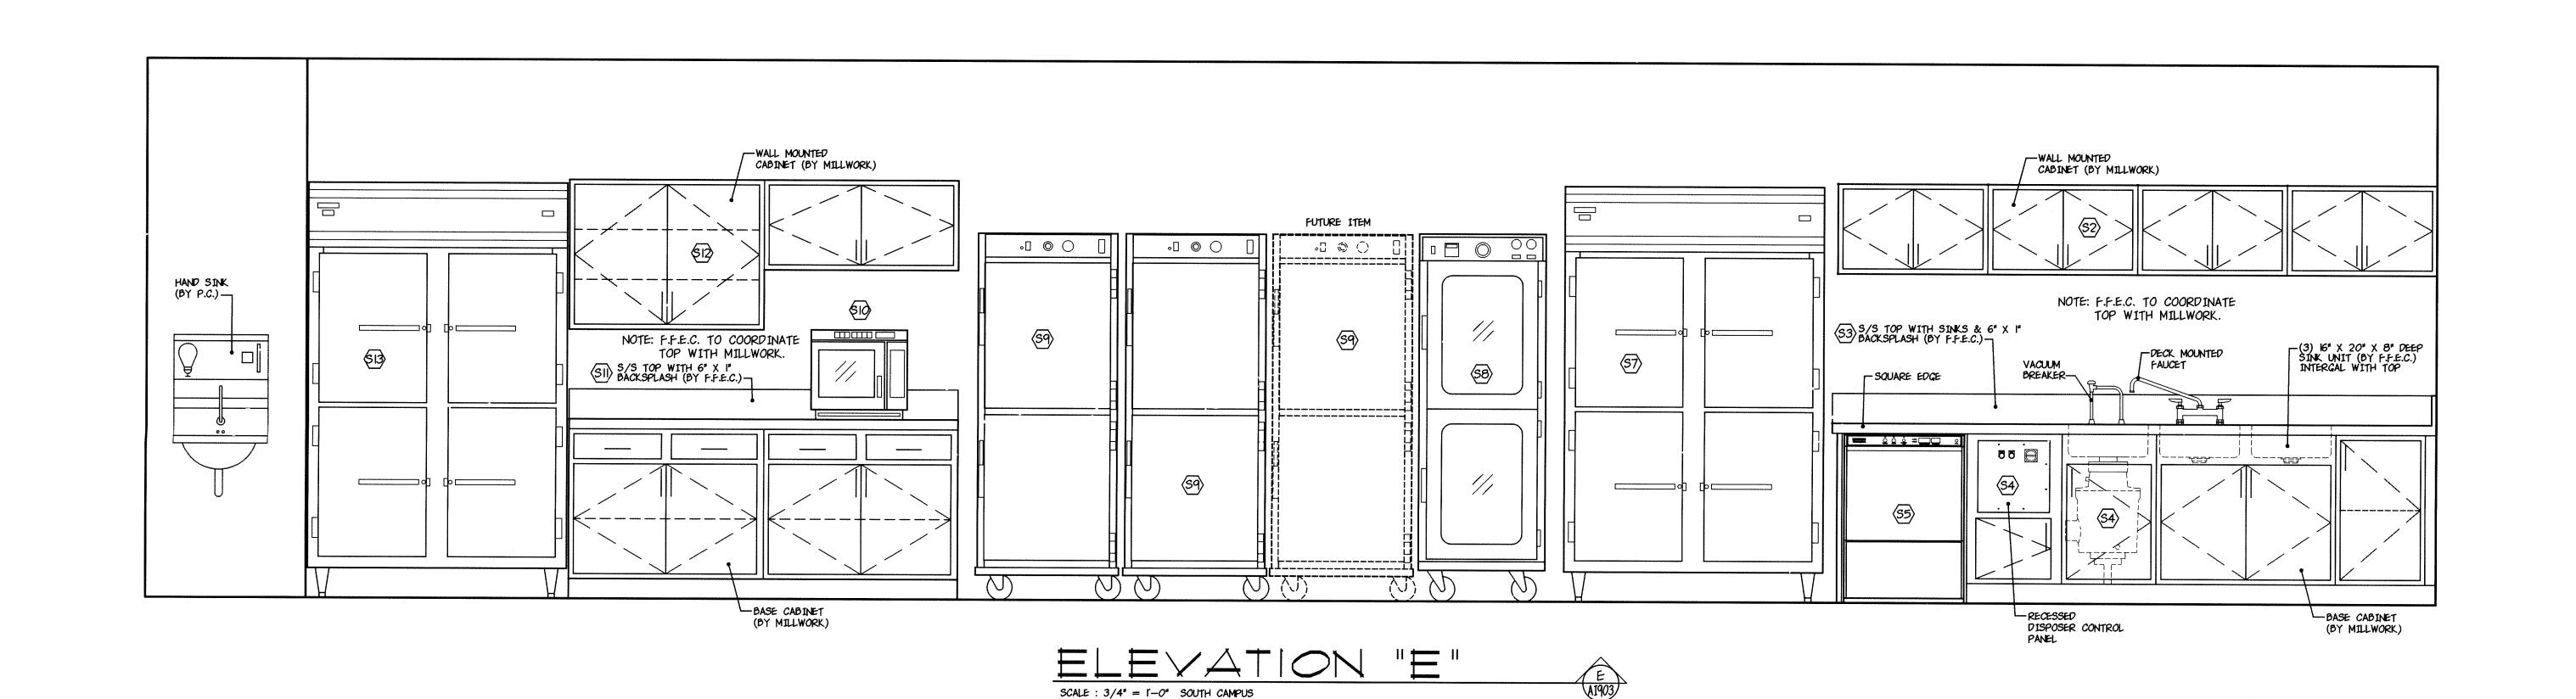Indianapolis, IN 46260 Homepage www.GibraltarDesign.com Email info@GibraltarDesign.com Phone 317.580.5777 Fax 317.580.5778 PROJECT 02-580

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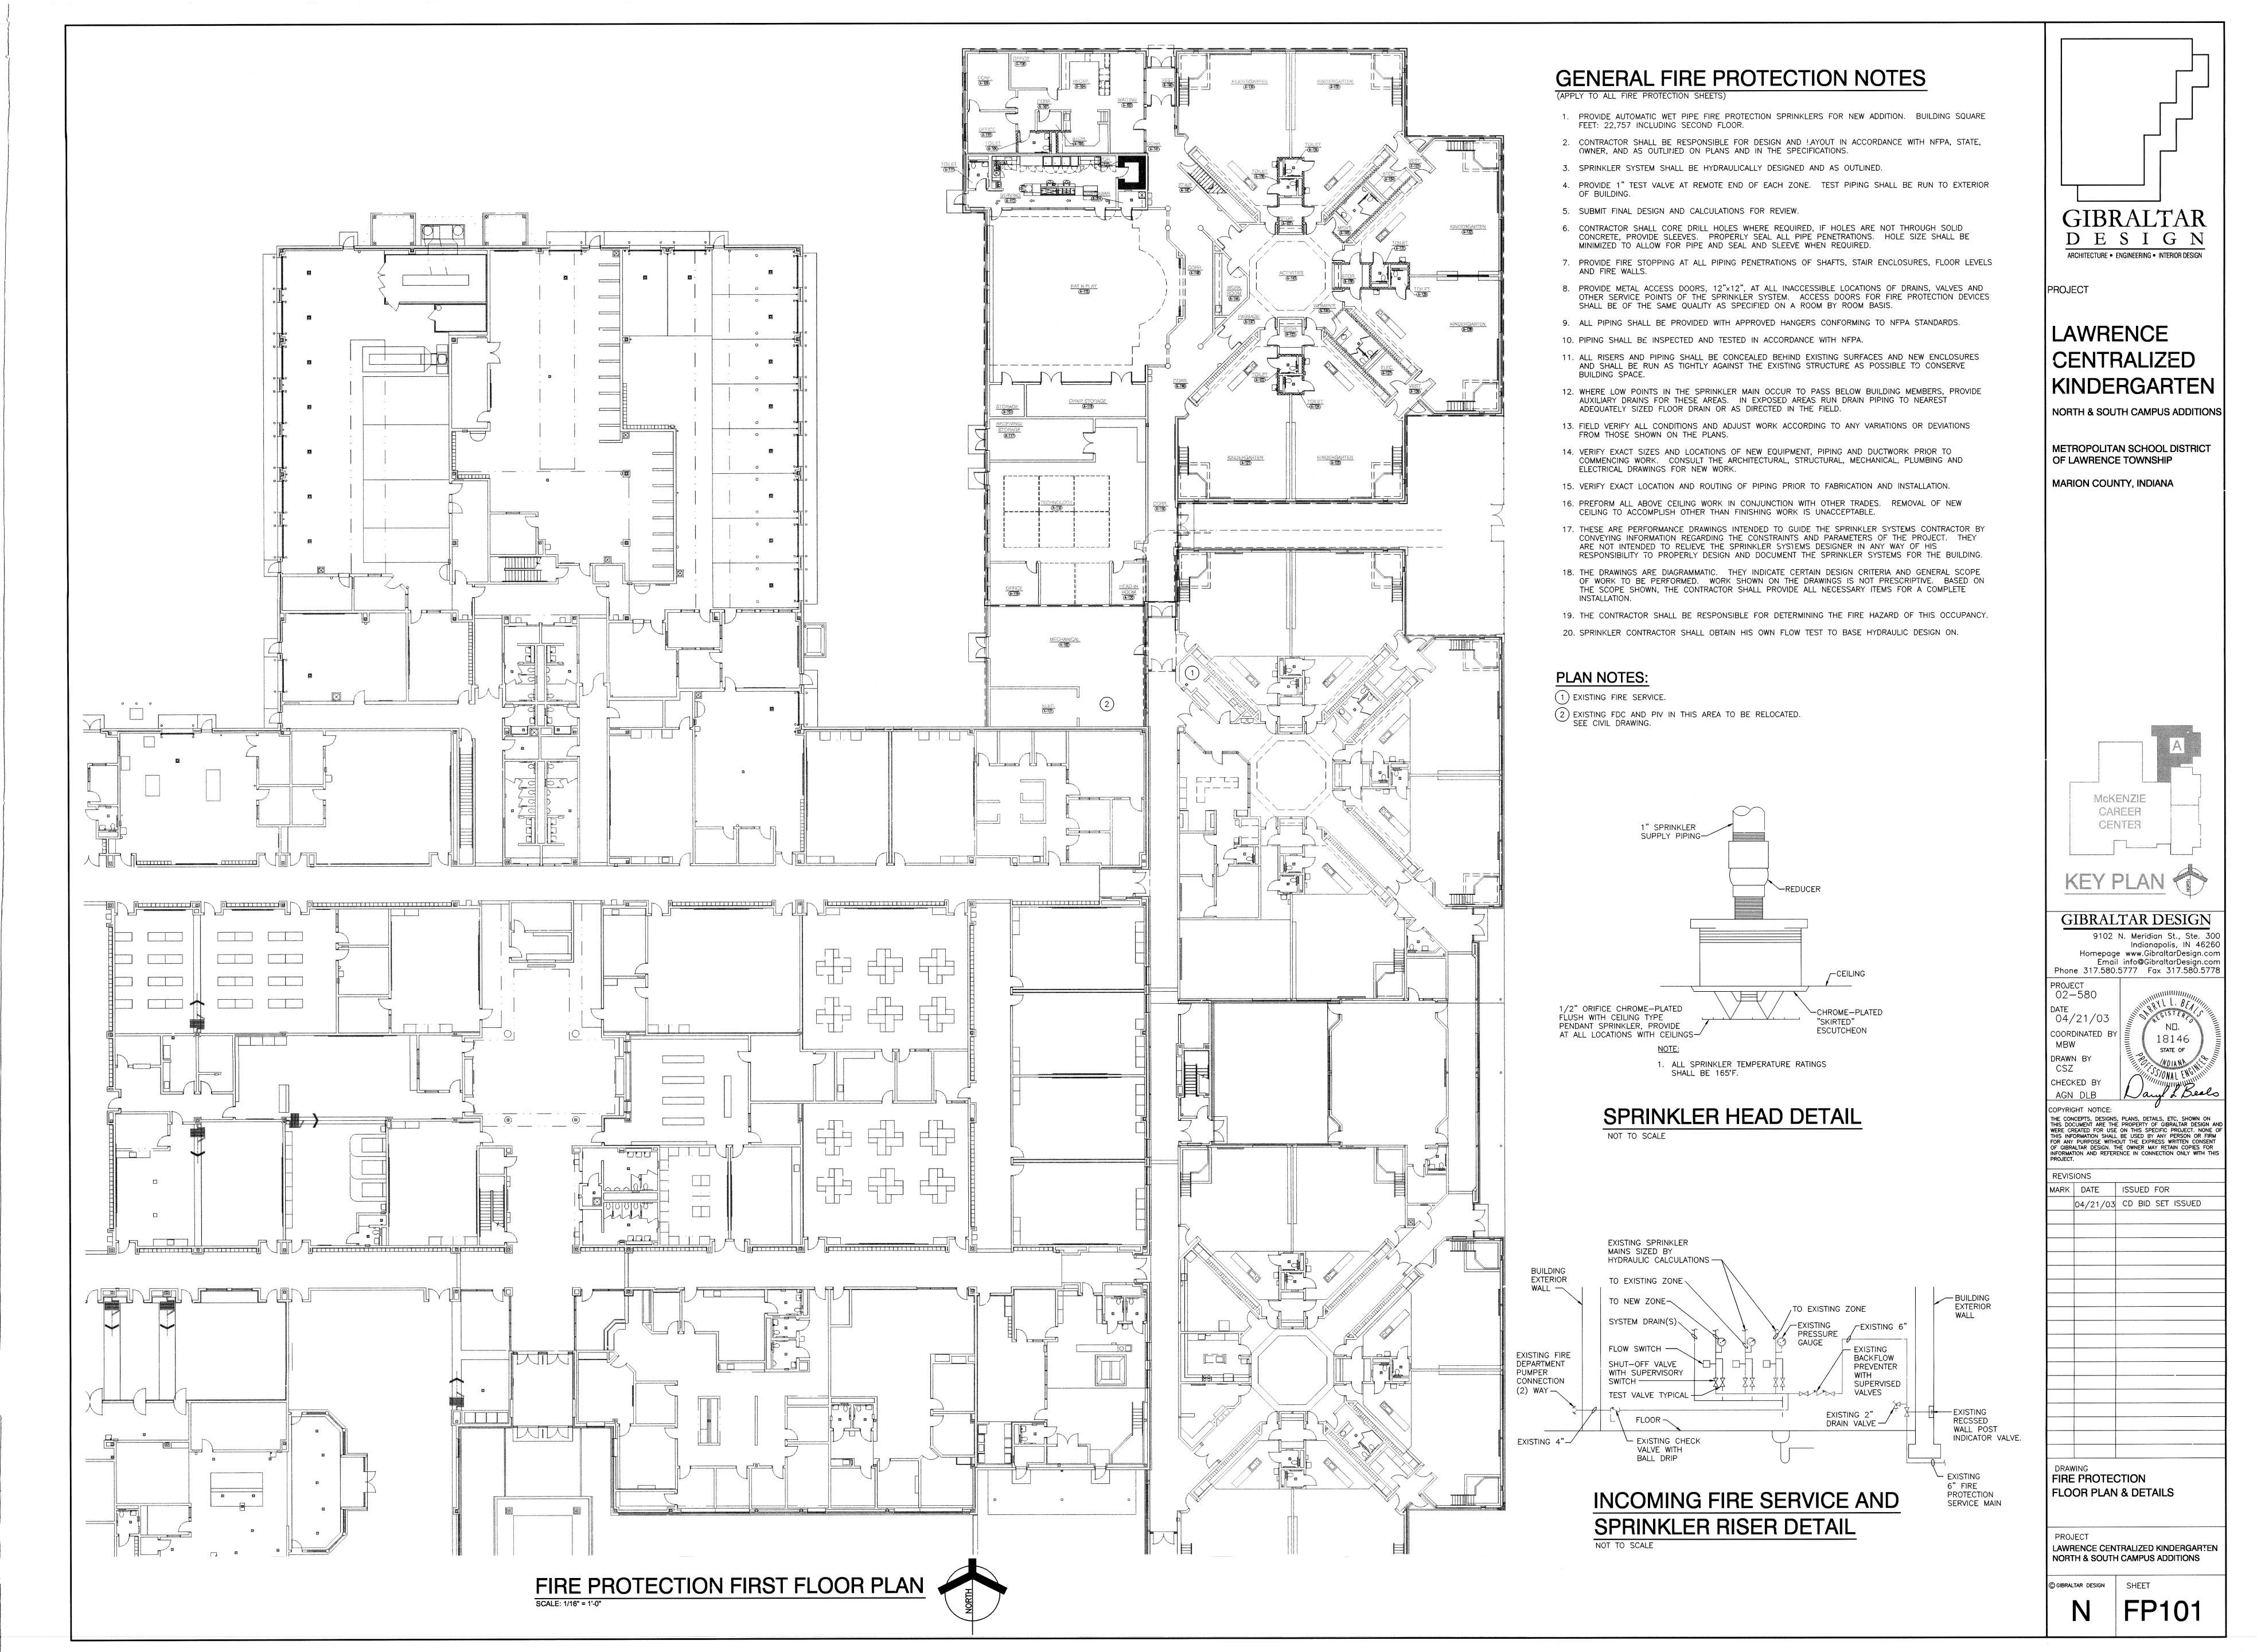
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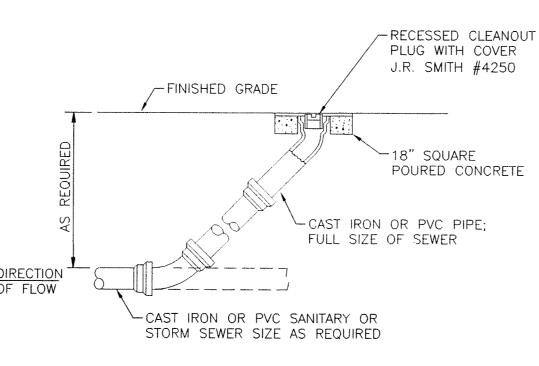
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CONDENSATE DRAIN COLD WATER SOFT COLD WATER 120' HOT WATER 150' HOT WATER 150' HOT WATER TEMPERED WATER HOT WATER RETURN GAS PIPING COMPRESSED AIR VACUUM ACID RESISTANT VENT ACID RESISTANT WASTE FUEL OIL SUPPLY FUEL OIL RETURN FUEL OIL FANK VENT FUEL OIL GAUGE STORM DRAIN OR SEWER PLUMBING VENTS FLOW IN DIRECTION OF ARROW PITCH DOWN IN DIRECTION OF ARROW SHUT—OFF VALVE TEMPERATURE REGULATING VALVE BALANCING VALVE PRESSURE RELIEF VALVE PRESSURE REGULATING VALVE UNION PIPE ANCHOR PIPING DROP WITH RESPECT TO FLOW PIPE TEE OUT OF TOP PIPE TEE OUT OF BOTTOM	SYMBOL	ABBREVIATION D CW SCW HW 150'HW TW HWR G CA VA ARV ARW FOS FOR FOV FOG S W
SOFT COLD WATER 120' HOT WATER 150' HOT WATER TEMPERED WATER HOT WATER RETURN GAS PIPING COMPRESSED AIR VACUUM ACID RESISTANT VENT ACID RESISTANT WASTE FUEL OIL SUPPLY FUEL OIL RETURN FUEL OIL TANK VENT FUEL OIL GAUGE STORM DRAIN OR SEWER SANITARY WASTE OR SEWER PLUMBING VENTS FLOW IN DIRECTION OF ARROW PITCH DOWN IN DIRECTION OF ARROW PITCH DUTY VALVE CHECK VALVE TEMPERATURE REGULATING VALVE BALANCING VALVE PRESSURE REGULATING VALVE UNION PIPE ANCHOR PIPE GUIDE PIPING DROP WITH RESPECT TO FLOW PIPING RISE WITH RESPECT TO FLOW PIPE TEE OUT OF TOP	(150')	CW SCW HW 150°HW TW HWR G CA VA ARV ARW FOS FOR FOV FOG S
120' HOT WATER TEMPERED WATER HOT WATER RETURN GAS PIPING COMPRESSED AIR VACUUM ACID RESISTANT VENT ACID RESISTANT WASTE FUEL OIL SUPPLY FUEL OIL RETURN FUEL OIL TANK VENT FUEL OIL GAUGE STORM DRAIN OR SEWER SANITARY WASTE OR SEWER PLUMBING VENTS FLOW IN DIRECTION OF ARROW PITCH DOWN IN DIRECTION OF ARROW SHUT—OFF VALVE TRIPLE DUTY VALVE CHECK VALVE TEMPERATURE REGULATING VALVE BALANCING VALVE PRESSURE RELIEF VALVE PRESSURE REGULATING VALVE UNION PIPE ANCHOR PIPE GUIDE PIPING DROP WITH RESPECT TO FLOW PIPE TEE OUT OF TOP	(150')	HW 150°HW TW HWR G CA VA ARV ARW FOS FOR FOR FOV FOG S
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IL ILL OUT OF DOLLOW	0	
PRESSURE GAUGE	_	
THERMOMETER		
STRAINER		
AUTOMATIC AIR VENT	<u> </u>	
SILL COCK	→ → → <u>SC</u>	SC
HOSE BIBB	→ → → → <u>HB</u>	НВ
NSIDE ROOF CONDUCTOR ROOF DRAIN	<u>◦ RC</u>	RC RD
OVERFLOW ROOF DRAIN	⊠ <u>ND</u>	OFD
ROOF PLUMBING VENT	•	0.0
LOOR DRAIN	Ø <u>FD</u>	FD
DPEN SITE DRAIN	∘ <u>OSD</u>	OSD
CLEAN OUT	<u>−−∞ CO</u> <u>−−∞ CO</u>	СО
PLUMBING VENT THRU ROOF SHOWER HEAD AND MIXING VALVE	<u> </u>	VTR
WATER CLOSET		WC WC
JRINAL JRINAL		UR UR
AVATORY		LAV
SERVICE SINK		SS
MOP SINK		MS
DRINKING FOUNTAIN		DF
ELECTRIC WATER COOLER TIRE DEPARTMENT CONNECTION	T_T	EWC FDC
AUTOMATIC SPRINKLER RISER		ASR
AUTOMATIC SPRINKLER PIPING	SP	SP
IRE PIPING	F	
DISTILLED WATER	DW	DW
MEDICAL COMPRESSED AIR	MA	MA
MEDICAL VACUUM	MV	MV
MEDICAL VACUUM PUMP EXHAUST AIR MEDICAL AIR COMPRESSOR INTAKE AIR		MVE MAI
VASTE ANESTHETIC GAS EVACUATION	EV	EV
VASTE ANESTHETIC GAS EVACUATE PUMP EXHAUST AIR	EVE	EVE
ABORATORY COMPRESSED AIR	LA	LA
ABORATORY AIR COMPRESSOR INTAKE AIR	LAI	LAI
ABORATORY VACUUM	LV	LV
ABORATORY VACUUM PUMP EXHAUST AIR XYGEN	LVE OX	LVE
ITROUS OXIDE	N ₂ 0	0X N ₂ 0
ITROGEN	N N	N N
ARBON DIOXIDE		CO ₂
IEDICAL GAS QUICK—CONNECT RECESSED WALL OUTLET	-0	
ABORATORY GAS BACK MOUNTED OUTLET	-0	
/ALL MOUNTED MEDICAL VACUUM SLIDE EVERSE OSMOSIS SUPPLY	b _ 500	MVS
EVERSE OSMOSIS SUPPLY EVERSE OSMOSIS RETURN	ROS———	ROS ROR
EIONIZED WATER SUPPLY	DIW —	DIW
EIONIZED WATER RETURN	DIWR —	DIWR
ROCESS COMPRESSED AIR		PA
ROCESS VACUUM	PV	PV
ROCESS VACUUM EXHAUST	PVE	PVE
ROCESS CHILLED WATER SUPPLY ROCESS CHILLED WATER RETURN	— PCH — PCHR —	PCH PCHR
ITROGEN	PCHR	PCHR N
RGON	AG	AR
ENTILATING CONTRACTOR		VC
ECHANICAL CONTRACTOR		MC
LECTRICAL CONTRACTOR		EC
EMPERATURE CONTROL CONTRACTOR		TCC
ORTH, SOUTH, EAST, WEST		IN.
LEVATION		N., S., E., W. EL.
OINT OF CONNECTION, NEW TO EXISTING	8	L. L.
ATER HAMMER ARRESTOR		WHA

GENERAL PLUMBING NOTES (APPLY TO ALL PLUMBING SHEETS)

- 1. MECHANICAL CONTRACTOR IS RESPONSIBLE FOR ALL NEW WORK SHOWN ON THESE SHEETS UNLESS OTHERWISE NOTED.
- 2. CONTRACTOR SHALL FIELD VERIFY ALL EXISTING CONDITIONS PRIOR TO BID AND MODIFY WORK AS REQUIRED FOR ANY VARIATIONS OR DEVIATIONS FROM THOSE SHOWN ON THESE SHEETS.
- 3. ALL WALLS, LIGHTS, EQUIPMENT, DUCTWORK, PIPING, ETC. SHOWN WITH THIN DOTTED LINES IS EXISTING TO REMAIN CONDITIONS AND SHOULD BE USED FOR
- REFERENCE ONLY, AND MAY INDICATE NONEXISTENT OR INACCURATE CONDITIONS. 4. ALL EQUIPMENT, DUCTWORK AND PIPING SHOWN WITH THICK DASHED LINES IS EXISTING TO BE REMOVED OR RELOCATED.
- 5. ALL EQUIPMENT, DUCTWORK AND PIPING SHOWN WITH THICK SOLID LINES IS NEW
- 6. ALL BULKHEADS, CANOPIES AND ROOF OVERHANGS SHOWN WITH THIN DOTTED/DASHED LINES AND IS NOT OTHERWISE NOTED, INDICATE LOCATION PROVIDED BY OTHER CONTRACTORS.
- 7. REFER TO ARCHITECTURAL, STRUCTURAL, MECHANICAL AND ELECTRICAL SHEETS AND COORDINATE ALL WORK.
- 8. ALL PIPING IN PIPE SPACES AND TUNNELS SHALL BE PLACED AS CLOSE TO WALLS AS POSSIBLE TO ALLOW MAXIMUM ACCESS.
- 9. ALL DUCTWORK AND PIPING ABOVE CEILING SHALL BE PLACED TO AVOID LIGHTING FIXTURES, JOISTS, BEAMS, ETC.
- 10. PROVIDE CEILING ACCESS PANELS FOR ACCESS TO VOLUME DAMPERS, FIRE AND SMOKE DAMPERS, SHUT-OFF VALVES, CONTROL VALVES, DRAIN VALVES, EQUIPMENT, ETC. LOCATED ABOVE NON-ACCESSIBLE CEILINGS (INCLUDES ALL EXISTING ITEMS REQUIRING ACCESS WHERE NEW NON-ACCESSIBLE CEILINGS OCCUR). COORDINATE ALL ACCESS PANELS WITH THE ARCHITECT.
- 11. CONTRACTOR SHALL CORE DRILL HOLES THROUGH FLOORS, WALLS, DECKS, ETC. WHERE PASSAGE IS NOT AVAILABLE TO INSTALL NEW PIPING. PROVIDE PIPE SLEEVES AND PROPERLY SEAL ALL PIPE PENETRATIONS AS REQUIRED. REFER TO
- 12. ALL DOMESTIC WATER PIPING HEADERS LOCATED IN PIPE CHASE SHALL BE SAME SIZE AS PIPING MAIN DROPS INDICATED ON THESE SHEETS.
- 13. ALL DOMESTIC, HEATING AND CHILLED WATER, GAS, COMPRESSED AIR, ETC. BRANCH PIPING SHOWN WITHOUT SIZE INDICATED, SHALL BE A MINIMUM OF 3/4".
- 14. ALL HORIZONTAL SANITARY AND STORM PIPING INSIDE OF BUILDING SHALL SLOPE A MINIMUM OF 1/4" PER 1"-0" UNLESS OTHERWISE NOTED.
- 15. EXACT LOCATION OF ALL FLOOR DRAINS IN BOILER AND MECHANICAL ROOMS SHALL BE VERIFIED BY ARCHITECT. IN GENERAL; FLOOR DRAINS SHALL BE LOCATED WITHIN 6" OF CONCRETE PADS SUPPORTING EQUIPMENT AND SHALL BE CENTERED WHERE DRAINING IS REQUIRED, ADDITIONALLY FLOOR DRAIN STRAINERS SHALL BE DEPRESSED APPROXIMATELY 1" BELOW BOILER AND MECHANICAL ROOMS, ETC. FLOOR ELEVATION.
- 16. ALL WATER AND WASTE PIPING UNDER FLOOR SLAB SHALL CONTINUE FULL SIZE OF HORIZONTAL BRANCH. VERTICAL SUPPLY RISER TO FIXTURES SHALL BE REDUCED TO SIZE REQUIRED BY THE FIXTURE, FLUSH AT FLOOR OR WALL
- 17. WATER HAMMER ARRESTORS SHALL BE SIZED AND INSTALLED PER PLUMBING AND DRAINAGE INSTITUTE (STANDARD PDI-WH 20) REQUIREMENTS IN ACCESSIBLE LOCATIONS ON THE HOT AND COLD WATER PIPING AND WHERE FLUSH VALVES AND ANY OTHER QUICK CLOSING VALVES ARE USED.
- 18. CONTRACTOR SHALL ALSO PROVIDE AND INSTALL VALVES IN ALL PIPING AS REQUIRED TO FACILITATE OPERATION OF VARIOUS SYSTEMS DURING CONSTRUCTION.




TYPICAL EXTERIOR **CLEANOUT DETAIL** NOT TO SCALE

NOT TO SCALE _EXPANSION TANK, EXT-2 - ASME T&P RELIEF VALVE, TERMINATE RELIEF DRAIN STRAP-ON AQUASTAT -HOT WATER PIPING OVER FLOOR (TYPICAL) -CIRCULATION PUMP, THERMOMETER -SEE FLOOR PLAN E FLOOR \--(150 FOR PIPE SIZE LANS FOR . _2 1/2"SCW - THERMOMETER -SHUT-OFF VALVE (TYPICAL) -HOT WATER (TYPICAL) CIRCULATION - UNION (TYPICAL) TMV-1 THERMOSTATIC ASME APPROVED TEMP. & MIXING VALVE, LAWLER PRESSURE RELIEF VALVE └─ TMV-2 THERMOSTATIC ELECTRIC WATER HEATER #801, 22.5 GPM AT 8 PSI DROP (PIPE TO FLOOR DRAIN) 2 1/2"HW(150°) MIXING VALVE LAWLER MODEL #9600, WATER _3/4"HWR (150°) -FLOOR DRAIN EXPANSION CONCRETE PAD-TANK DRAIN --2 1/2"SCW FINISH FLOOR-CONCRETE PAD-TANK DRAIN -


DOMESTIC WATER HEATER PIPING DETAIL

NOT TO SCALE


ELECTRIC WATER

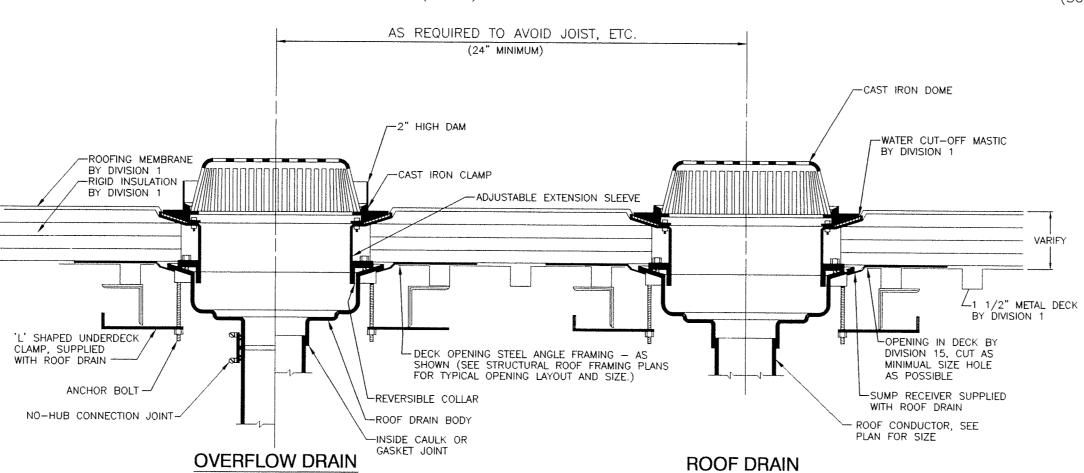


ROOF & OVERFLOW DRAIN DETAIL

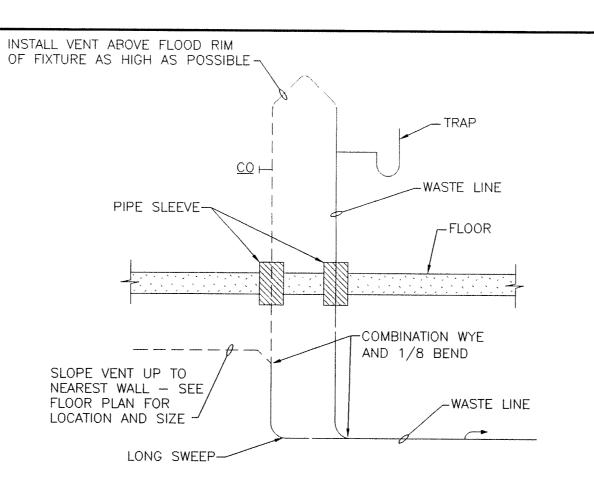


ISLAND SINK WASTE AND VENT PIPING DETAIL

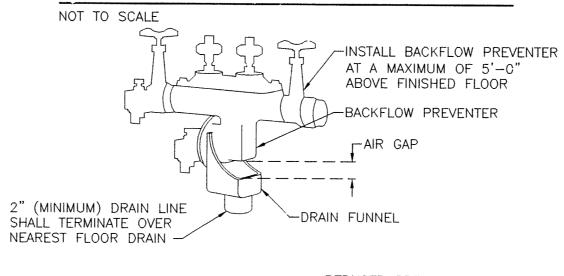


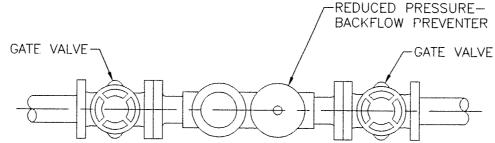


BACKFLOW PREVENTER DETAIL

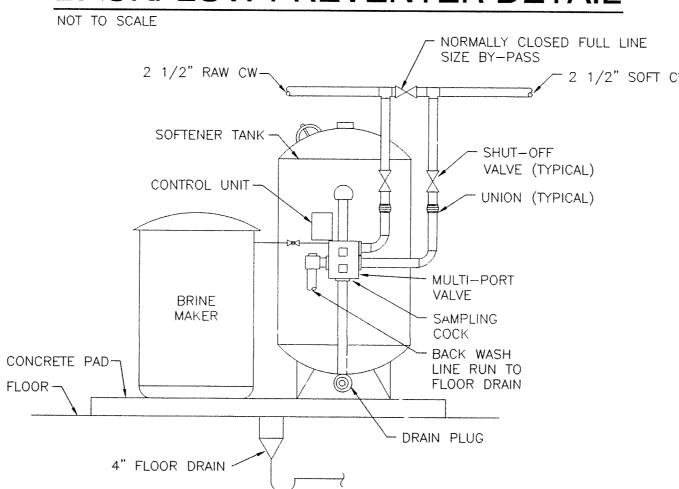

DOMESTIC WATER SOFTENER PIPING DETAIL

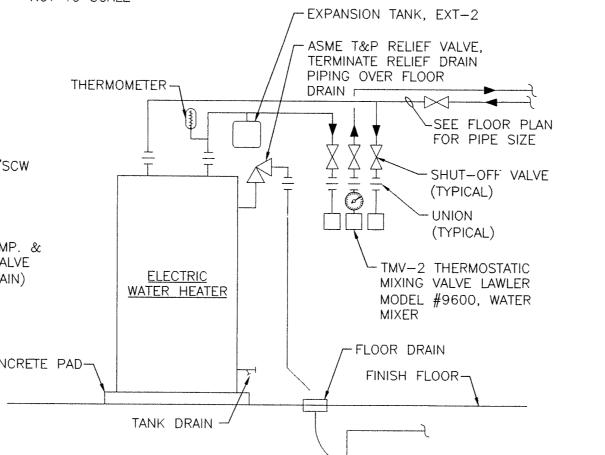

HEATER PIPING DETAIL NOT TO SCALE

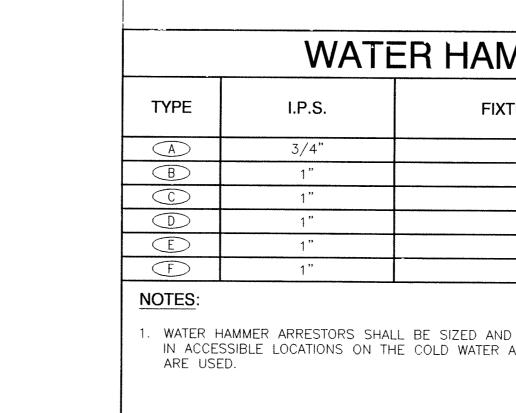

		WATER HE	EATER SC	CHEDUL	E ([OHW	<u>')</u>	******	
NO.	MANUFACTURER AND MODEL	NOMINAL STORAGE CAPACITY (GAL.)	INPUT RATING MBH	1 1		ELECTRIC	CAL DATA		SEE
	AND WODEL	OALAOTT (GAL.)	NATURAL GAS	AT 100 °F RISE	AMPS	KW	VOLTS	PHASE	NOTE
DWH-1	A. O. SMITH BTH-150	100	135	134			120	1	1
DWH-2	A. O. SMITH PEC-66	66		16.45	18.8	4.5	240	1	

NOTES:

. TWO (2) WATER HEATERS REQUIRED PIPED PARALLEL, PROVIDE A. O. SMITH MANIFOLD KIT #78692.

	RECIRCULATING PUMP SCHEDULE (DHWRP)									
СР	SYSTEM	BELL AND GOSSE	TT MODEL NUMBER	GPM	FEET	HP	SEE			
NO.	SERVED	SERIES	SIZE	ai w	HEAD	1115	NOTE			
DHWRP-1	120° NEW	PL-36B	3/4"	22	20	1/6	1,2			
DHWRP-2	140°	PL-36B	3/4"	22	20	1/6	1,2			
DHWRP-3	120° EXISTING	PL-36B	3/4"	22	20	1/6	1,2			

NOTES:

. PUMP MOTOR: 120 VOLTS, 1 PHASE, 60 HERTZ, 1750 RPM.

. PUMP SHALL START AND STOP ON 10° TEMPERATURE IN RETURN MAINS.

		_	WAT	ER S	SOF	TEN	IER	SCHEDUL	E			
NO. MANUFACTURE		CAPACITY PER SOFTENER TANK RESIN BACKWASH GRAINS EXCHANGE LBS. SALT/REGE					T/REGEN	BRINE MAKER SALT	ELECTRICAL DATA			SEE
	AND MODEL	CU. FT.		MAX.	MIN.	MAX.	MIN.	CAPACITY (LB.)	WATTS	VOLTS	PHASE	NOTE
WS-1	AQUA SYSTEMS #700	7.00	10	266,000	147,000	*****		1500		120	1	1,2
NOT	EQ.			, ,,					***************************************		I	

NOTES:

1. FULLY AUTOMATIC OPERATION.

2. 30"X48" BRINE TANK.

		PL	UMBI	NG F	IXTUI	RE SC	HEDULE	
	ITEM	FIXTURE	WASTE	VENT	CW	HW	FIXTURE MOUNTING HEIGHT	SEE NOTE
	P-1	WATER CLOSET	4"	2"	1"	_	15" RIM AFF	_
	P-2	WATER CLOSET—ADA	4"	2"	1"	_	18" TOP OF SEAT AFF	_
	P3	URINAL	2"	1 1/2"	3/4		24" LIP AFF	
CW [P-4	LAVATORY-ADA	1 1/2"	1 1/2"	1/2"	1/2"	27" RIM AFF	
	P-5	LAVATORY W/STOPPER-ADA	1 1/2"	1 1/2"	1/2"	1/2"	34" RIM AFF	
	P-6	CABINET SINK	1 1/2"	1 1/2"	1/2"	1/2"	COUNTER TOP MOUNTED	6
	P-7	WATER COOLER—ADA	1 1/2"	1 1/2"	1/2"		SEE NOTE #5	5
	P-8	MOP SINK	3"	1 1/2"	3/4"	3/4"	FLOOR MOUNTED	_
	P-9	SERVICE SINK	3"	1 1/2"	3/4"	3/4"	TRAP STANDARD	
ſ	P-10	CABINET LAVATORY—ADA	1 1/2"	1 1/2"	1/2""	1/2"	COUNTER TOP MOUNTED	6
	P-11	WATER CLOSET-KINDERGARTEN	4"	2"	1"	_	10" RIM AFF	

NCTES:

- MECHANICAL CONTRACTOR SHALL CONSULT WITH THE ARCHITECT BEFORE ROUGHING-IN ANY WATER CLOSETS.
- 2. ALL SIZES SHOWN ARE INDIVIDUAL BRANCH SIZES TO FLUSH VALVES, FAUCETS, BUBBLERS, ETC.
- 3. ALL WATER CLOSETS AND URINALS SHALL BE FLUSH VALVE OPERATED
- 4. ALL FIXTURES, INCLUDING DRINKING FOUNTAINS AND WATER COOLERS, SHALL BE CHROME-PLATED, KEY OPERATED AND VALVE EXPOSED AT THE
- 5. MOUNT ONE EWC AT 36" AFF TO BUBBLER FOR ADA AND MOUNT ONE AT 26" AFF TO BUBBLER.
- 6. CABINET SINKS WILL BE FURNISHED COMPLETE WITH TRIM UNDER A DIFFERENT CONTRACT AND TURNED OVER TO THE MECHANICAL CONTRACTOR AT THE JOB SITE. THE MECHANICAL CONTRACTOR SHALL SET SINK PROVIDE ALL LABOR AND MATERIAL TO ROUGH-IN AND HOOKUP COMPLETE.

	FLOOR DRAIN SCHEDULE										
TYPE	JAY '	R. SMITH	GENERAL	SEE							
	FLOOR DRAIN	TRAP	LOCATION	NOTE							
Α	MODEL 2041-A	INTEGRAL	FINISHED AREA FLOOR ON GRADE	2							
В	MODEL 2632-AB	4595 WITH 4429 CO	MECHANICAL EQUIPMENT ROOM	4							
С	MODEL 2220	4595 WITH 4429 CO	BOILER ROOM, MECHANICAL ROOM, ETC.	3							
D	MODEL 2010-AB	7222 WITH BRONZE PLUG	MECHANICAL EQUIPMENT ROOMS NOT ON GRADE	3							
E	MODEL 3150-12	1595 WITH 4021-T CO	KITCHEN AREA ONLY	5							


ALL FLOOR AND SHOWER DRAINS SHALL BE FULL SIZE OF THE CONNECTION WASTE LINE SHOWN ON THE DRAWINGS. UNLESS OTHERWISE

- ALL FLOOR DRAINS SHALL HAVE NICKEL BRONZE RIMS AND STRAINERS. THE STRAINERS SHALL HAVE A 5" MINIMUM DIAMETER OR TWICE THAT OF THE CONNECTING WASTE LINE, UNLESS OTHERWISE NOTED.
- 3. FLOOR DRAIN SHALL HAVE A SHALLOW PERFORATED SEDIMENT BUCKET AND POLISHED BRONZE STRAINER.
- 4. PROVIDE 3/4 GRATE.
- 5. FLOOR DRAIN SHALL HAVE NICKEL BRONZE RIM AND 1/2 GRATE.

EXPANSI	ON TANK	SCHEDU	LE (EXT)	
SYSTEM	A.MTROL	VC	PRE-CHARGE	
SERVED	MODEL NO.	TANK	ACCEPTANCE	PRESSURE PSI
DOMESTIC HW (NORTH)	ST-20V-C	7.6	.32	40
DOMESTIC HW (SOUTH)	ST-5-C	2.1	.43	40
	SYSTEM SERVED DOMESTIC HW (NORTH)	SYSTEM AMTROL MODEL NO. DOMESTIC HW (NORTH) ST-20V-C	SYSTEM AMTROL VC SERVED MODEL NO. TANK DOMESTIC HW (NORTH) ST-20V-C 7.6	SERVED MODEL NO. TANK ACCEPTANCE DOMESTIC HW (NORTH) ST-20V-C 7.6 .32

WATER HAMMER ARRESTOR SCHEDULE											
TYPE	I.P.S.	FIXTURE UNIT RATING	J.R.SMITH NO.	SEE NOTE							
A	3/4"	1-11	5005	1							
B	1"	12-32	5010	1							
	1"	33-60	5020	1							
D	1"	61-113	5030	1							
E	1"	114-154	5040	1							
(F)	1"	155-330	5050	1							

WATER HAMMER ARRESTORS SHALL BE SIZED AND INSTALLED PER PLUMBING AND DRAINAGE INSTITUTE (STANDARD PDI-WH 201) REQUIREMENTS IN ACCESSIBLE LOCATIONS ON THE COLD WATER AND HOT WATER PIPING AND WHERE FLUSH VALVES AND ANY OTHER QUICK CLOSING VALVES

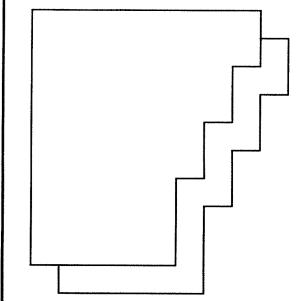

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PROJECT

LAWRENCE CENTRALIZED **KINDERGARTEN**

NORTH & SOUTH CAMPUS ADDITIONS

METROPOLITAN SCHOOL DISTRICT OF LAWRENCE TOWNSHIP

MARION COUNTY, INDIANA

GIBRALTAR DESIGN

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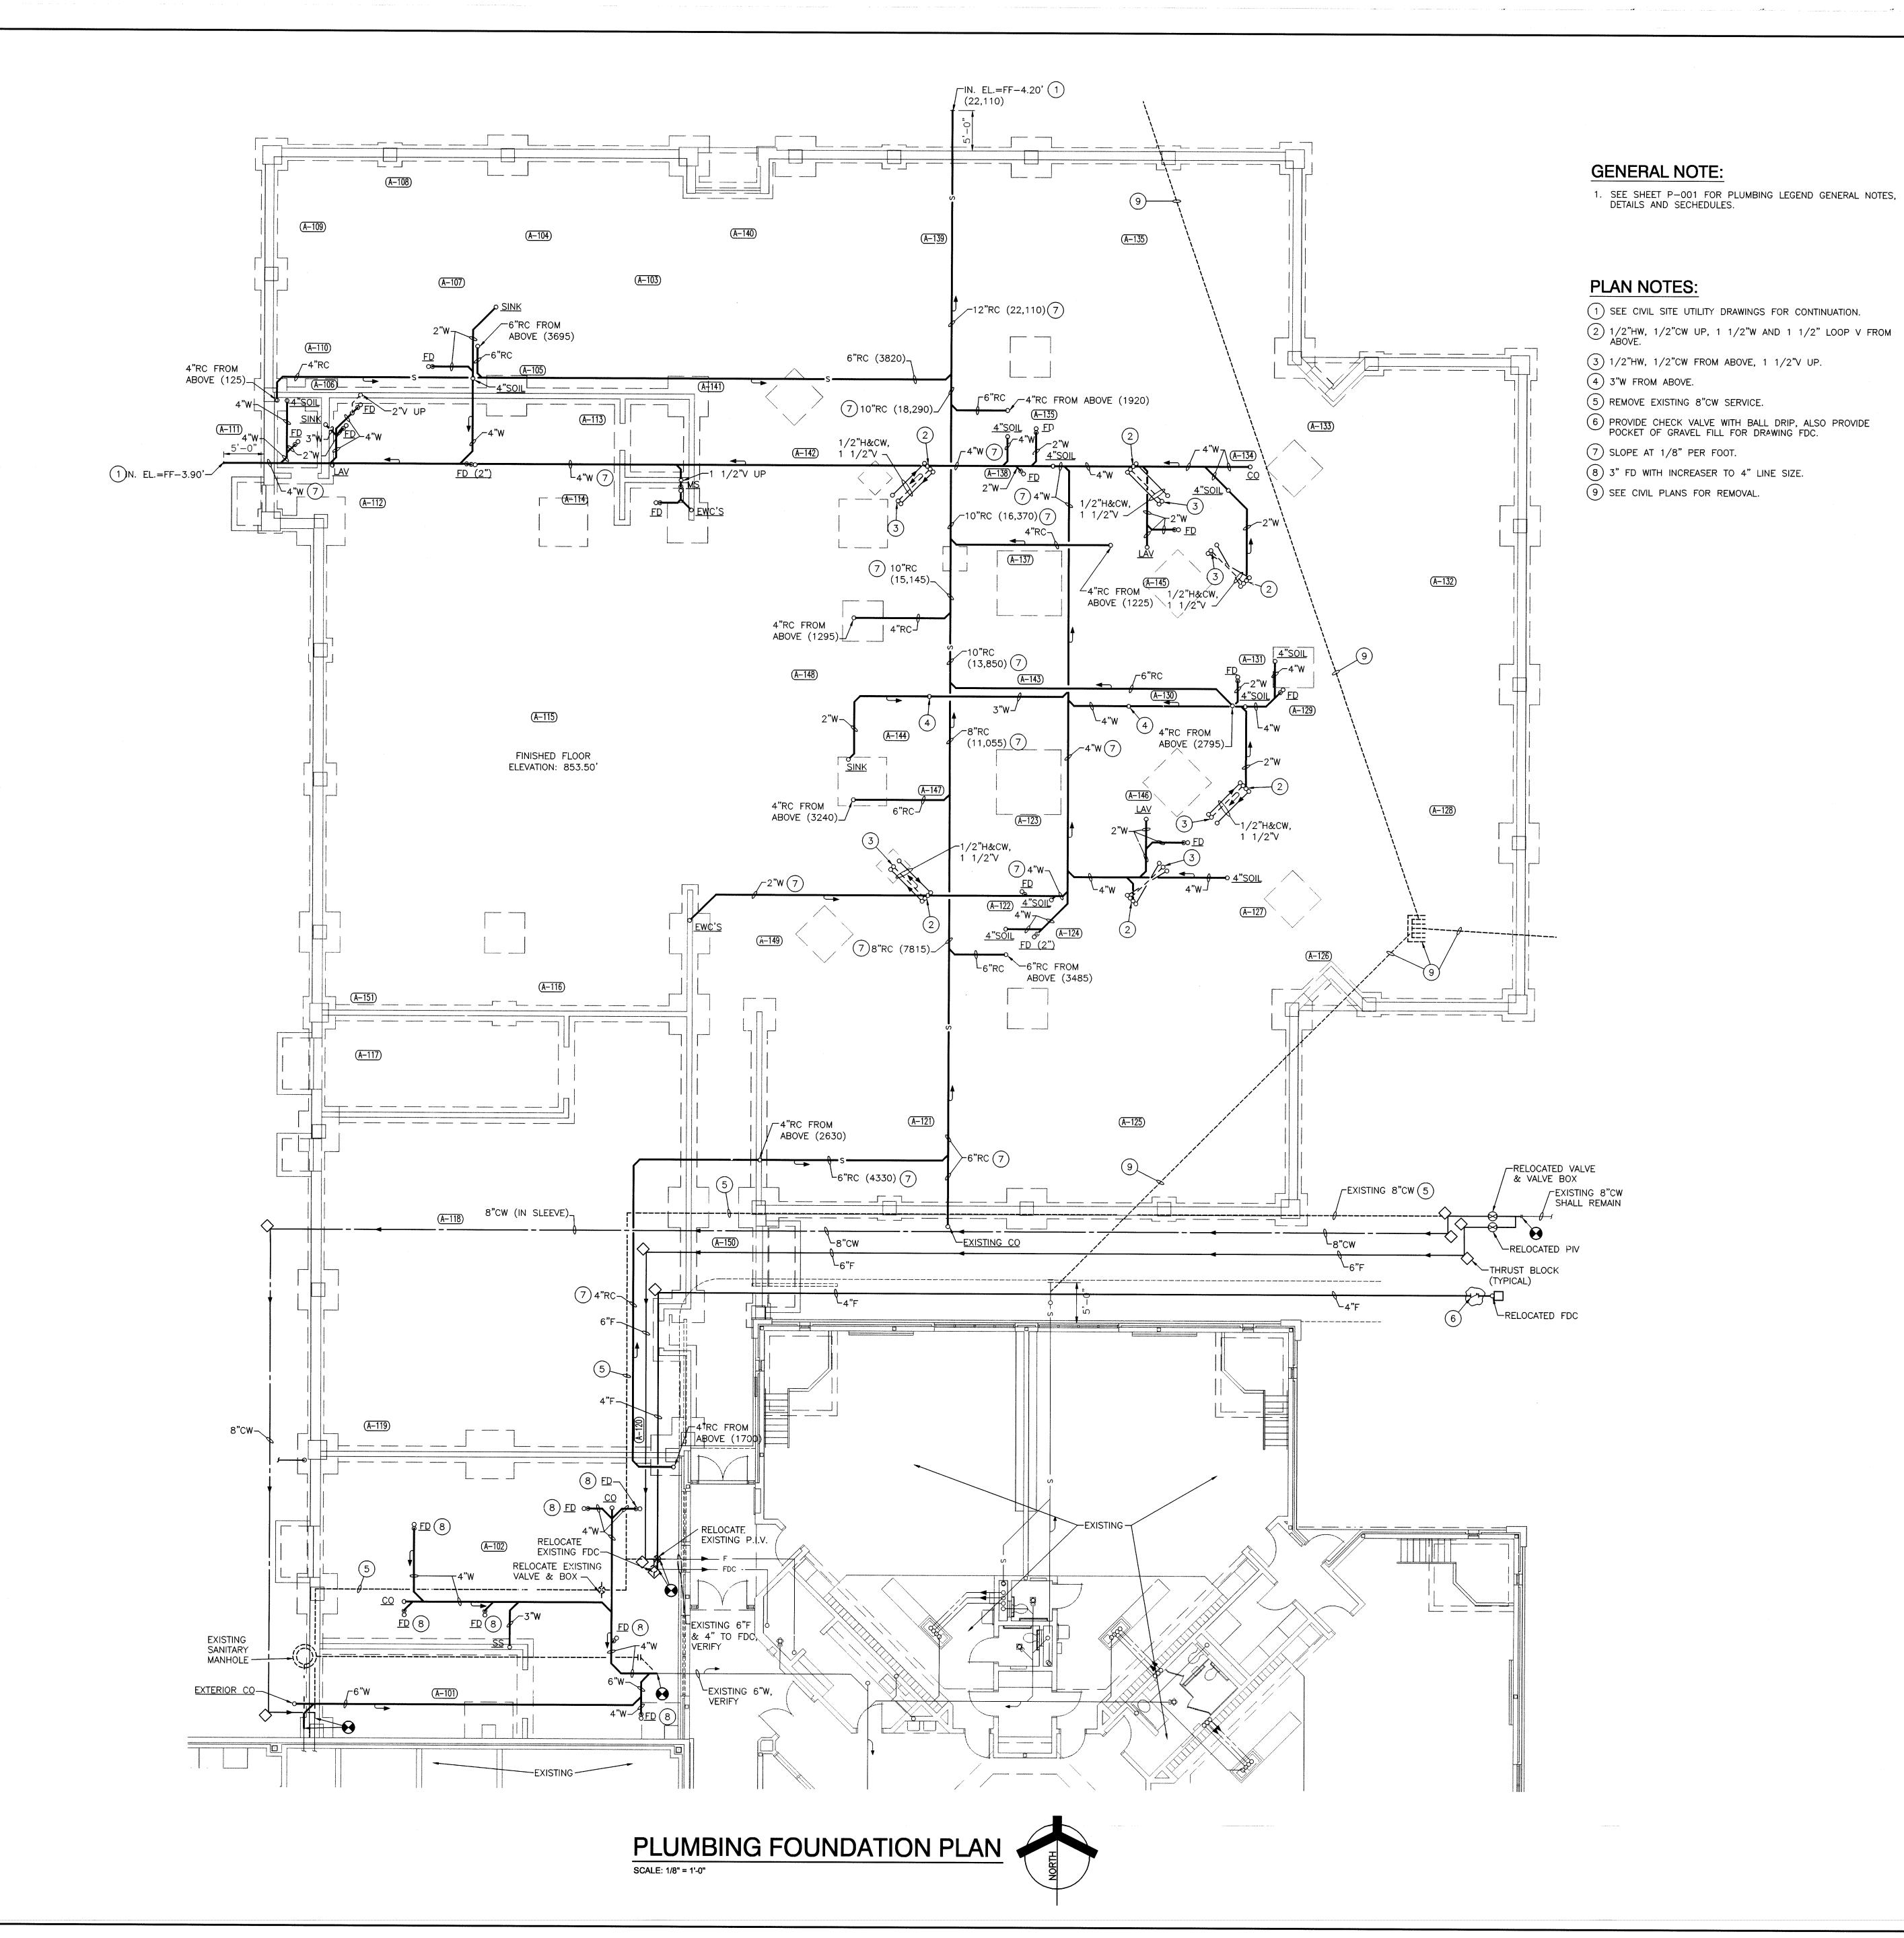
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PLUMBING LEGEND, GENERAL NOTES, DETAILS AND SCHEDULES

PROJECT LAWRENCE CENTRALIZED KINDERGARTEN NORTH & SOUTH CAMPUS ADDITIONS

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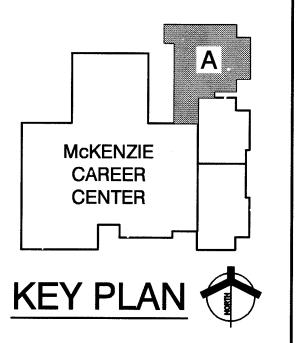
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LAWRENCE CENTRALIZED KINDERGARTEN

NORTH & SOUTH CAMPUS ADDITIONS

METROPOLITAN SCHOOL DISTRICT
OF LAWRENCE TOWNSHIP
MARION COUNTY, INDIANA



GIBRALTAR DESIGN

9102 N. Meridian St., Ste. 300
Indianapolis, IN 46260
Homepage www.GibraltarDesign.com
Email info@GibraltarDesign.com
Phone 317.580.5777 Fax 317.580.5778

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AJP

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DRAWING
UNIT "A" PLUMBING
FOUNDATION PLAN


PROJECT

LAWRENCE CENTRALIZED KINDERGARTEN

NORTH CAMPUS

© GIBRALTAR DESIGN SHEET

P-101

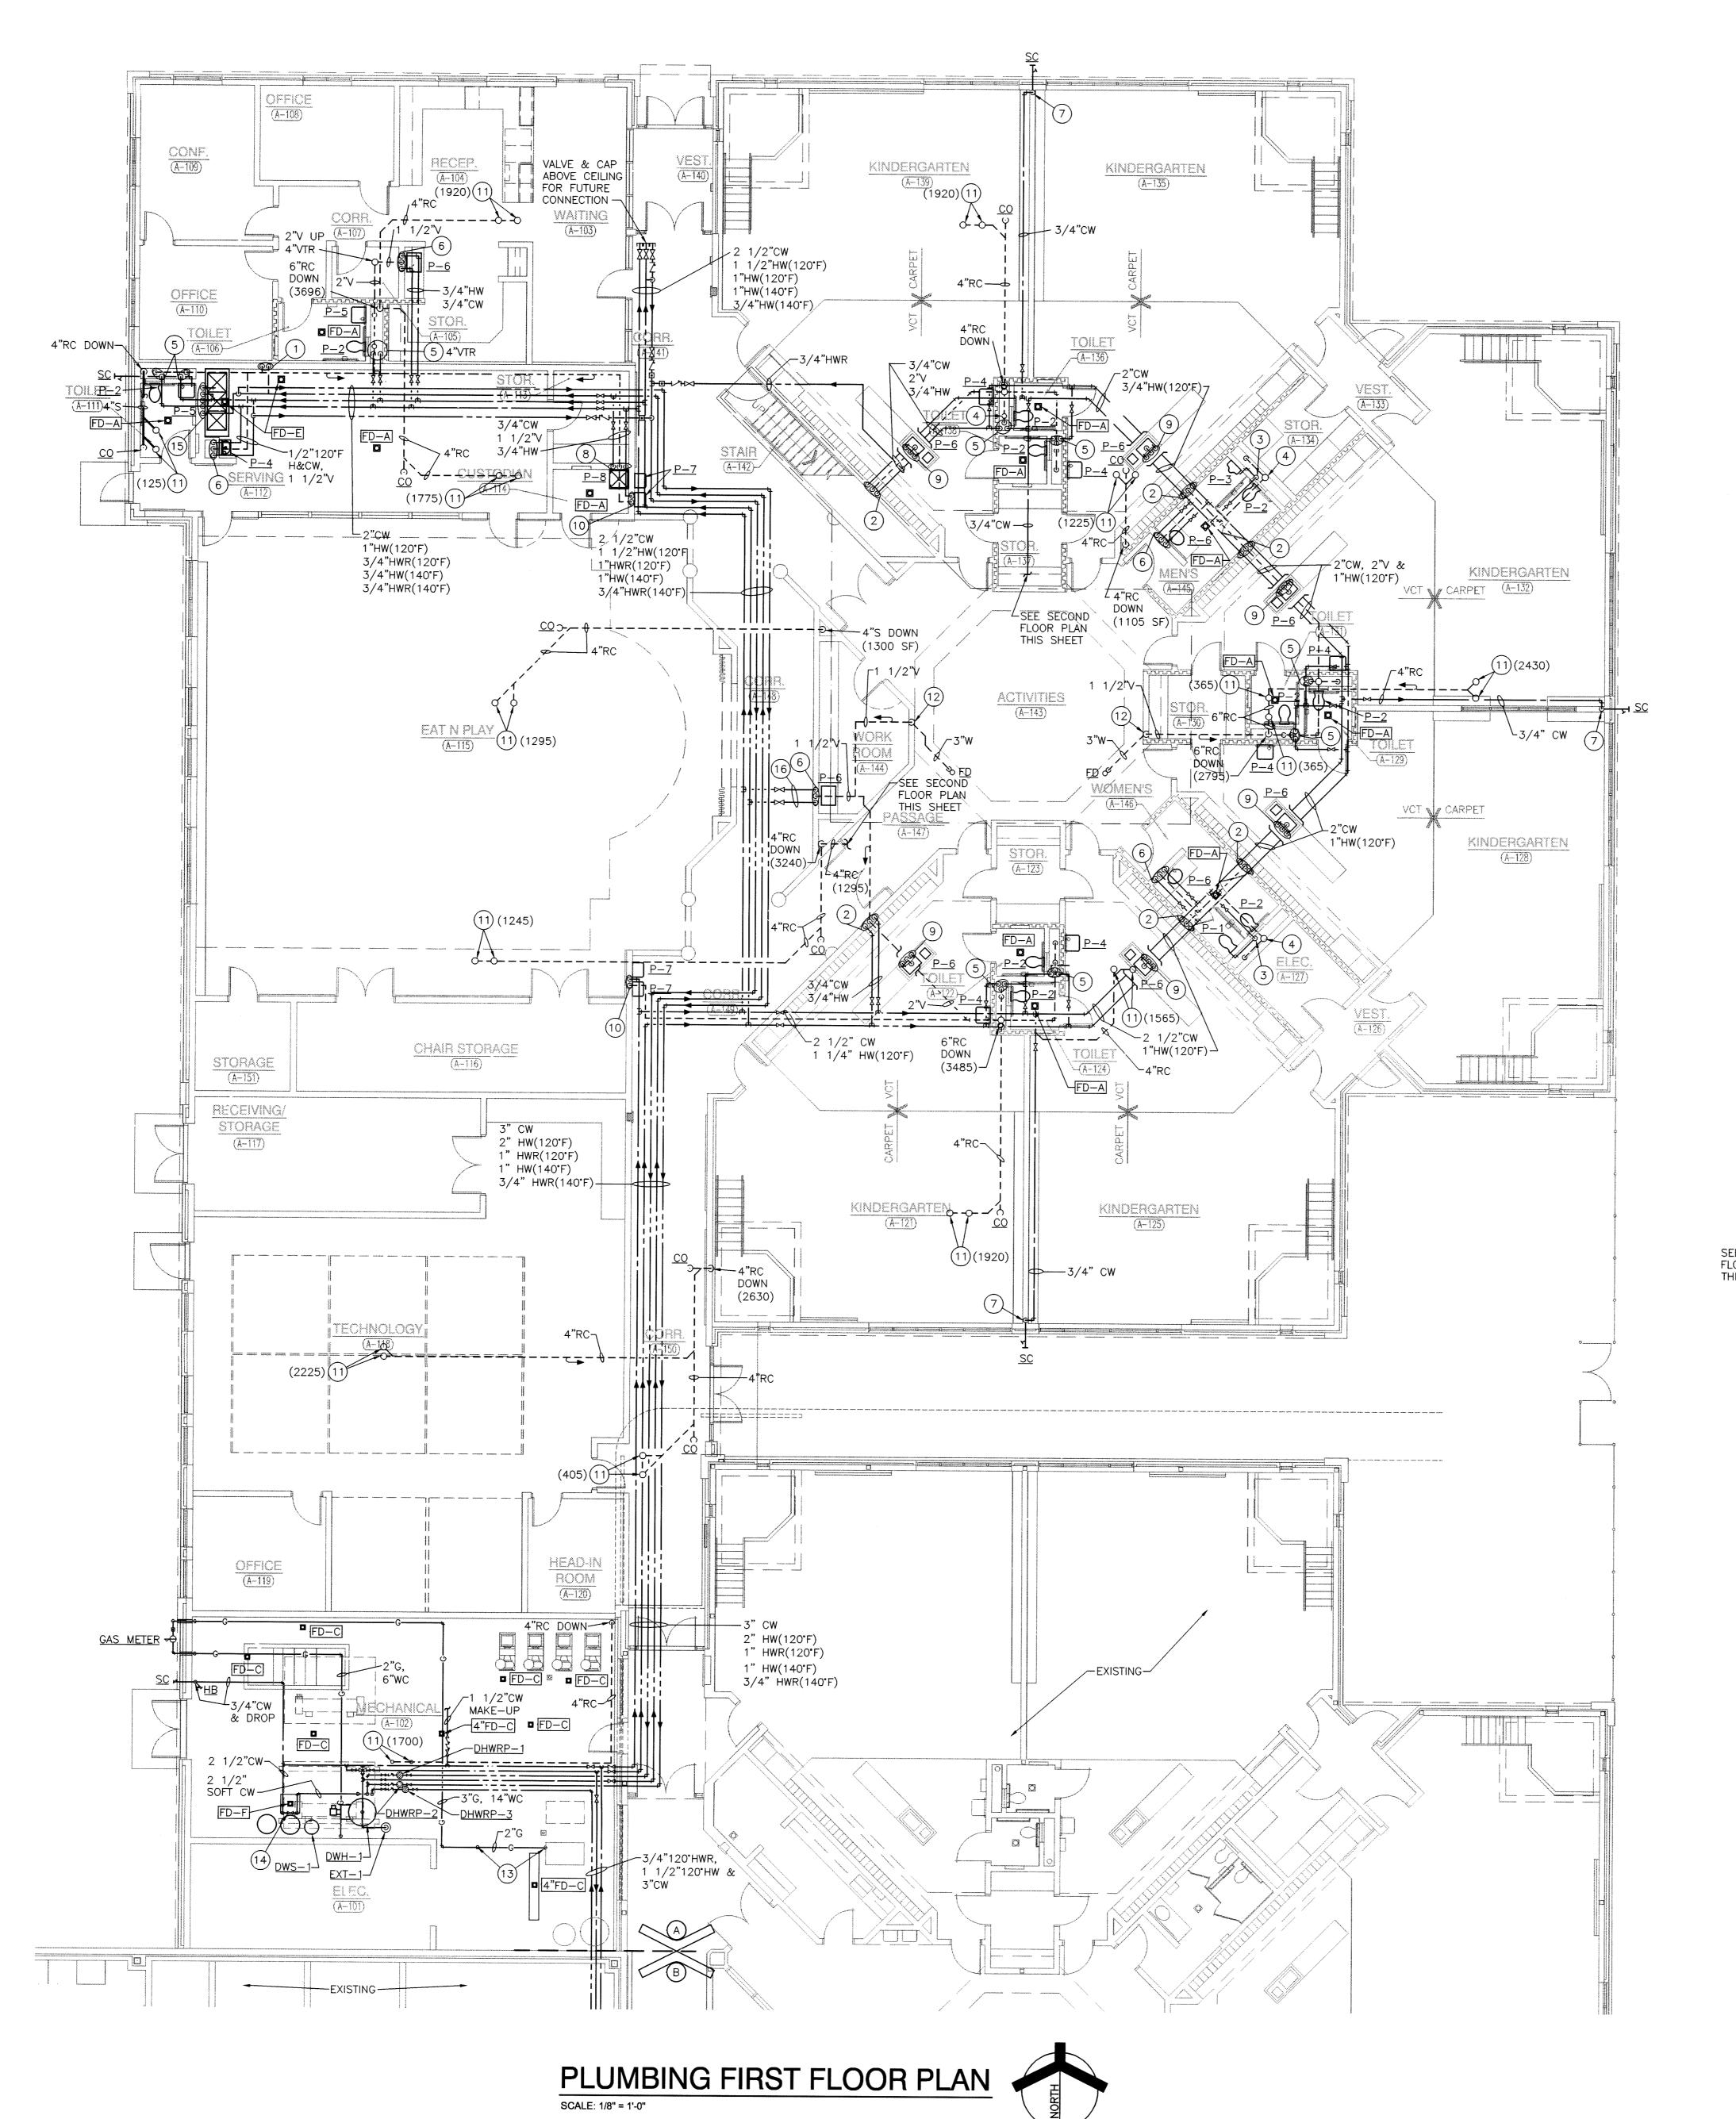


 SEE SHEET P-001 FOR PLUMBING LEGEND, GENERAL NOTES, DETAILS AND SECHEDULES.

PLAN NOTES:

- 1) 3/4"150"HW DROP AND 2"V FROM BELOW.
 2) 3/4"HW, 3/4"CW, 2" LOOP-VENT DOWN IN WALL AND PIE
- 2 3/4"HW, 3/4"CW, 2" LOOP-VENT DOWN IN WALL AND PIPED UNDER FLOOR.


 (3) 1 1/2"CW WITH WHA TYPE "B" DOWN IN WALL.
- 2"V RISE, 4"V UP THRU ROOF, 4"W DOWN.
- 5 1 1/2"CW WITH WHA TYPE "A" DOWN IN CHASE, 2"V RISE, 4"W DOWN.
- 6 1/2"HW, 1/2"CW, 1 1/2"W AND 1 1/2"V DOWN.


 (7) 3/4"CW DOWN IN WALL FOR CONNECTION TO SILL COCK.
- 8 3/4"150"HW, 3/4"CW, 1 1/2"V FROM BELOW FOR CONNECTION TO MOP SINK.
- 9 1/2"HW, 1/2"CW, 1 1/2"W AND 2" LOOP-VENT STUB UP FROM BELOW FLOOR FOR CONNECTION TO SINK.
- 10 1/2"CW, 1 1/2"W AND 1 1/2"V DOWN IN WALL FOR CONNECTION TO ELECTRIC WATER COOLER.
- 11) 4"RC FROM RD/OFF ABOVE.
- (12) 3"W DOWN, 1 1/2"V RISE.
- 2"G DROP TO BOILER, PROVIDE UNION, SHUT-OFF VALVE, DROP LEG, ETC. AND HOOK-UP BOILER COMPLETE.
- 2 1/2"CW DROP TO AND 2 1/2" SOFT CW RISE FROM WATER SOFTENER, PROVIDE 2 1/2" NORMALLY CLOSED BY PASS.
- (15) 3/4"150°HW AND 3/4"CW DROP, 3"W DOWN AND 1 1/2"V RISE.
- (16) 1/2"HW AND 1/2"CW.

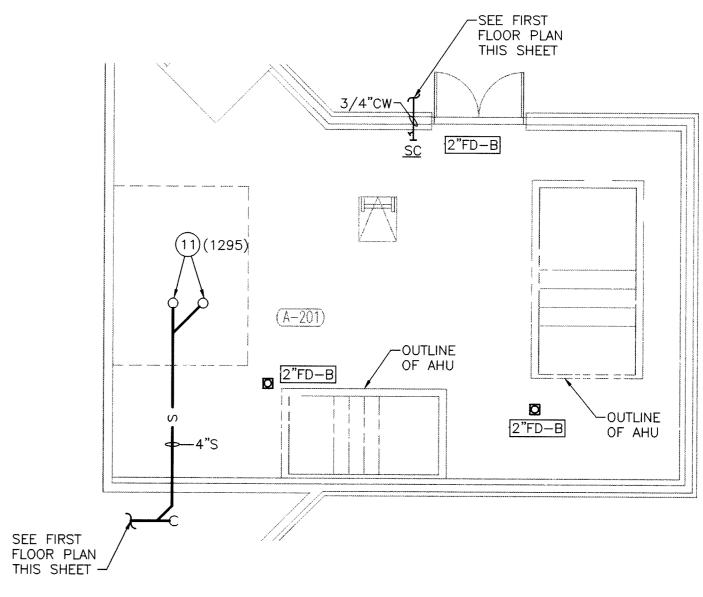

PLUMBING SECOND FLOOR PLAN


SCALE: 1/8" = 1'-0"

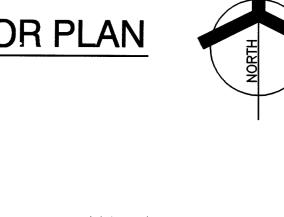

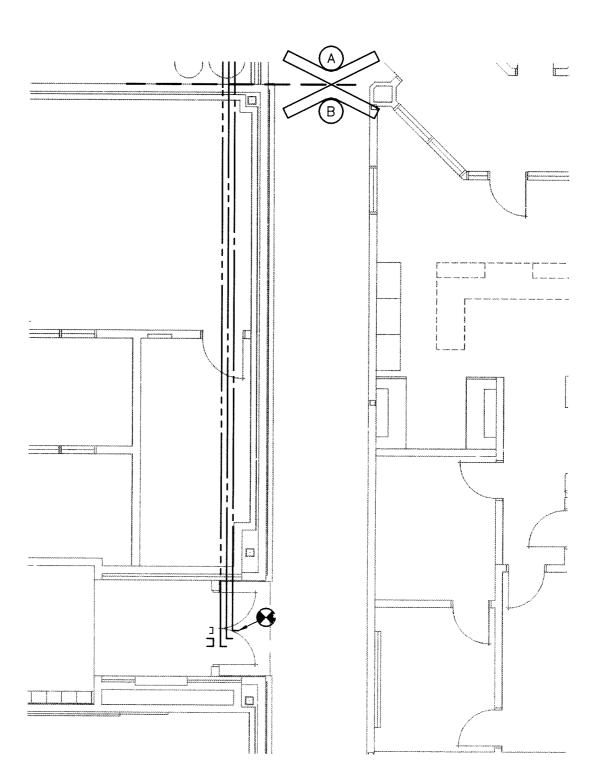

PLUMBING FIRST FLOOR PLAN

SCALE: 1/8" = 1'-0"

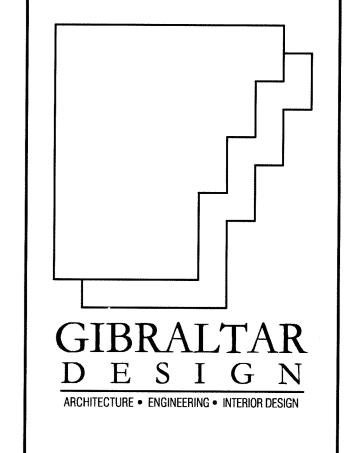


PROJECT

LAWRENCE CENTRALIZED KINDERGARTEN

NORTH & SOUTH CAMPUS ADDITIONS

METROPOLITAN SCHOOL DISTRICT OF LAWRENCE TOWNSHIP

MARION COUNTY, INDIANA

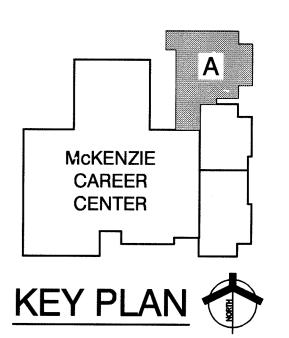

GIBRALTAR DESIGN

9102 N. Meridian St., Ste. 300
Indianapolis, IN 46260
Homepage www.GibraltarDesign.com
Email info@GibraltarDesign.com
Phone 317.580.5777 Fax 317.580.5778

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02-580

DATE
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COORDINATED BY
AJP

DRAWN BY
MBW

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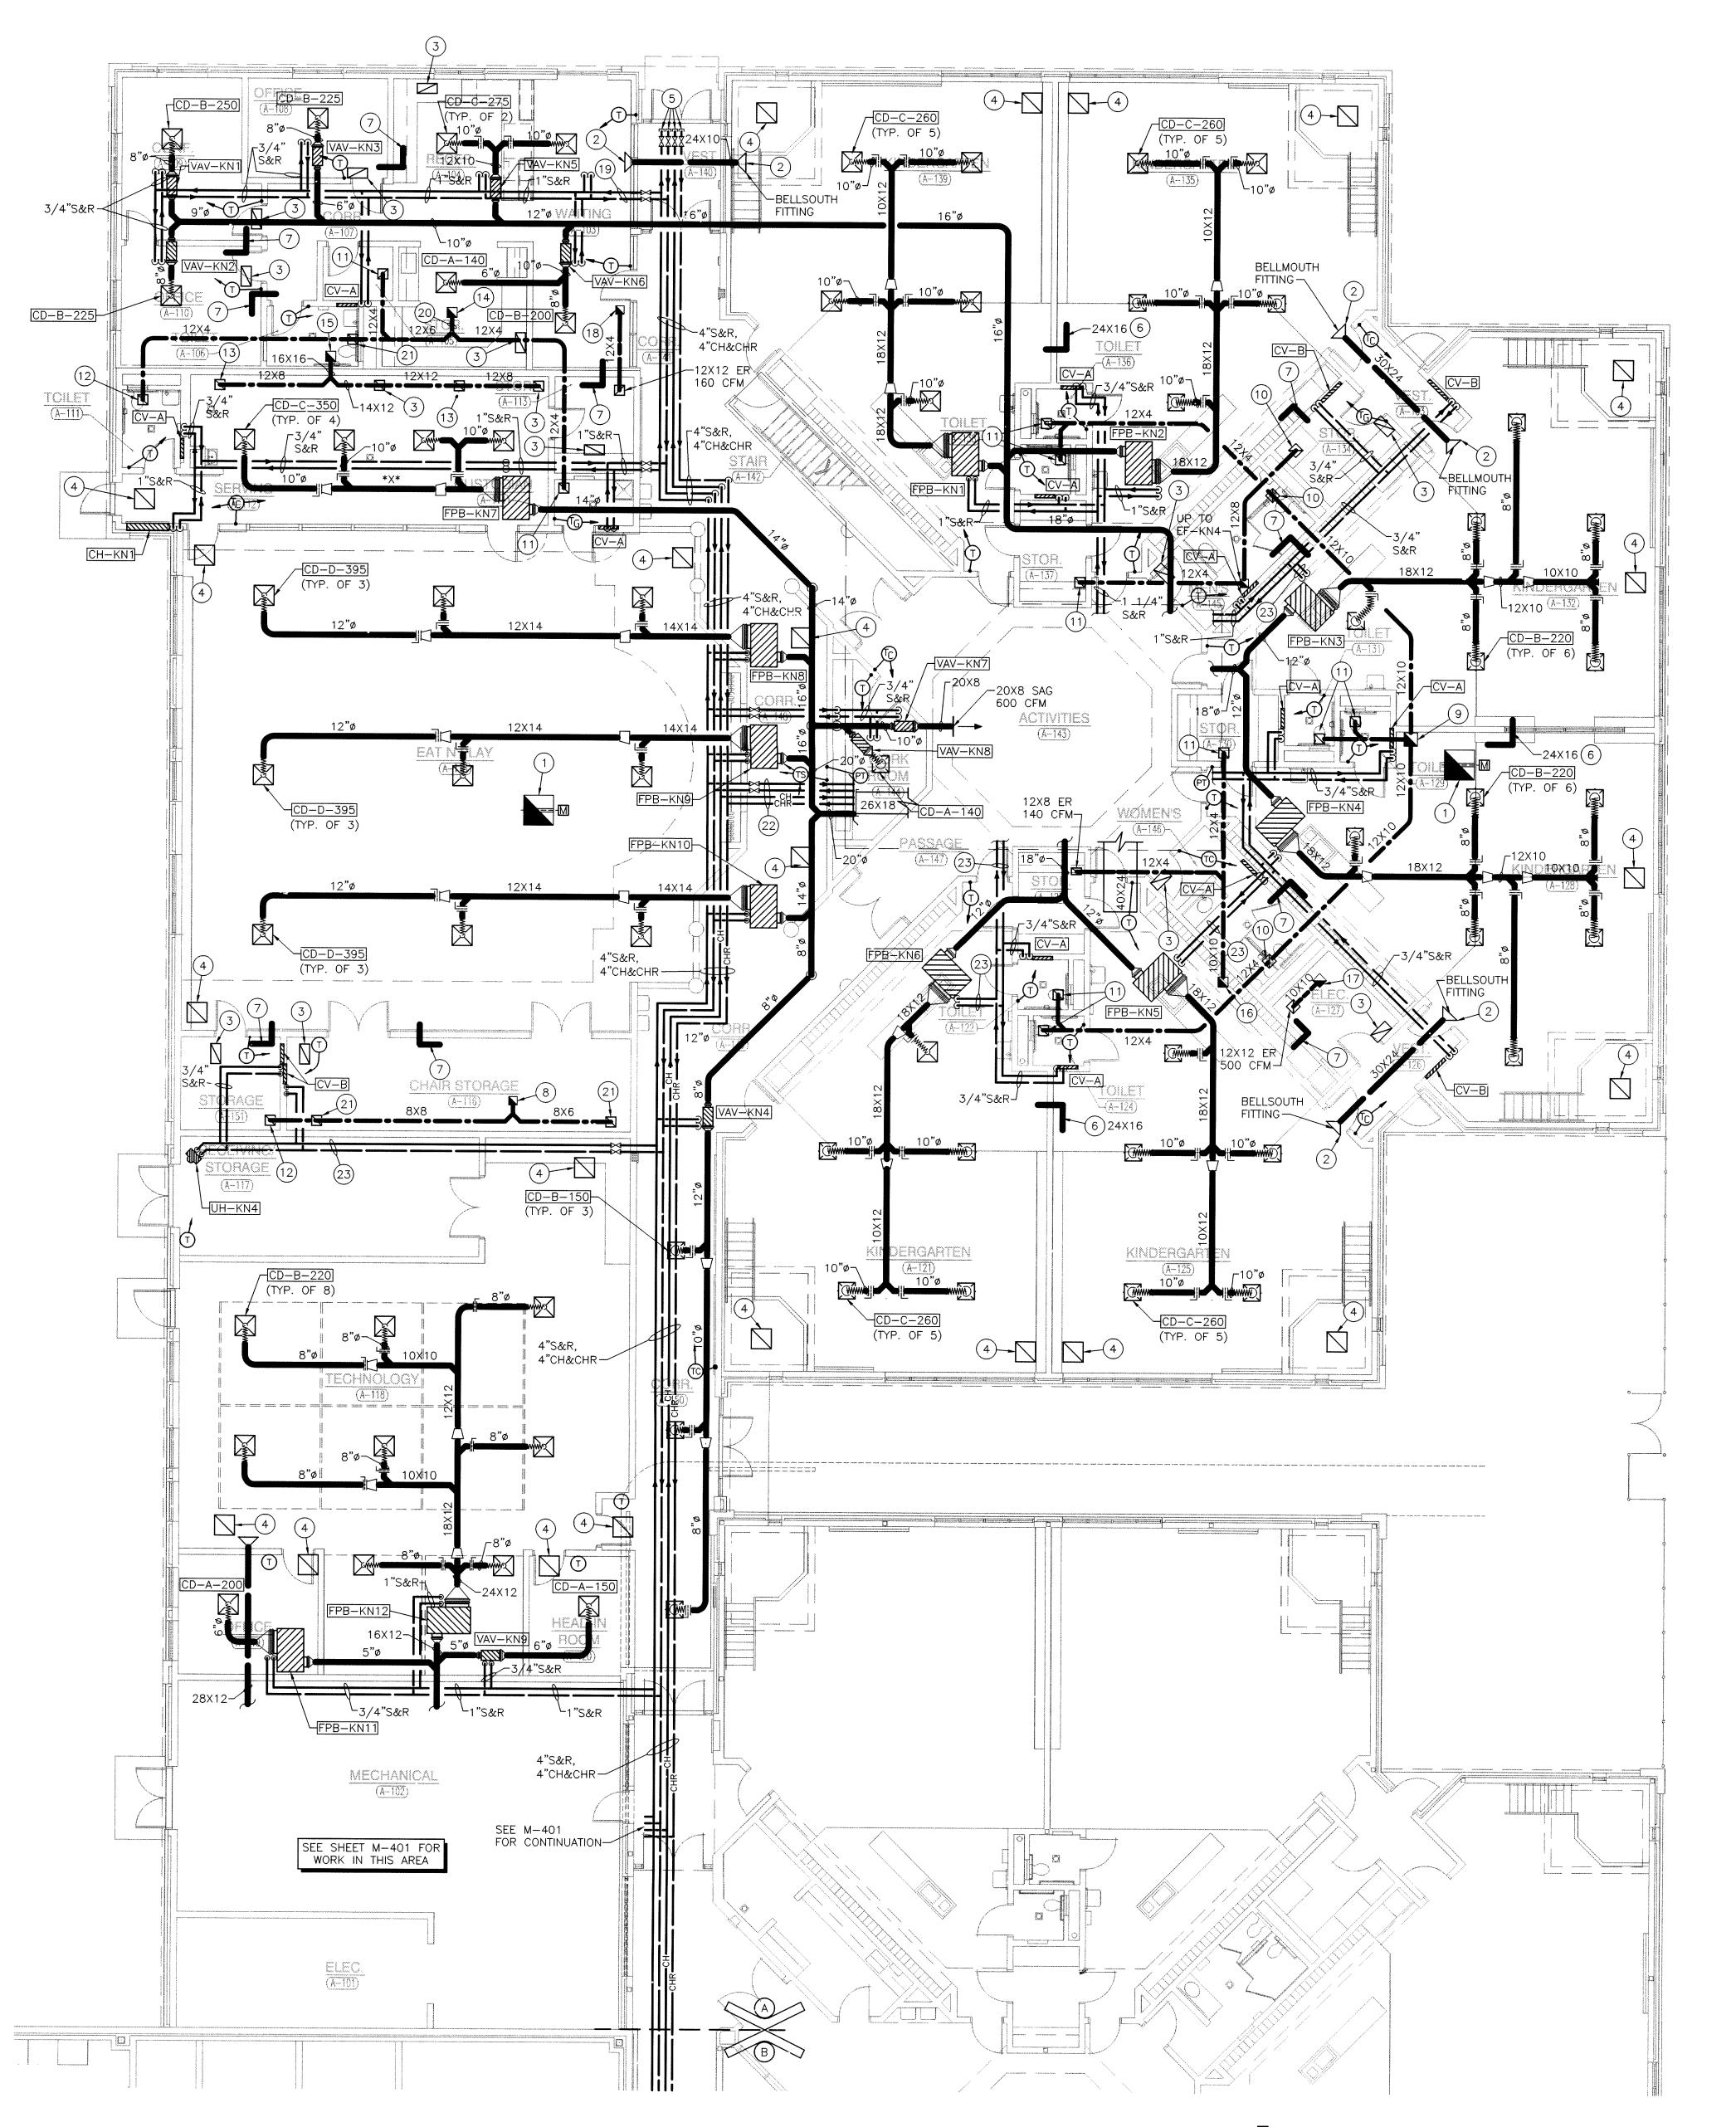
DRAWING
UNIT "A" PLUMBING
FIRST FLOOR AND
SECOND FLOOR PLANS

PROJECT


LAWRENCE CENTRALIZED KINDERGARTEN

NORTH CAMPUS

N P-102



UNIT "A" MECHANICAL FIRST FLOOR PLAN
SCALE: 1/8" = 1'-0"

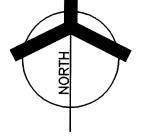

GENERAL NOTES:

- 1. SEE SHEET M-501 FOR MECHANICAL DETAILS.
- SEE SHEET M-601 FOR MECHANICAL LEGEND, GENERAL NOTES AND SCHEDULES.
- SEE SHEET M-801 FOR MECHANICAL TEMPERATURE CONTROL DIAGRAMS.

PLAN NOTES:

- 1 36"X36" DUCT WITH 36"X36" MOTORIZED RELIEF DAMPER UP TO RELIEF VENT ON ROOF. MOTORIZED DAMPER SHALL BE CONTROLLED BY A BUILDING STATIC PRESSURE SENSOR.
- (2) STUB DUCT THRU WALL INTO SPACE ABOVE CEILING.
- 3 24"X12" RETURN AIR GRILLE IN CEILING.
- 4) 24"X24" RETURN AIR GRILLE IN CEILING.
 5) CAPPED 4" SUPPLY AND RETURN, 4" CHILLED WATER AND CHILLED WATER RETURN WITH SHUT-OFF VALVES FOR FUTURE EXPANSION.
- 6 STUB TRANSFER AIR DUCT THRU WALL ABOVE CEILING.

 7 12"X12" TRANSFER AIR DUCT STUBBED THRU WALL ABOVE CEILING.
- (8) 10"X10" UP TO EF-KN9.
- 9 16"X16" UP TO EF-KN5.
- (10) 12"X12" FR 380 CFM.
- (11) 12"X12" ER 75 CFM.
- (12) 12"X12" ER 120 CFM. (13) 12"X12" ER 385 CFM.
- (14) 10"X10" UP TO EF-KN1.
- (15) 16"X16" UP TO EF-KN2.
- (16) 10"X10" UP TO EF-KN6.
- (17) 10"X10" UP TO EF-KN7.
- (18) 10"X10" UP TO EF-KN3.
- 19 1 1/4"S&R.
- 20) 12"X10"
- (21) 12"X12" ER 160 CFM.
- 22) 3"S&R, 4"CH&CHR.
- (23) 1"S&R.

NEW 4"S&R 4"CH&CHR -

PLUMBING FIRST FLOOR PLAN
SCALE: 1/8" = 1'-0"

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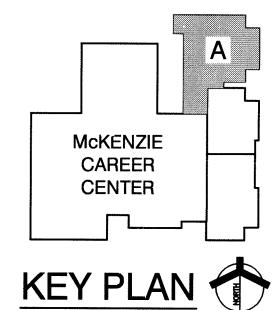
LAWRENCE CENTRALIZED KINDERGARTEN

NORTH & SOUTH CAMPUS ADDITIONS

METROPOLITAN SCHOOL DISTRICT

OF LAWRENCE TOWNSHIP

MARION COUNTY, INDIANA



GIBRALTAR DESIGN

9102 N. Meridian St., Ste. 300
Indianapolis, IN 46260
Homepage www.GibraltarDesign.com
Email info@GibraltarDesign.com
Phone 317.580.5777 Fax 317.580.5778

PROJECT 02-580 DATE

DATE 04/21/03 COORDINATED BY AJP DRAWN BY CSZ

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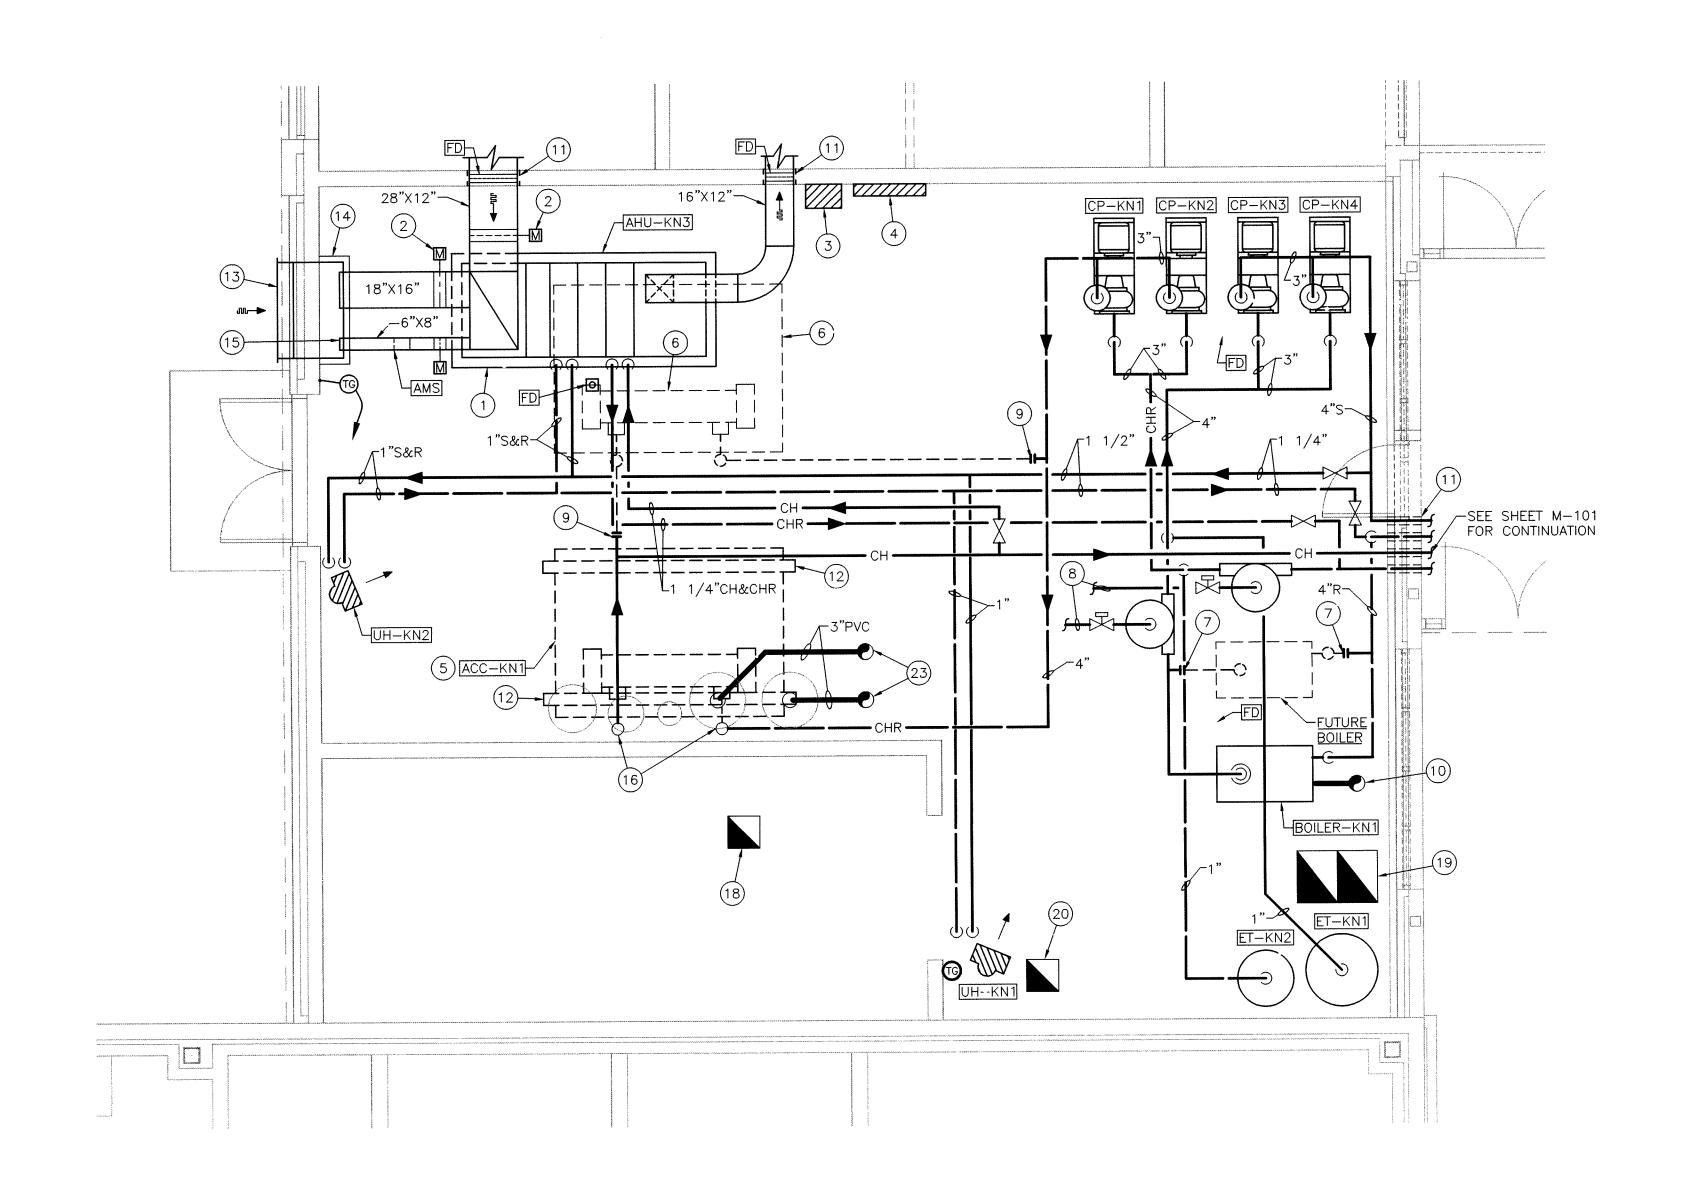
DRAWING
UNIT "A" MECHANICAL
FIRST FLOOR PLAN

PROJECT

LAWRENCE CENTRALIZED KINDERGARTEN
NORTH CAMPUS

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N M-101



- 1. SEE SHEET M-501 FOR MECHANICAL DETAILS.
- SEE SHEET M-601 FOR MECHANICAL LEGEND, GENERAL NOTES AND SCHEDULES.
- SEE SHEET M-801 FOR MECHANICAL TEMPERATURE CONTROL DIAGRAMS.


PLAN NOTES:


- 1) INSTALL EQUIPMENT ON A 4" HIGH CONCRETE PAD.
- 2 OUTDOOR AIR AND RETURN AIR MOTORIZED DAMPERS BY TCC.
- (3) VARIABLE FREQUENCY DRIVE.
- 4 TEMPERATURE CONTROL PANEL.
- 5) AIR COOLED CHILLER #A1 ON ROOF.
- 6 FUTURE CHILLER TO BE LOCATED ON ROOF.
- 7 PROVIDE A 4" BLIND FLANGE IN THE SUPPLY AND RETURN PIPING TO RECEIVE A FUTURE BOILER.
- (8) 1"CW MAKE-UP TO HEATING AND COOLING SYSTEM.
- 9 PROVIDE A 4" BLIND FLANGE IN CH & CHR PIPING TO RECEIVE A FUTURE CHILLER.
- 10) 10"¢ BOILER VENT UP, TERMINATE IN RAIN CAP 48" ABOVE ROOF.
- (11) PROVIDE PIPE SLEEVES THRU WALL.
- 12) PROVIDE AND INSTALL 12" HIGH PATE EQUIPMENT RAILS.
 (13) 48" WIDE X 32" HIGH OUTDOOR AIR INTAKE LOUVER BY G.C.
- (14) 48"X32"X12" DOUBLE WALL, 2" INSULATED PLENUM AROUND LOUVER.
- (15) STUB OUTDOOR AIR DUCTS INTO PLENUM AT THIS POINT.
- (16) 4"CH&CHR PIPING UP THRU ROOF TO ACC—KN1 ON ROOF.

 (17) ALL PIPING ABOVE ROOF SHALL BE INSULATED AND JACKETED WITH PROOF JACKET.
- (18) 16"X16" WITH EXHAUST GRILLE UP TO EF-KN10 ON ROOF.

 (19) (2) 20"X26" COMBUSTION AIR DUCTS UP TO OUTSIDE AIR INTAKE WITH MOTORIZED DAMPER ON ROOF. TERMINATE BACK DUCT AT 12" AFF AND FRONT DUCT AT 12" BELOW
- 20 16"X16" DUCT UP TO OUTSIDE AIR INTAKE ON ROOF.
- 21) CONNECT NEW 4" S&R TO EXISTING 4" S&R AS SHOWN ON DRAWING M-501.
- (22) CONNECT NEW 4" CH&CHR TO EXISTING 4" CH&CHR AS SHOWN ON DRAWING M-501.
- 3"ø PVC WATER HEATER VENT UP, TERMINATE 48" ABOVE ROOF IN A GOOSENECK.




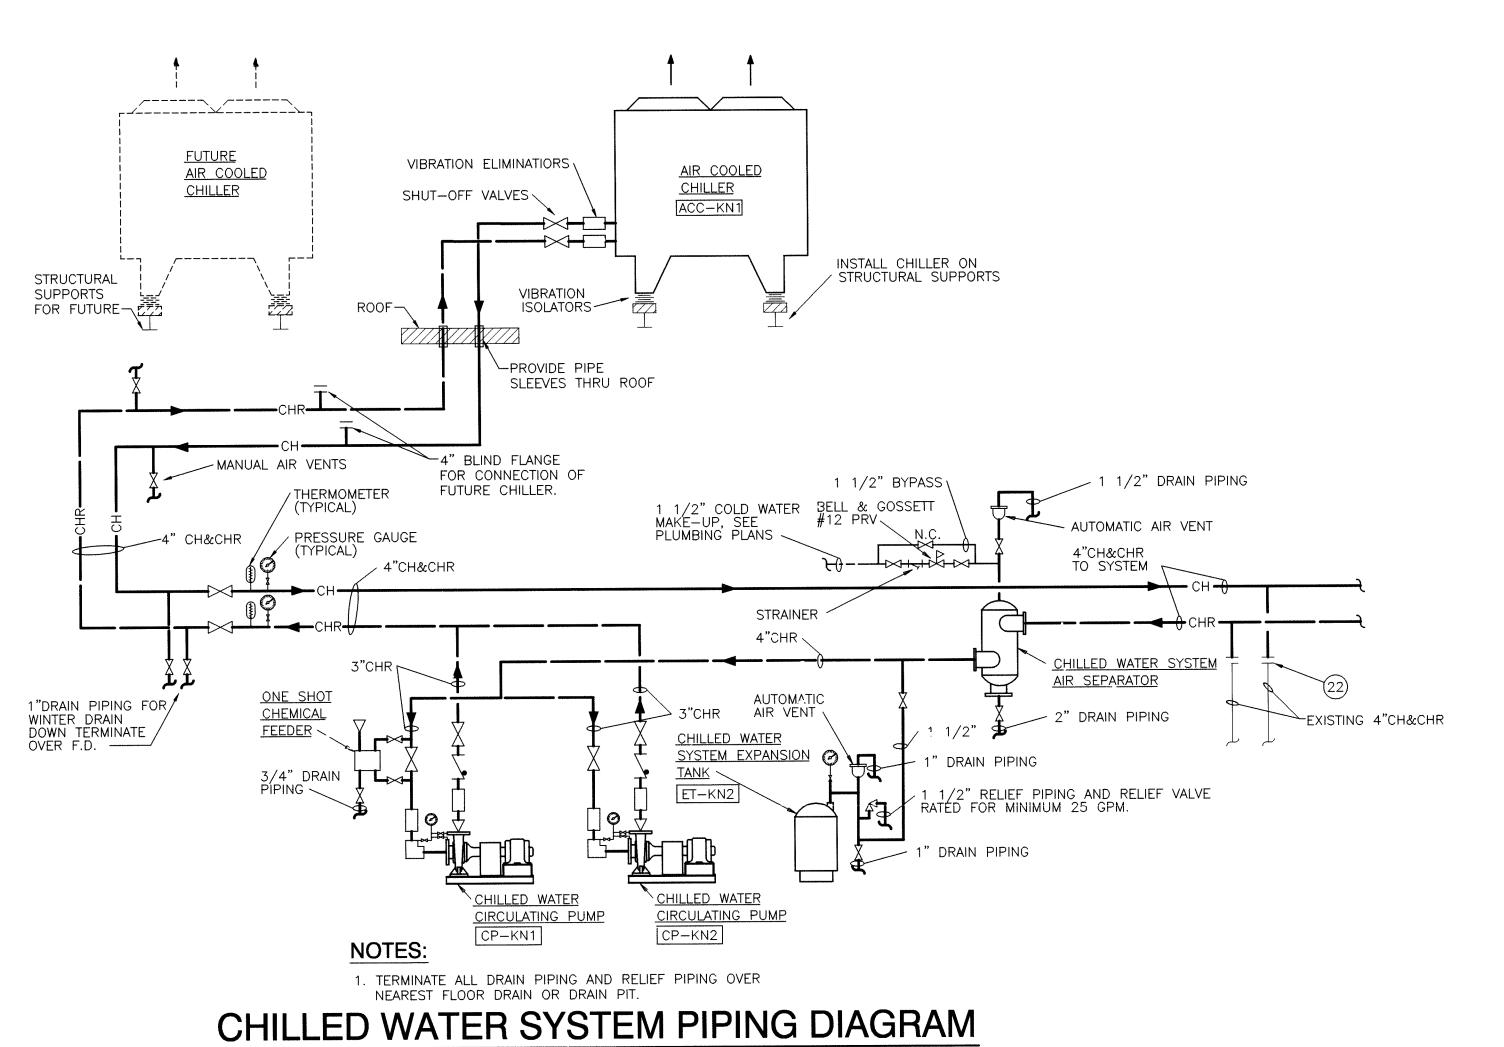

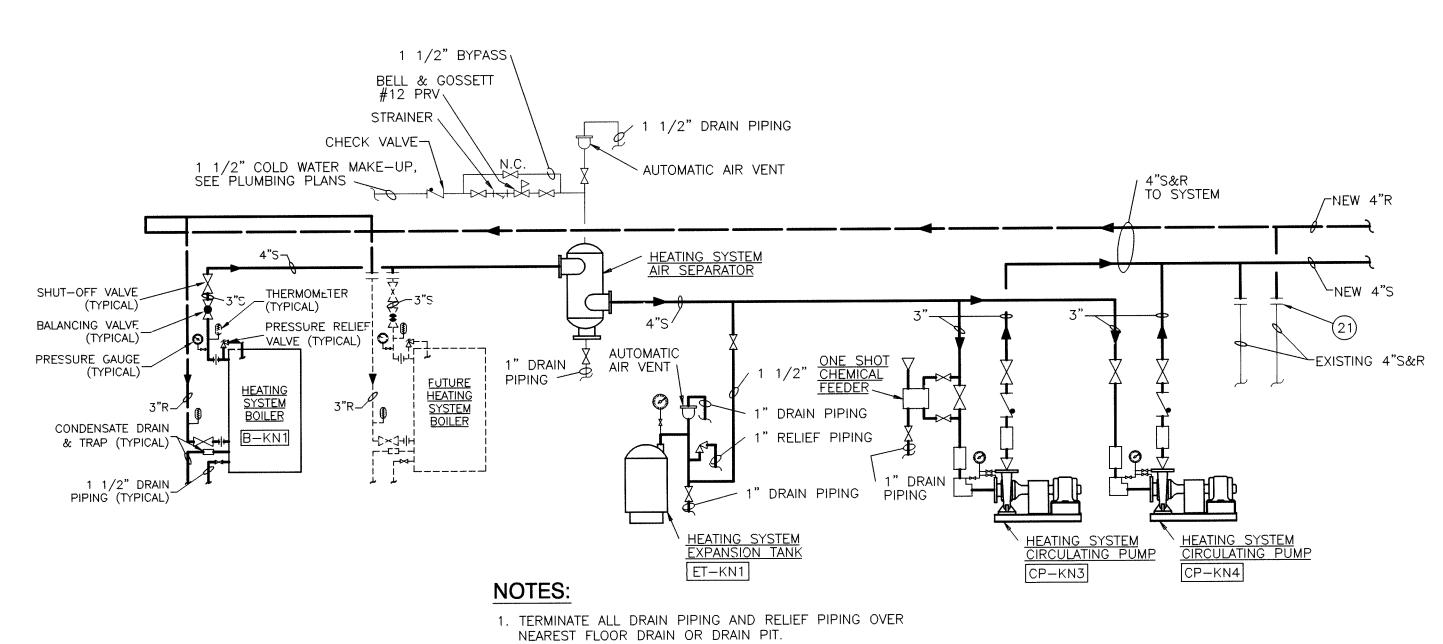

HEATING WATER SYSTEM PIPING DIAGRAM

NOT TO SCALE

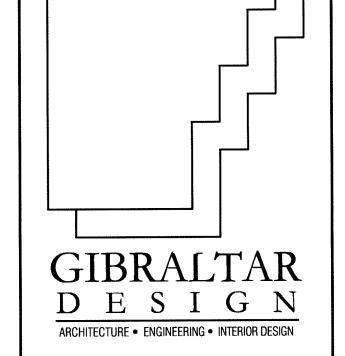

PROJECT


LAWRENCE CENTRALIZED KINDERGARTEN

NORTH & SOUTH CAMPUS ADDITIONS

METROPOLITAN SCHOOL DISTRICT

MARION COUNTY, INDIANA

OF LAWRENCE TOWNSHIP

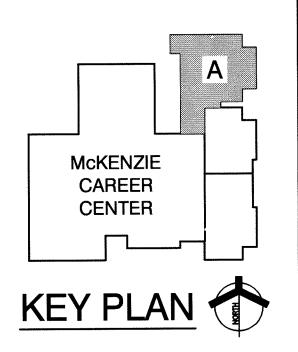

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9102 N. Meridian St., Ste. 300
Indianapolis, IN 46260
Homepage www.GibraltarDesign.com

Email info@GibraltarDesign.com
Phone 317.580.5777 Fax 317.580.5778

PROJECT
02-580

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COORDINATED BY
AJP

DRAWN BY
CSZ

CHECKED BY
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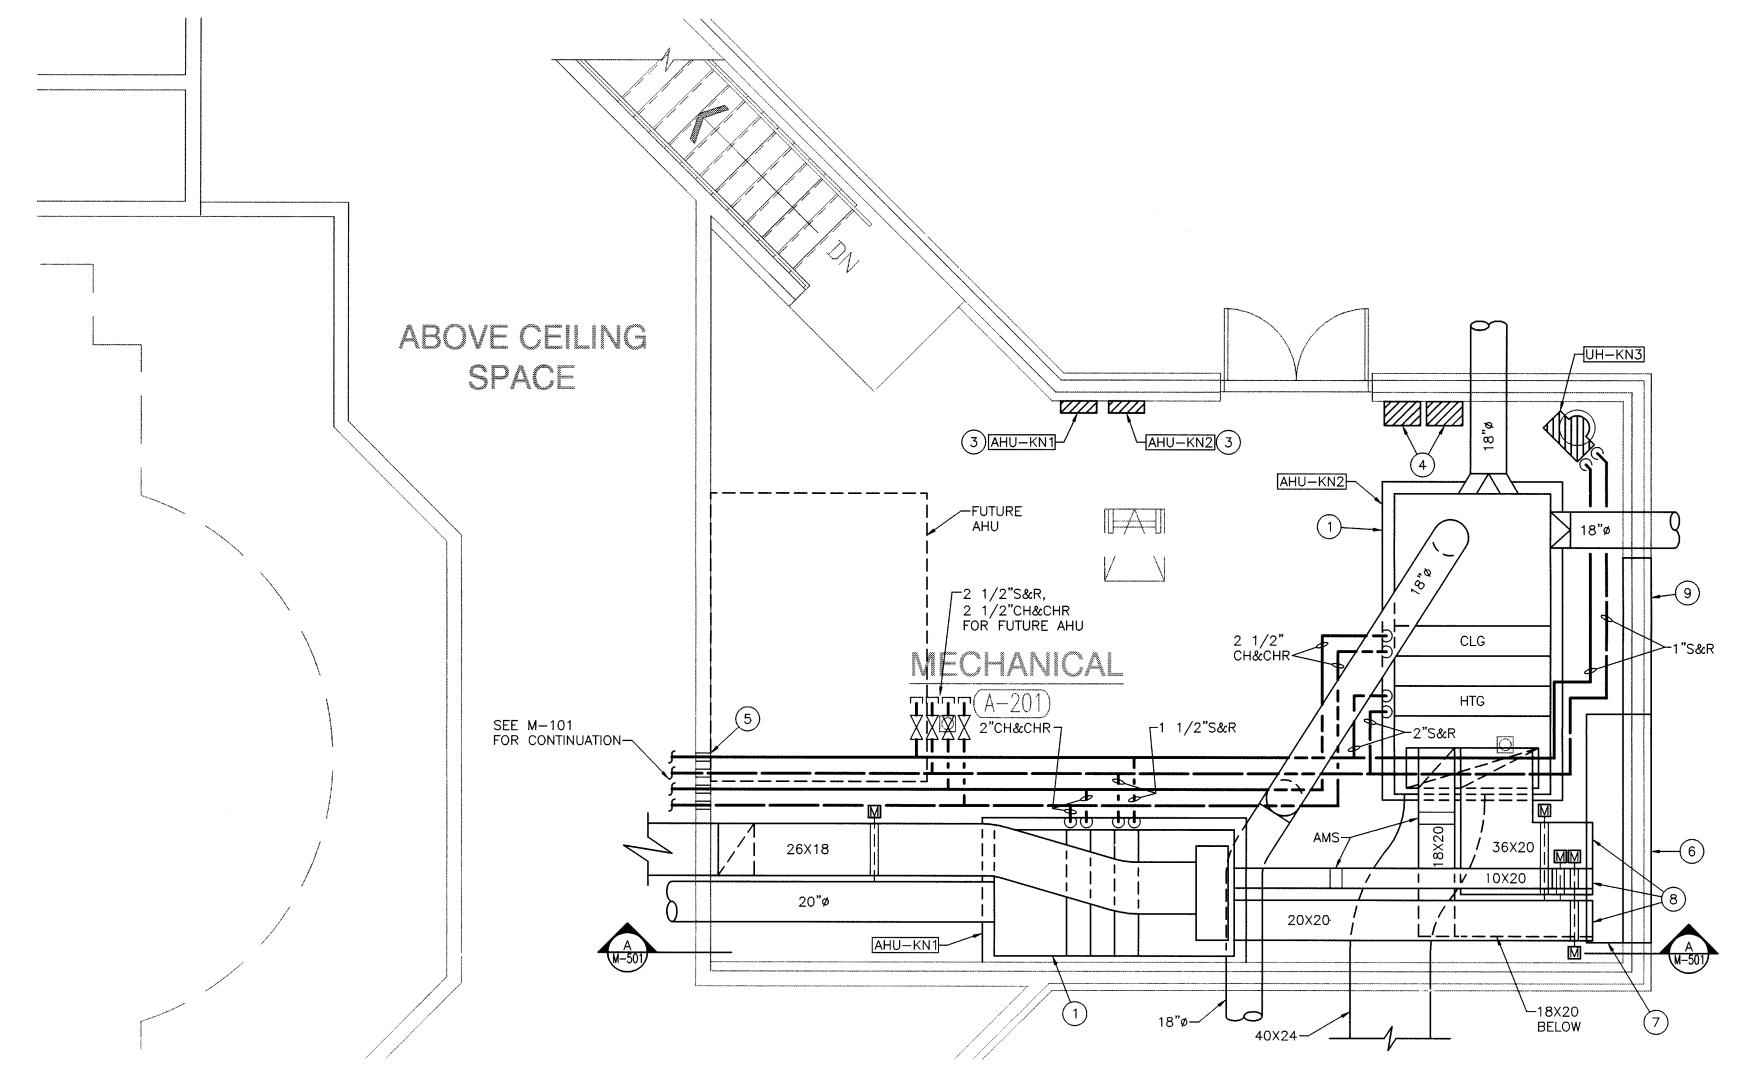
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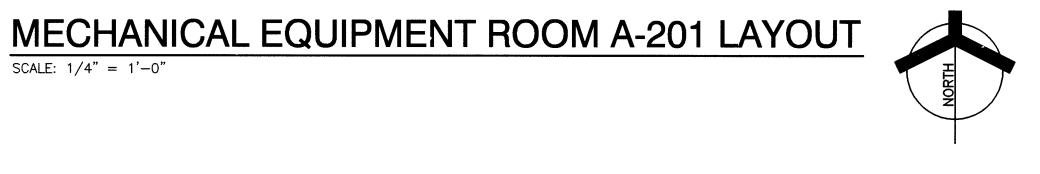
DRAWING
MECHANICAL
BOILER ROOM A-102 PLAN
AND PIPING DIAGRAMS


PROJECT
LAWRENCE CENTRALIZED KINDERGARTEN
NORTH CAMPUS

SHEET SHEET M-40

M-401





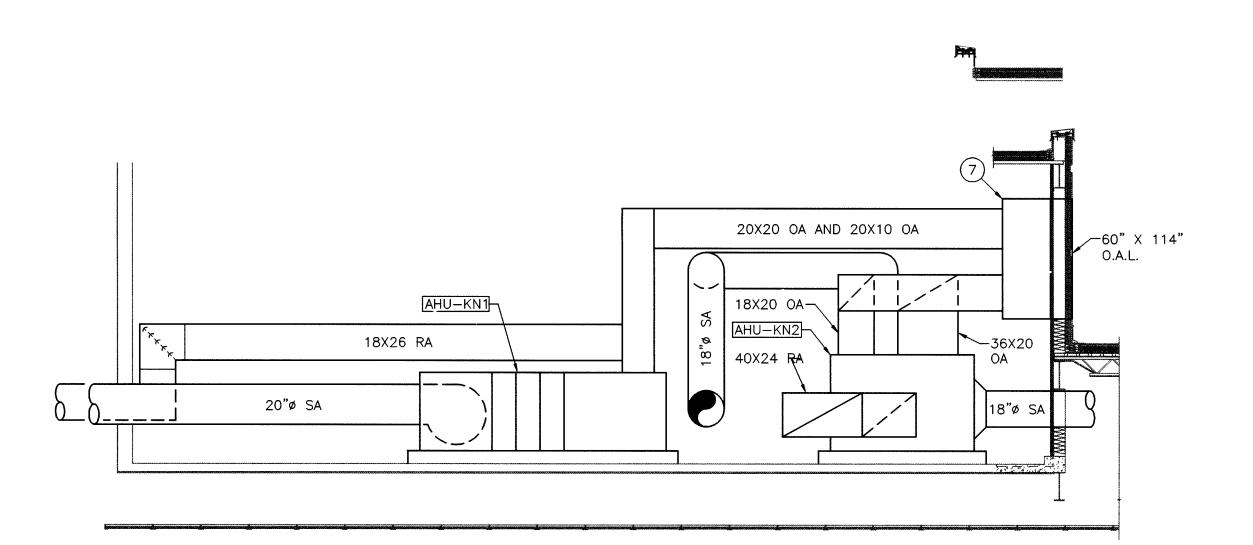

SCALE: 1/4" = 1'-0"


MECHANICAL EQUIPMENT ROOM A-201 SECTION (A) M-501

GENERAL NOTES:

- 1. SEE SHEET M-501 FOR MECHANICAL DETAILS.
- SEE SHEET M-601 FOR MECHANICAL LEGEND, GENERAL NOTES AND SCHEDULES.
- SEE SHEET M-801 FOR MECHANICAL TEMPERATURE CONTROL DIAGRAMS.

PLAN NOTES:

- (1) INSTALL EQUIPMENT ON A 4" HIGH CONCRETE PAD.
- 2 OUTDOOR AIR AND RETURN AIR MOTORIZED DAMPERS BY
- 3 VARIABLE FREQUENCY DRIVE.
- (4) TEMPERATURE CONTROL PANEL.
- (5) PROVIDE PIPE SLEEVES THRU WALL.
- 6 9'-6" WIDE X 5'-0"" HIGH OUTDOOR AIR INTAKE LOUVER BY G.C.
- 7 9'-6"X5'-0"X2 1/4" DOUBLE WALL, 2" INSULATED PLENUM AROUND LOUVER.
- (8) STUB OUTDOOR AIR DUCTS INTO PLENUM AT THIS POINT.
- 9 6'-6" WIDE X 5'-0" HIGH OUTDOOR AIR INTAKE LOUVER FOR FUTURE AHU BY G.C. INSTALL SHEETMETAL BLANK OFF TO BE REMOVED WHEN FUTURE AHU IS INSTALLED.
- (10) CONNECT NEW 4"S&R AND 4"CH&CHR LINES INTO EXISTING 4"S&R AND 4"CH&CHR LINES IN THIS AREA. INSTALL MANUAL NORMALLY CLOSED SHUTOFF VALVES.

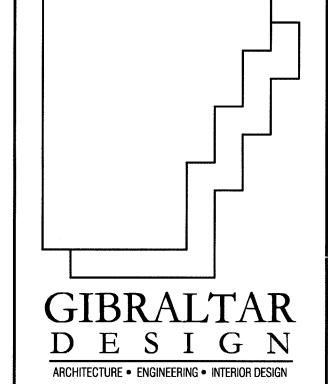


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NORTH & SOUTH CAMPUS ADDITIONS

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DRAWING
MECHANICAL EQUIPMENT ROOM A-201 LAYOUT AND DETAILS

LAWRENCE CENTRALIZED KINDERGARTEN NORTH CAMPUS

	LEGEND	
NAME	SYMBOL	ABBREVIATION
HEATING SYSTEM WATER SUPPLY		S
HEATING SYSTEM WATER RETURN		R
CHILLED WATER SUPPLY	CH-	CH
CHILLED WATER RETURN	— ← CHR ← ←	CHR
CONDENSATE DRAIN	D	D
RELIEF VENT		V
REFRIGERANT LIQUID PIPING		RL
REFRIGERANT GAS SUCTION PIPING	→ RS →	RS
REFRIGERANT GAS DISCHARGE PIPING	RG───	RG
SHUT-OFF VALVE		
TRIPLE DUTY VALVE		
CHECK VALVE		
TEMPERATURE REGULATING VALVE	→	
BALANCING VALVE		
PRESSURE RELIEF VALVE	P	
PRESSURE REGULATING VALVE		
UNION		
PIPE ANCHOR	*************************************	
PIPE GUIDE		
PIPING DROP WITH RESPECT TO FLOW		
PIPING RISE WITH RESPECT TO FLOW	C	
PIPE TEE OUT OF TOP		
PIPE TEE OUT OF BOTTOM		
PRESSURE GAUGE	0	
THERMOMETER		
STRAINER	Ψ	
AUTOMATIC AIR VENT	7	
THERMOSTAT	(I) (I) (I) (I)	C=CONCEALED, G=GUARD, N=NIG
FLEXIBLE DUCT		
(SINGLE LINE) SUPPLY SHEET METAL DUCT		
(SINGLE LINE) RETURN SHEET METAL DUCT		
(SINGLE LINE) EXHAUST DUCT		
(SINGLE LINE) DUCT TRANSITION—SYMMETRIC REDUCTION		
(SINGLE LINE) DUCT DROP WITH RESPECT TO FLOW		
SINGLE LINE) DUCT RISE WITH RESPECT TO FLOW	R	
DUCT SIZE (1ST FIGURE=WIDTH, 2ND FIGURE=DEPTH)	12X10	
ROUND DUCT SIZE	0R 12X10	
ROUND DUCT SIZE	OR 12"ø	
FLAT—OVAL DUCT SIZE		
SUPPLY DUCT SECTION	24X12↔	
EXHAUST OR RETURN AIR DUCT SECTION		
SUPPLY RISER		
EXHAUST RISER		
RELIEF OR RETURN DECK OPENING		
MANUAL VOLUME DAMPER		VD
TRE DAMPER		FD
BACKDRAFT DAMPER		BDD
MOTORIZED DAMPER		MD
SMOKE DAMPER		SD
COMBINATION FIRE/SMOKE DAMPER		[FSD]
SMOKE DETECTOR		<u> </u>
XHAUST GRILLE OR REGISTER		ER,EG
RELIEF GRILLE		RG
RETURN AIR REGISTER OR GRILLE		RAR,RAG
SUPPLY AIR REGISTER OR GRILLE		
CEILING DIFFUSER, TYPE & CFM	†·	SAR,SAG
INEAR DIFFUSER, TYPE & CFM		CD-A-
		LD-A-
XHAUST FAN & SCHEDULE DESIGNATION		EF-
ROOF EXHAUST FAN	\	
ABINET HEATER & SCHEDULE DESIGNATION	<i>VIIIIIII</i>	CH-
CONVECTOR & SCHEDULE DESIGNATION	77777	CV-
INIT HEATER & SCHEDULE DESIGNATION		UH-
IR HANDLING UNIT & SCHEDULE DESIGNATION		AHU-
IRCULATING PUMP & SCHEDULE DESIGNATION		CP-
ARIABLE AIR VOLUME BOX & SCHEDULE DESIGNATION	***************************************	[VAV]
AN POWERED VAV BOX & SCHEDULE DESIGNATION		FPB-
IR FLOW MEASUREMENT STATION	AMS	
/ATER FLOW CONTROL REGULATOR	<u>[VINIO]</u>	
	T :	D /T
RESSURE/TEMPERATURE TEST PORT	[VED]	P/T
RESSURE/TEMPERATURE TEST PORT	VFD	
ARIABLE FREQUENCY DRIVE		
ARIABLE FREQUENCY DRIVE PACE PRESSURE SENSOR	<u></u>	
ARIABLE FREQUENCY DRIVE PACE PRESSURE SENSOR RESSURE TRANSMITTER	<u></u>	
ARIABLE FREQUENCY DRIVE PACE PRESSURE SENSOR RESSURE TRANSMITTER ENTILATING CONTRACTOR		VC
ARIABLE FREQUENCY DRIVE PACE PRESSURE SENSOR RESSURE TRANSMITTER ENTILATING CONTRACTOR ECHANICAL CONTRACTOR		VC MC
ARIABLE FREQUENCY DRIVE PACE PRESSURE SENSOR RESSURE TRANSMITTER ENTILATING CONTRACTOR ECHANICAL CONTRACTOR LECTRICAL CONTRACTOR		
ARIABLE FREQUENCY DRIVE PACE PRESSURE SENSOR RESSURE TRANSMITTER ENTILATING CONTRACTOR ECHANICAL CONTRACTOR		MC

(NOT ALL SYMBOLS AND ABBREVIATIONS MAY APPLY FOR THIS PROJECT)

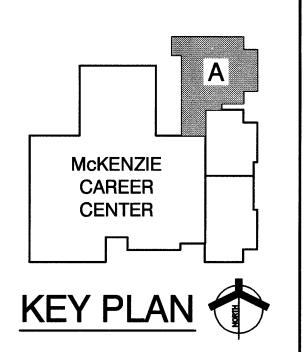GENERAL HVAC NOTES

EXISTING TO BE REMOVED OR RELOCATED.

(APPLY TO ALL HVAC SHEETS)

COORDINATE ALL WORK.

- 1. MECHANICAL CONTRACTOR IS RESPONSIBLE FOR ALL NEW WORK SHOWN ON THESE SHEETS UNLESS OTHERWISE NOTED.
- 2. CONTRACTOR SHALL FIELD VERIFY ALL EXISTING CONDITIONS PRIOR TO BID AND MODIFY WORK AS REQUIRED FOR ANY VARIATIONS OR DEVIATIONS FROM THOSE SHOWN ON THESE SHEETS.
- 3. ALL WALLS, LIGHTS, EQUIPMENT, DUCTWORK, PIPING, ETC. SHOWN WITH THIN DOTTED LINES IS EXISTING TO REMAIN CONDITIONS AND SHOULD BE USED FOR REFERENCE ONLY, AND MAY INDICATE NONEXISTENT OR INACCURATE CONDITIONS. 4. ALL EQUIPMENT, DUCTWORK AND PIPING SHOWN WITH THICK DASHED LINES IS
- 5. ALL EQUIPMENT, DUCTWORK AND PIPING SHOWN WITH THICK SOLID LINES IS NEW
- 6. ALL BULKHEADS, CANOPIES AND ROOF OVERHANGS SHOWN WITH THIN DOTTED/DASHED LINES AND IS NOT OTHERWISE NOTED, INDICATE LOCATION PROVIDED BY OTHER CONTRACTORS.
- 7. REFER TO ARCHITECTURAL, STRUCTURAL, PLUMBING AND ELECTRICAL SHEETS AND
- 8. REFER TO ARCHITECTURAL REFLECTED CEILING PLANS FOR LOCATION OF CEILING DIFFUSERS, RETURN GRILLES, EXHAUST GRILLES, ETC. WITH RESPECT TO CEILING TYPE, CEILING GRID AND LIGHTING FIXTURES.
- 9. ALL PIPING IN PIPE SPACES AND TUNNELS SHALL BE PLACED AS CLOSE TO WALLS AS POSSIBLE TO ALLOW MAXIMUM ACCESS.
- 10. ALL DUCTWORK AND PIPING ABOVE CEILING SHALL BE PLACED TO AVOID LIGHTING FIXTURES, JOISTS, BEAMS, ETC.
- 11. PROVIDE A MANUAL BALANCING DAMPER IN EACH ZONE DUCTWORK OF ALL

MULTIZONE AIR HANDLING UNITS AS CLOSE TO UNITS AS POSSIBLE.

- 12. PROVIDE CEILING ACCESS PANELS FOR ACCESS TO VOLUME DAMPERS, FIRE AND SMOKE DAMPERS, SHUT-OFF VALVES, CONTROL VALVES, DRAIN VALVES, EQUIPMENT, ETC. LOCATED ABOVE NON-ACCESSIBLE CEILINGS (INCLUDES ALL EXISTING ITEMS REQUIRING ACCESS WHERE NEW NON-ACCESSIBLE CEILINGS OCCUR). COORDINATE ALL ACCESS PANELS WITH THE ARCHITECT.
- 13. CONTRACTOR SHALL CORE DRILL HOLES THROUGH FLOORS, WALLS, DECKS, ETC. WHERE PASSAGE IS NOT AVAILABLE TO INSTALL NEW PIPING. PROVIDE PIPE SLEEVES AND PROPERLY SEAL ALL PIPE PENETRATIONS AS REQUIRED. REFER TO SPECIFICATIONS.
- 14. ARROWS ON ALL DOMESTIC, HEATING AND CHILLED WATER, GAS, COMPRESSED AIR, ETC. PIPING MAINS INDICATE DIRECTION OF FLOW. PITCH PIPING MAINS UP A MINIMUM OF 1" PER 50'-0" IN DIRECTION OF SUPPLY WATER FLOW.
- 15. ALL FAN COIL UNIT CONDENSATE DRAINS ABOVE GRADE SHALL BE TYPE "L" HARD COPPER TUBING AND SHALL BE SIZED AS FOLLOWS: 1" DRAIN FOR ONE COIL, 1 1/4" DRAIN FOR TWO COILS, 1 1/2" DRAIN FOR THREE COILS, 2" DRAIN FOR FOUR OR MORE COILS. ALL BELOW GRADE DRAINS SHALL BE 2" EXTRA HEAVY CAST IRON SOIL PIPE AND SHALL SLOPE 1/8" PER 1"-0" UNLESS OTHERWISE NOTED.
- 16. ALL AUTOMATIC TEMPERATURE REGULATING VALVES SHALL BE SIZED FOR 5 PSI MAXIMUM WATER PRESSURE DROP.
- 17. VALVE ALL HEATING AND CHILLED WATER BRANCHES IN FAN AND MECHANICAL ROOMS. CONTRACTOR SHALL ALSO PROVIDE AND INSTALL VALVES IN ALL PIPING AS REQUIRED TO FACILITATE OPERATION OF VARIOUS SYSTEMS DURING
- 18. HEATING AND CHILLED WATER BRANCHES TO CONVECTORS AND FAN COIL UNITS SHALL BE 3/4" FOR UNITS UNDER 3 GPM AND 1" FOR UNITS OVER 3 GPM. 1" SIZE TO ALL FINNED TUBE, CABINET HEATERS, UNIT HEATERS AND VAV RE-HEAT COILS UNLESS OTHERWISE NOTED.
- 19. ALL THERMOSTATS SHALL BE APPROXIMATELY 4'-6" ABOVE FINISHED FLOOR AND LINED UP VERTICALLY WITH LIGHT SWITCHES UNLESS OTHERWISE NOTED OR DIRECTED BY ARCHITECT.
- 20. ALL THERMOSTATS IN BOILER AND MECHANICAL ROOMS SHALL BE SET AT 50 DEGREES FAHRENHEIT.
- 21. PAINT ALL AREAS ABOVE CEILING THAT ARE VISIBLE THROUGH CEILING RETURN AIR GRILLES A FLAT BLACK.

	CONVECTOR SCHEDULE										
CV NO.	AREA SERVED	TRANE MODEL NUMBER	МВН	LENGTH	HEIGHT	DEPTH	WATER RATE GPM	WALL RECESS DEPTH	SEE NOTE		
Α	SEE DRAWINGS	RG4SOL	2.5	26"	24"	4"	0.5	3 9/16"	1		
В	SEE DRAWINGS	RG4SOL	3.1	32"	24"	4"	0.5	3 9/16"	1		

. HEATING CAPACITIES ARE BASED ON 65 °F ENTERING AIR. 180 °F ENTERING WATER AND 40 °F WATER TEMPERATURE DROP.

CABINET HEATER SCHEDULE											
CH NO.	ROOM SERVED	TRANE MODEL NUMBER	TYPE AND ARRANGEMENT	WRH	FAN SPEED RPM	WATER RATE GPM	MOTOR HP	CFM	WALL RECESS DEPTH	SEE NOTE	
KN1	A-112	FFHB 040	VERTICAL RECESSED	26.6	700	2.0	1/30	400	8 1/2"	1,2,3	
KS1	A-101	FFEB 040	HORIZONTAL RECESSED	26.6	700	2.0	1/30	400	_	1,2	
KS2	A-101	FFEB 040	HORIZONTAL RECESSED	26.6	700	2.0	1/30	400	_	1,2	
KS3	A-103	FFEB 040	HORIZONTAL RECESSED	26.6	700	2.0	1/30	400	_	1,2	
KS4	A-103	FFEB 040	HORIZONTAL RECESSED	26.6	700	2.0	1/30	400	_	1,2	

- . HEATING CAPACITIES ARE BASED ON 65 °F ENTERING AIR 180°F ENTERING WATER AND 40 °F WATER TEMPERATURE DROP AT LOW SPEED OPERATION, FINAL AIR TEMPERATURE SHALL BE 110 °F TO 140 °F.
- 2. MOTOR SHALL BE MULTI-SPEED 115 VOLT, 1 PHASE, 60 HERTZ.
- 3. PROVIDE ACCESSIBLE HOSE BIBB IN CABINET FOR SYSTEM DRAIN.

		AIR HA	NDL	ING (JNIT S	CHED	ULE		
AHU NO.	AREA SERVED	TYPE AND ARRANGEMENT	TRANE MODEL NUMBER	CFM	MAXIMUM FAN OUTLET VELOCITY FPM	MINIMUM EXTERNAL STATIC PRESSURE " W.C.	MINIMUM FAN MOTOR HP	MINIMUM CFM OF OUTDOOR AIR	SEE NOTE
AHU-KN1	KITCHEN & EAT & PLAY	DRAW-THROUGH VARIABLE AIR VOLUME	MCCB-10	4,110	1780	2.0	7.5	1125	1,2
AHU-KN2	CLASSROOMS & ADMINISTRATION	DRAW-THROUGH VARIABLE AIR VOLUME	MCCB-21	9,200	1820	2.0	15	2790	1,2,3
AHU-KN3	TECHNOLOGY	DRAW-THROUGH VARIABLE AIR VOLUME	MCCB-06	2,130	1510	1.5	3	150	1,2
	IZITCHIENI 9.	DDAW TUDOUGU							
AHU-KS1	KITCHEN & EAT & PLAY	DRAW-THROUGH VARIABLE AIR VOLUME	MCCB-12	5,200	1865	2.0	7.5	1125	1,2

NOTES:

- I. ALL EQUIPMENT SHALL BE SELECTED IN STRICT ACCORDANCE WITH THE MAXIMUM AND MINIMUM QUANTITIES SHOWN.
- 2. MOTOR DATA: 460 VOLTS, 3 PHASES, 60 HERTZ.
- 3. PROVIDE PLUG FAN.

AHU	I CHM I	TOTAL LOAD	1	RING IR	1	VING IR	WA	TER	MAXIMUM FACE	AIR PRESSURE	MINIMUM NUMBER	SEE
NO.	OI W	MBH	DRY BULB °F	WET BULB °F	DRY BULB °F	WET BULB °F	MAXIMUM GPM	MAXIMUM PRESSURE DROP (FT.)	VELOCITY FPM	DROP " W.C.	OF ROWS	NOTE
KN1	4,110	150	79.9	66.2	55	54.2	25.0	2.85	430	.50	6	1,2
KN2	9,200	370	79.9	66.2	55	54.2	61.0	5.75	445	.50	6	1,2
KN3	2,130	72	79.2	65.9	55	54.8	12.0	.75	365	.45	6	1,2
KS1	5,200	185	79.9	66.2	55	54.2	32.0	3.0	425	.45	6	1,2

NOTES:

- 1. ALL EQUIPMENT SHALL BE SELECTED IN STRICT ACCORDANCE WITH MAXIMUM AND MINIMUM QUANTITIES SHOWN.
- 2. COOLING CAPACITIES ARE BASED ON 42°F ENTERING WATER AND 12 °F WATER TEMPERATURE RISE.

AIR HANDLING UNIT HEATING COIL SCHEDULE (HW)													
AHU NO.	CFM	TOTAL LOAD MBH	EAT °F	LAT °F	MAXIMUM GPM	MAXIMUM PRESSURE DROP (FT.)	MAXIMUM FACE VELOCITY FPM	AIR PRESSURE DROP " W.C.	MINIMUM NUMBER OF ROWS	SEE NOTE			
KN1	4,110	221	50.5	100	11.0	.40	430	.15	2	1,2,3,4			
KN2	9,200	540	50.5	100	27.0	.60	445	.15	2	1,2,5,4			
KN3	2,130	83	50.5	100	4.2	.10	365	.10	2	1,2,3,4			
KS1	5,200	270	50.5	100	14.0	.30	425	.12	2	1,2,3,4			

NOTES:


- . ALL EQUIPMENT SHOWN SHALL BE SELECTED IN STRICT ACCORDANCE WITH THE MAXIMUM AND MINIMUM QUANTITIES SHOWN.
- 2. CAPACITIES ARE BASED ON -10 °F OUTDOOR AIR. 180 °F ENTERING WATER. AND 40 °F WATER TEMPERATURE DROP.
- 3. MINIMUM WATER VELOCITY: 2.5 FPS.
- 4. PRE-HEAT COIL WITH CIRCULATING PUMP.

CEILING DIFFUSER SCHEDULE											
CD TYPE	KRUEGER MODEL NUMBER	NECK SłZE	PATTERN	PANEL SIZE	SEE NOTE						
Α	SERIES 1400	6"ø	4-WAY	24"x24"	1,2,3,4						
В	SERIES 1400	8"ø	4-WAY	24"×24"	1,2,3,4						
С	SERIES 1400	10"ø	4-WAY	24"×24"	1,2,3,4						
D	SERIES 1400	12"ø	4-WAY	24"×24"	1,2,3,4						
Е	SERIES 1400	14"ø	4-WAY	24"×24"	1,2,3,4						
F	SERIES 1400	15"ø	4-WAY	24"×24"	1,2,3,4						

- . DIFFUSER SHALL BE FULLY ADJUSTABLE.
- 2. NC LEVEL SHALL NOT EXCEED 30 dB.
- 3. FRAME TYPE AS REQUIRED FOR CEILING TYPE, SEE ROOM FINISH SCHEDULE.
- 4. PROVIDE DIFFUSER WITH RADIATION DAMPER AND BLANKET WHERE REQUIRED SEE LIFE SAFETY PLAN.

	144444 - 144444 - 144444 - 144444 - 144444 - 144444 - 144444 - 144444 - 144444 - 144444 - 144444 - 144444 - 144	E	(HAUS	T FAN	SCH	HEL	DUL	E				
EF NO.	AREA EXHAUSTED	TYPE	GREENHECK MODEL	BACKDRAFT DAMPER	CFM	SP. " OF	FAN	МО	OTOR DATA		CONTROL	SEE
140.	EXHAUSTED		NUMBER	SIZE		W.C.	RPM	HP	VOLTS	PHASE	NOTE #1	NOTE
KN1	A-105, A-106, A-111	ROOF	GB 101-4	12 " X12"	430	.375	1725	1/4	115	1	ZONE #2	2,3
KN2	A-112	ROOF	GB 141-4	16"X16"	1540	.375	1725	1/3	115	1	М	2,3
KN3	A113	ROOF	GB 70-6	10"X10"	160	.375	1725	1/6	115	1	ZONE #1	2,3
KN4	A-134, A-137	ROOF	GB 90-4	10"X10"	455	.375	1725	1/4	115	1	ZONE #2	2,3
KN5	A-122, A-124, A-129, A-131, A-136, A-138, A-145, A-146	ROOF	GB 141-4	16"X16"	1210	.50	1725	1/4	115	1	ZONE #2	2,3
KN6	A-123, A-130	ROOF	GB 70-6	10"X10"	215	.375	1725	1/6	115	1	ZONE #2	2,3
KN7	A-127	ROOF	GB 90-4	10"X10"	500	.375	1725	1/4	115	1	(T)	3
KN8	A-201	ROOF	GB 141-4	16"X16"	1500	.375	1725	1/3	115	1	(T)	3
KN9	A-116, A-151	ROOF	GB 101-4	12"X12"	440	.375	1725	1/4	115	1	ZONE #3	
KN10	A-101	ROOF	GB 141-4	16"X16"	1600	.375	1725	1/3	115	1	(T)	
KS1	A-105, A-107	ROOF	GB 70-6	10"X10"	1320	.375	1725	1/4	115	1	ZONE #1	2,3
KS2	A-104	ROOF	GB 121-4	12"X12"	700	.375	1725	1/4	115	1	М	2,3
KS3	A-110, A-111, A-112	ROOF	GB 121	12"X12"	600	.375	1725	1/4	115	1	ZONE #1	

- . CONTROL DESIGNATIONS: (ZONE#) FAN TO BE CONTROLLED AUTOMATICALLY BY TEMPERATURE CONTROL ZONE SHOWN, (M) FAN TO BE CONTROLLED BY MANUAL SWITCH PROVIDED BY ELECTRICAL CONTRACTOR, INTERLOCKED THROUGH DAY/NIGHT ZONE# SHOWN, (T) FAN TO BE CONTROLLED BY THERMOSTAT PROVIDED BY TEMPERATURE CONTROL CONTRACTOR, (H) FAN TO BE CONTROLLED BY HUMIDISTAT PROVIDED BY TEMPERATURE CONTROL CONTRACTOR, (TM) FAN TO BE CONTROLLED BY TIMER PROVIDED BY ELECTRICAL CONTRACTOR, (EPE) FAN TO BE CONTROLLED AUTOMATICALLY BY REFRIGERANT PURGE EXHAUST SYSTEM PROVIDED BY TEMPERATURE CONTROL CONTRACTOR, SEE SPECIFICATIONS.
- . TEMPERATURE CONTROL CONTRACTOR SHALL PROVIDE PRESSURE ELECTRIC SWITCHES TO CONTROL EXHAUST FAN CONTRACTORS. REFER TO ELECTRICAL DRAWINGS FOR LOCATIONS.
- 3. INSTALL FAN ON 18" HIGH PREFABRICATED CURB PROVIDED BY FAN MANUFACTURER.

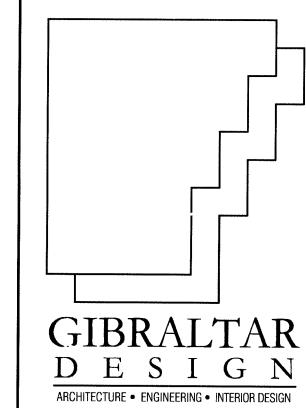

PROJECT

LAWRENCE **CENTRALIZED KINDERGARTEN**

NORTH & SOUTH CAMPUS ADDITIONS

METROPOLITAN SCHOOL DISTRICT

OF LAWRENCE TOWNSHIP

MARION COUNTY, INDIANA

GIBRALTAR DESIGN 9102 N. Meridian St., Ste. 300

Indianapolis, IN 46260 Homepage www.GibraltarDesign.com Email info@GibraltarDesign.com Phone 317.580.5777 Fax 317.580.5778

04/21/03 COORDINATED BY DRAWN BY

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MARK DATE ISSUED FOR 04/21/03 CD BID SET ISSUED

MECHANICAL LEGEND, GENERAL NOTES AND SCHEDULES

LAWRENCE CENTRALIZED KINDERGARTEN NORTH & SOUTH CAMPUS ADDITIONS

©GIBRALTAR DESIGN SHEET

BOILER SCHEDULE												
B TYPE MANUFACTURER MODEL NUMBER INPUT OUTPUT NOMINAL GAS #2 OIL MOTOR VOLTS PLACE NOT												
NO.	ITPE	NOMINAL BOILER HP	GAS CFH	#2 OIL GPH	MOTOR KW	VOLTS	PHASE	NOTE				
KN1	CONDENSING	VIESSMANN	VSB-57	2160	2000	60	2160	_	1.4	460	3	1,2
	W											

NOTES:

- 1. CAPACITIES ARE BASED ON NATURAL GAS HEATING CONTENT OF 1000 BTU/CUBIC ET.
- 2. GAS PRESSURE TO GAS TRAIN REGULATOR IS 14".

	EXPANSION TANK SCHEDULE												
NO.	SYSTEM	BELL & GOSSETT	VC	DLUME	PRE-CHARGE								
	SERVED	MODEL NO.	TANK	ACCEPTANCE	PRESSURE PSI								
KN1	HEATING WATER	B-2000	528	528	12PSI								
KN2	CHILLED WATER	B-800	211	211	12PSI								
					<u> </u>								

	AIR COOLED CHILLER SCHEDULE														
ACCH	M())=							-							
NO.	MODEL NUMBER	(TONS)			<u> </u>	COMPRESSOR DATA (EACH) COM				COND	CONDENSER FAN DATA (EACH)				SEE NOTE
	INOMBER	-	GPM	EWT °F	LWT °F	QTY	QTY RLA LRA VOLTS PHASE QTY FLA VOLTS PHASE					PHASE			
KN1	CGAF-C50	50	100	42	52	4	4 (2) 15.5 (2) 110 (2) 24.2 (2) 174 460 3 6 1.7 460 3				3	97	_		
	-		-												

NOTES:

- 1. UNIT SUPPLIER SHALL SUBMIT A REFRIGERATION PIPING DIAGRAM FOR APPROVAL. SHOWING ALL VALVES, TRAPS, HOT GAS BYPASS, ETC.
- 2. UNIT SHALL HAVE -10 'F LOW AMBIENT CONTROL.
- 3. CAPACITIES ARE BASED ON 'F SUCTION TEMPERATURE. 'F CONDENSING TEMPERATURE AND 95 'F AMBIENT TEMPERATURE.
- 4. PROVIDE SPLIT SYSTEM WITH REMOTE EVAPORATOR.
- 5. COOLING SYSTEM SHALL HAVE TWO REFRIGERANT CIRCUITS.

FPB	ROOM	PRIMA	RY AIR	AIR	HEAT	ING CO)IL	FAN	TRANE	SERVED	SEE
NO.	SERVED	MAXIMUM CFM	MINIMUM CFM	INLET	CAPACITY MBH	GPM	ROW	HP	MODEL NUMBER	BY AHU	NOTE
KN1	A-139	1300	520	12"ø	56.4	3.0	2	1/2	VSWF 12	KN2	1,2,3,4
KN2	A-135	1300	520	12"ø	56.4	3.0	2	1/2	VSWF 12	KN2	1,2,3,4
KN3	A-132	1320	525	12"ø	56.4	3.0	2	1/2	VSWF 12	KN2	1,2,3,4
KN4	A-128	1320	525	12"ø	56.4	3.0	2	1/2	VSWF 12	KN2	1,2,3,4
KN5	A-125	1300	520	12"ø	56.4	3.0	2	1/2	VSWF 12	KN2	1,2,3,4
KN6	A-121	1300	520	12"ø	56.4	3.0	2	1/2	VSWF 12	KN2	1,2,3,4
KN7	A-112	1400	560	14"ø	60.4	3.0	2	1/2	VSWF 14	KN1	1,2,3,4
KN8	A-115	1185	475	12"ø	51.4	2.6	2	1/2	VSWF 12	KN1	1,2,3,4
KN9	A-115	1185	475	12"ø	51.4	2.6	2	1/2	VSWF 12	KN1	1,2,3,4
KN10	A-115	1185	475	12"ø	51.4	2.6	2	1/2	VSWF 12	KN1	1,2,3,4
KN12	A-118	1760	705	14"ø	76.0	4.0	2	1/2	VSWF 14	KN3	1,2,3,4
KN11	A-119	200	80	5"ø	8.6	0.5	2	1/3	VSWF 05	KN3	1,2,3,4
KS1	A-101	900	360	10"ø	38.9	2.0	2	1/3	VSWF 10	KS1	1,2,3,4
KS2	A-102	800	320	10"ø	34.6	2.0	2	1/3	VSWF 10	KS1	1,2,3,4
KS3	A-102,103	1300	520	12"ø	56.4	3.0	2	1/2	VSWF 12	KS1	1,2,3,4
KS4	A-102	1300	520	12"ø	56.4	3.0	2	1/2	VSWF 12	KS1	1,2,3,4
KS5	A-104	1400	560	14"ø	60.4	3.0	2	1/2	VSWF 14	KS1	1,2,3,4

NOTES:

- 1. FAN MOTOR: 115 VOLTS, 1 PHASE, 60 HERTZ.
- 2. NC LEVEL SHALL NOT EXCEED 33 BASED ON 10 db ROOM EFFECT IN EACH OCTAVE BAND AND 1/2 BASS STC-39 CEILING TRANSMISSION LOSS.
- 3. FAN CFM TO MATCH PRIMARY AIR MAXIMUM CFM SETTING.
- 4. HEATING COIL CAPACITIES ARE BASED ON 180 *F ENTERING WATER AND 40 *F.

	VAF	RIABLE	E AIR	VOL	UME	BO	XS	CHEDU	JLE	
VAV	ROOM	CI	-M	AIR	HEAT	ING CO	OIL	TRANE	SERVED BY	SEE
NO.	SERVED	MAXIMUM	MINIMUM	INLET	CAPACITY MBH	GPM	ROW	MODEL NUMBER	AHU	NOTE
KN1	A-109	250	100	5ø	5.4	0.5	1	VCWE 03	KN2	_
KN2	A-110	225	90	5ø	4.9	0.5	1	VCWE 03	KN2	
KN3	A-108	225	90	5ø	4.9	0.5	1	VCWE 03	KN2	_
KN4	A-150	450	180	6ø	9.7	1.0	1	VCWE 06	KN2	-
KN5	A-104	550	220	8ø	11.9	1.0	1	VCWE 11	KN2	-
KN6	A-103	340	140	6ø	7.3	1.0	1	VCWE 06	KN2	
KN7	A-143	600	250	8ø	13.6	1.0	1	VCWE 11	KN2	
KN8	A-144	140	50	5ø	2.7	0.5	1	VCWE 03	KN2	
KN9	A-120	150	40	5ø	3.2	0.5	1	VCWE 03	KN3	_
								-		
KS1	A-109	400	160	6ø	8.6	1.0		VCWE 06	KS1	_

NOTES:

1. NC LEVEL SHALL NOT EXCEED 33 BASED ON 10 db ROOM EFFECT IN EACH OCTAVE BAND AND 1/2 PASS STC-39 CEILING TRANSMISSION LOSS.

2. HEATING COIL CAPACITIES ARE BASED ON 180 °F ENTERING WATER AND 40 °F.

	UNIT HEATER SCHEDULE													
UH NO.	ROOM SERVED	TRANE MODEL NUMBER	TYPE AND ARRANGEMENT	МВН	CFM	WATER RATE GPM	HP	FAN SPEED RPM	SEE NOTE					
KN1	A-101	100 S	HORIZONTAL PROPELLOR	62.5	1335	6.2	1/8	1550	1,2					
KN2	A-102	100 S	HORIZONTAL PROPELLOR	62.5	1335	6.2	1/8	1550	1,2					
KN3	A-201	100 S	HORIZONTAL PROPELLOR	62.5	1335	6.2	1/8	1550	1,2					
KN4	A-117	100 S	HORIZONTAL PROPELLOR	62.5	1335	6.2	1/8	1550	1,2					
KS1	A-108	100 S	HORIZONTAL PROPELLOR	62.5	1335	6.2	1/8	1550	1,2					


NOTES:

- 1. HEATING CAPACITIES ARE BASED ON 60 °F ENTERING AIR, 180 °F ENTERING WATER AND 40 °F WATER TEMPERATURE DROP, FINAL AIR TEMPERATURE SHALL BE 110 °F TO 140 °F.
- 2. MOTORS SHALL BE MULTI-SPEED, 115 VOLTS, 1 PHASE, 60 HERTZ.

	CIRCULATING PUMP SCHEDULE													
СР	SYSTEM	BELL AND GOSSET	T MODEL NUMBER	GPM	FEET	HP	SEE							
NO.	SERVED	SERIES	SIZE	GFIVI	HEAD	ПР	NOTE							
KN1	CHILLED WATER SYSTEM	SERIES 1510	2BC	100	65	5	1,2							
KN2	CHILLED WATER SYSTEM	SERIES 1510	2BC	100	65	5	1,2							
KN3	HEATING SYSTEM	SERIES 1510	2BC	110	60	5	1,2							
KN4	HEATING SYSTEM	SERIES 1510	2BC	110	60	5	1,2							
KN5	AHU-KN1 HEATING COIL	SERIES 90	1 1/4 AA	11	20	3/4	1							
KN6	AHU-KN2 HEATING COIL	SERIES 90	1 1/4 AA	27	20	3/4	1							
KN7	AHU-KN3 HEATING COIL	SERIES 90	1 1/4 AA	4.5	20	3/4	1							
KS1	AULI KS1 HEATING COU	CEDIEC CO												
V21	AHU-KS1 HEATING COIL	SERIES 60	2AA	48	20	3/4	1							

NOTES:

- 1. PUMP MOTOR: 460 VOLTS, 3 PHASE, 60 HERTZ, 1750 RPM.
- 2. PUMP SHALL OPERATE AS 100% STAND-BY PUMP.

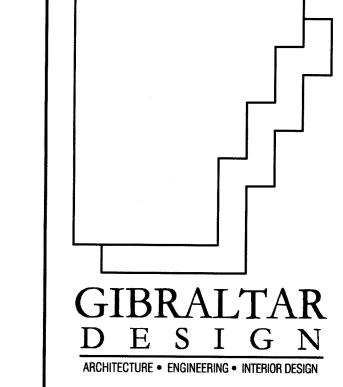

PROJECT

LAWRENCE CENTRALIZED KINDERGARTEN

NORTH & SOUTH CAMPUS ADDITIONS

METROPOLITAN SCHOOL DISTRICT OF LAWRENCE TOWNSHIP

MARION COUNTY, INDIANA

GIBRALTAR DESIGN

9102 N. Meridian St., Ste. 300 Indianapolis, IN 46260 Homepage www.GibraltarDesign.com Email info@GibraltarDesign.com Phone 317.580.5777 Fax 317.580.5778

PROJECT 02-580 DATE 04/21/03 COORDINATED BY

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DRAWING
MECHANICAL
SCHEDULES


PROJECT


LAWRENCE CENTRALIZED KINDERGARTEN


NORTH & SOUTH CAMPUS ADDITIONS

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M-602




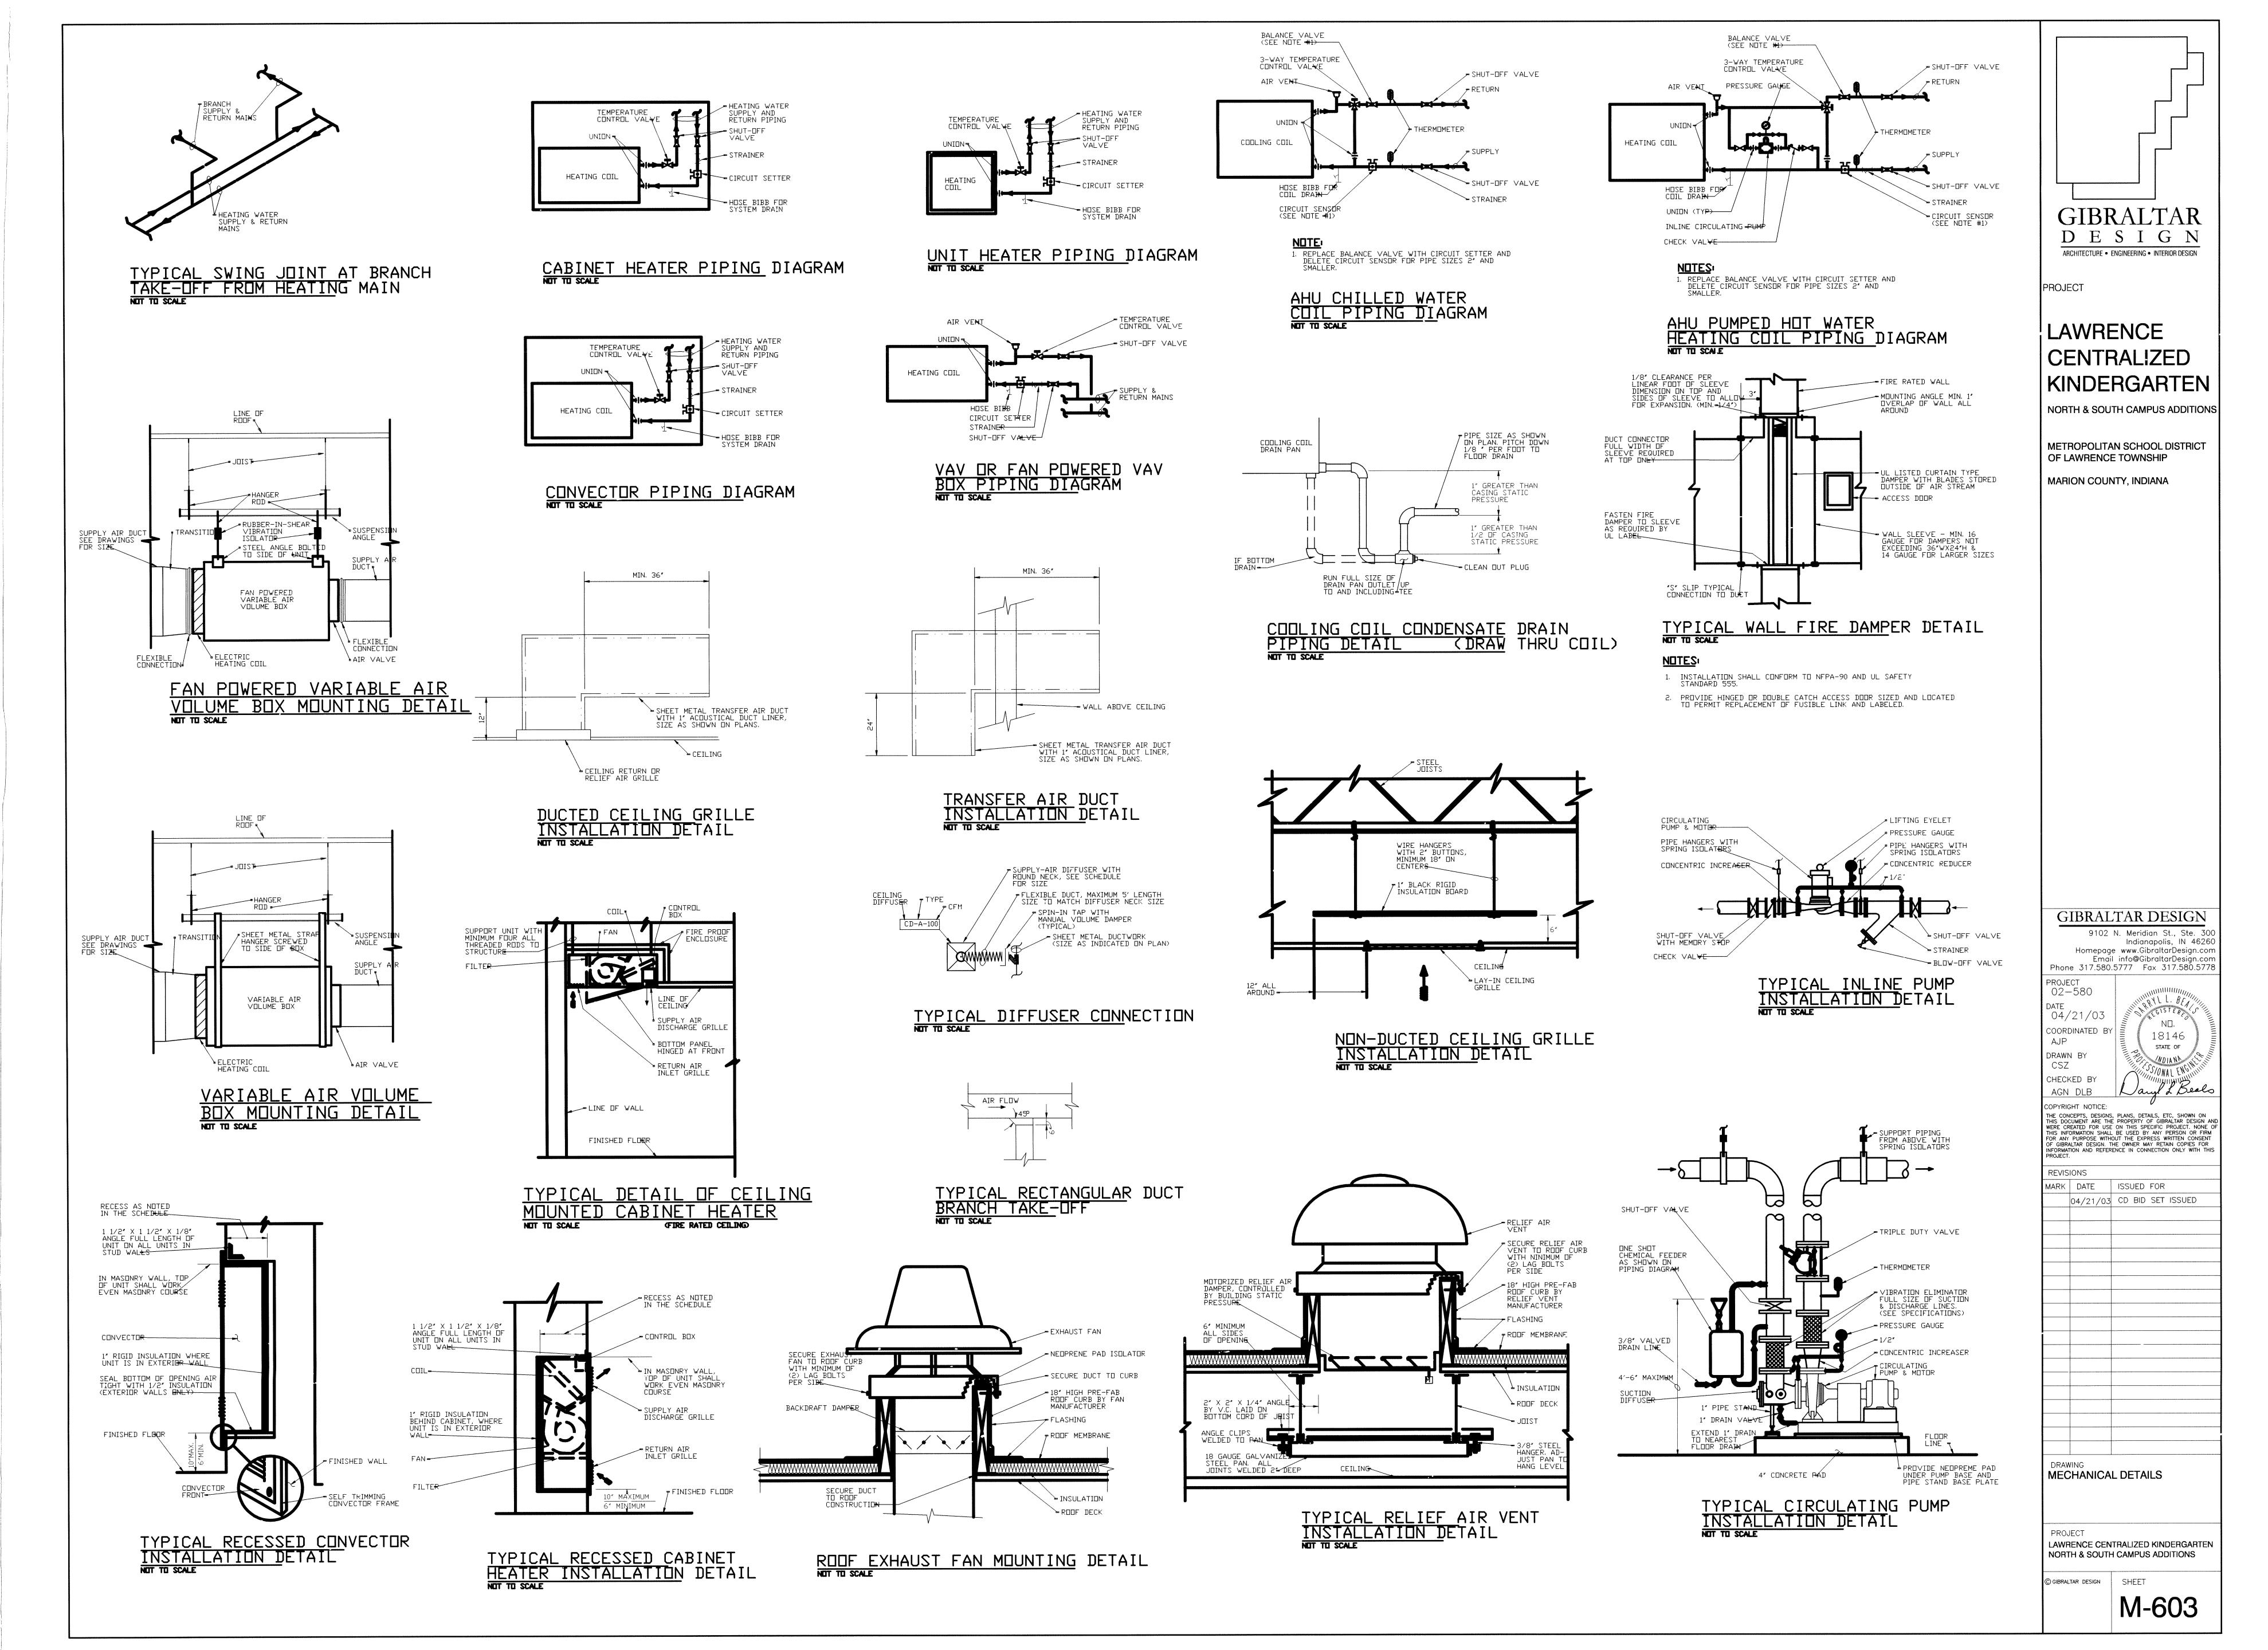

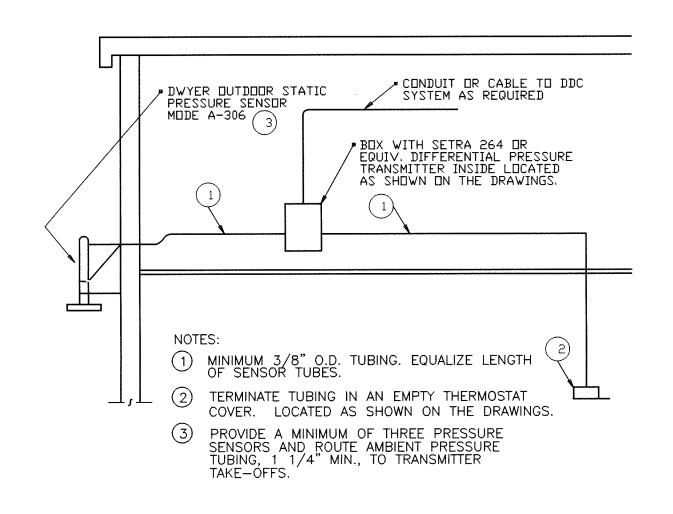


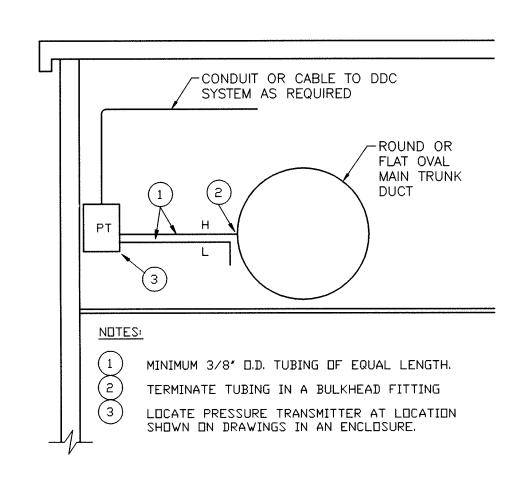BUILDING STATIC PRESSURE SENSOR INSTALLATION DETAIL


DUCT STATIC PRESSURE
SENSOR INSTALLATION DETAIL

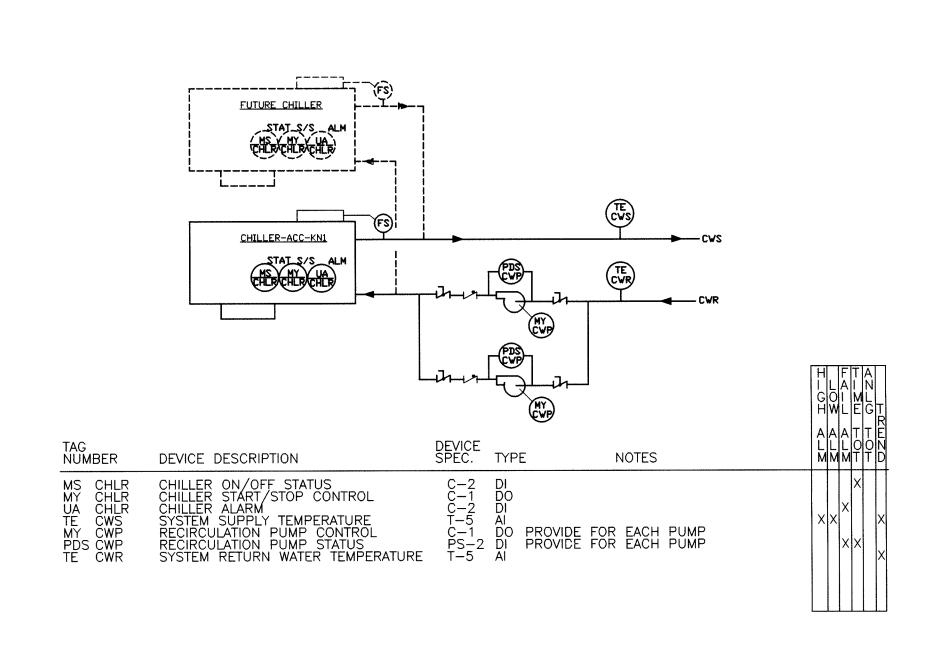

CHILLED WATER SYSTEM CONTROL DIAGRAM

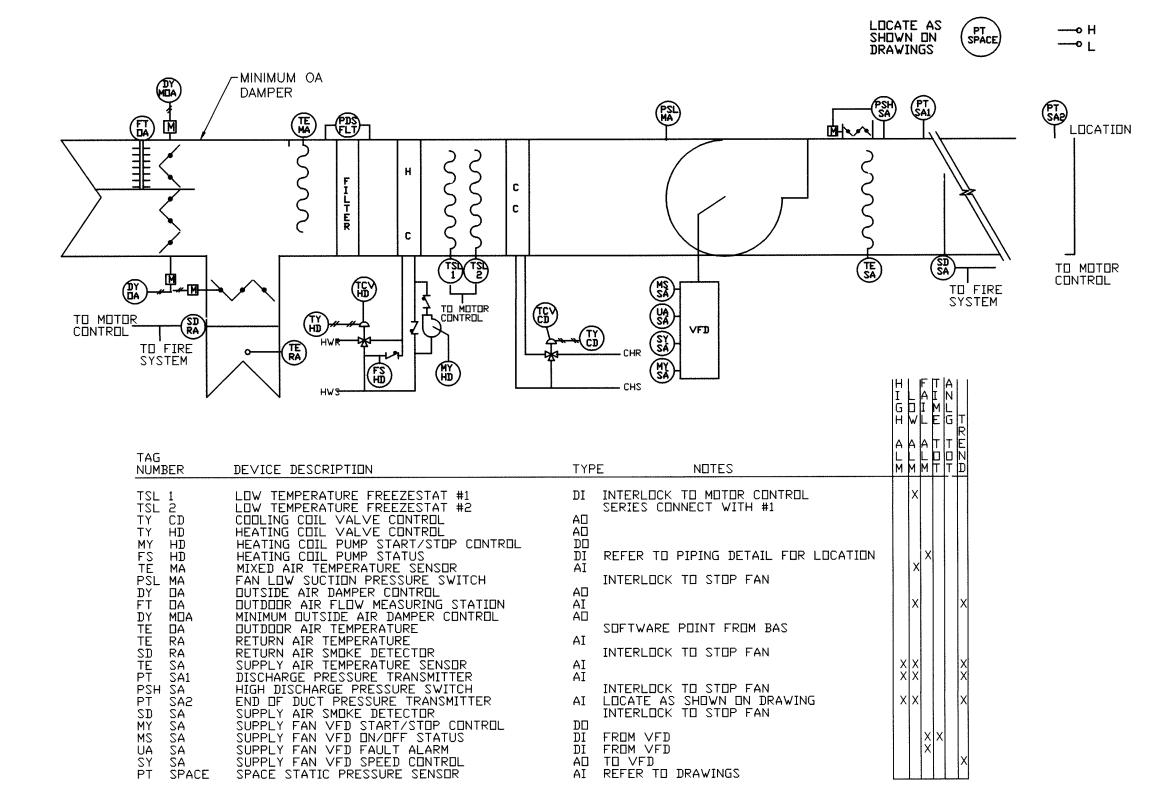

AHU KN1, KN2, KN3 AND KS1 VARIABLE VOLUME HEATING/COOLING
AIR HANDLER WITH PUMPED HEATING COIL AND SPLIT OUTDOOR AIR DUCT.

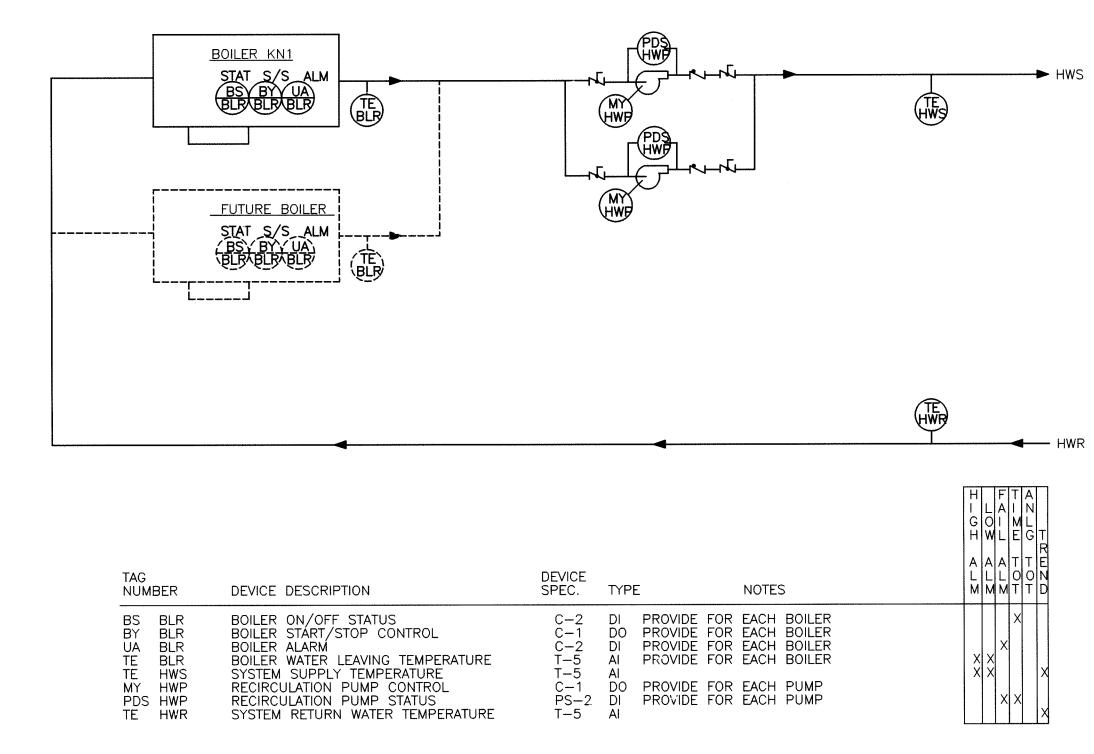

HOT WATER SYSTEM CONTROL DIAGRAM

NOT TO SCALE

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LAWRENCE CENTRALIZED KINDERGARTEN

NORTH & SOUTH CAMPUS ADDITIONS

MARION COUNTY, INDIANA

METROPOLITAN SCHOOL DISTRICT OF LAWRENCE TOWNSHIP

GIBRALTAR DESIGN

9102 N. Meridian St., Ste. 300
Indianapolis, IN 46260
Homepage www.GibraltarDesign.com
Email info@GibraltarDesign.com
Phone 317.580.5777 Fax 317.580.5778

PROJECT

Phone 317.580.5777 Fax 317.58

PROJECT
02-580

DATE
04/21/03

COORDINATED BY
AJP

DRAWN BY
CSZ

CHECKED BY
AGN DLB

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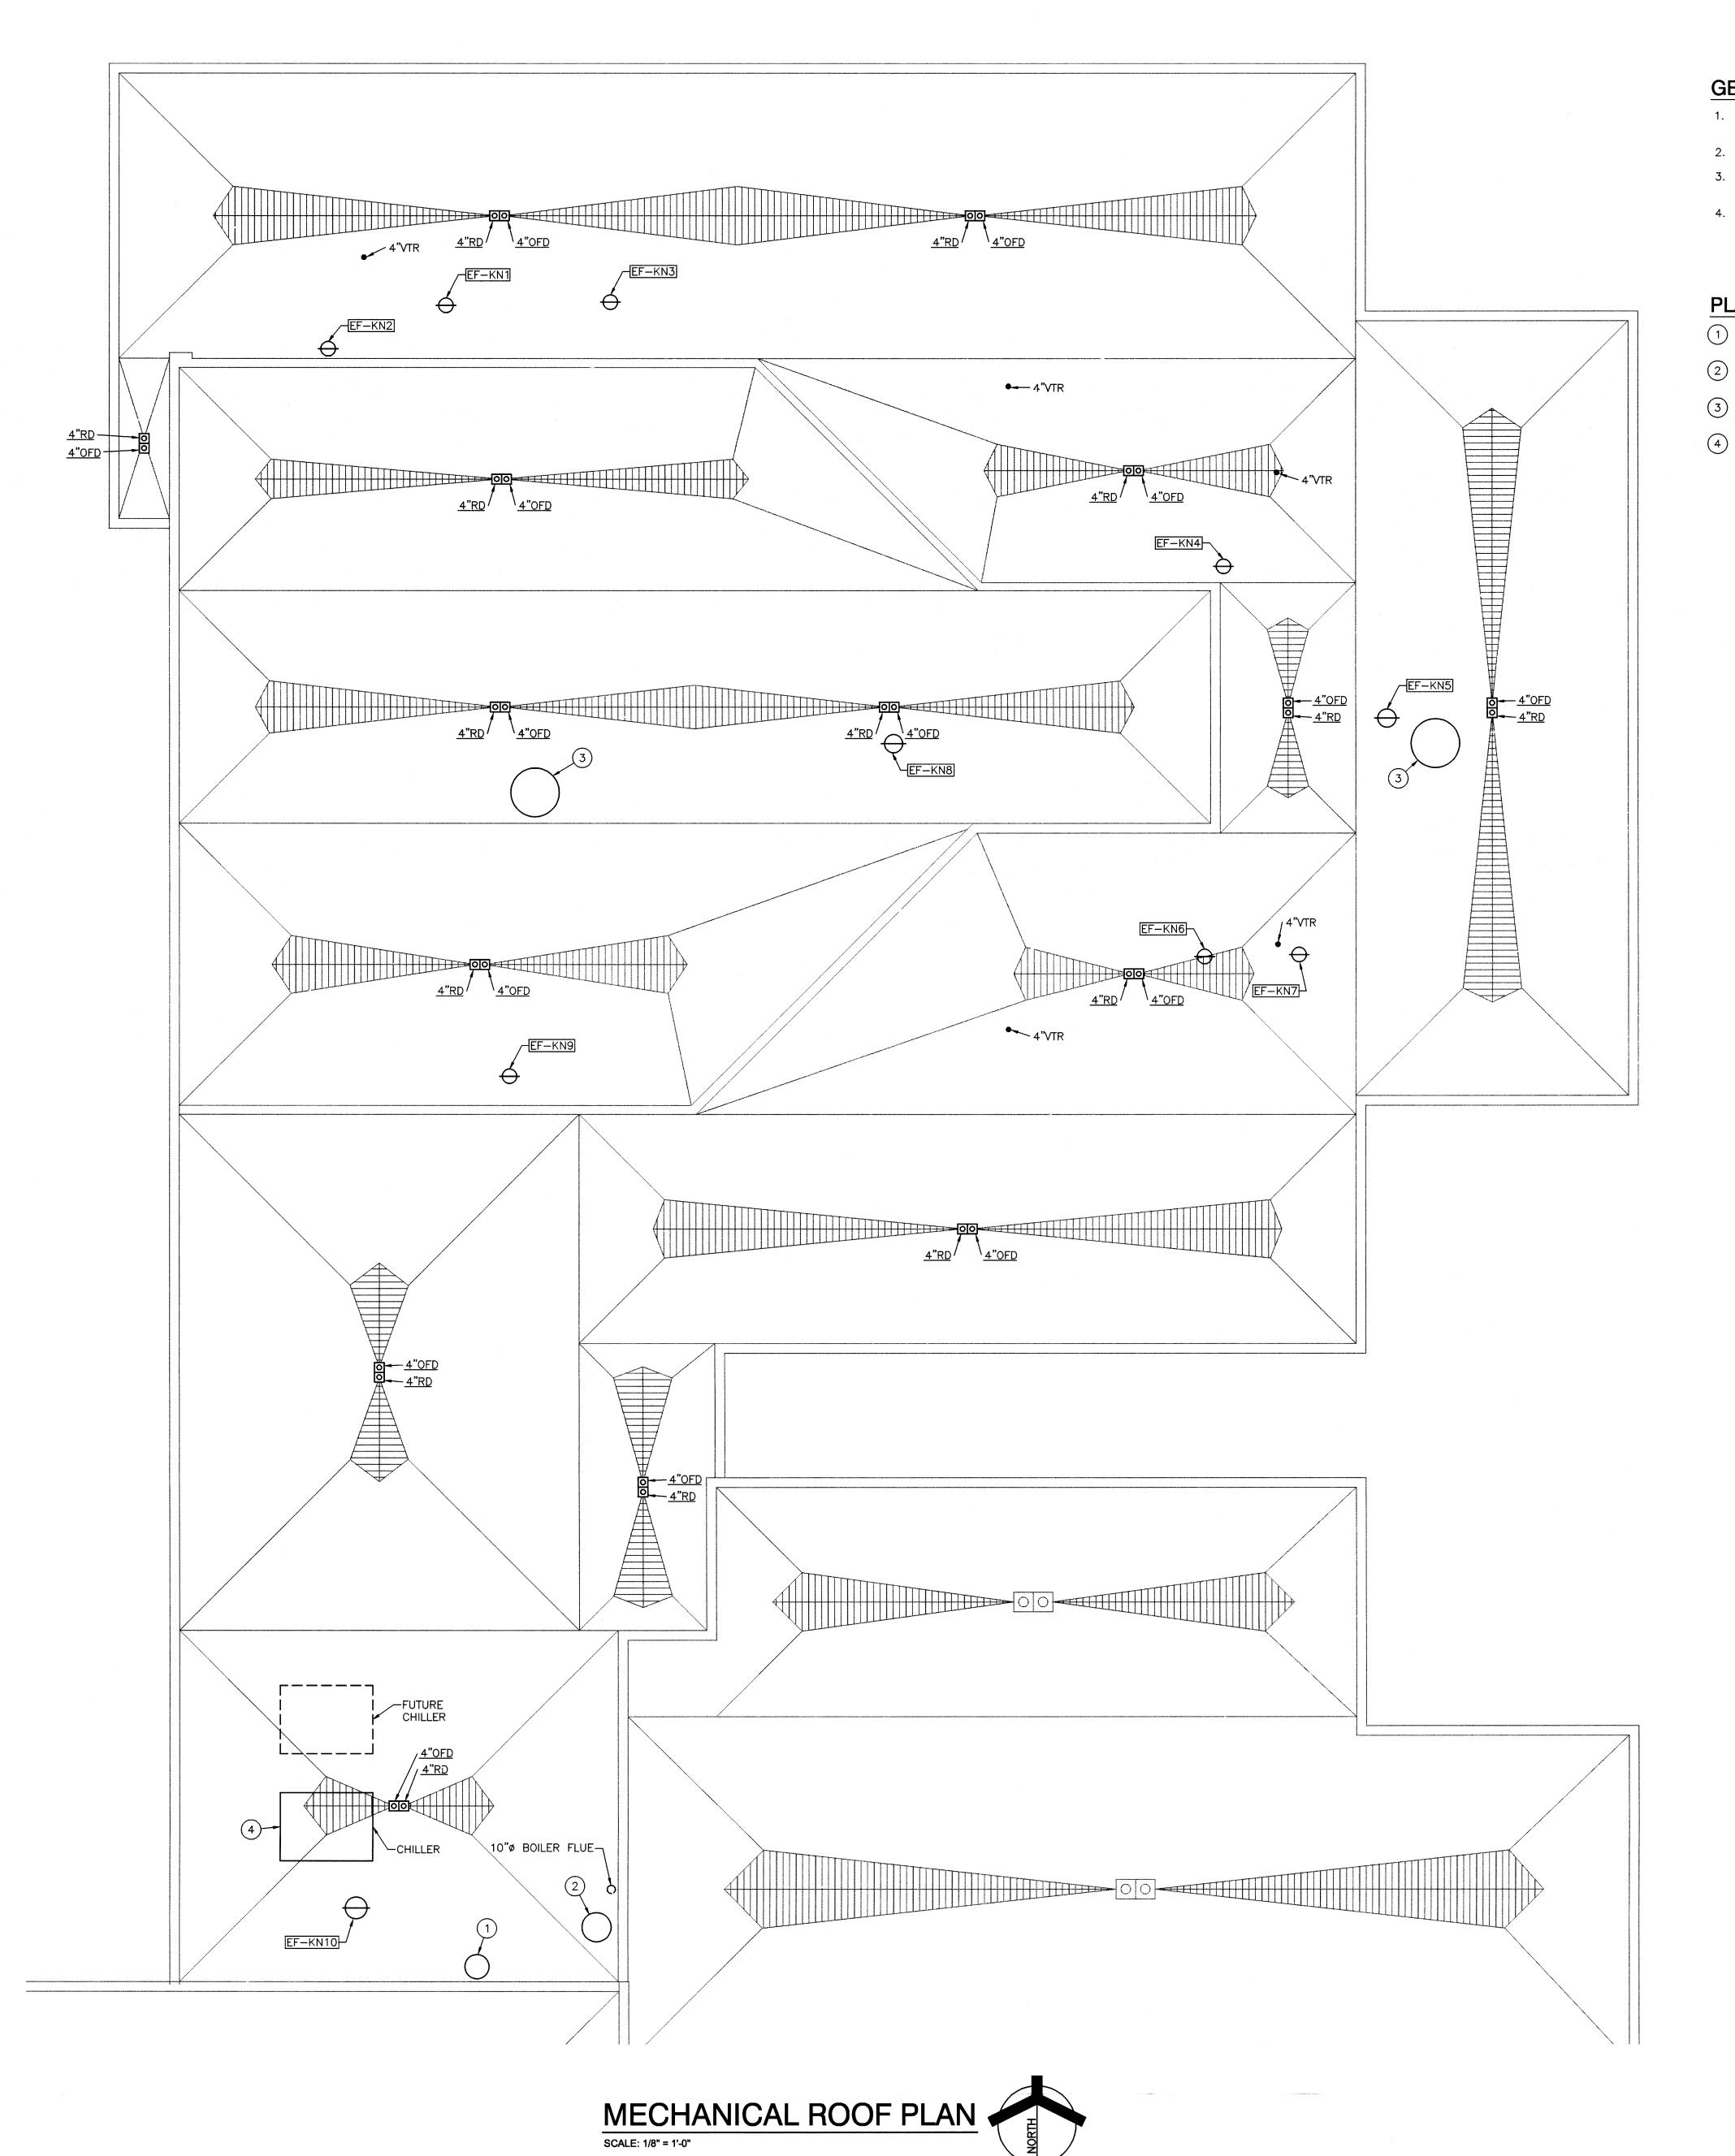
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DRAWING
MECHANICAL
TEMPERATURE CONTROL
DIAGRAMS

PROJECT
LAWRENCE CENTRALIZED KINDERGARTEN
NORTH & SOUTH CAMPUS ADDITIONS

GIBRALTAR DESIGN SHEET


M-801



- SEE SHEET P-001 FOR PLUMBING LEGEND, GENERAL NOTES, DETAILS AND SECHEDULES.
- 2. SEE SHEET M-501 FOR MECHANICAL DETAILS.
- SEE SHEET M-601 FOR MECHANICAL LEGEND, GENERAL NOTES AND SCHEDULES.
- SEE SHEET M-801 FOR MECHANICAL TEMPERATURE CONTROL DIAGRAMS.

PLAN NOTES:

- 1) GREENHECK MODEL GRS-16 OUTDOOR AIR INTAKE OR AN APPROVED EQUAL.
- 2 GREENHECK MODEL GRS-18 OUTDOOR AIR INTAKE FOR COMBUSTION AIR OR AN APPROVED EQUAL.
- 3 GREENHECK MODEL GRS-36 RELIEF VENT OR AN APPROVED EQUAL.
- 4 CHILLERS TO BE INSTALLED ON EQUIPMENT RAILS. SEE NOTES ON M-401.

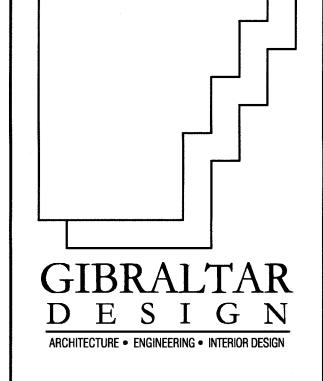


PROJECT

LAWRENCE CENTRALIZED KINDERGARTEN

NORTH & SOUTH CAMPUS ADDITIONS

METROPOLITAN SCHOOL DISTRICT OF LAWRENCE TOWNSHIP MARION COUNTY, INDIANA

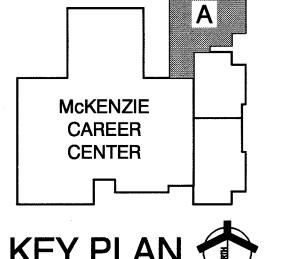


KEY PLAN

GIBRALTAR DESIGN 9102 N. Meridian St., Ste. 300 Indianapolis, IN 46260 Homepage www.GibraltarDesign.com Email info@GibraltarDesign.com Phone 317.580.5777 Fax 317.580.5778

PROJECT 02-580 DATE 04/21/03 COORDINATED BY DRAWN BY

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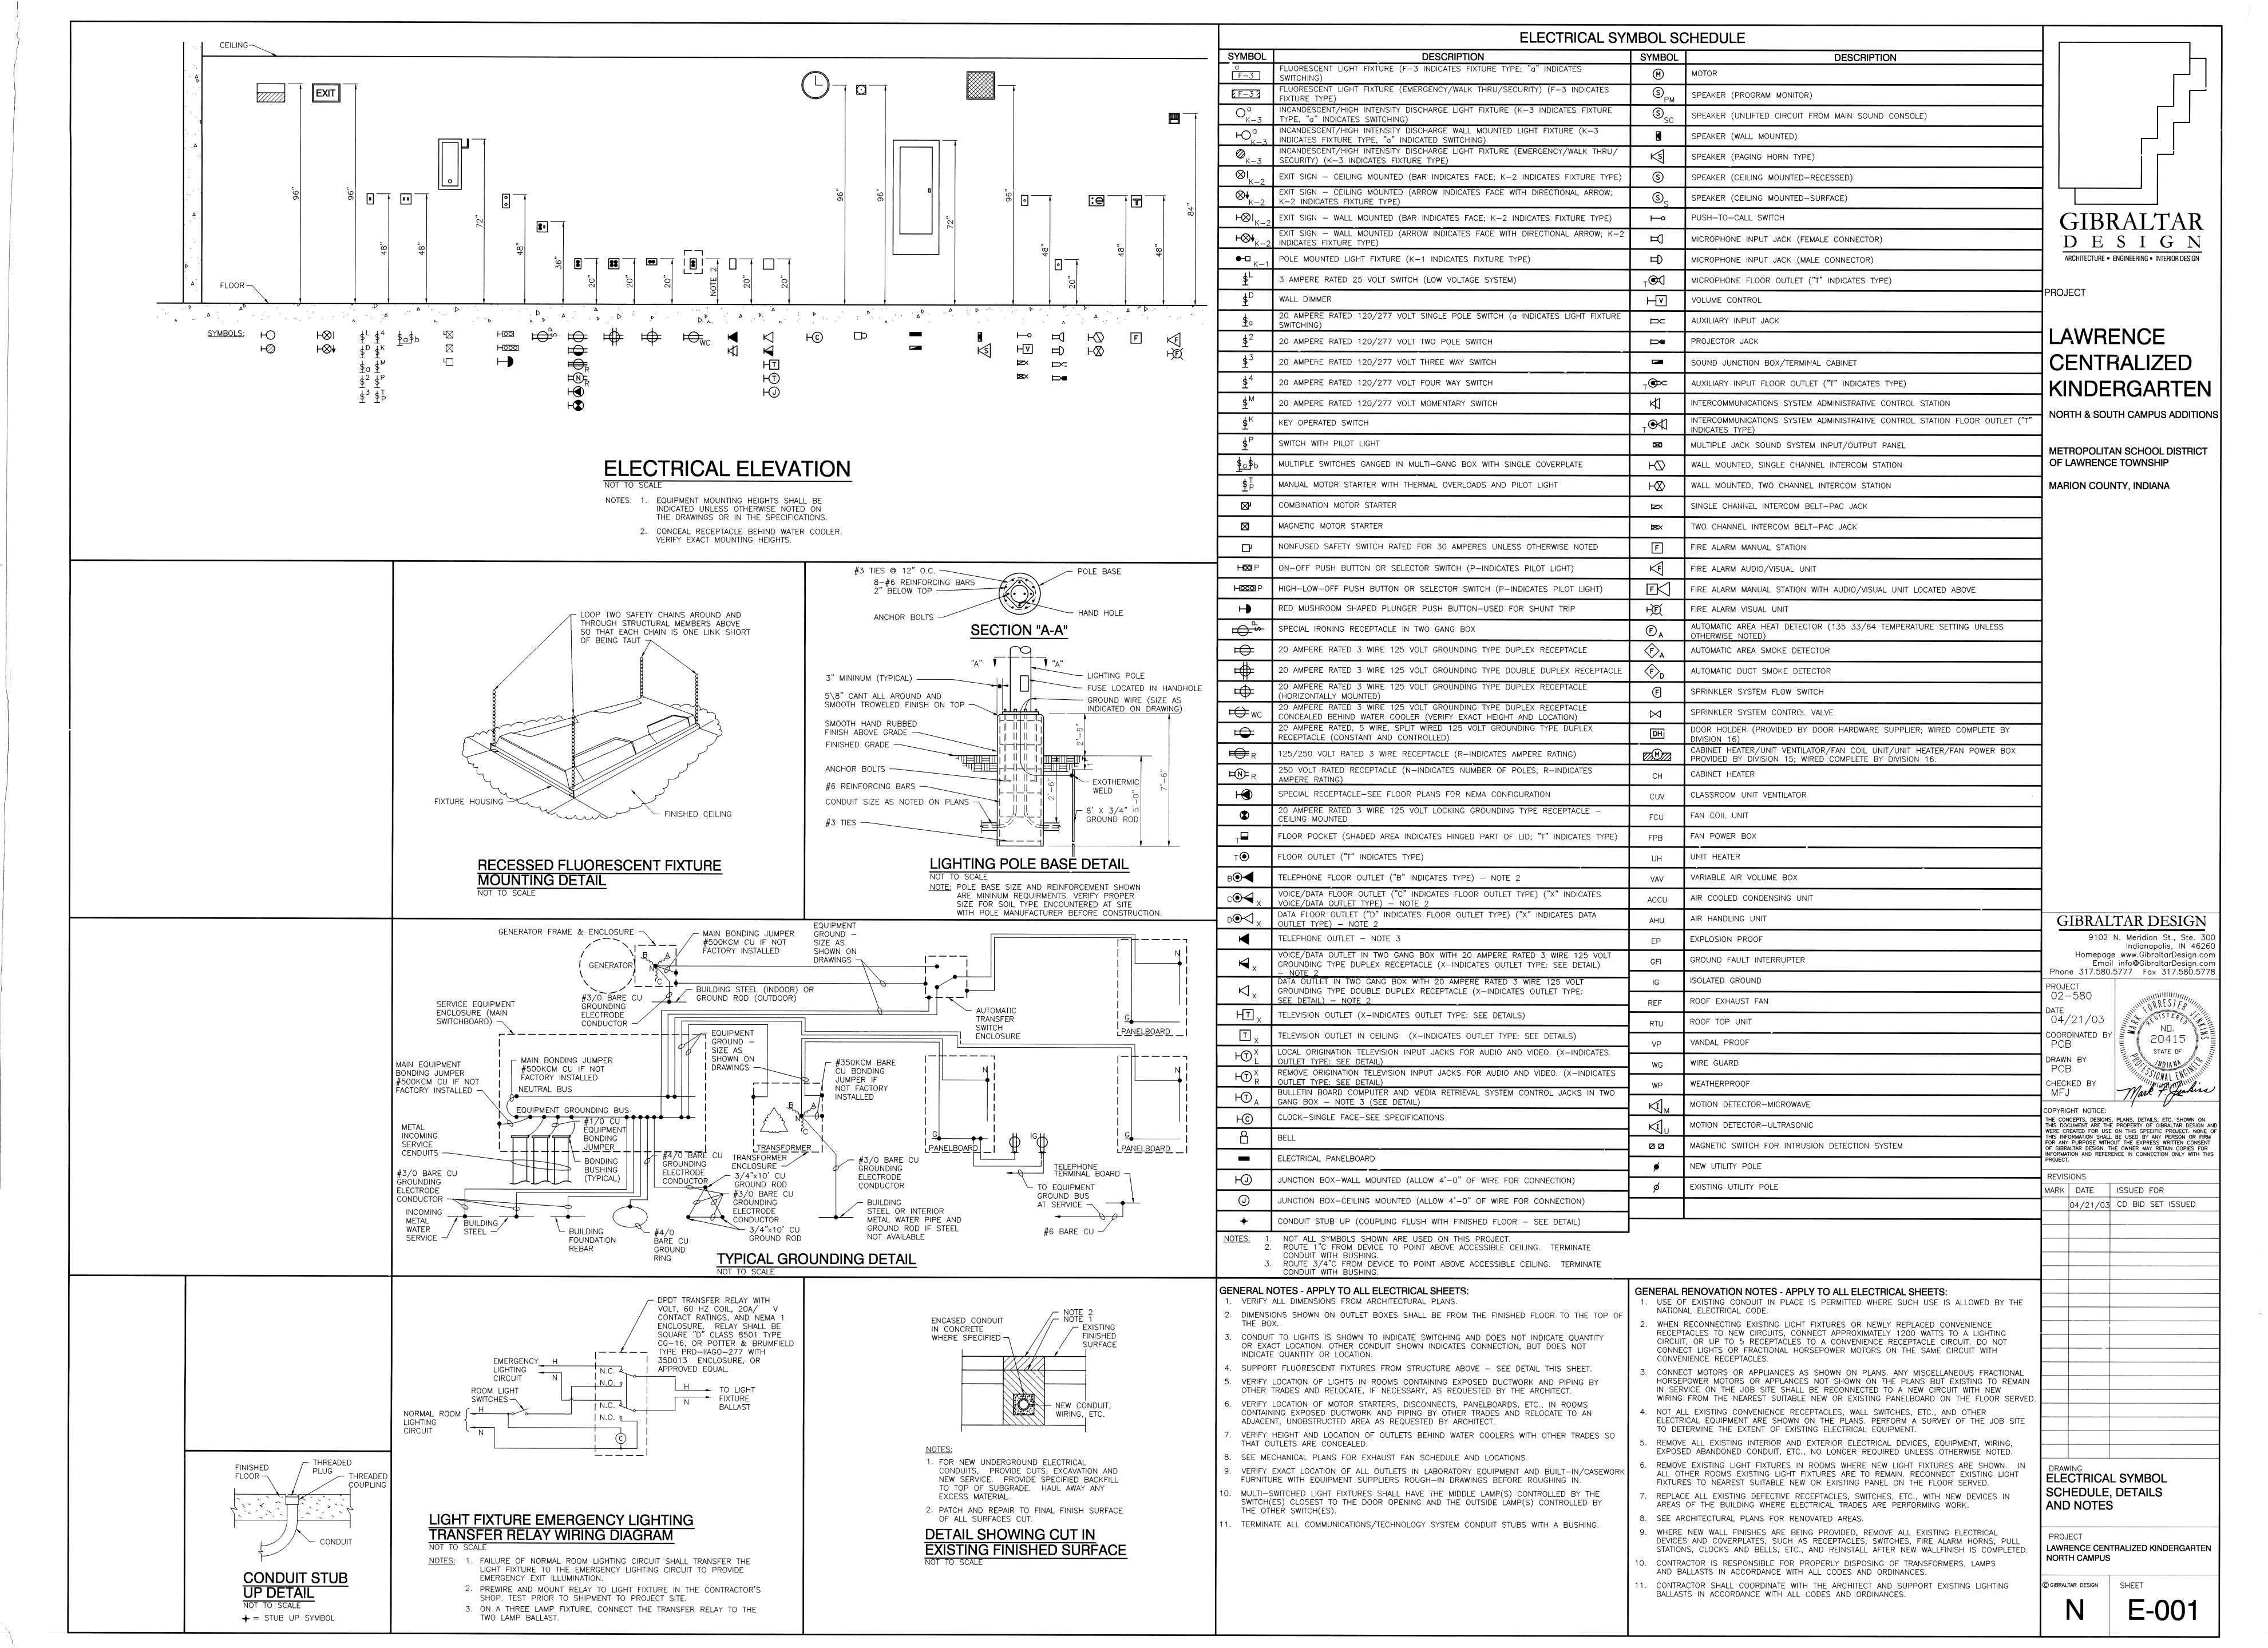
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DRAWING
MECHANICAL
ROOF PLAN

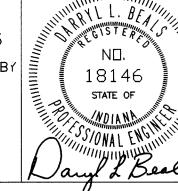LAWRENCE CENTRALIZED KINDERGARTEN NORTH CAMPUS

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SITE PLAN NOTES - GENERAL

- 1. ALL WORK SHOWN ON THIS SHEET IS NEW AND BY THE ELECTRICAL TRADES, UNLESS OTHERWISE NOTED.
- RELOCATE OR REMOVE ANY OR ALL EXISTING SERVICES, POLES, ETC., AS MAY BE REQUIRED TO ACCOMODATE NEW CONSTRUCTION, UNLESS OTHERWISE NOTED.
- PAY ALL FEES AND OTHER COSTS NOT BORNE BY THE LOCAL POWER COMPANY TO PROVIDE NEW ELECTRICAL SERVICE.
- 4. PAY ALL FEES AND OTHER COSTS NOT BORNE BY THE LOCAL TELEPHONE COMPANY TO PROVIDE NEW TELEPHONE SERVICE.
- 5. PAY ALL FEES AND OTHER COSTS NOT BORNE BY THE LOCAL CATV COMPANY TO PROVIDE NEW CATV SERVICE.

DEMOLITION PLAN NOTES: (THESE NOTES APPLY TO THIS SHEET ONLY)

(THESE NOTES APPLY TO THIS SHEET ONLY)


REMOVE EXISTING SITE LIGHTING FIXTURES, POLES, POLE BASES AND WIRING BACK TO SOURCE. ABANDON ALL CONDUIT CONCEALED UNDERGROUND, IN FLOORS AND IN WALLS IN PLACE AND REMOVE ALL EXPOSED CONDUIT NOT BEING REUSED TO SERVE THE NEW LIGHTING FIXTURES.


PLAN NOTES:

(THESE NOTES APPLY TO THIS SHEET ONLY)

(1) EXISTING UTILITY POLE AND OVERHEAD PRIMARY ELECTRICAL SERVICE.

- (2) 4" CONDUIT FOR NEW INCOMING UNDERGROUND PRIMARY ELECTRICAL SERVICE.
- 3 FLUSH IN-GROUND PULL BOX.
- 4 NEW PAD MOUNTED TRANSFORMER.
- 5 NEW EMERGENCY GENERATOR.
- 6 NEW INCOMING UNDERGROUND SECODNARY ELECTRICAL SERVICE SEE POWER DISTRIBUTION DIAGRAM ON SHEET E-701.
- TRANSITION FROM PVC TO CONDUIT WITH A PVC TO CONDUIT ADAPTER BELOW GRADE, ROUTE THE CONDUIT AND WIRE UP THE OUTSIDE OF THE BUILDING, STUB INSIDE THE BUILDING AND THEN ROUTE THEM ABOVE THE CEILINGS TO THE NEW RELAY.

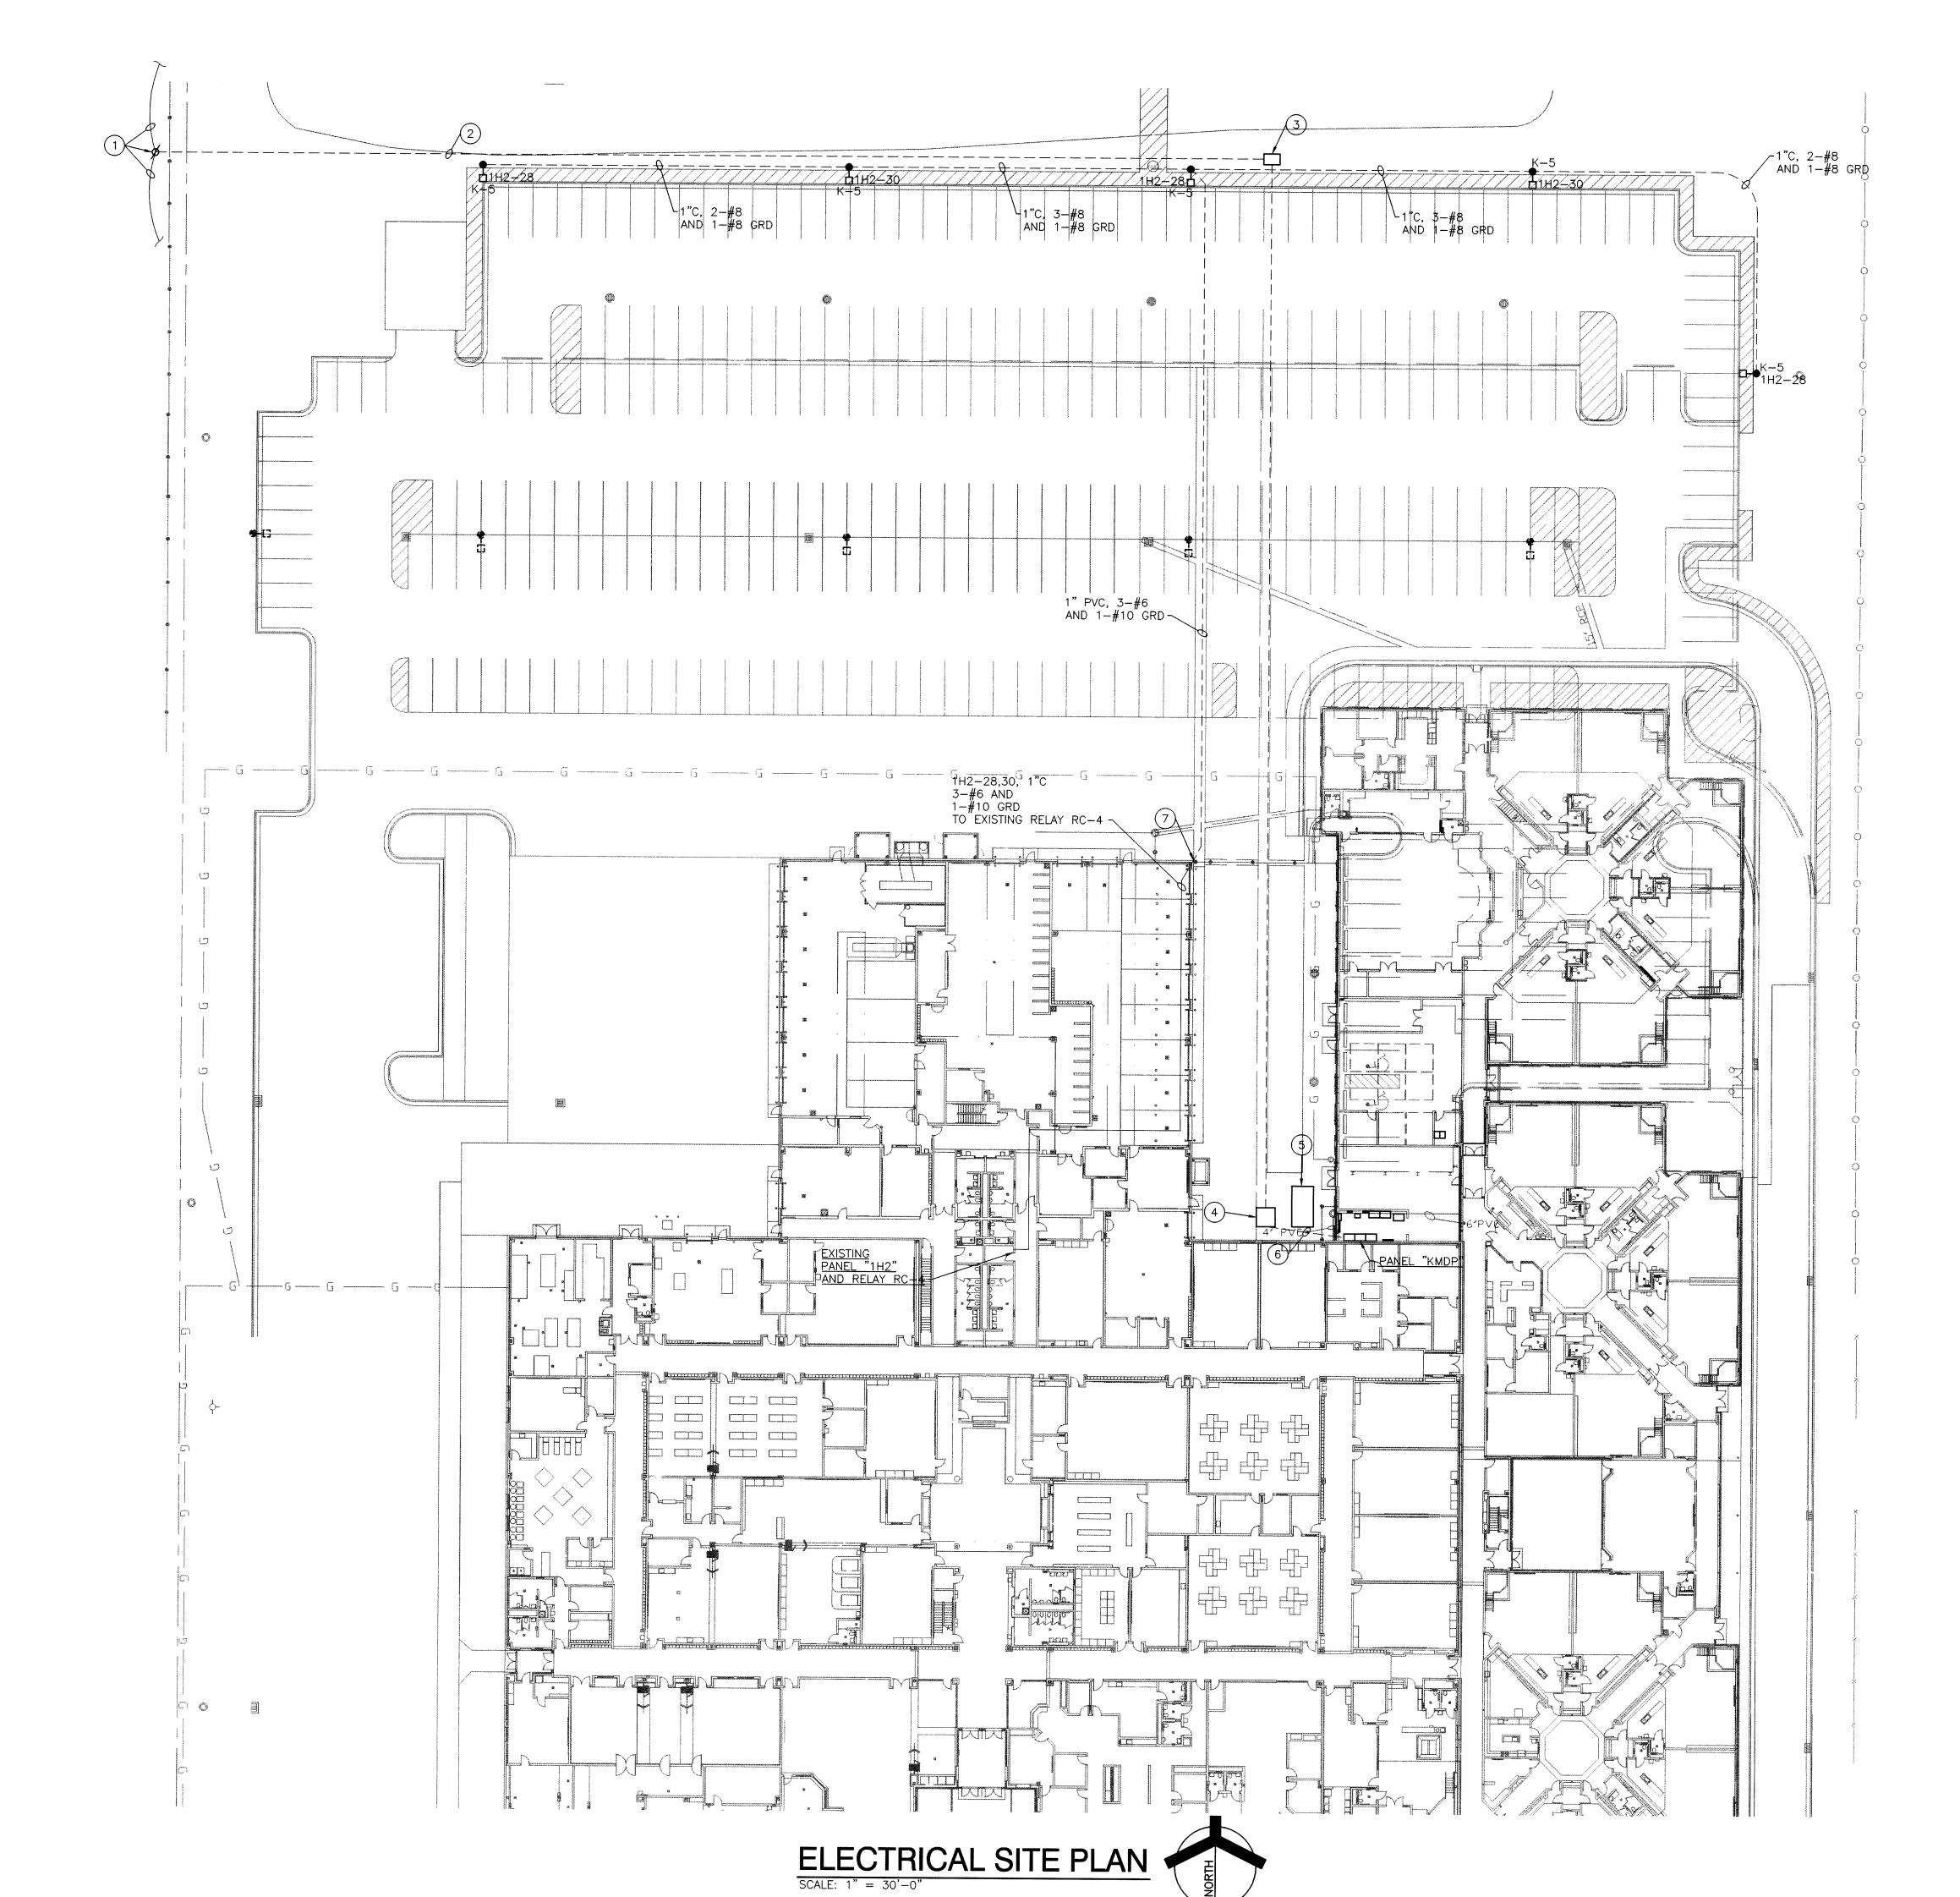

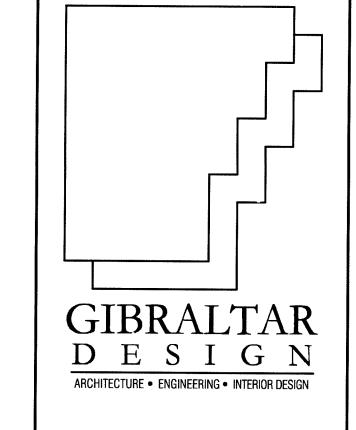

PROJECT

LAWRENCE CENTRALIZED KINDERGARTEN

NORTH & SOUTH CAMPUS ADDITIONS

METROPOLITAN SCHOOL DISTRICT OF LAWRENCE TOWNSHIP

MARION COUNTY, INDIANA

GIBRALTAR DESIGN

9102 N. Meridian St., Ste. 300
Indianapolis, IN 46260
Homepage www.GibraltarDesign.com
Email info@GibraltarDesign.com
Phone 317.580.5777 Fax 317.580.5778

PROJECT
02-580

DATE
04/21/03

DATE
04/21/03

COORDINATED BY
PCB

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MFJ

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DRAWING ELECTRICAL SITE PLAN


PROJECT

LAWRENCE CENTRALIZED KINDERGARTEN

NORTH & SOUTH CAMPUS ADDITIONS


GIBRALTAR DESIGN SHEET


ES101

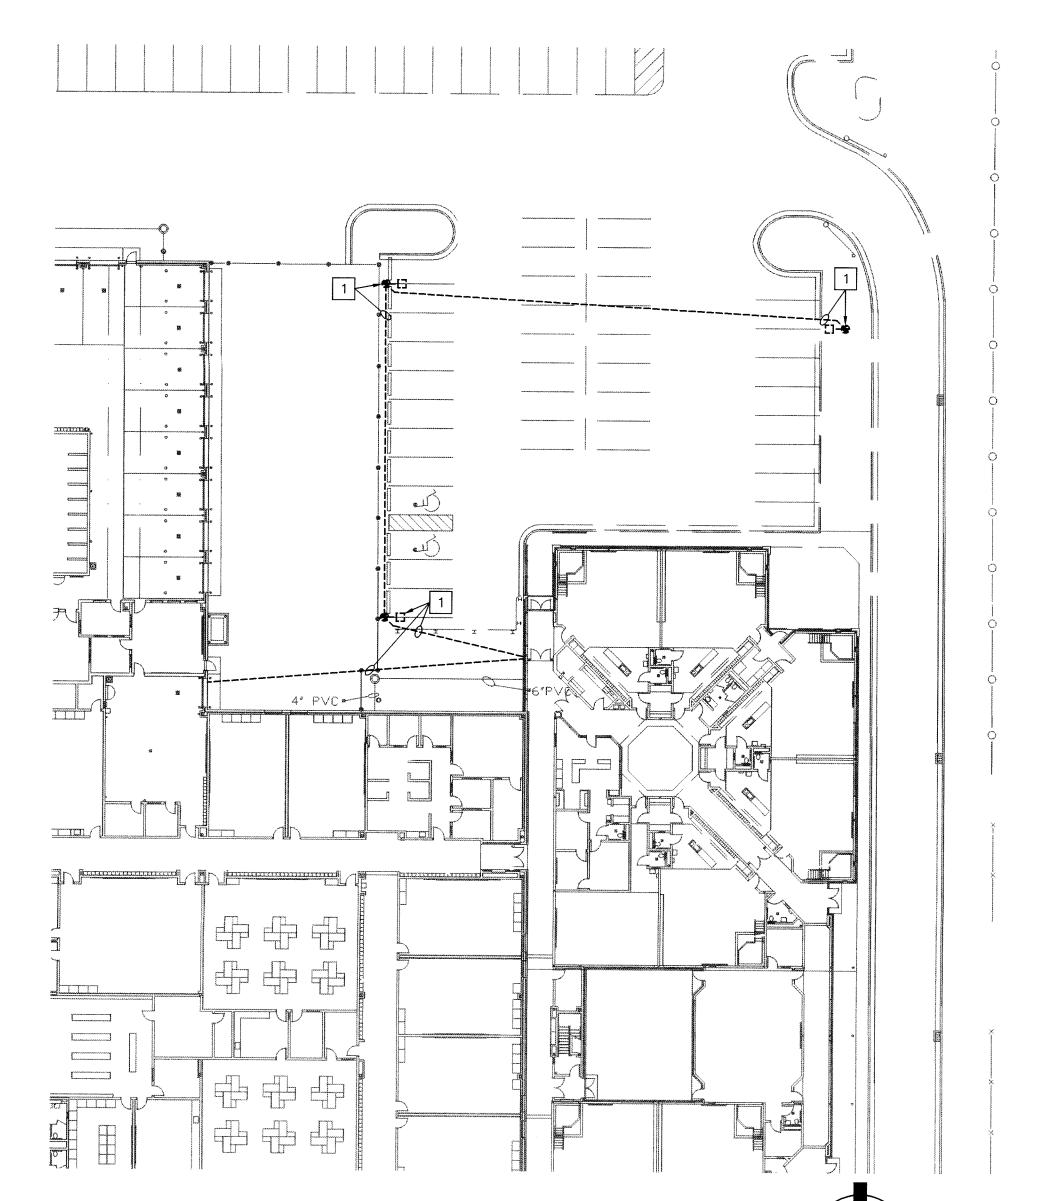


ELECTRICAL DEMOLITION SITE PLAN

SCALE: 1" = 30'-0"

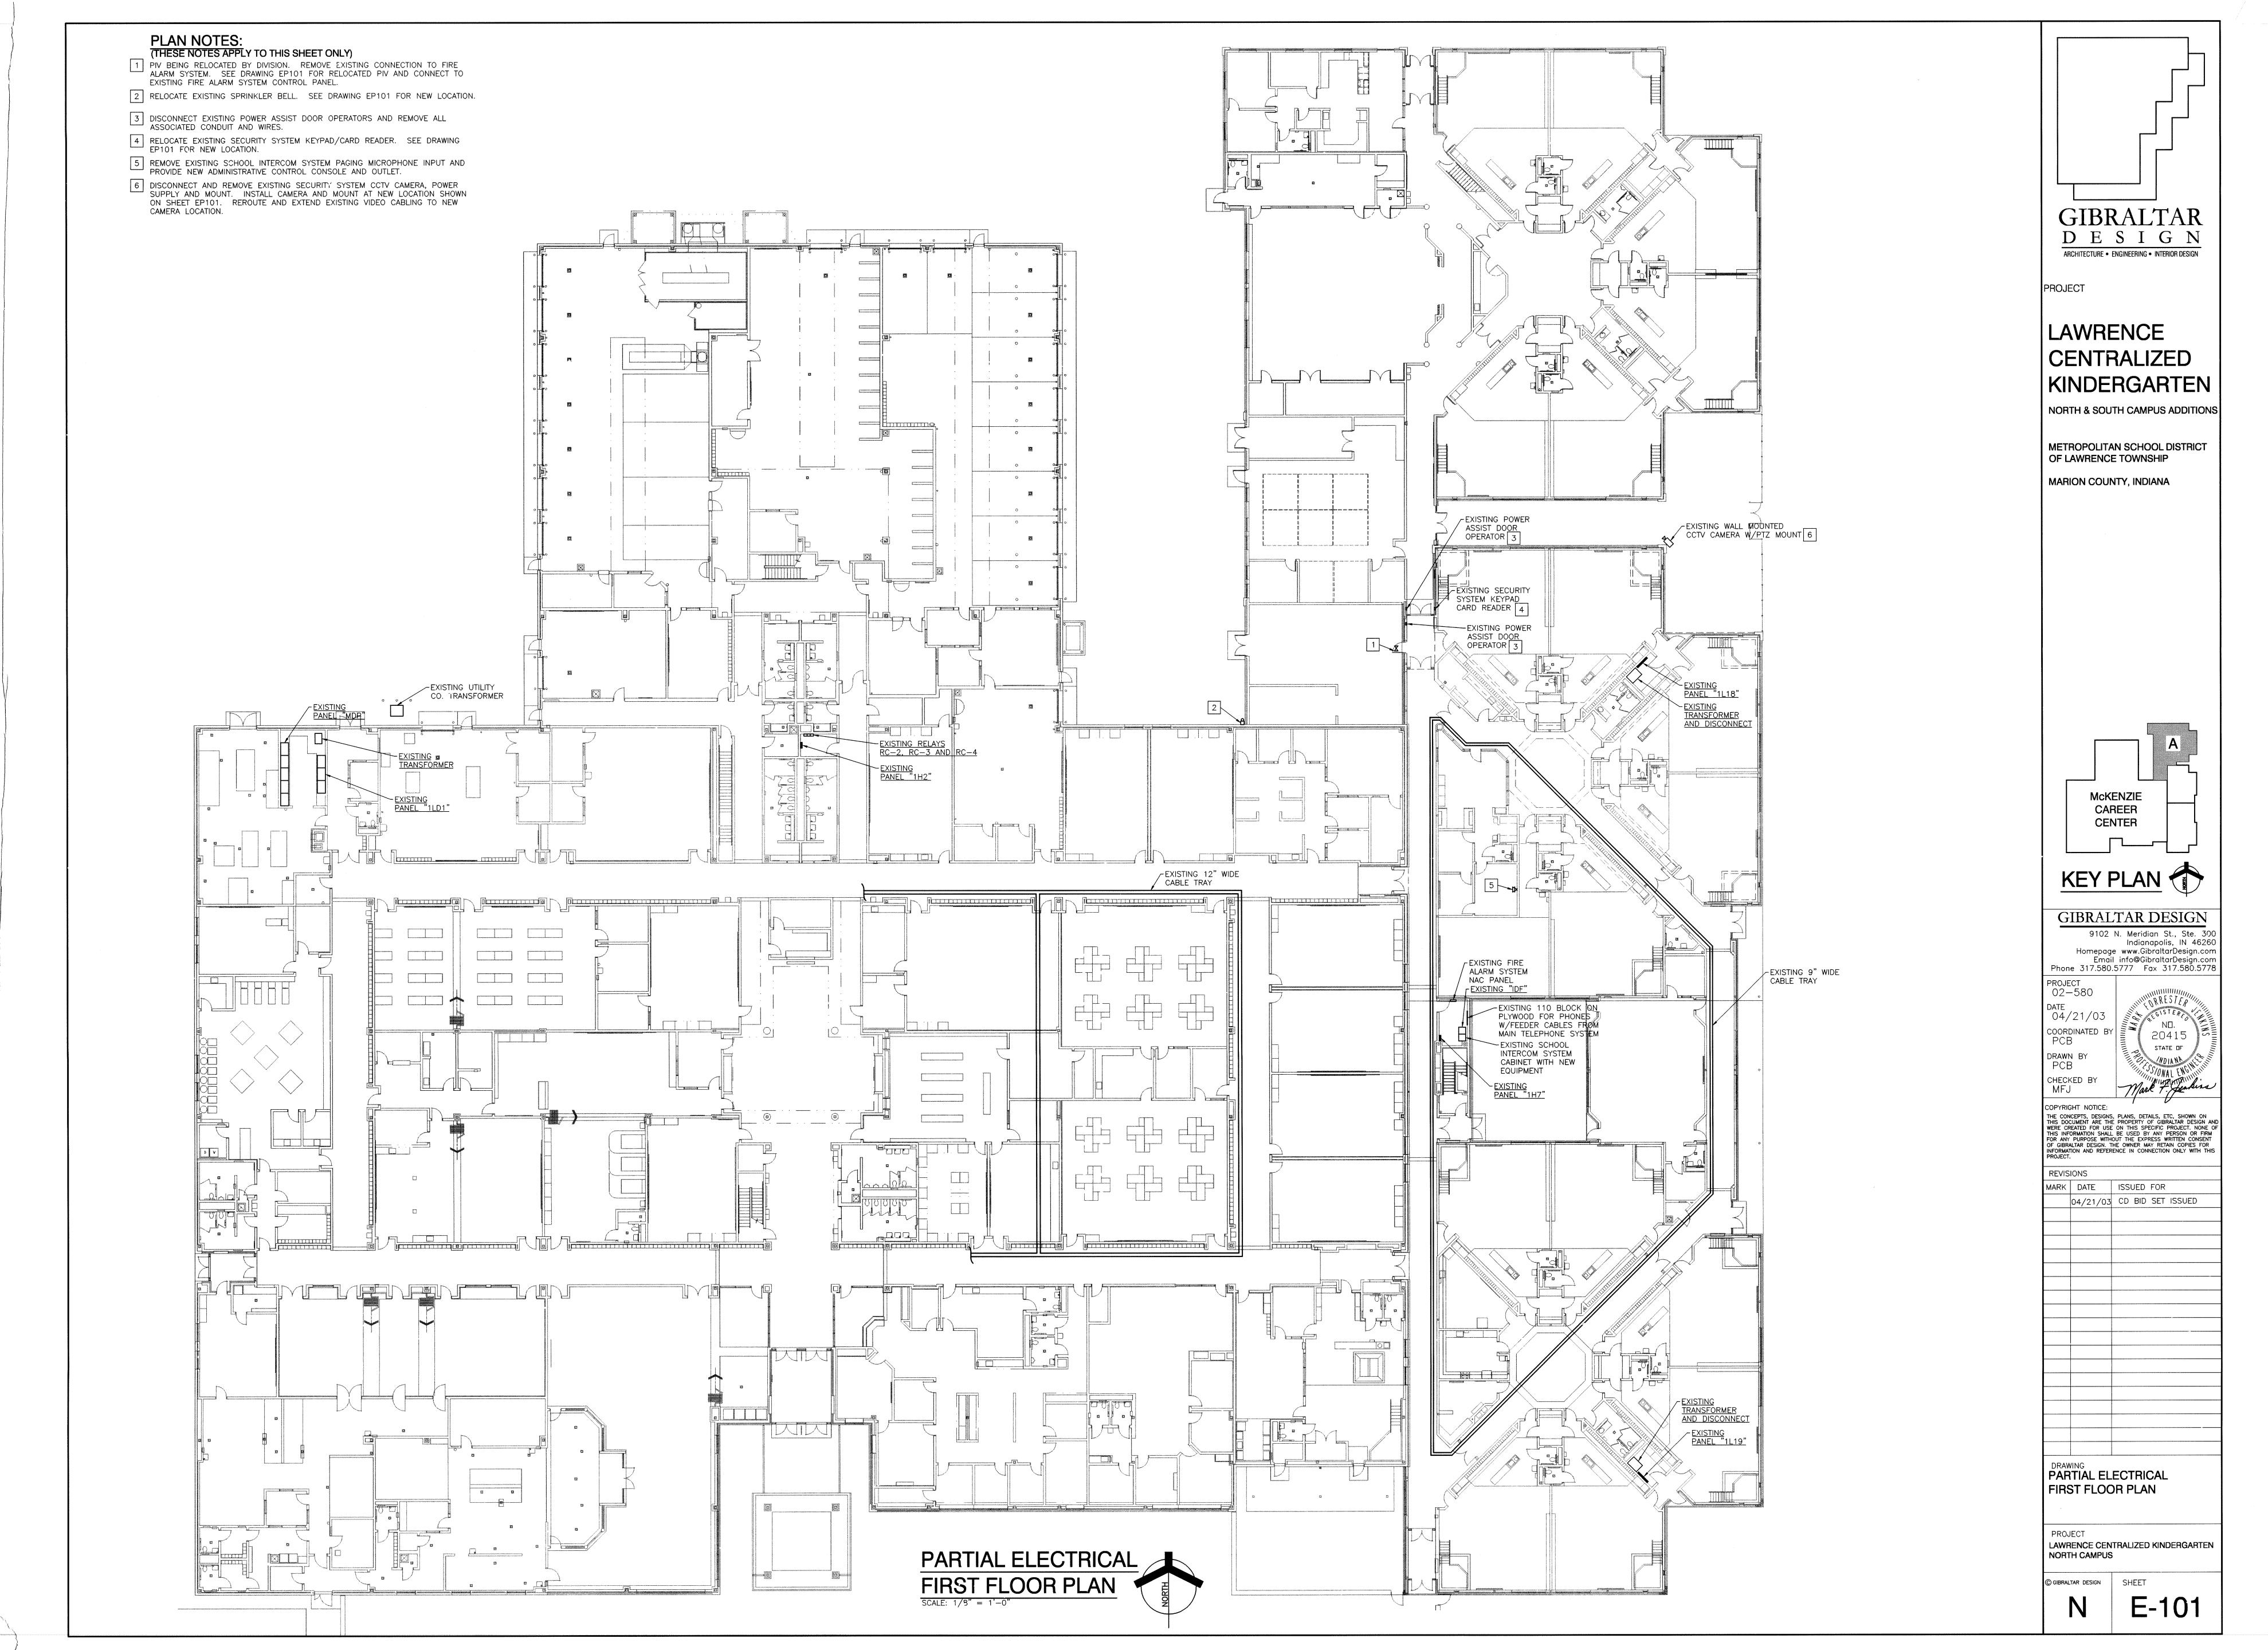


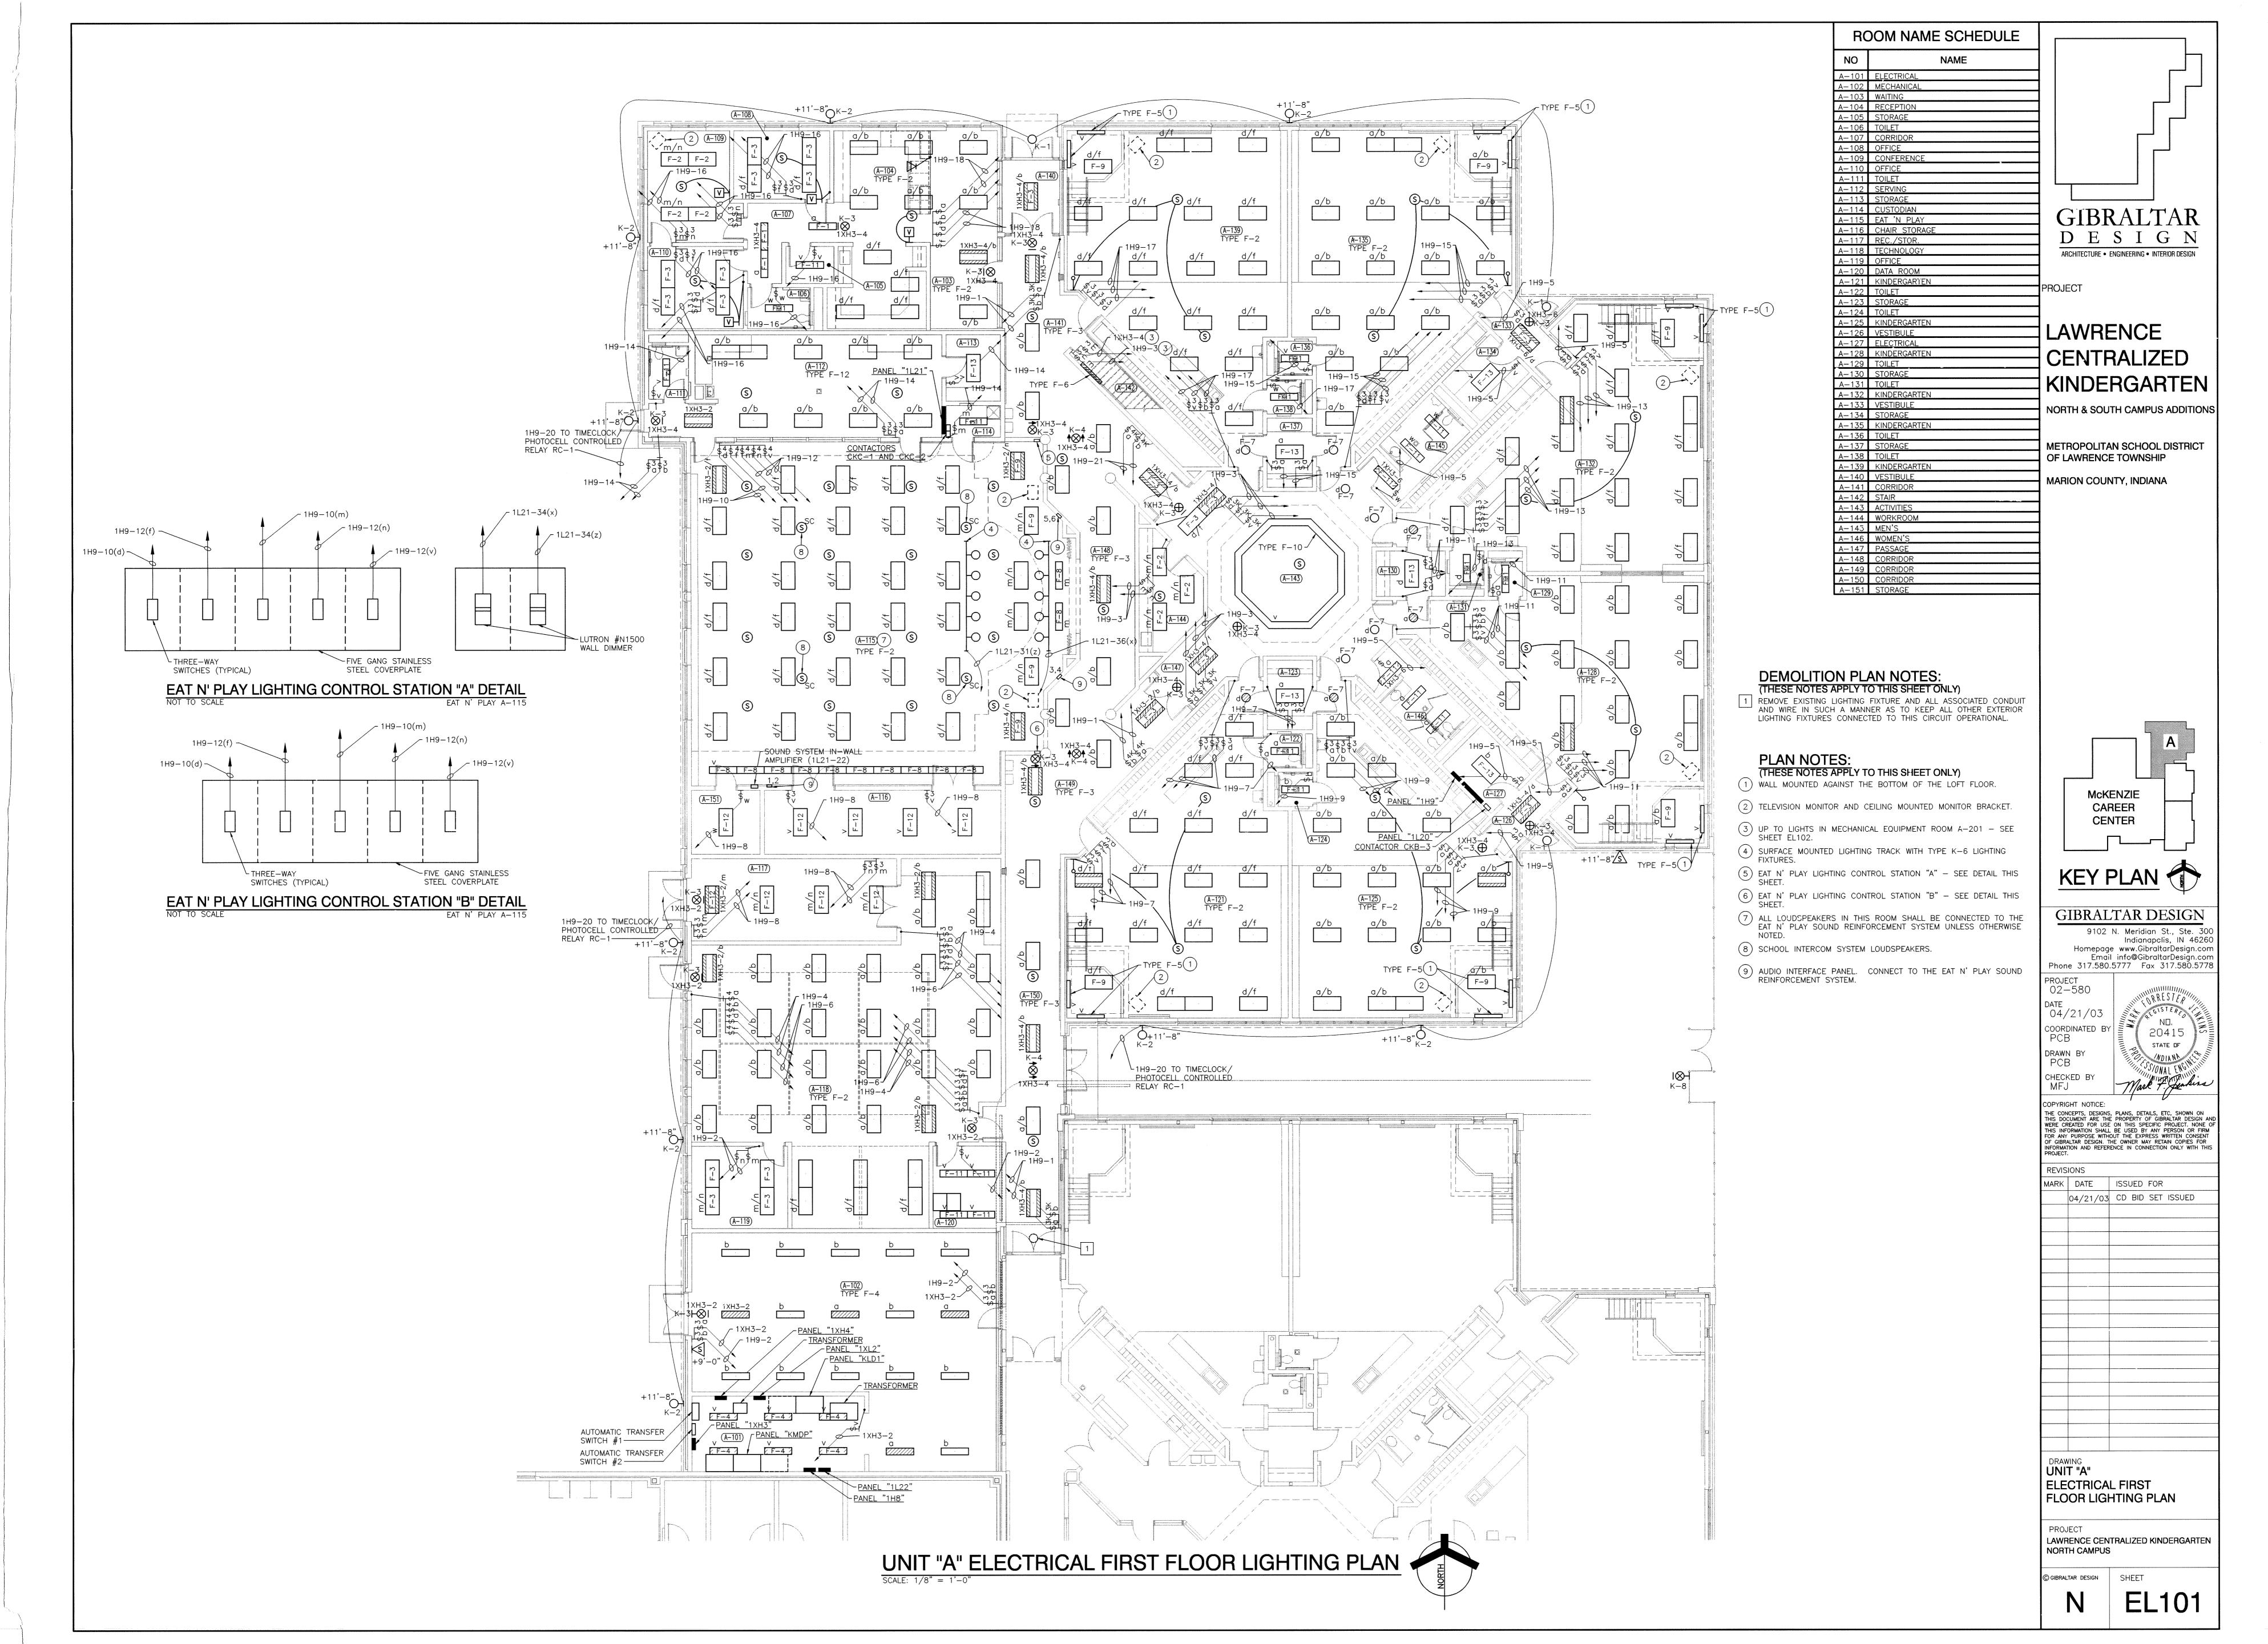

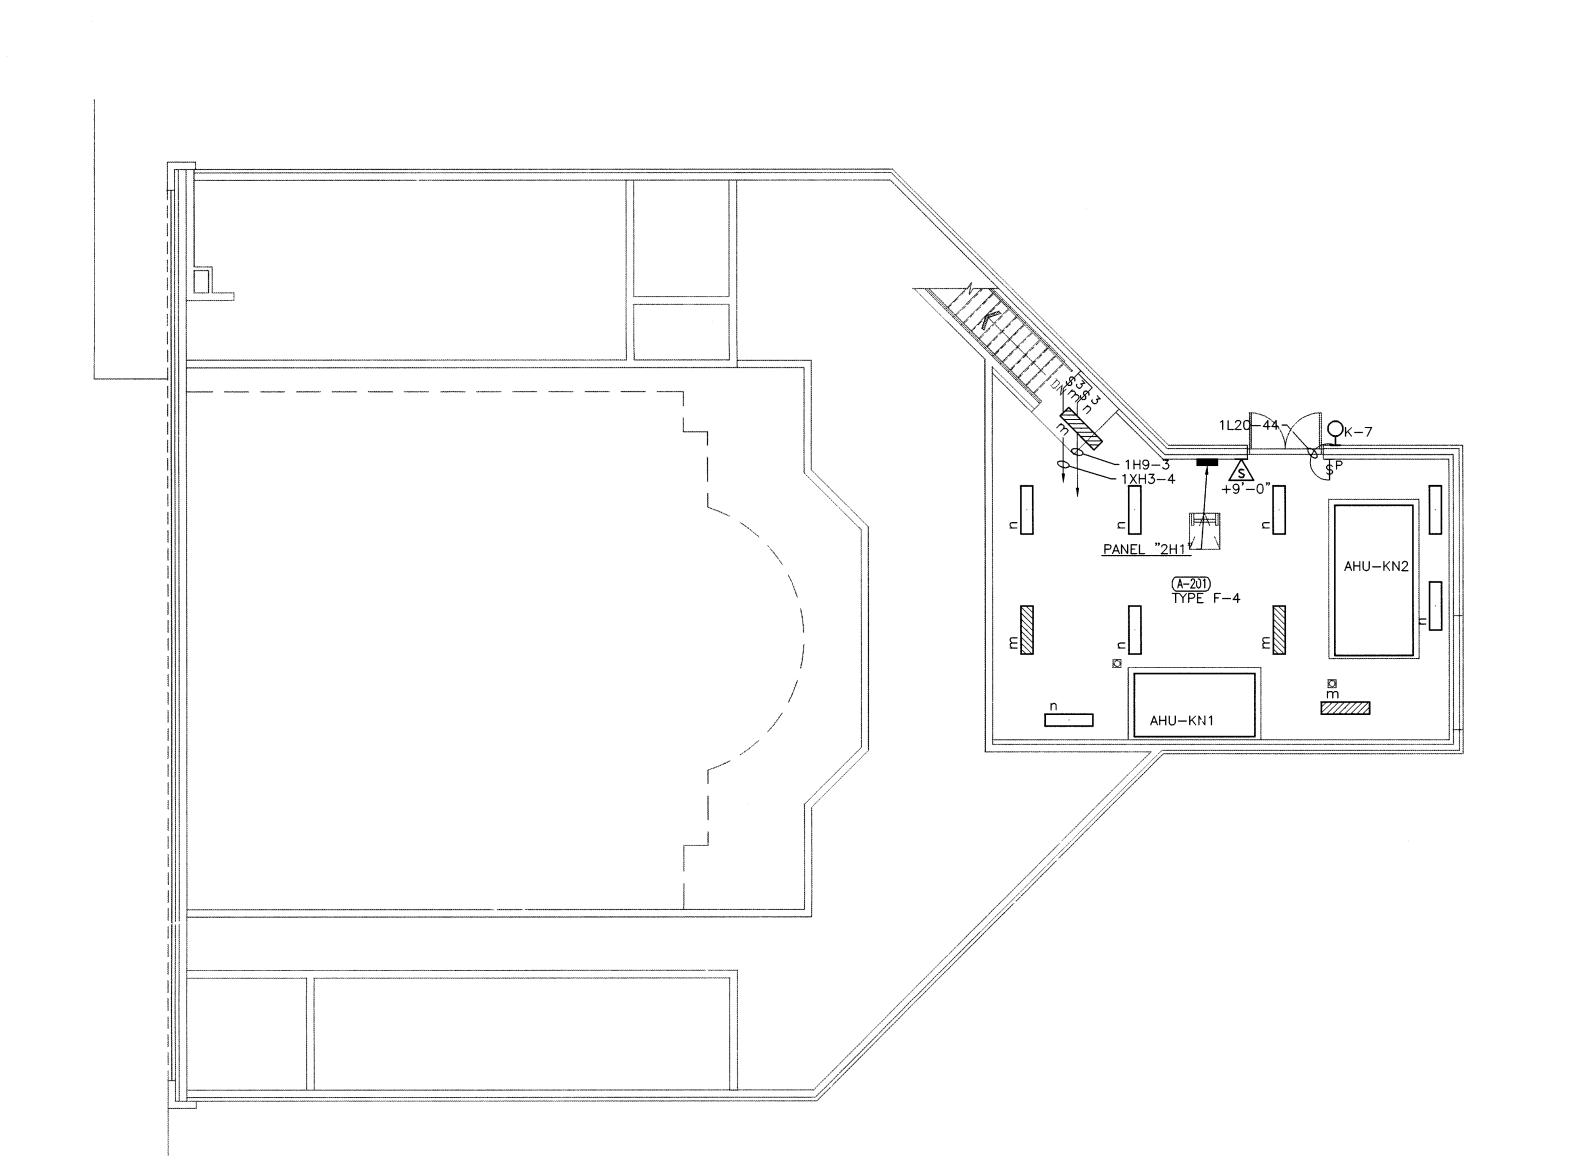



ROOM NAME SCHEDULE
NO NAME

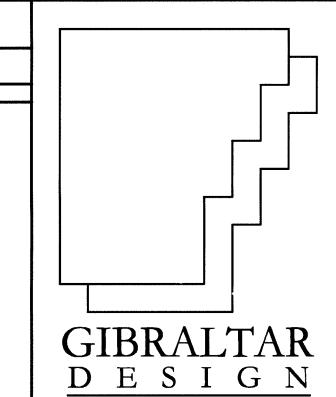


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JJECT

LAWRENCE CENTRALIZED KINDERGARTEN

NORTH & SOUTH CAMPUS ADDITIONS

METROPOLITAN SCHOOL DISTRICT OF LAWRENCE TOWNSHIP MARION COUNTY, INDIANA

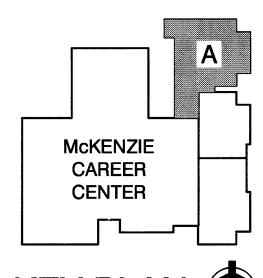

KEY PLAN

GIBRALTAR DESIGN

9102 N. Meridian St., Ste. 300
Indianapolis, IN 46260
Homepage www.GibraltarDesign.com
Email info@GibraltarDesign.com
Phone 317.580.5777 Fax 317.580.5778

PROJECT
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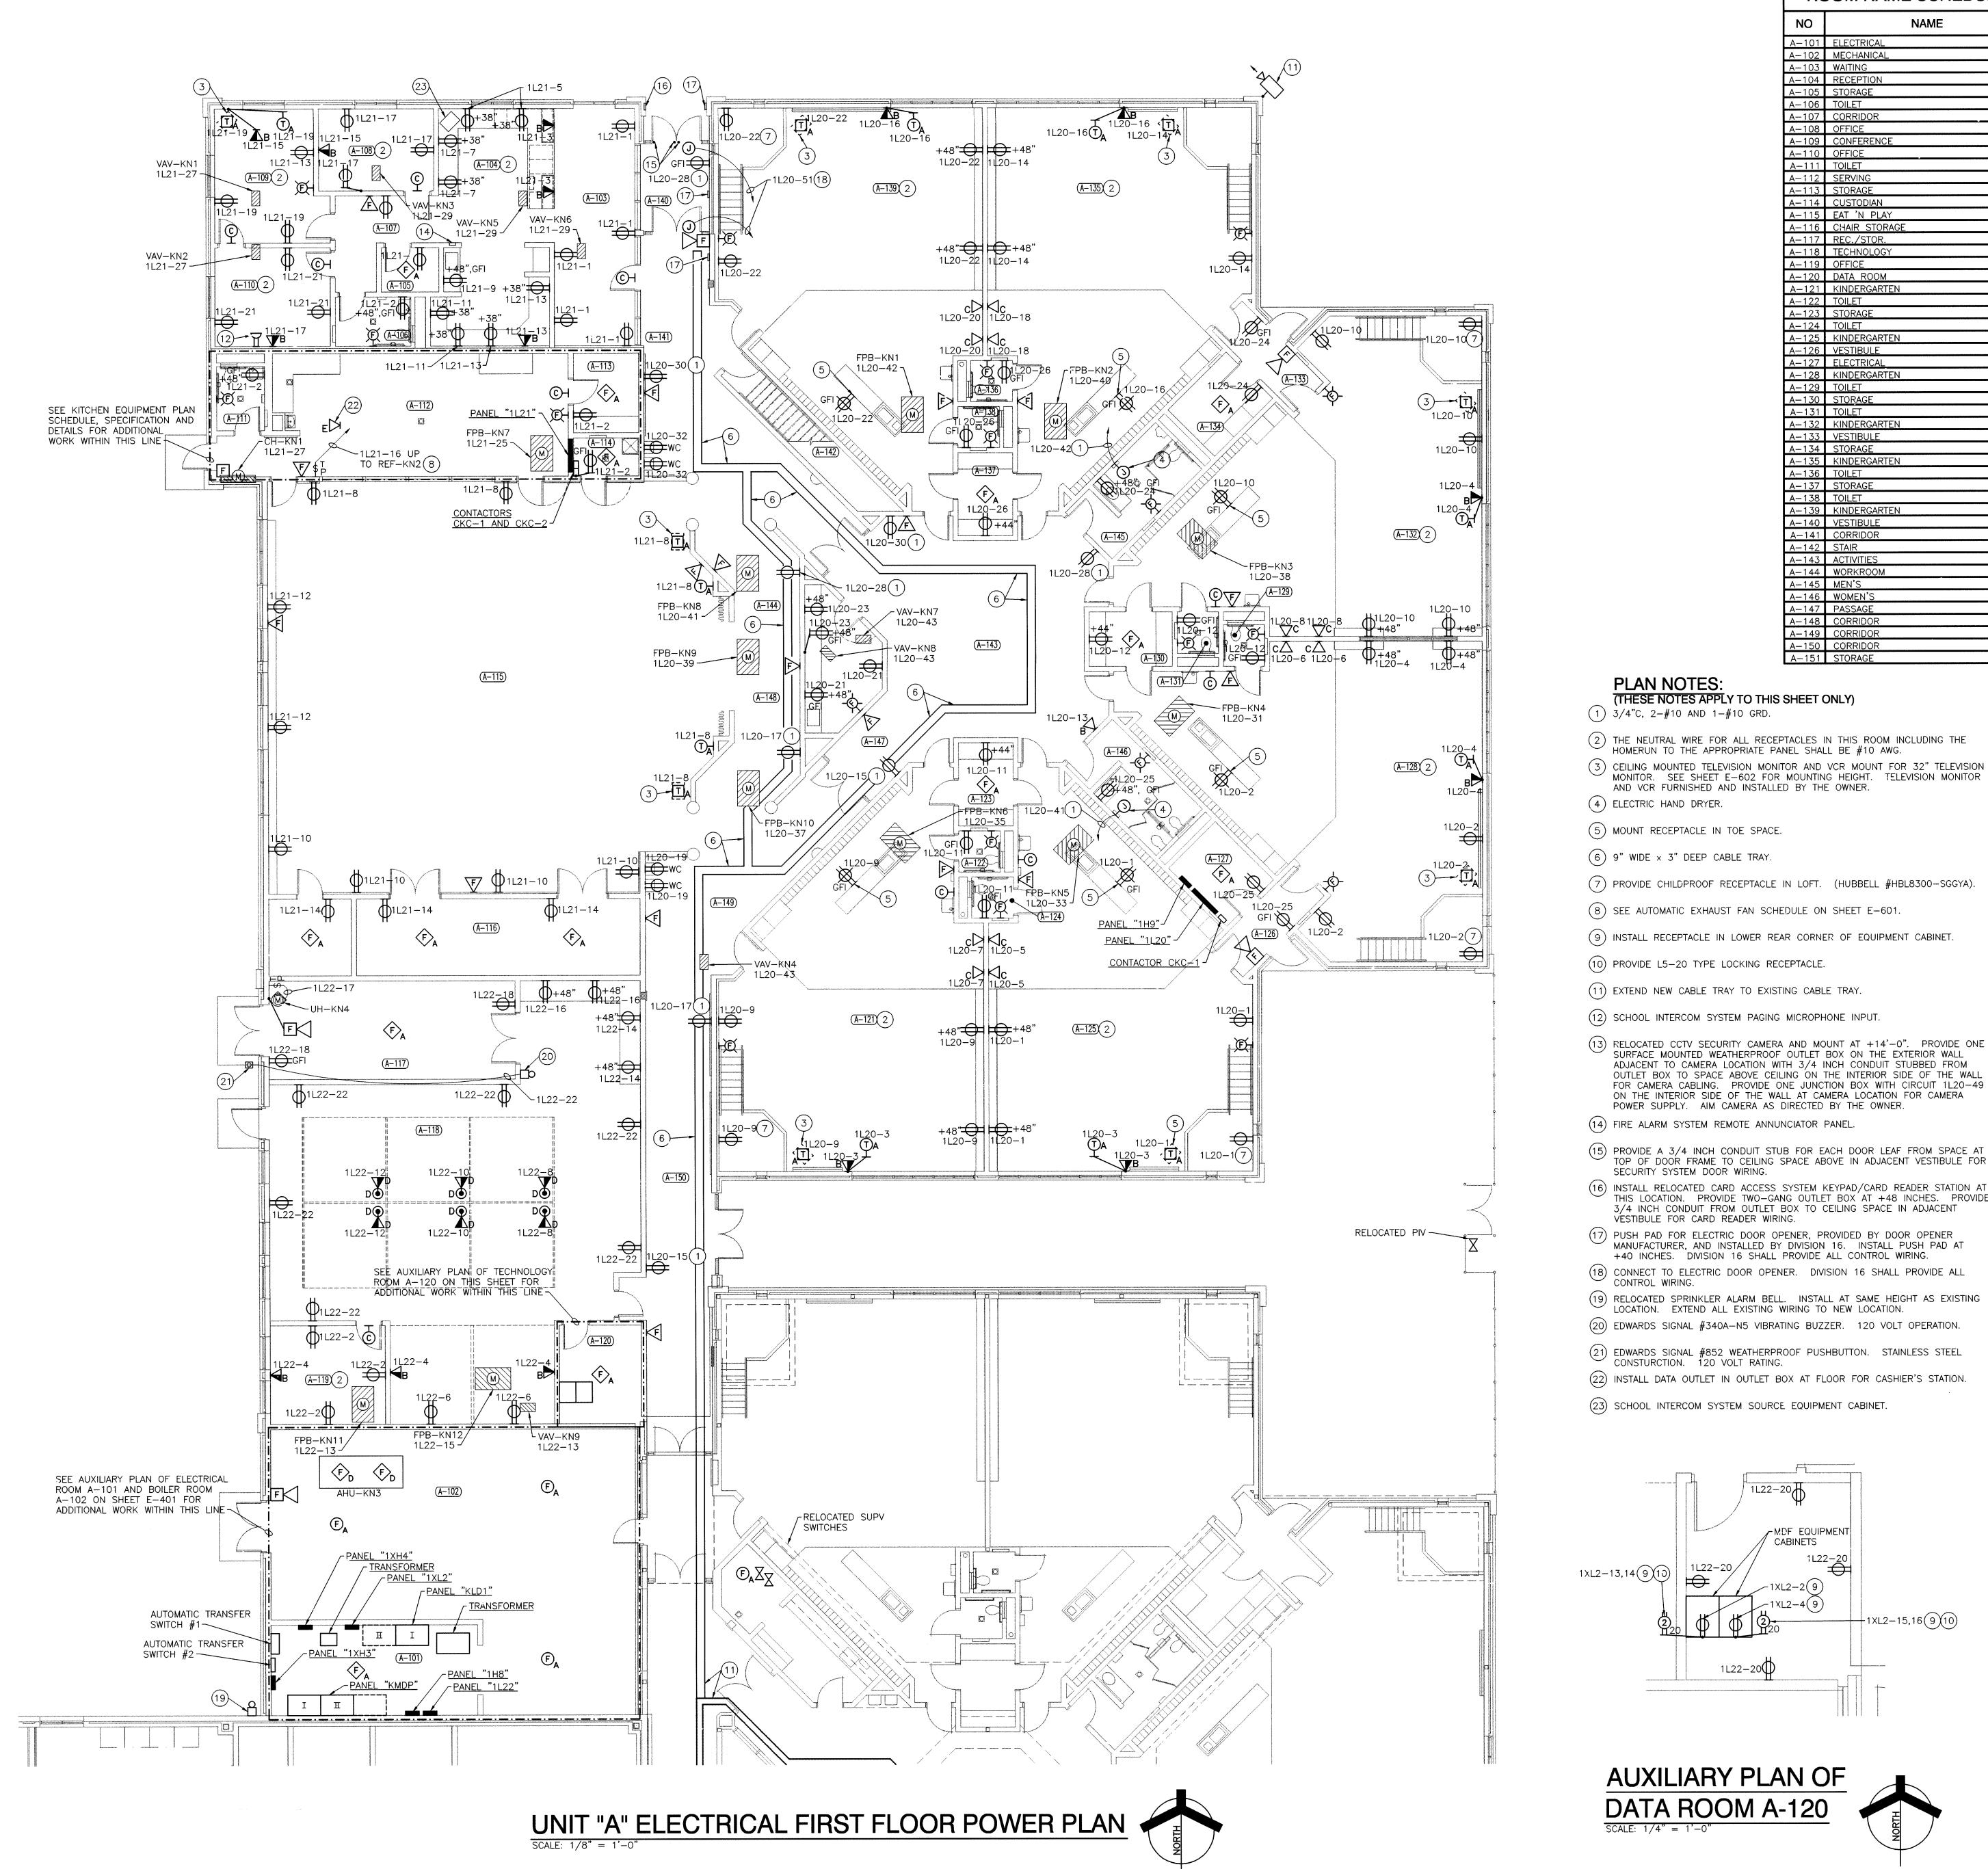
DRAWING
UNIT "A"
ELECTRICAL SECOND
FLOOR LIGHTING PLAN

PROJECT
LAWRENCE CENTRALIZED KINDERGARTEN
NORTH CAMPUS

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SHEET

EL102







(2) THE NEUTRAL WIRE FOR ALL RECEPTACLES IN THIS ROOM INCLUDING THE

- (3) CEILING MOUNTED TELEVISION MONITOR AND VCR MOUNT FOR 32" TELEVISION

- (9) INSTALL RECEPTACLE IN LOWER REAR CORNER OF EQUIPMENT CABINET.
- SURFACE MOUNTED WEATHERPROOF OUTLET BOX ON THE EXTERIOR WALL ADJACENT TO CAMERA LOCATION WITH 3/4 INCH CONDUIT STUBBED FROM OUTLET BOX TO SPACE ABOVE CEILING ON THE INTERIOR SIDE OF THE WALL FOR CAMERA CABLING. PROVIDE ONE JUNCTION BOX WITH CIRCUIT 1L20-49 ON THE INTERIOR SIDE OF THE WALL AT CAMERA LOCATION FOR CAMERA POWER SUPPLY. AIM CAMERA AS DIRECTED BY THE OWNER.
- 15) PROVIDE A 3/4 INCH CONDUIT STUB FOR EACH DOOR LEAF FROM SPACE AT TOP OF DOOR FRAME TO CEILING SPACE ABOVE IN ADJACENT VESTIBULE FOR
- (16) INSTALL RELOCATED CARD ACCESS SYSTEM KEYPAD/CARD READER STATION AT THIS LOCATION. PROVIDE TWO-GANG OUTLET BOX AT +48 INCHES. PROVIDE 3/4 INCH CONDUIT FROM OUTLET BOX TO CEILING SPACE IN ADJACENT
- (17) PUSH PAD FOR ELECTRIC DOOR OPENER, PROVIDED BY DOOR OPENER MANUFACTURER, AND INSTALLED BY DIVISION 16. INSTALL PUSH PAD AT +40 INCHES. DIVISION 16 SHALL PROVIDE ALL CONTROL WIRING.
- (19) RELOCATED SPRINKLER ALARM BELL. INSTALL AT SAME HEIGHT AS EXISTING LOCATION. EXTEND ALL EXISTING WIRING TO NEW LOCATION.
- (20) EDWARDS SIGNAL #340A-N5 VIBRATING BUZZER. 120 VOLT OPERATION.

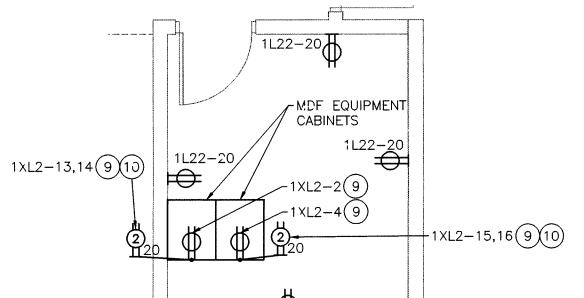

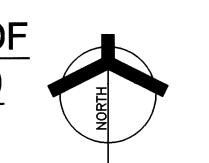



Email info@GibraltarDesign.com Phone 317.580.5777 Fax 317.580.5778

PROJECT 02-580	WILLIAM DECT
DATE 04/21/03	THE OKRESTER
COORDINATED BY PCB	20415
DRAWN BY PCB	NO. 20415 STATE OF ST
CHECKED BY MFJ	Mark T. Jean
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DRAWING UN!T "A" ELECTRICAL FIRST FLOOR POWER PLAN

LAWRENCE CENTRALIZED KINDERGARTEN NORTH CAMPUS

GIBRALTAR DESIGN

EP101

PLAN NOTES: (THESE NOTES APPLY TO THIS SHEET ONLY) 1) VARIABLE FREQUENCY DRIVE CONTROLLER BY DIVISION 15.

2 PROVIDE THE APPROPRIATE STRUCTURAL STEEL CHANNEL SUPPORTS FOR MOTOR STARTERS.

ROOM NAME SCHEDULE

A-201 MECHANICAL

GIBRALTAR D E S I G N

PROJECT


LAWRENCE CENTRALIZED KINDERGARTEN

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NORTH & SOUTH CAMPUS ADDITIONS

METROPOLITAN SCHOOL DISTRICT OF LAWRENCE TOWNSHIP

MARION COUNTY, INDIANA

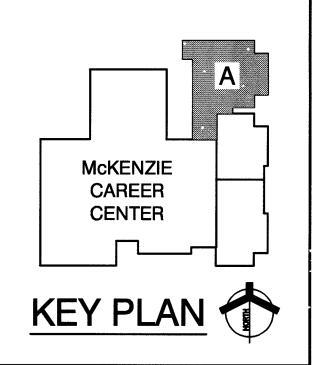

GIBRALTAR DESIGN 9102 N. Meridian St., Ste. 300 Indianapolis, IN 46260
Homepage www.GibraltarDesign.com
Email info@GibraltarDesign.com
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02-580 04/21/03 COORDINATED BY DRAWN BY PCB CHECKED BY


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MARK	DATE	ISSU	JED	FOR	
	04/21/03	CD	BID	SET	ISSUED


DRAWING UNIT "A" ELECTRICAL SECOND FLOOR POWER PLAN


LAWRENCE CENTRALIZED KINDERGARTEN NORTH CAMPUS

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UNIT "A" ELECTRICAL SECOND FLOOR POWER PLAN SCALE: 1/8" == 1'-0"



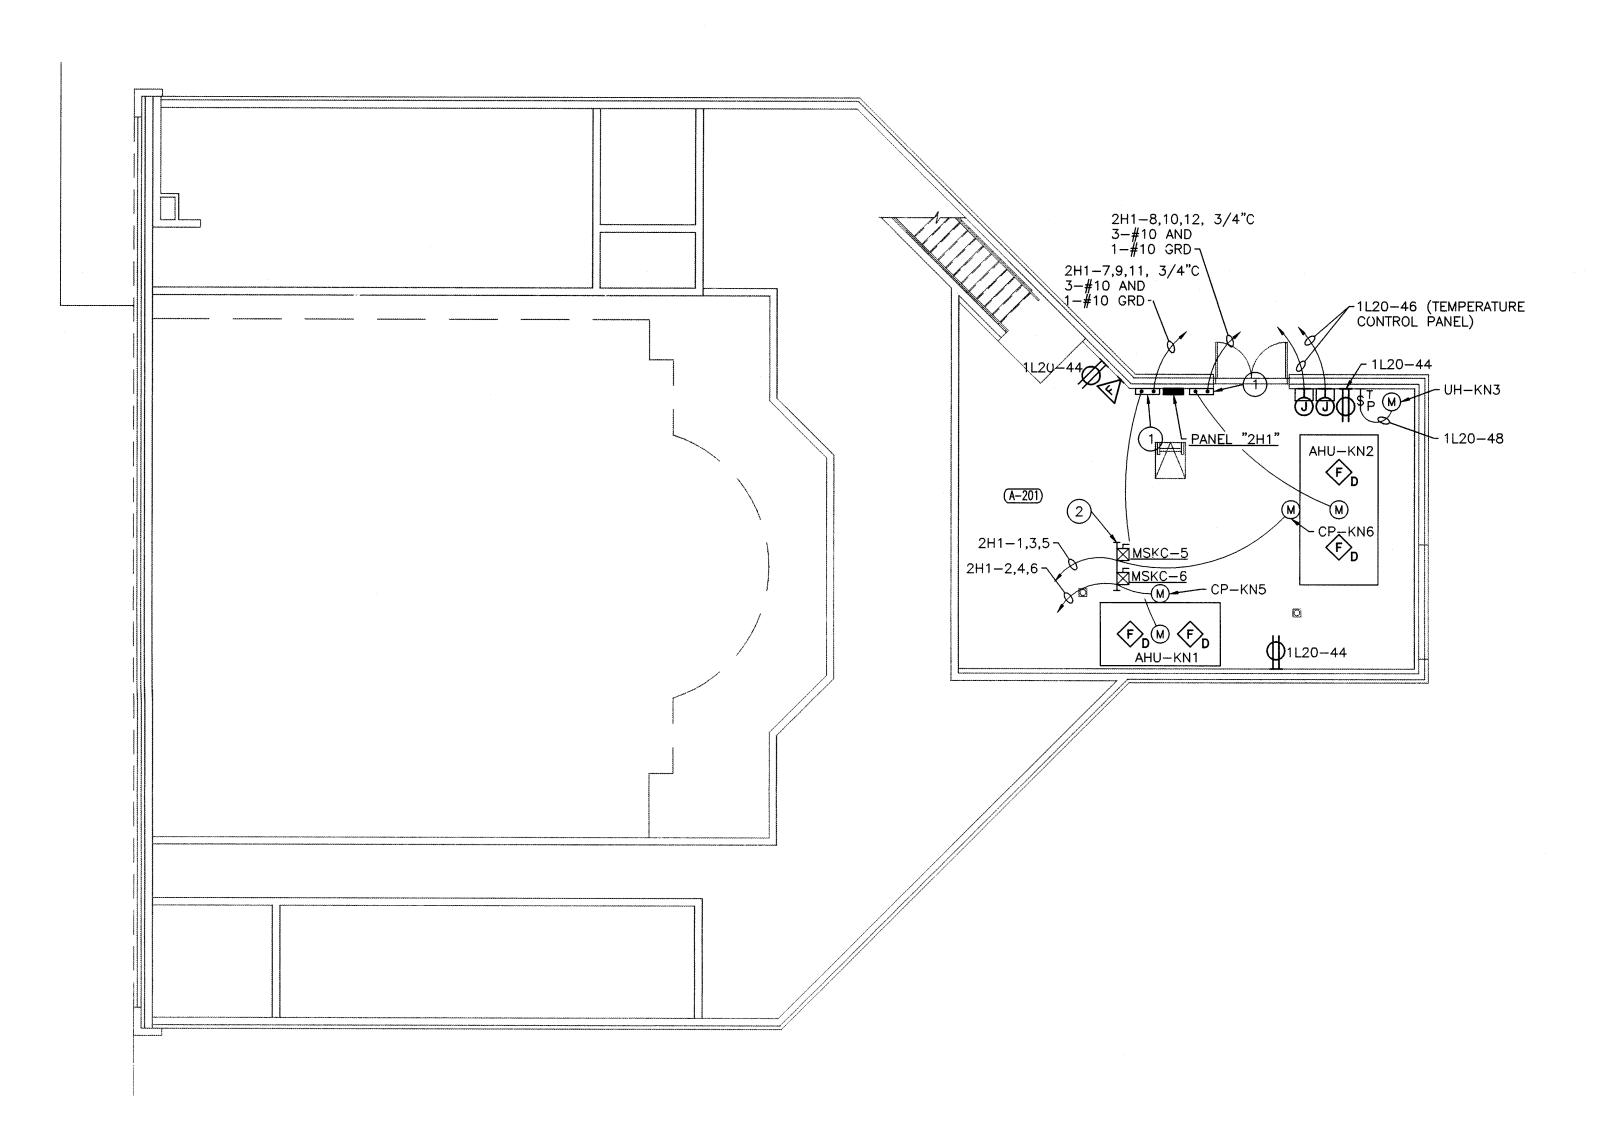

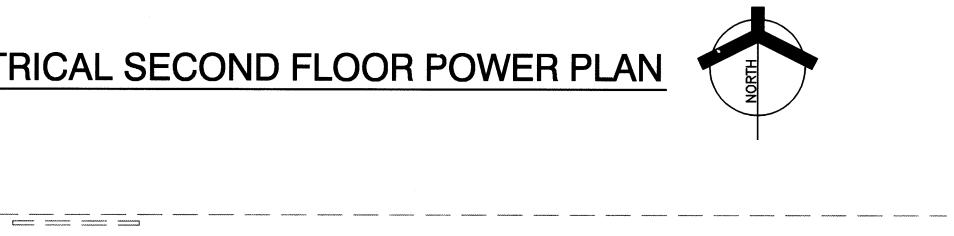
DEMOLITION PLAN NOTES: (THESE NOTES APPLY TO THIS SHEET ONLY)

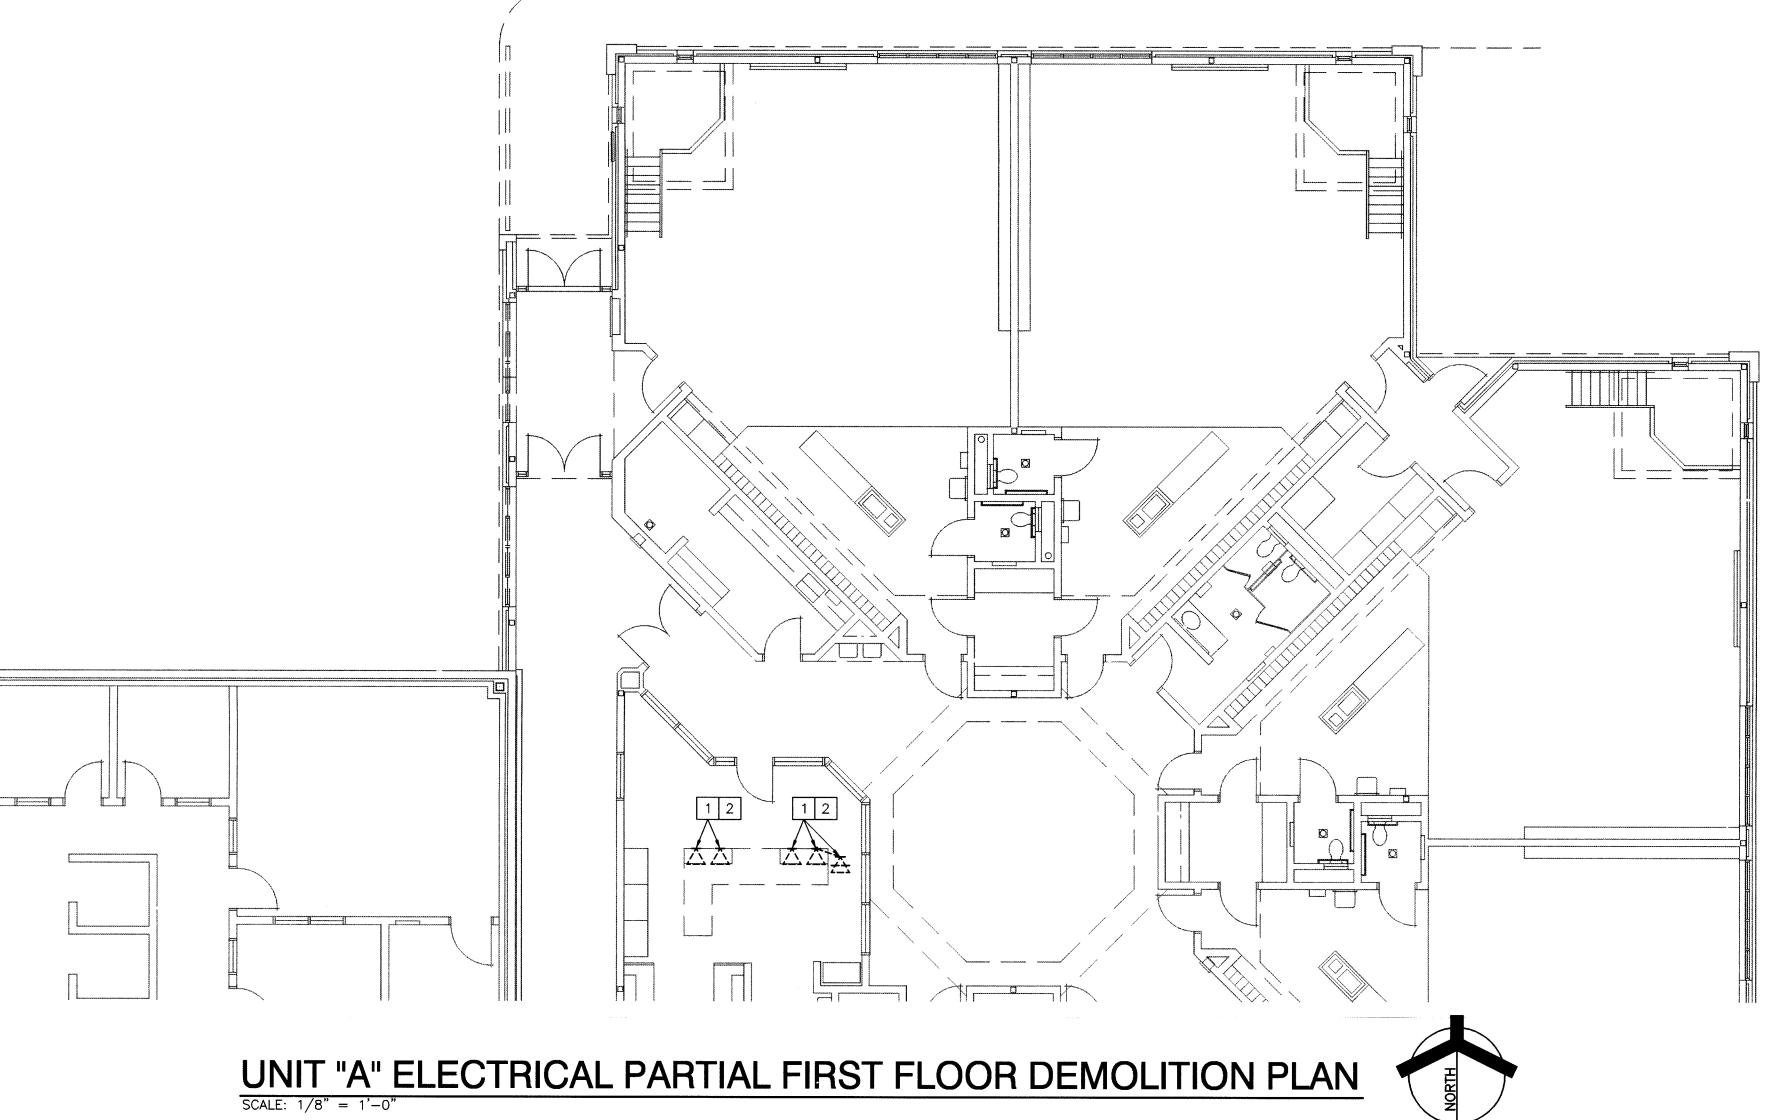- 1 REMOVE EXISTING VOICE AND DATA OUTLETS, JACKS AND WIRING BACK TO SOURCE. CUT OFF CONDUITS FLUSH WITH FLOOR AND PATCH AND REPAIR FLOOR SURFACES. ABANDON CONDUITS CONCEALED IN FLOORS AND WALLS AND REMOVE ALL OTHER ASSOCIATED CONDUITS.
- 2 REMOVE EXISTING POWER OUTLETS AND ALL ASSOCIATED WIRING BACK TO SOURCE IN SUCH A MANNER AS TO ALLOW ANY OTHER DEVICES CONNECTED TO CIRCUIT TO REMAIN IN SERVICE. ABANDON CONDUITS CONCEALED IN FLOORS AND WALLS AND REMOVE ALL OTHER ASSOCIATED CONDUITS.


PLAN NOTES:
(THESE NOTES APPLY TO THIS SHEET ONLY)

1 VARIABLE FREQUENCY DRIVE CONTROLLER BY DIVISION 15.

2 SEE POWER DISTRIBUTION DIAGRAM FOR CIRCUITING.

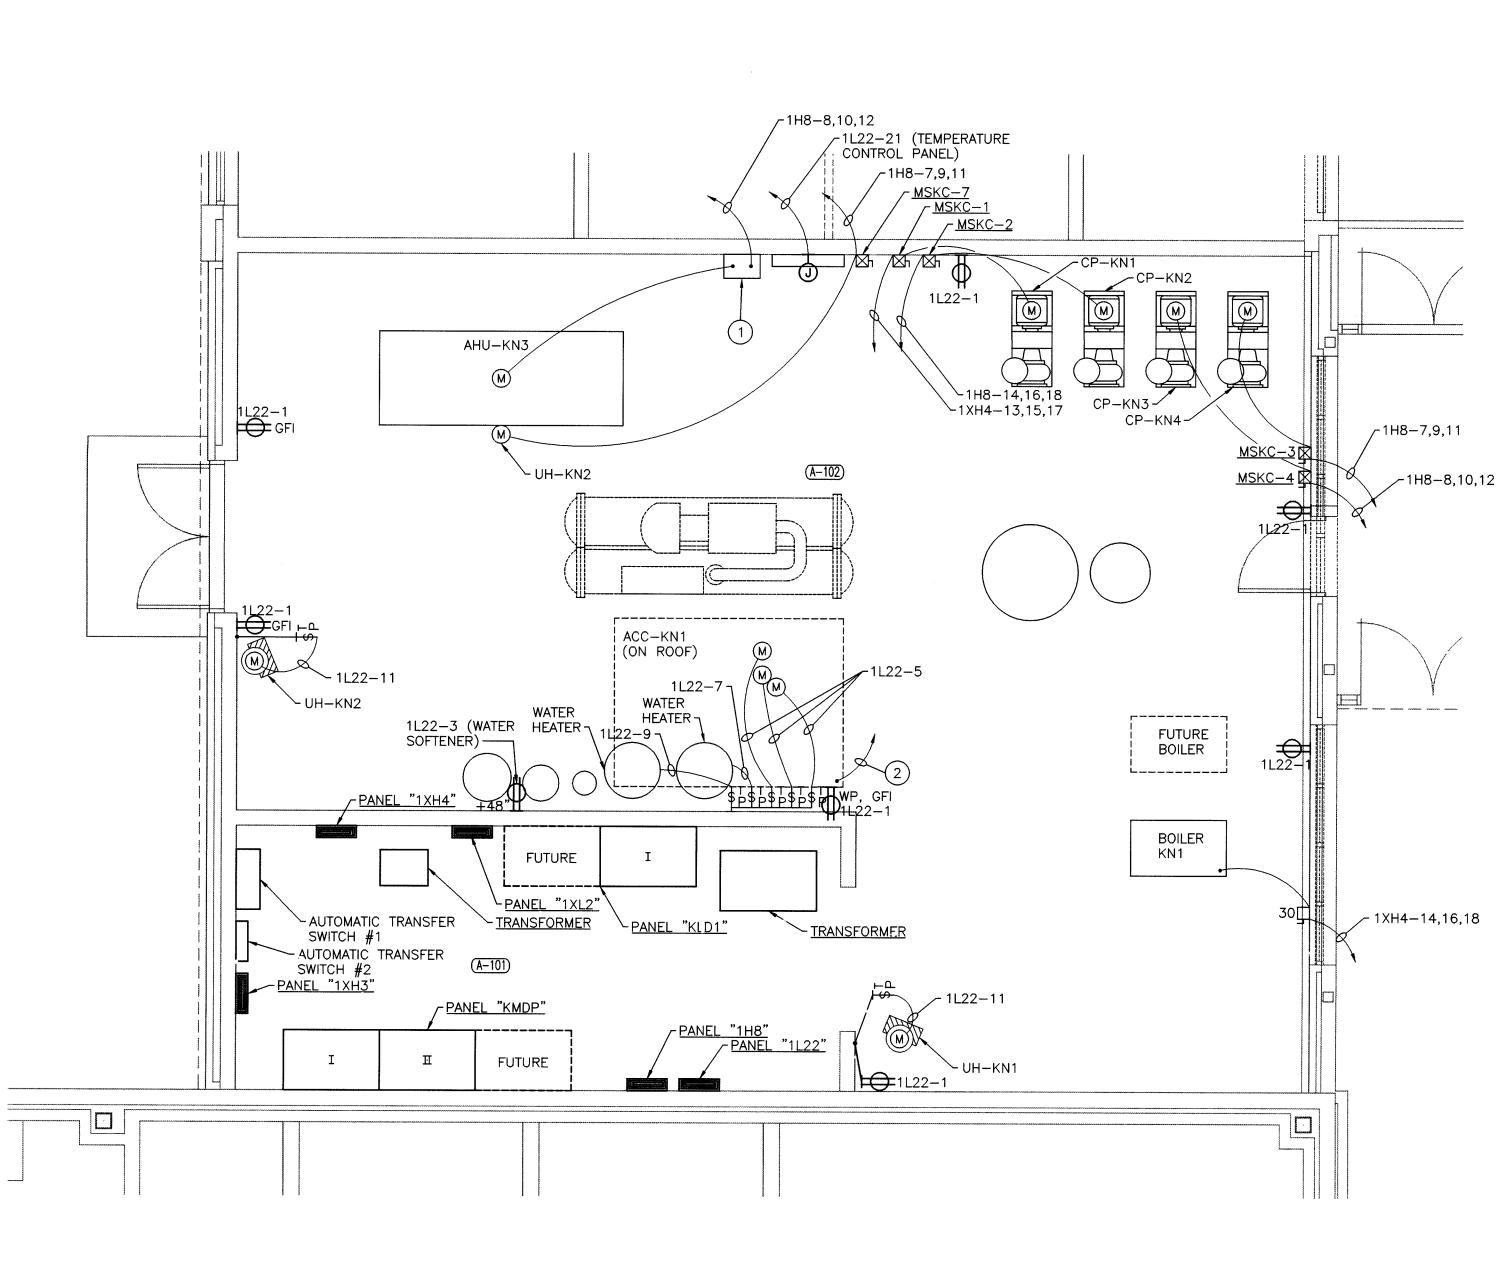



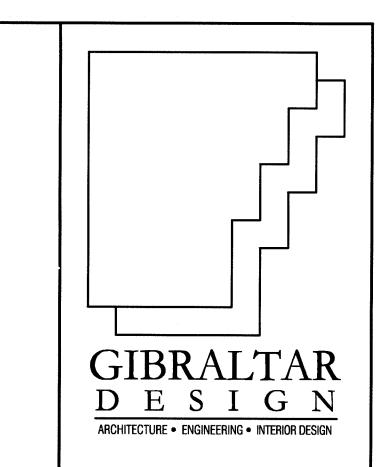


PROJECT

LAWRENCE CENTRALIZED KINDERGARTEN

NORTH & SOUTH CAMPUS ADDITIONS

METROPOLITAN SCHOOL DISTRICT
OF LAWRENCE TOWNSHIP
MARION COUNTY, INDIANA

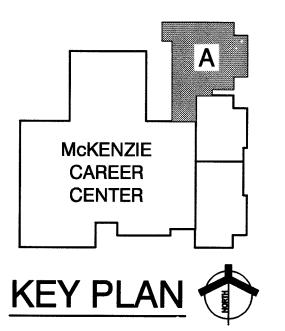

GIBRALTAR DESIGN

9102 N. Meridian St., Ste. 300
Indianapolis, IN 46260
Homepage www.GibraltarDesign.com
Email info@GibraltarDesign.com
Phone 317.580.5777 Fax 317.580.5778

PROJECT
02-580

DATE
04/21/03

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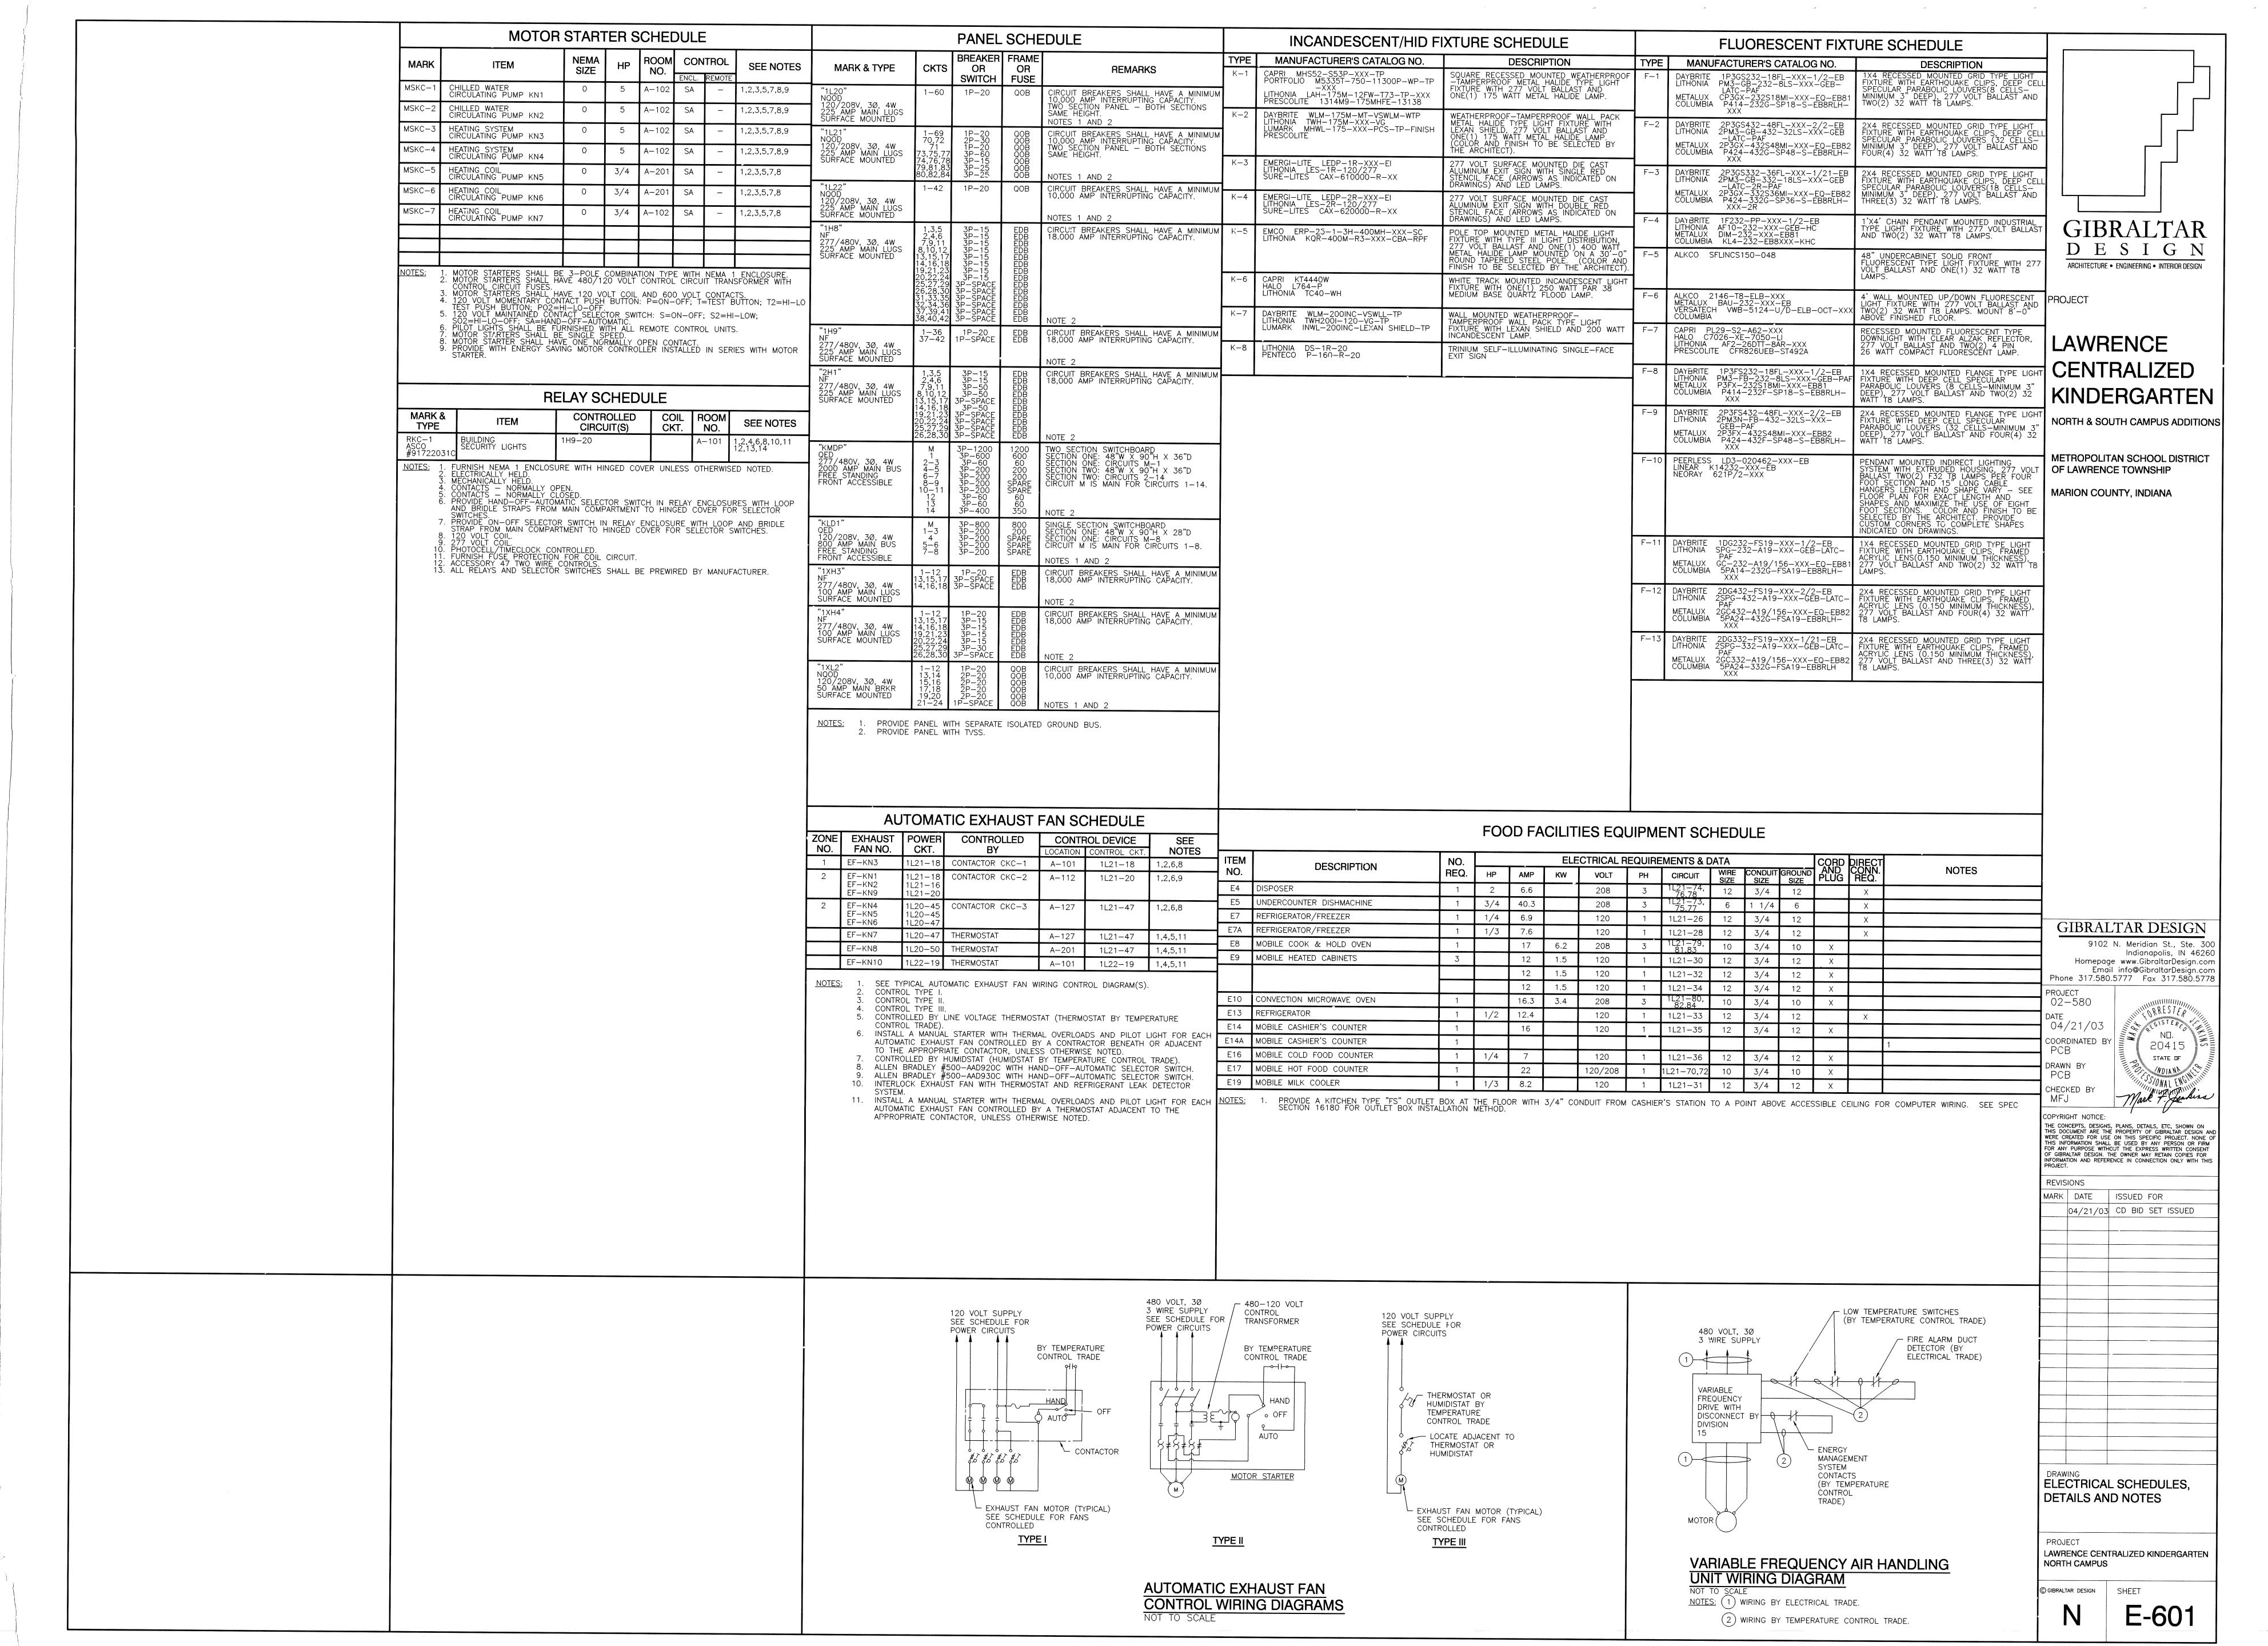
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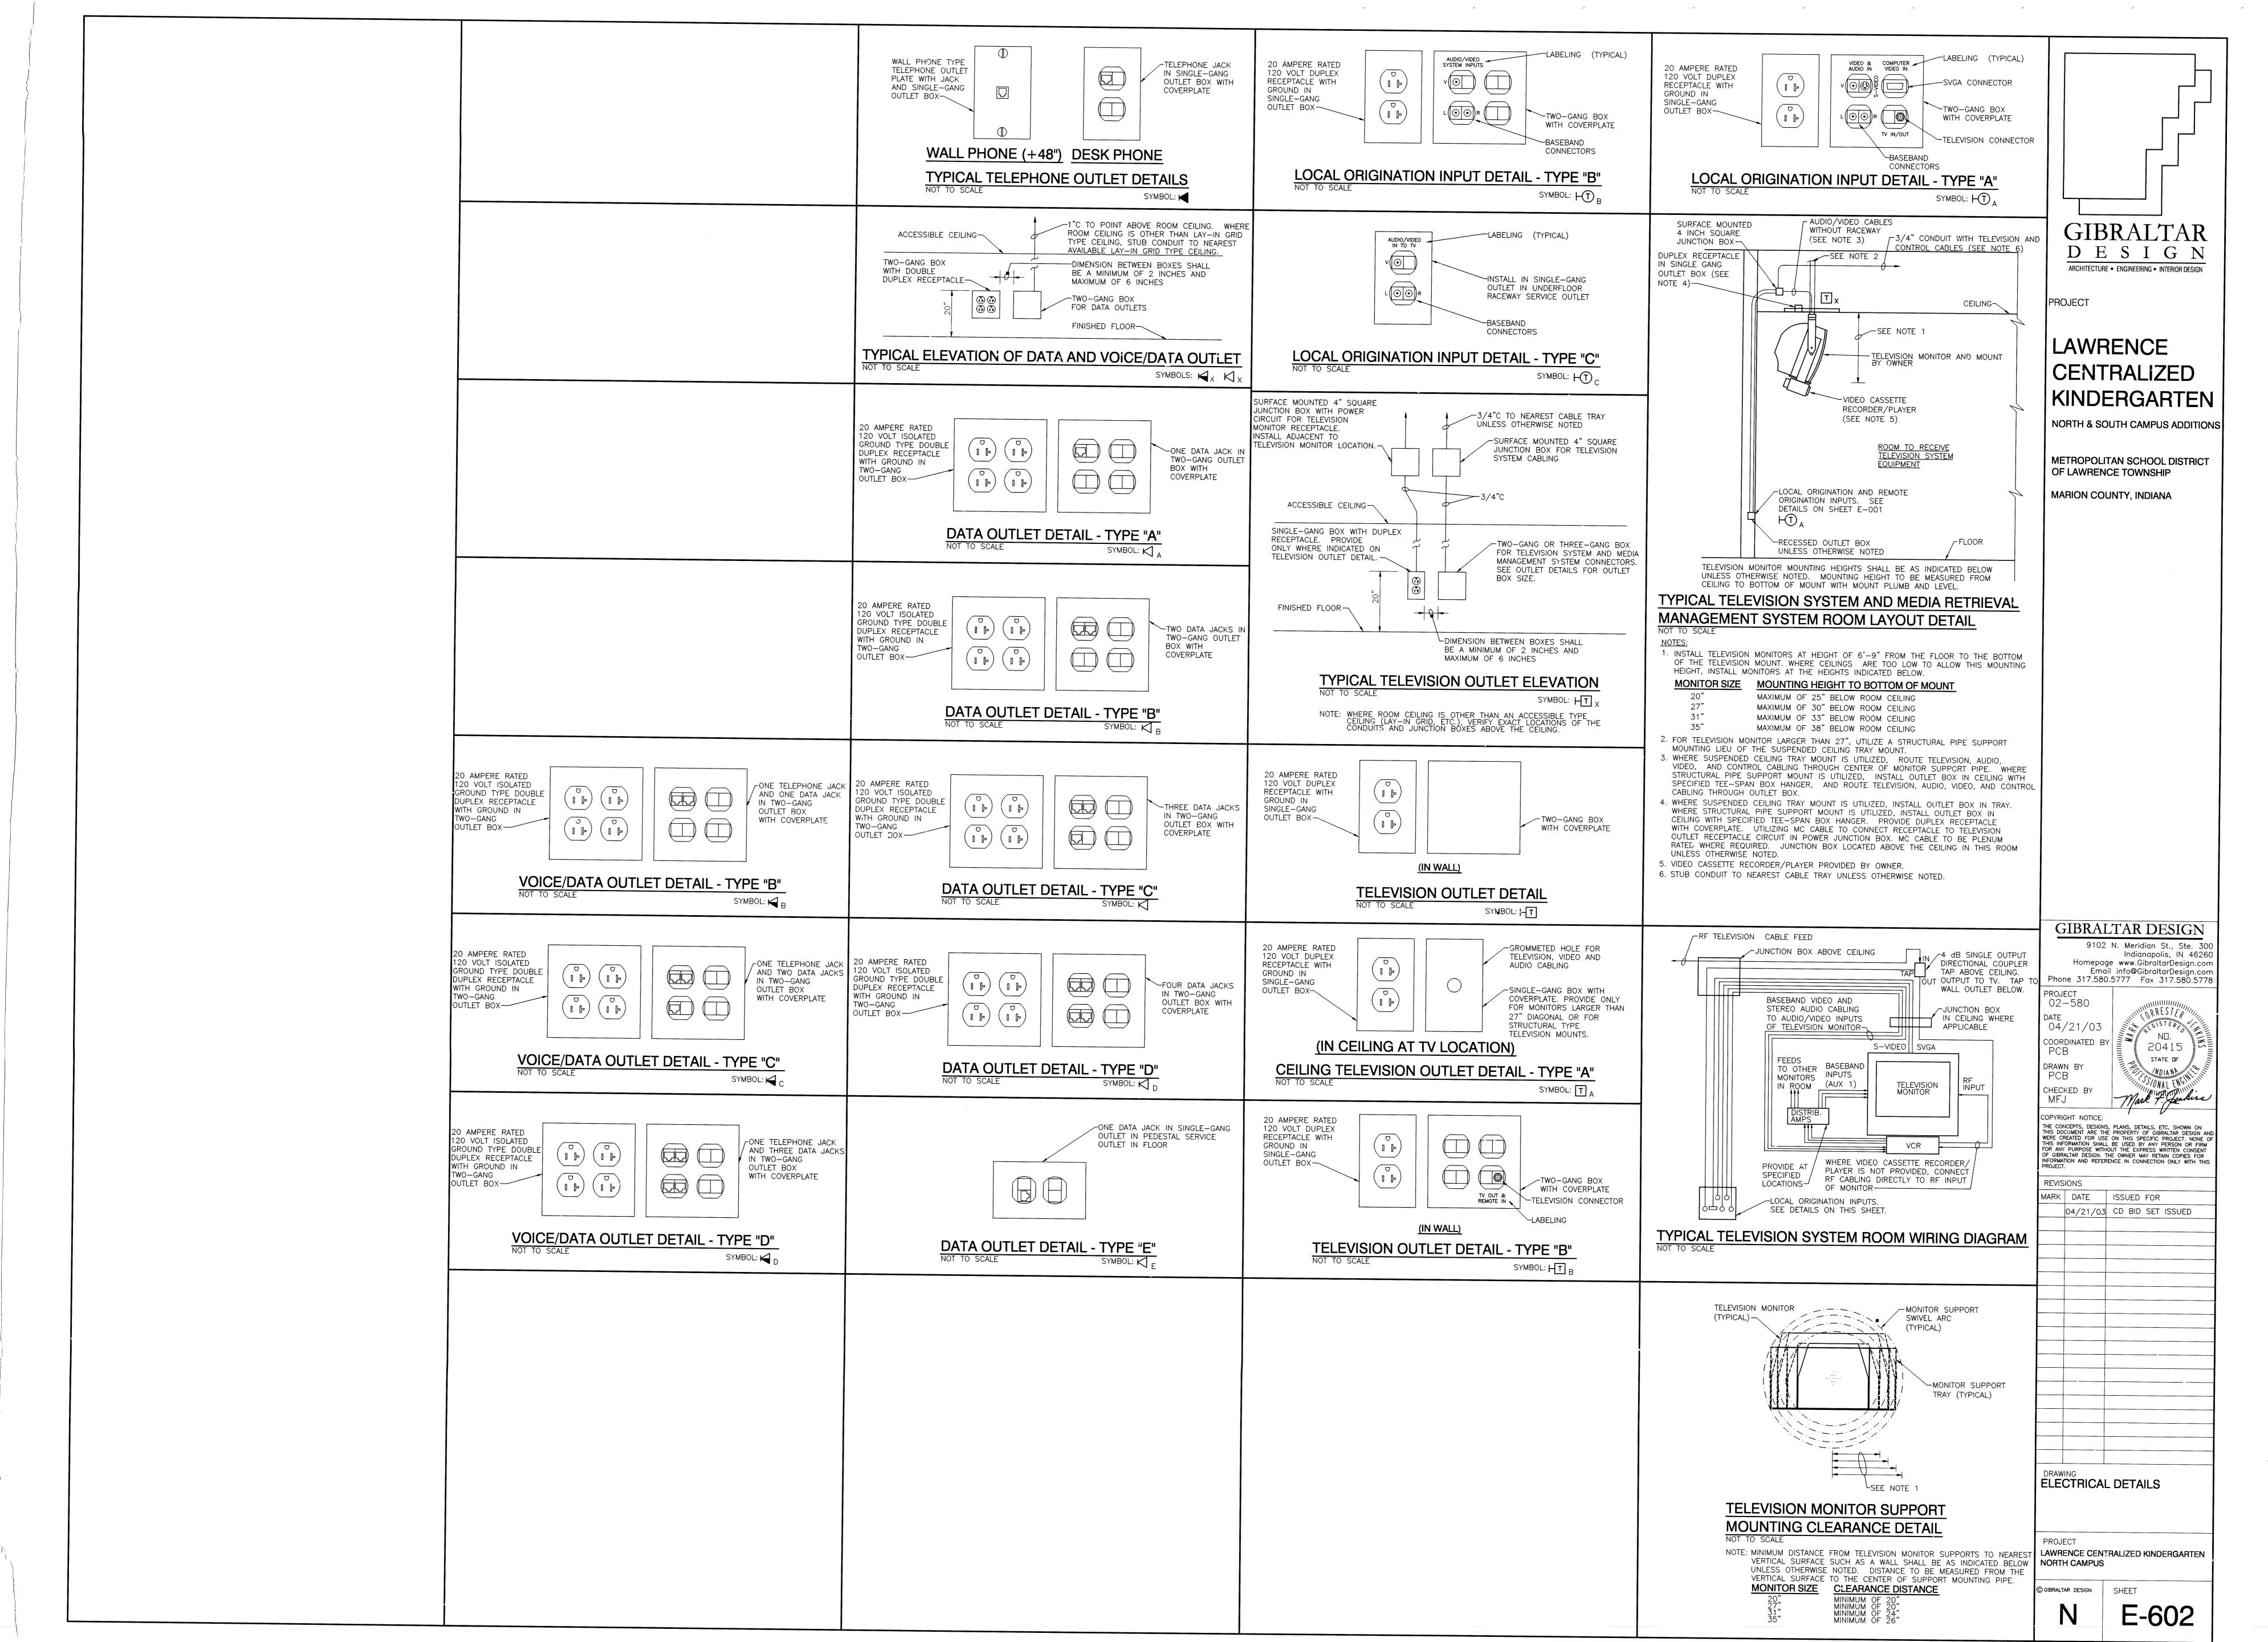
DRAWING
ELECTRICAL
AUXILIARY PLAN OF
ELECTRICAL ROOM A-101
AND BOILER ROOM A-102
PROJECT


LAWRENCE CENTRALIZED KINDERGARTEN
NORTH CAMPUS

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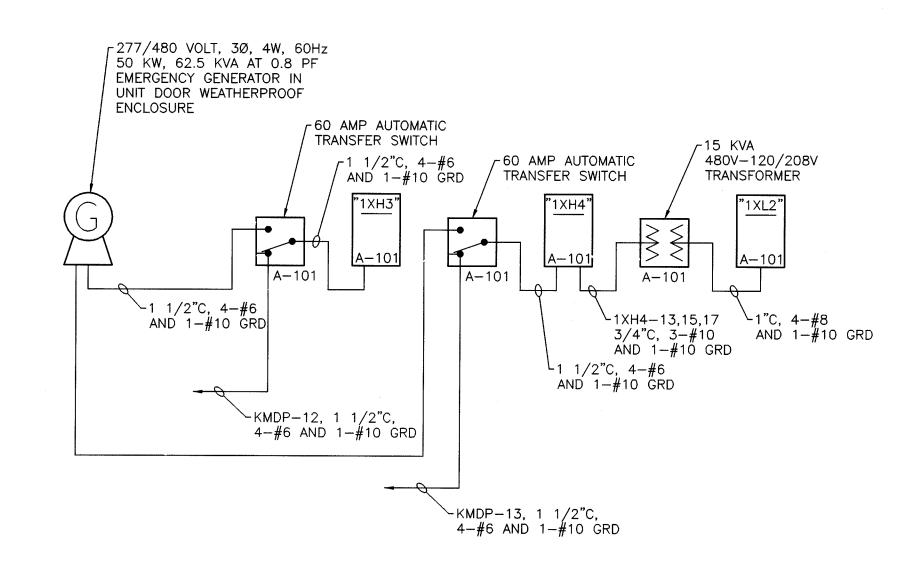
V E-401






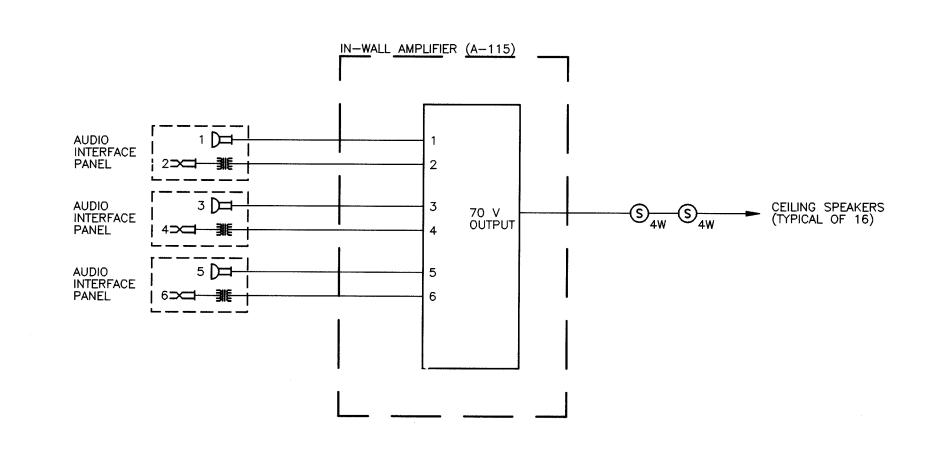


EAT 'N PLAY A-115 SOUND SYSTEM DISTRIBUTION DIAGRAM NOT TO SCALE



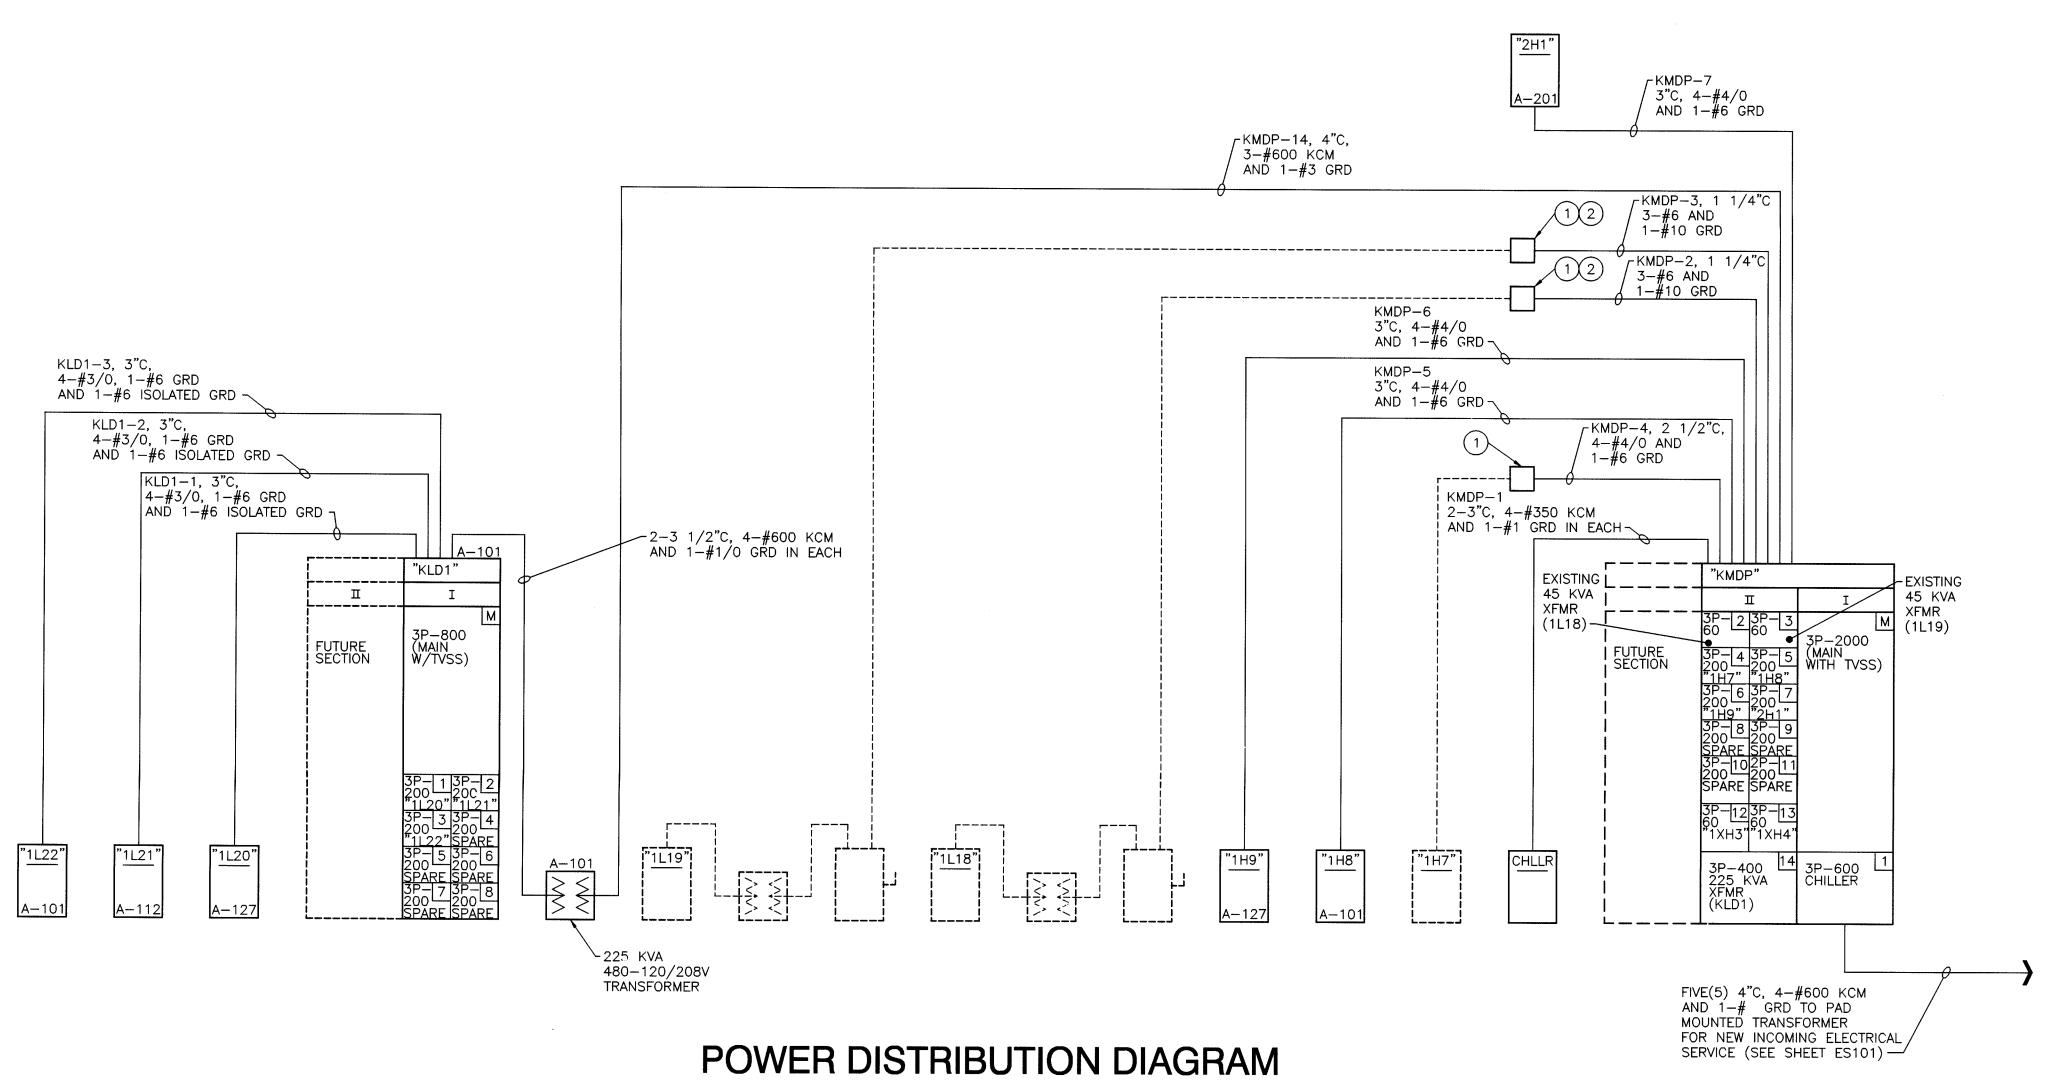

NOTES: 1 PROVIDE A NEW JUNCTION BOX ABOVE THE CEILING, INTERCEPT EXISTING FEEDER CONDUIT AND WIRE AND CONNECT THEM TO THE NEW MAIN DISTRIBUTION PANEL (KMDP). 2 REMOVE EXISTING WIRE BACK TO SOURCE UNLESS OTHERWISE NOTED. REMOVE ALL CONDUIT BACK TO SOURCE THAT IS NOT CONCEALED IN WALLS OR FLOORS.

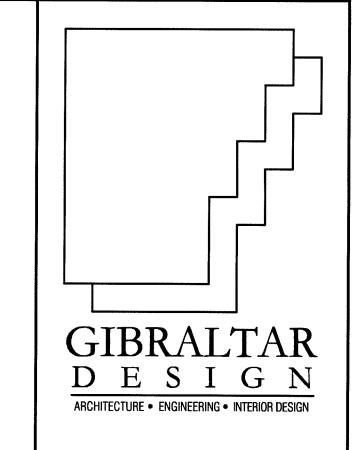

PROJECT

LAWRENCE CENTRALIZED **KINDERGARTEN**

NORTH & SOUTH CAMPUS ADDITIONS

METROPOLITAN SCHOOL DISTRICT OF LAWRENCE TOWNSHIP

MARION COUNTY, INDIANA

GIBRALTAR DESIGN 9102 N. Meridian St., Ste. 300 Indianapolis, IN 46260 Homepage www.GibraltarDesign.com Email info@GibraltarDesign.com Phone 317.580.5777 Fax 317.580.5778

PROJECT 02-580 DATE 04/21/03 COORDINATED BY PCB DRAWN BY

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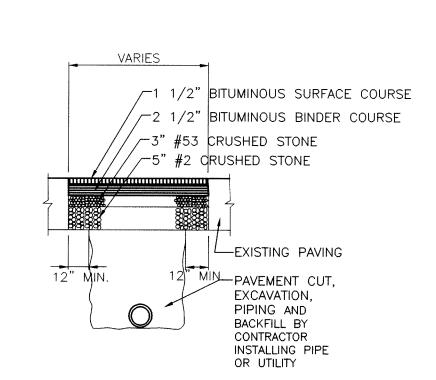
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DRAWING ELECTRICAL DISTRIBUTION DIAGRAMS


LAWRENCE CENTRALIZED KINDERGARTEN NORTH CAMPUS

GIBRALTAR DESIGN


E-701



CUT AND REPAIR HEAVY DUTY PAVEMENT DETAIL NOT TO SCALE

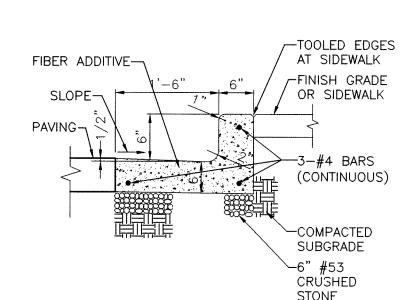

CHAIRBACK CURB/ NOT TO SCALE

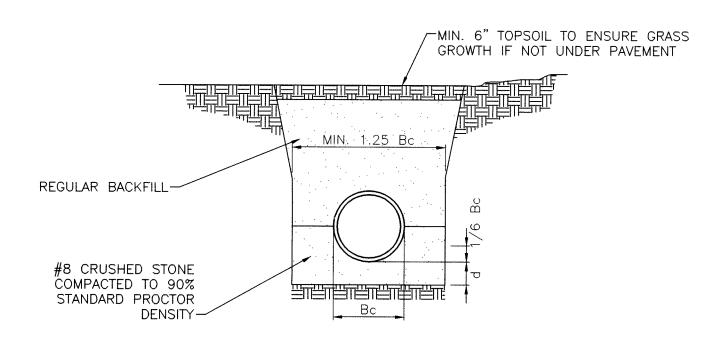

NOTE: ALL BEDDING AND INITIAL BACKFILL SHALL BE INSTALLED IN 6" TO 12" BALANCED LIFTS A MINIMUM 9" CLEARANCE SHALL BE PROVIDED ON EACH SIDE OF THE INSTALLED PIPE


DEPTH OF BEDDING MATERIAL BELOW PIPE 27" AND SMALLER 30" TO 60"

66" AND LARGER

LEGEND Bc = OUTSIDE DIAMETER D = INSIDE DIAMETER d = DEPTH OF BEDDING MATERIAL BELOW PIPE

REINFORCED CONCRETE PIPE (RCP) TRENCH DETAIL

GREATER THAN 5' FROM EDGE OF PAVEMENT NOT TO SCALE

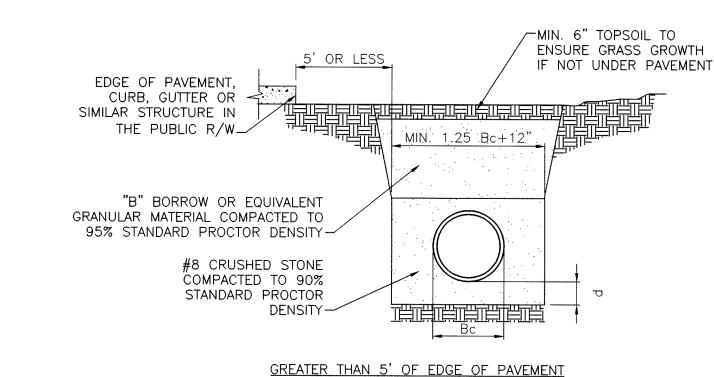


NOTE: ALL BEDDING AND INITIAL BACKFILL SHALL BE INSTALLED IN 6" TO 12" BALANCED LIFTS A MINIMUM 9" CLEARANCE SHALL BE PROVIDED ON EACH SIDE OF THE INSTALLED PIPE


DEPTH OF BEDDING MATERIAL BELOW PIPE 27" AND SMALLER 66" AND LARGER

LEGEND Bc = OUTSIDE DIAMETER D = INSIDE DIAMETER d = DEPTH OF BEDDING MATERIAL BELOW PIPE

REINFORCED CONCRETE PIPE (8) (RCP) TRENCH DETAIL WITHIN THAN 5' OF EDGE OF PAVEMENT NOT TO SCALE

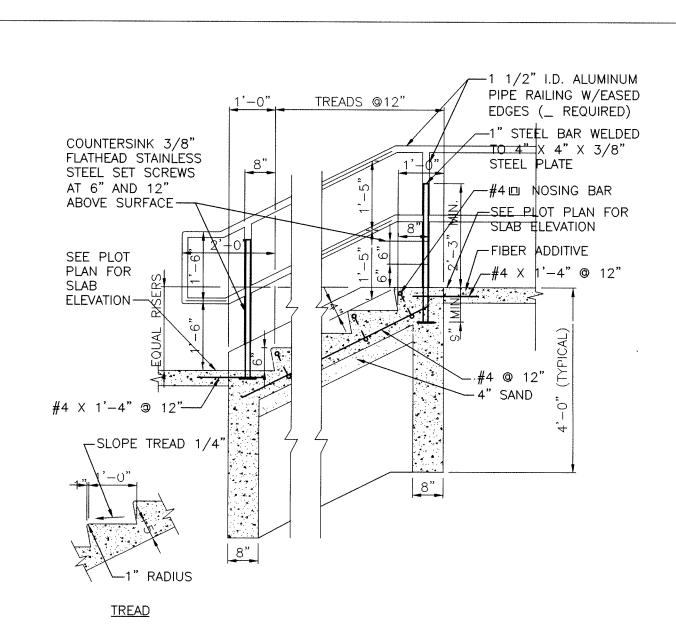

STAIR SECTION W/VARING NO. OF RISERS NOT TO SCALE

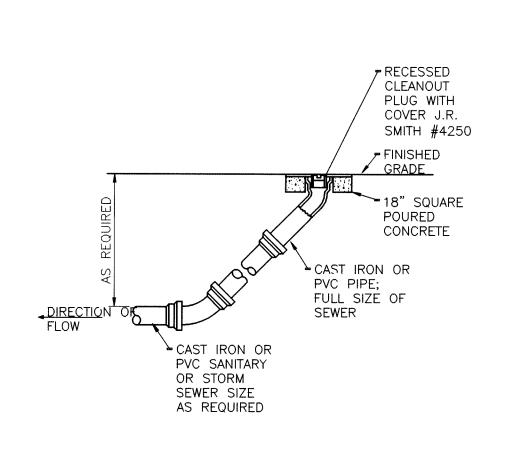

TYPICAL OUTSIDE CLEANOUT NOT TO SCALE

-COLLAR PER LOCAL FIRE

DEPT. REQUIREMENTS

2 HOSE OUTLETS

VALVE BOX COVER FLUSH WITH GRADE

-GATE VALVE

ROCK DRAIN POCKET -THOROUGHLY COMPACTED

-CATCH BASIN FRAME

-PAVEMENT

REINFORCED

CONCRETE TYPE A MODIFIED INLET BOX

MANHOLE BASE

OR #2 STONE

---MINIMUM 6" OF

#8 CRUSHED STONE

SET ON 6" OF #8

AND GRATE

---DEPTH OF BURY VARIES-SEE SPECIFICATIONS

SCREW TYPE VALVE BOX

PUMPER CONNECTION

FIRE DEPT.) FACING

TRUCK ACCESS-

FINISHED GRADE-

LEAVE HYDRANT

DRAIN OPEN -

CONCRETE BLOCK CAST IN PLACE -

GROUT AS REQUIRED-

REQUIRED.

NOT TO SCALE

HOSE AND PUMPER

FIRE DEPARTMENT.

NOT TO SCALE

CONNECTIONS SHALL HAVE

OF THREADS PER INCH TO

THE SAME TYPE AND NUMBER

MATCH THOSE OF THE LOCAL

FIRE HYDRANT DETAIL

<u>SIDE VIEW</u>

FRONT VIEW

DRAINAGE STRUCTURE DETAIL 6

---CATCH BASIN FRAME

AND GRATE

-MINIMUM 6" OF


CRUSHED STONE


EACH SIDE OF INLET

UNDISTURBED

(IF REQUIRED BY LOCAL


ROAD OR NEAREST FIRE

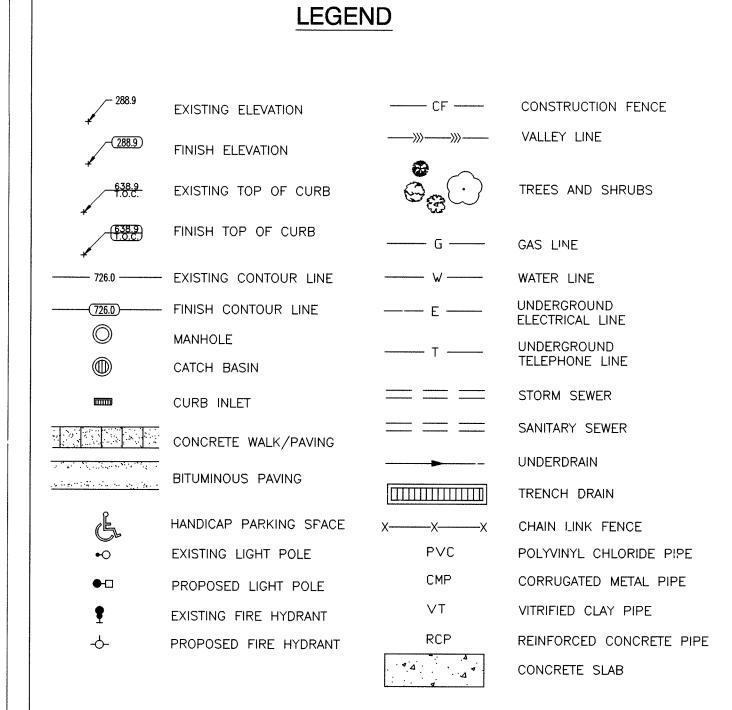

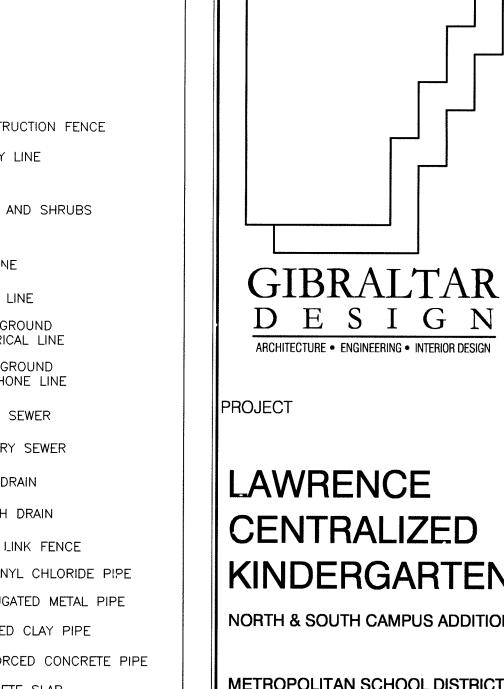


LAWRENCE CENTRALIZED **KINDERGARTEN** NORTH & SOUTH CAMPUS ADDITIONS


METROPOLITAN SCHOOL DISTRICT OF LAWRENCE TOWNSHIP MARION COUNTY, INDIANA

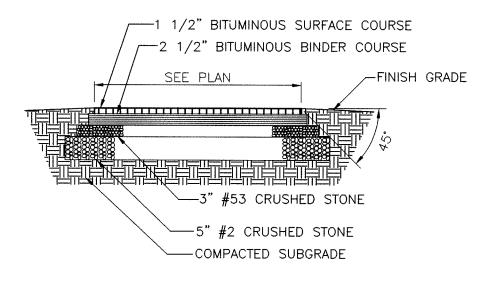


PAVEMENT DETAIL 1 **HEAVY DUTY** NOT TO SCALE

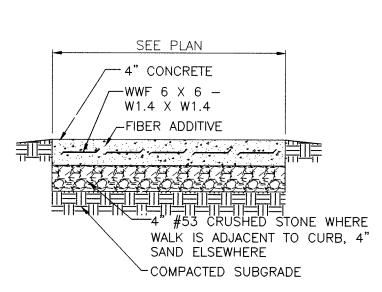

SIDEWALK DETAIL NOT TO SCALE

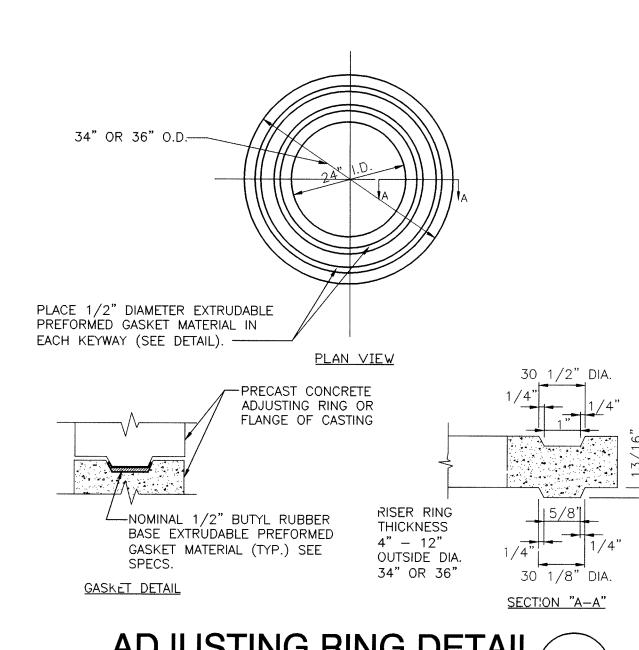



NOT TO SCALE

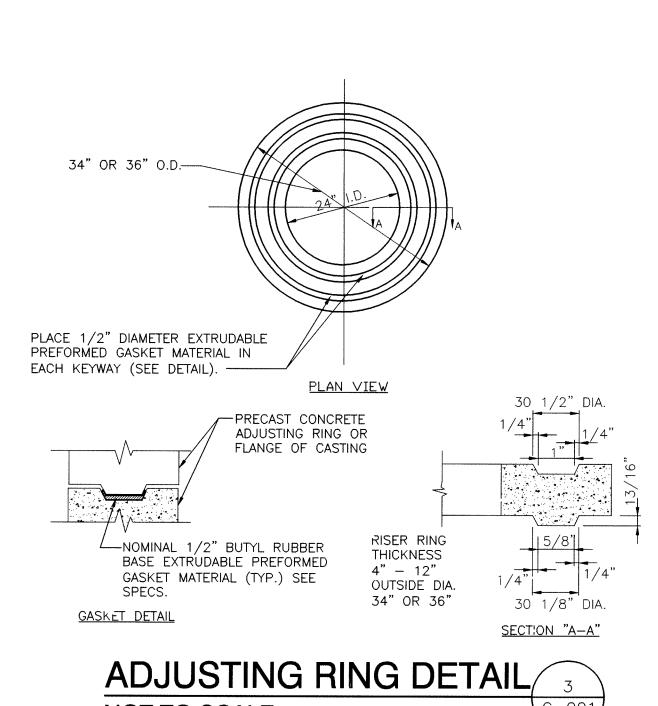

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C-001



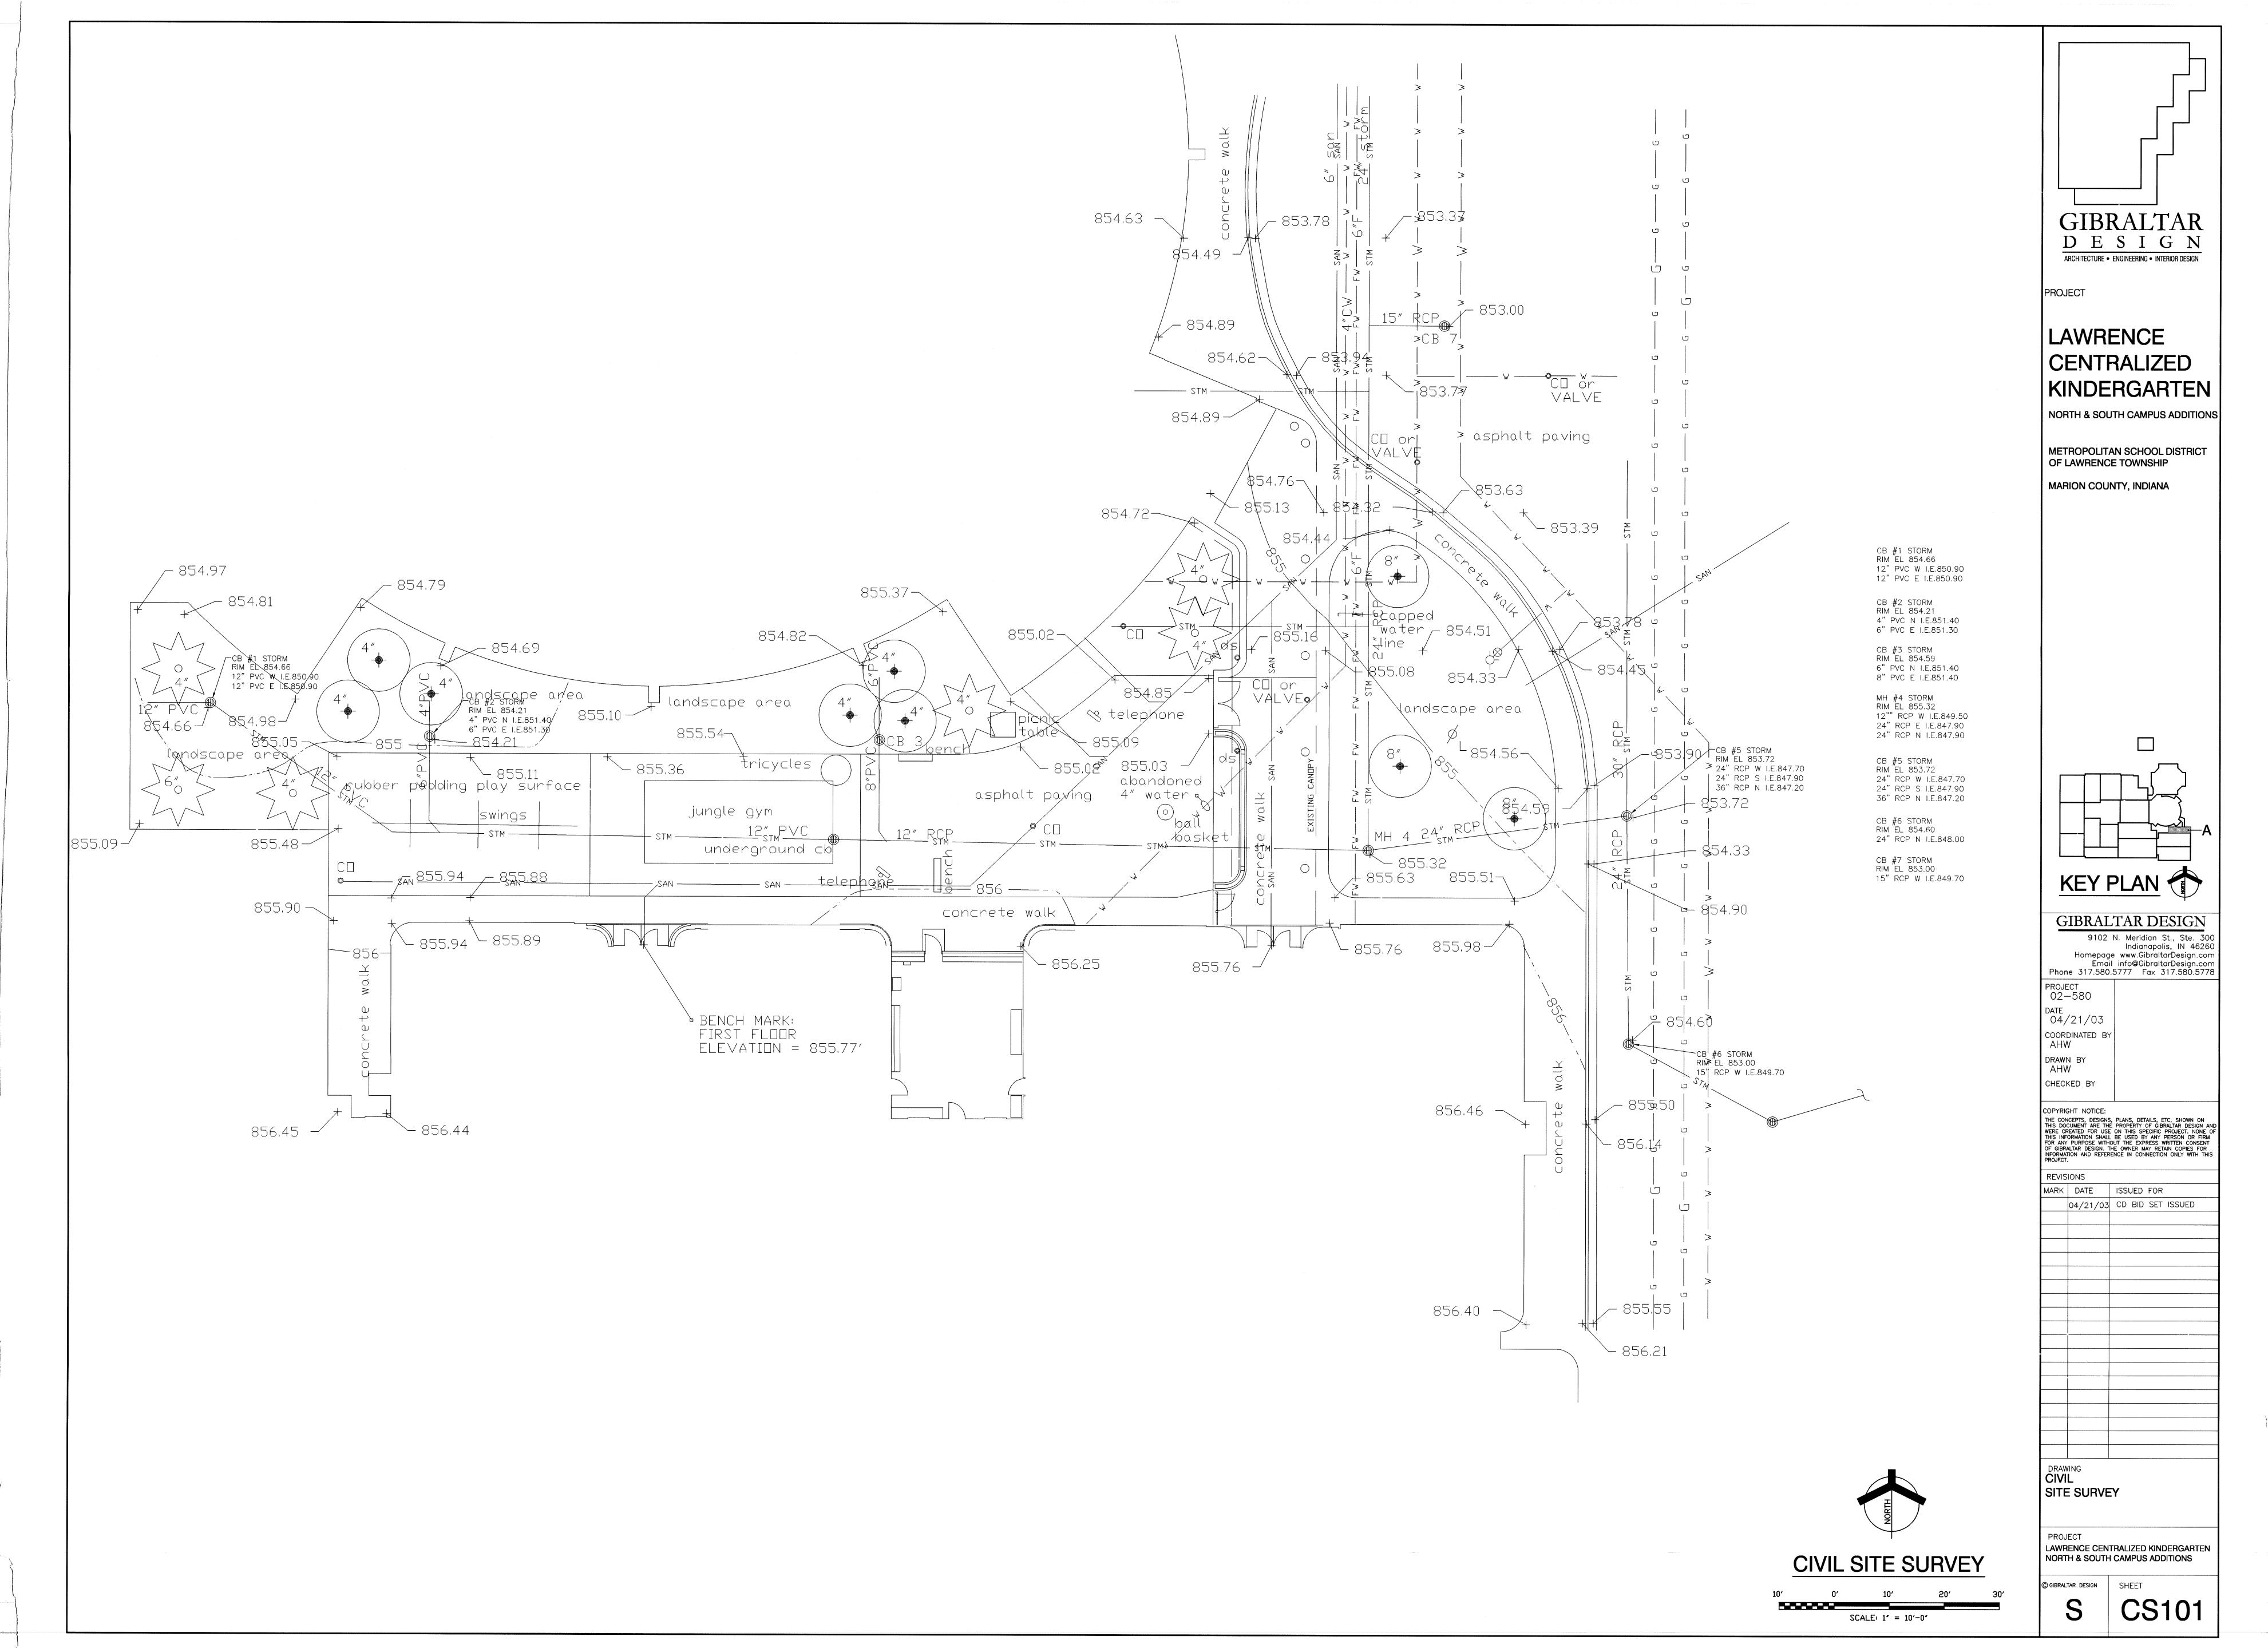

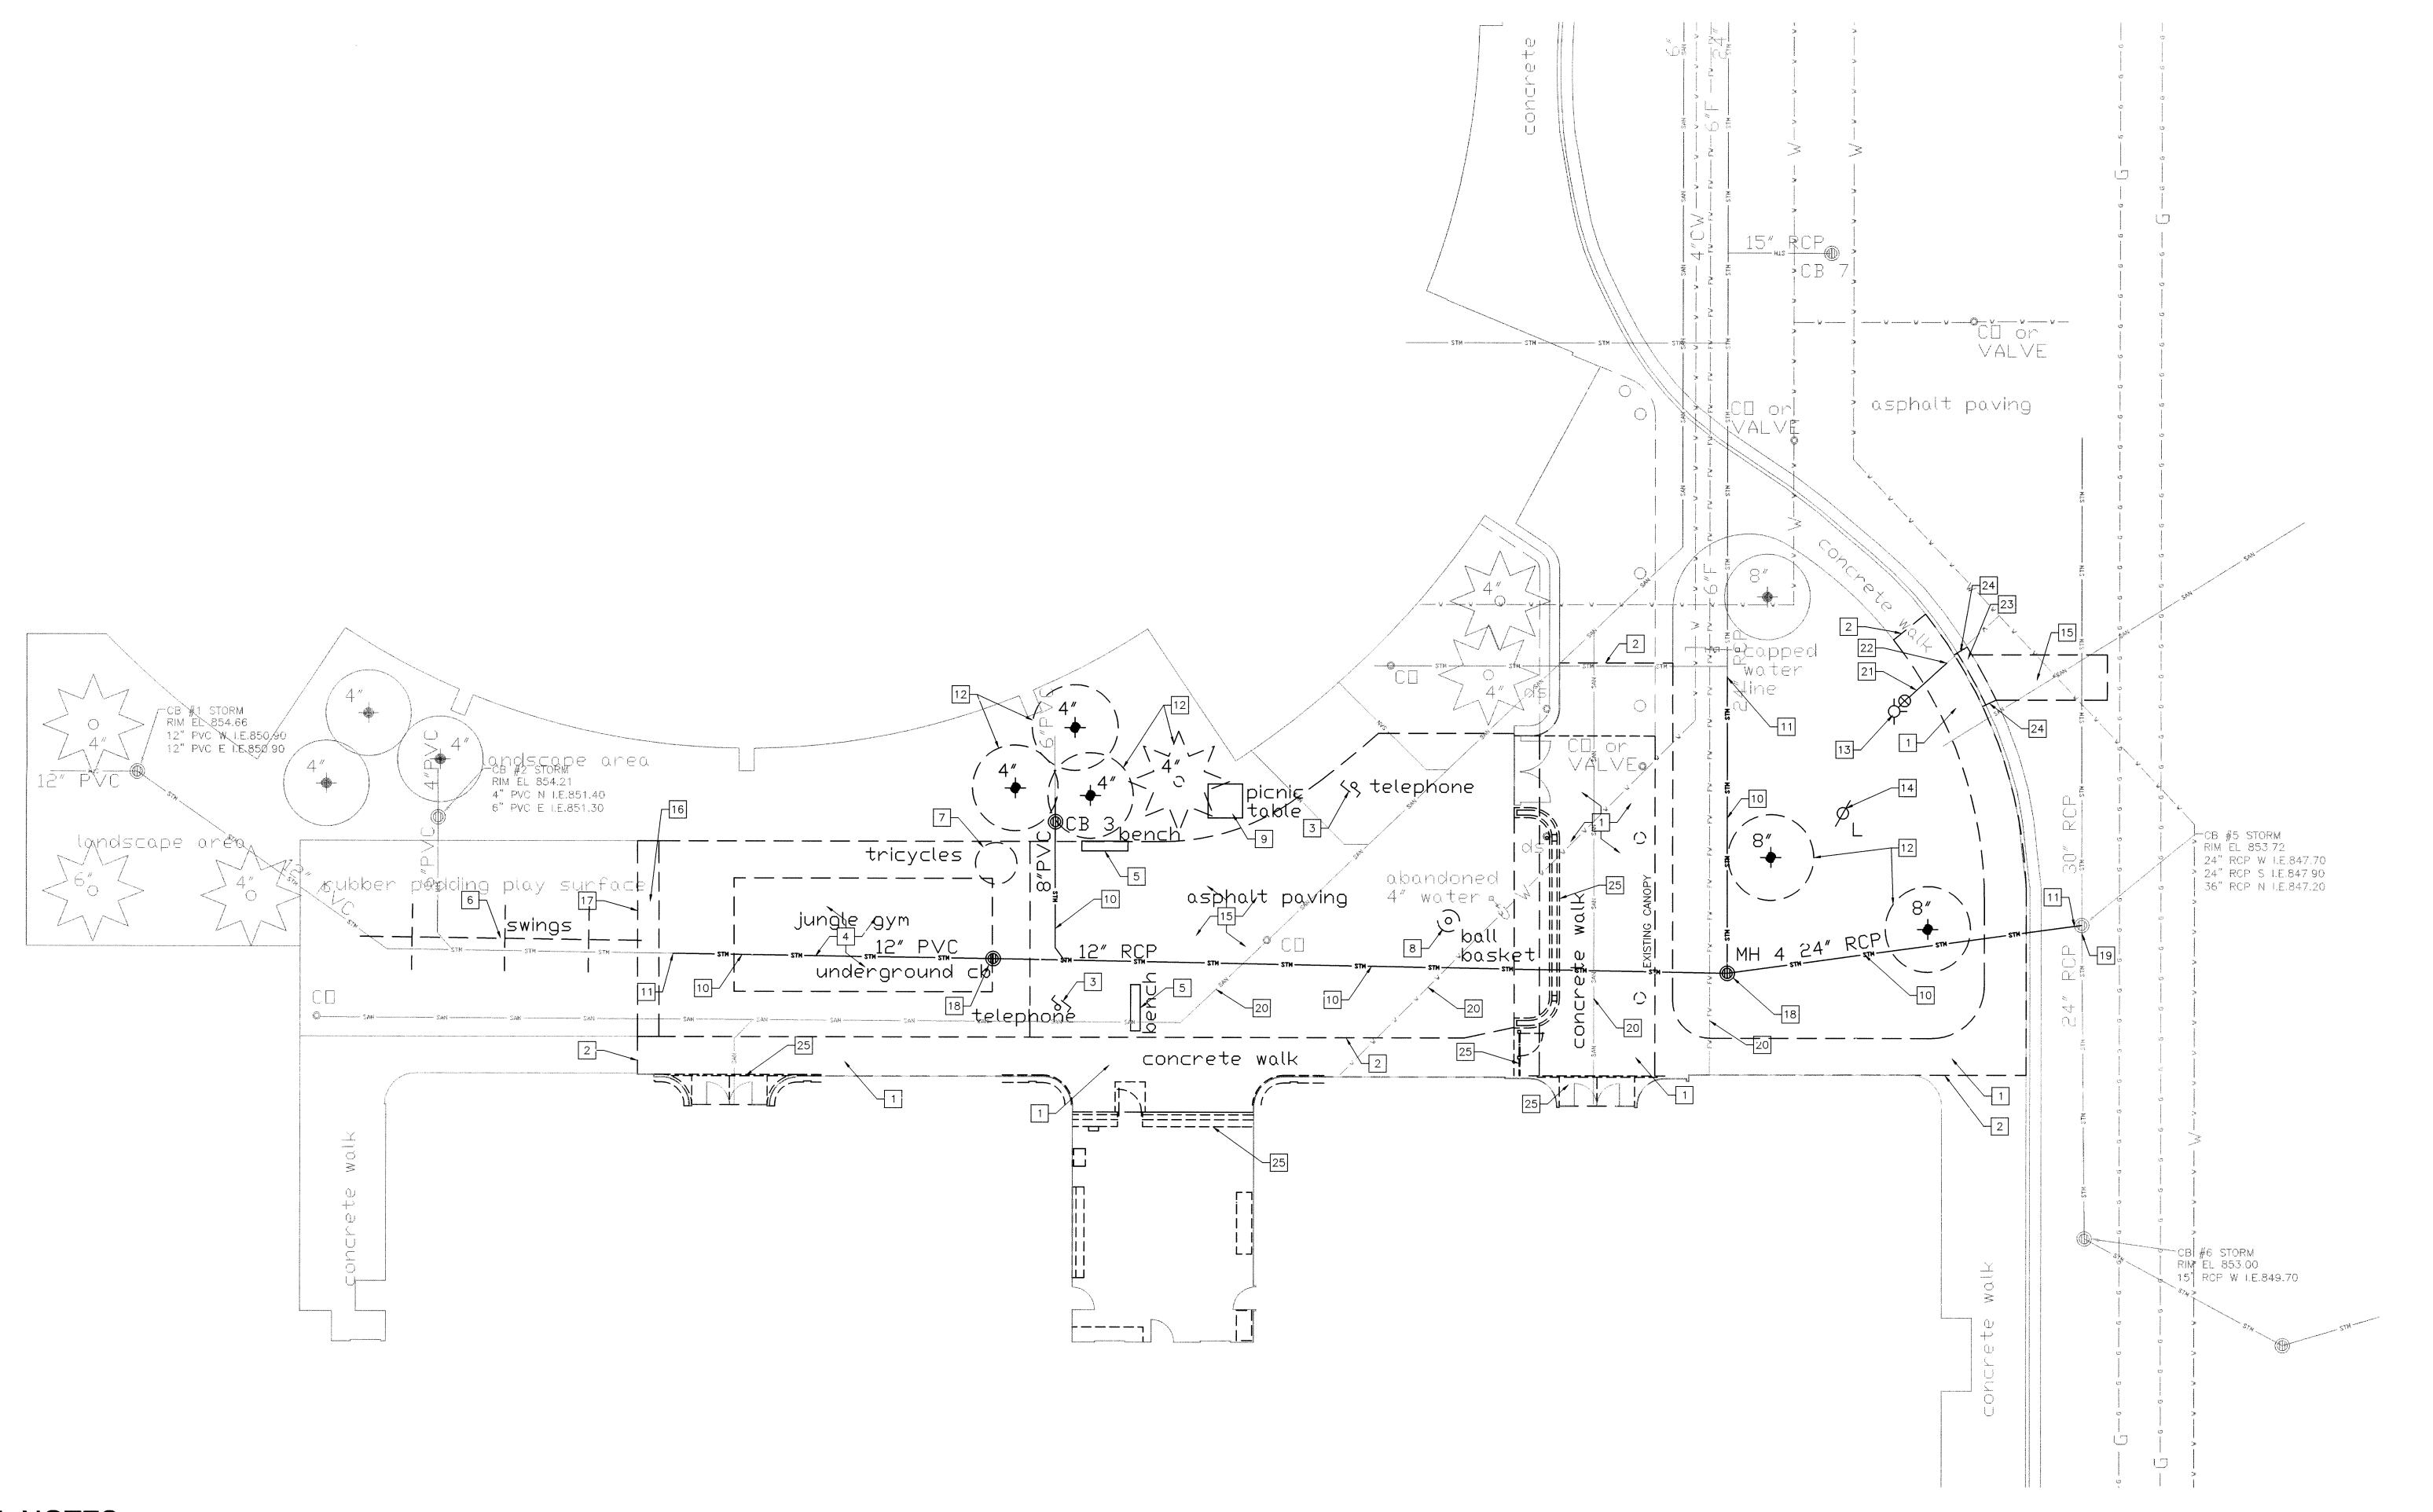- 1. ALL UTILITIES SHALL BE REMOVED FROM NEW BUILDING'S FOOT
- 2. ALL UTILITY LINE REMOVAL SHALL BE COORDINATED WITH UTILITY

19 PLUG CATCH BASIN WHERE STORM SEWER WAS REMOVED.

20 SEE PLUMBING DRAWINGS.

21 REMOVE FIRE WATER LINE.

22 FIRE WATER LINE REMOVAL LIMIT.

24 CURB AND GUTTER REMOVAL LIMIT.

25 SEE ARCHITECTURAL DRAWINGS.


23 REMOVE CURB AND GUTTER.


 CONTRACTOR IS TO VERIFY EXACT LOCATION OF ALL UNDERGROUND UTILITIES AND NOTIFY ENGINEER OF ANY DISCREPANCIES.

PLAN NOTES:

- 1 REMOVE SIDEWALK.
- 2 SIDEWALK REMOVAL LIMIT.
- 3 REMOVE TELEPHONE. SEE ELECTRICAL DRAWINGS.
- 4 REMOVE JUNGLE GYM.
- 5 REMOVE BENCH.
- 6 REMOVE SWINGS.
- 7 REMOVE TRICYCLES.
- 8 REMOVE BALL BASKET.
- 9 REMOVE PICNIC TABLE.
- 10 REMOVE STORM SEWER.
- 11 STORM SEWER REMOVAL LIMIT.
- 12 REMOVE TREE.
- 13 REMOVE FIRE HYDRANT.
- 14 REMOVE LIGHT POLE. SEE ELECTRICAL DRAWINGS.
- 15 REMOVE ASPHALT PAVEMENT.
- 16 REMOVE RUBBER PADDING AND RETURN TO OWNER.
- 17 RUBBER PADDING REMOVAL LIMIT.
- 18 REMOVE CATCH BASIN.



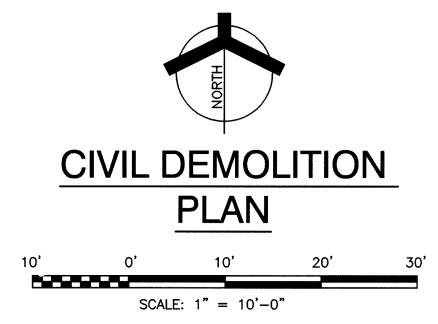

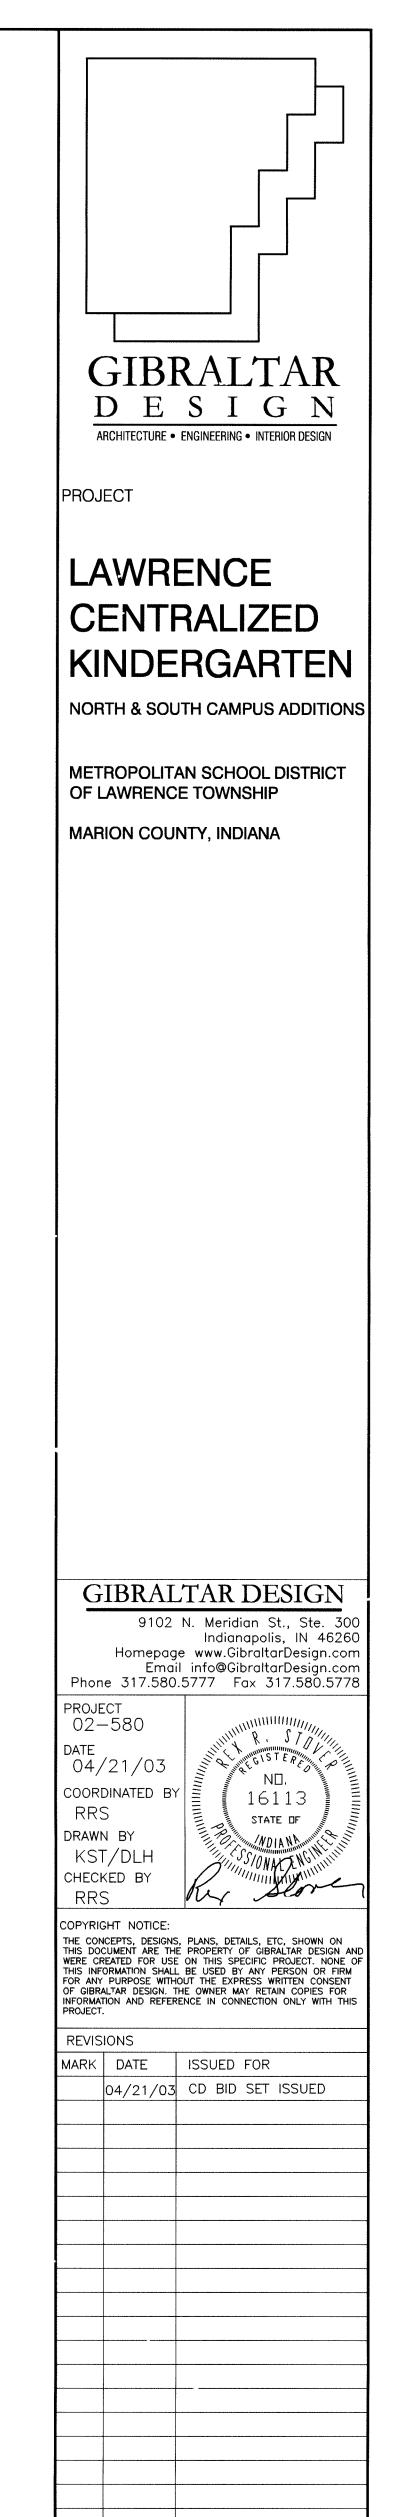


DEMOLITION PLAN

PROJECT LAWRENCE CENTRALIZED KINDERGARTEN NORTH & SOUTH CAMPUS ADDITIONS

GIBRALTAR DESIGN S

CD101

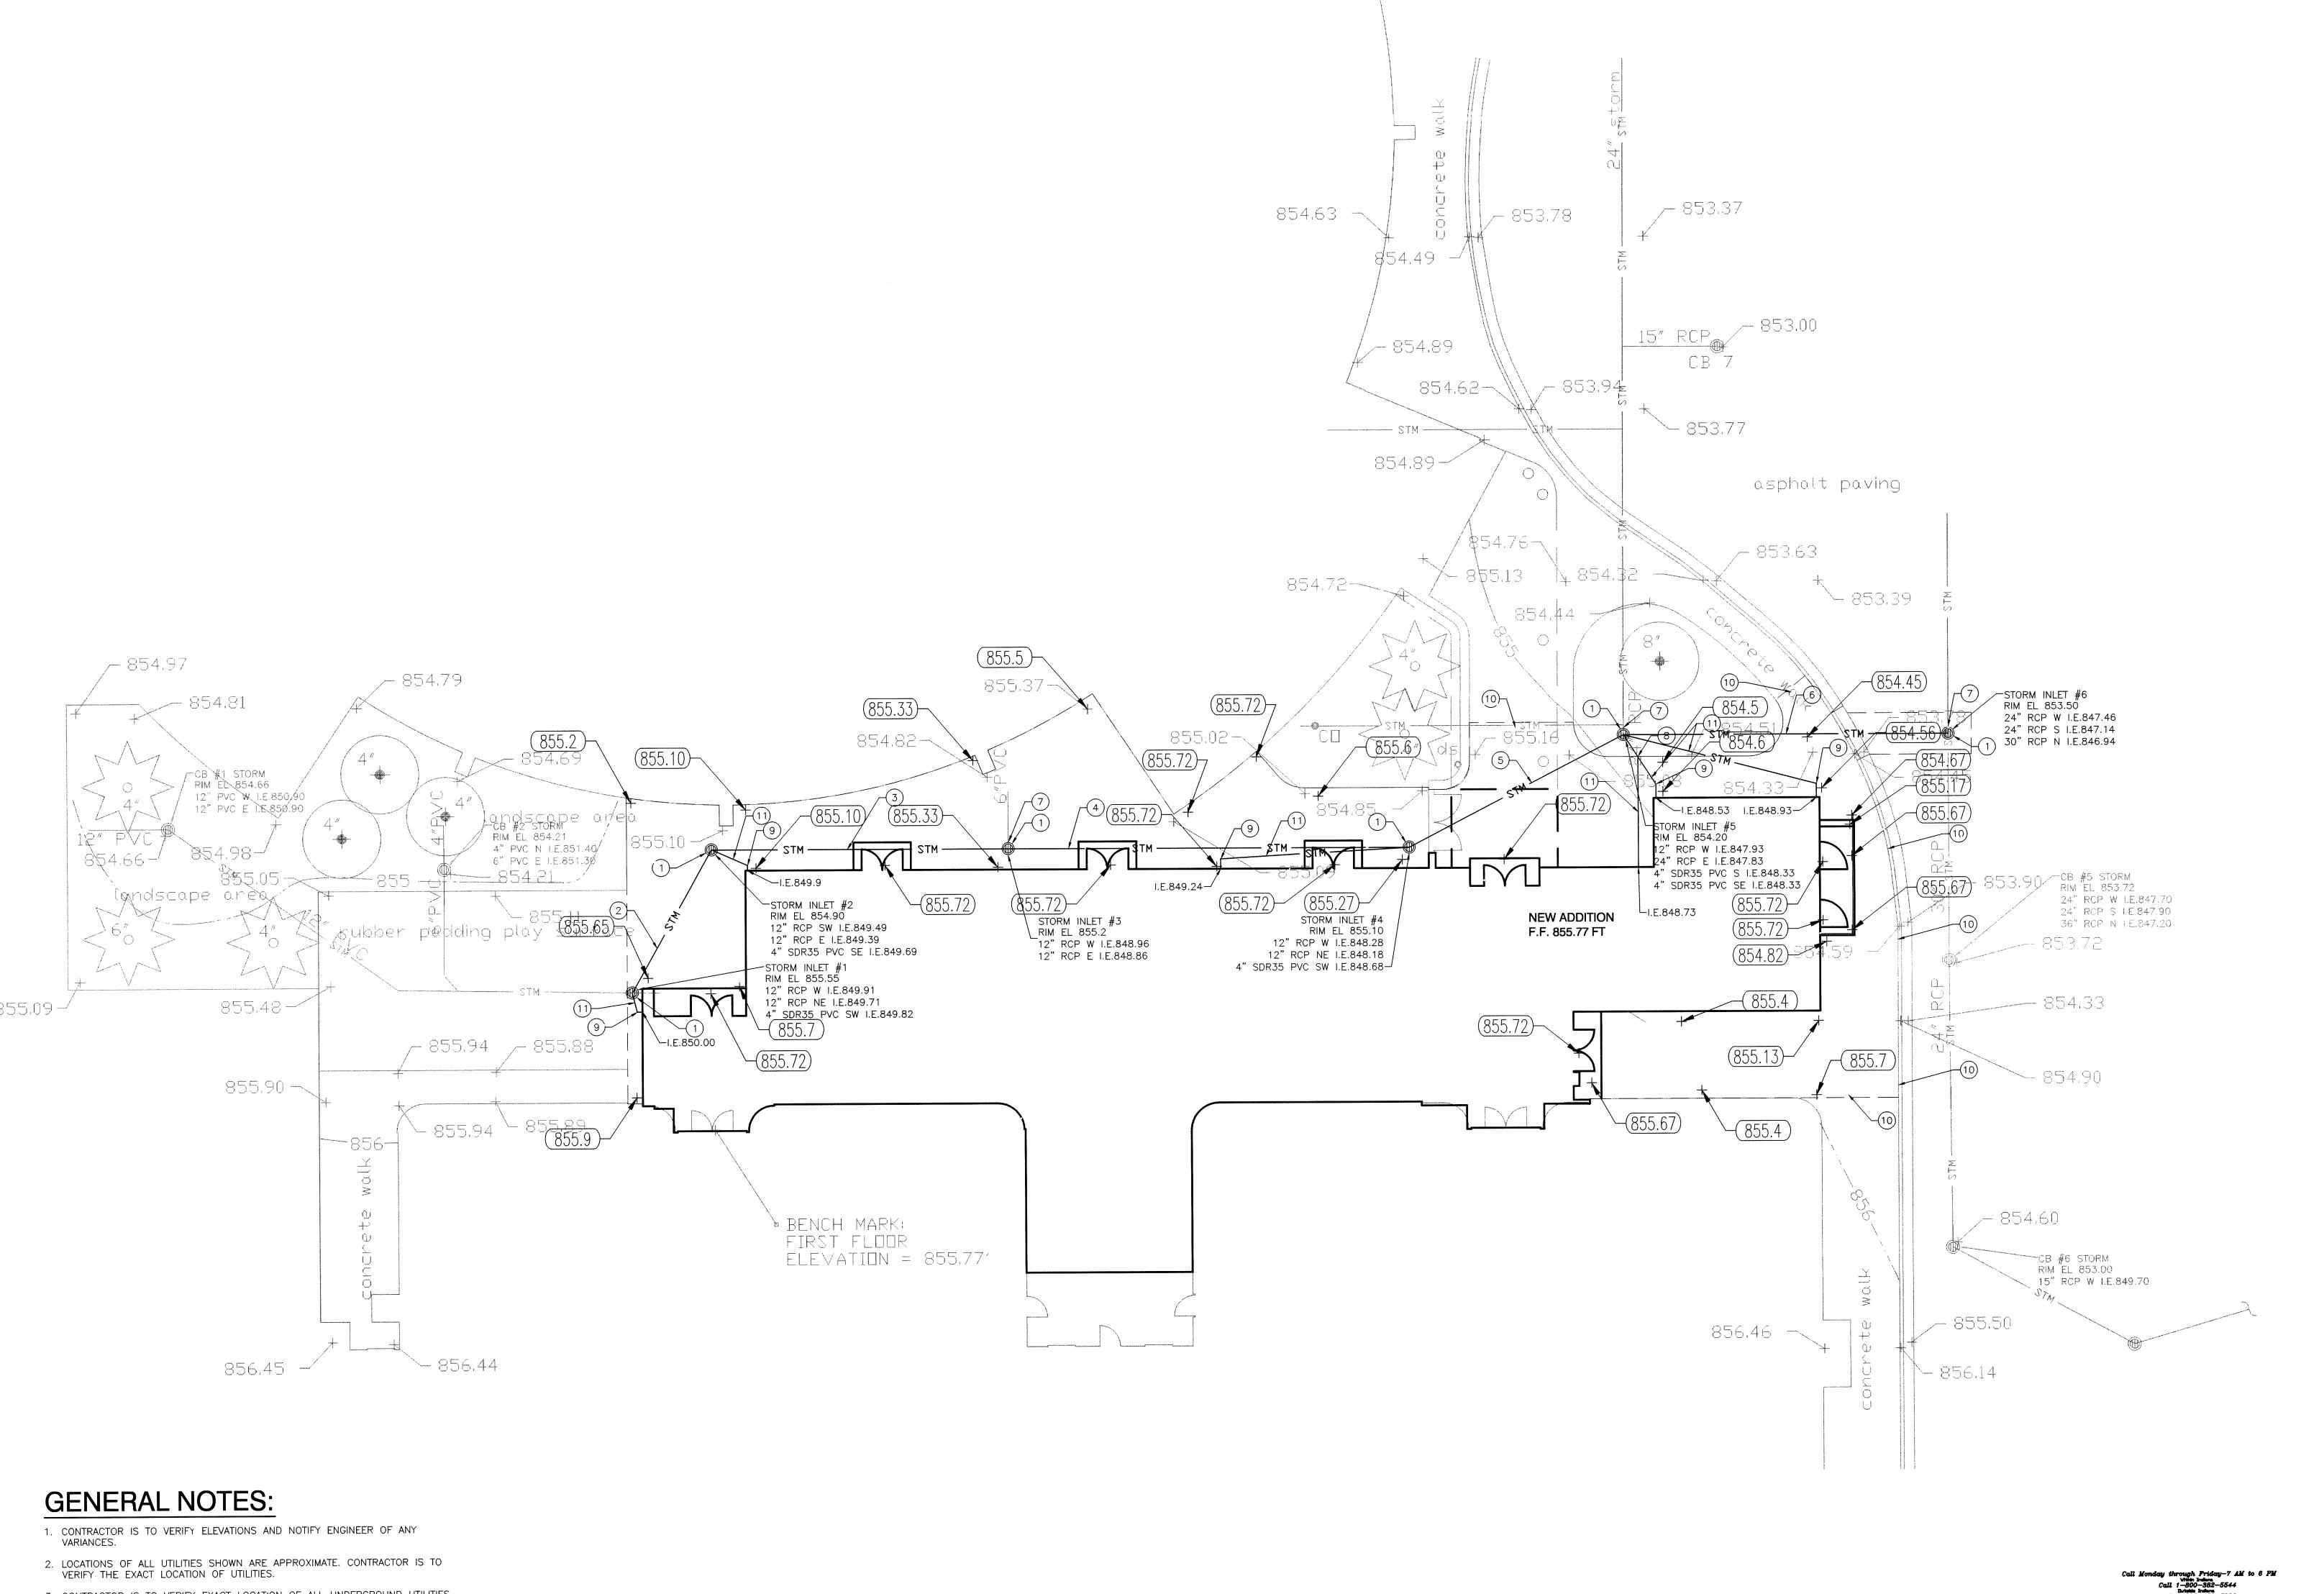

- 3. CONTRACTOR IS TO VERIFY EXACT LOCATION OF ALL UNDERGROUND UTILITIES AND NOTIFY ENGINEER OF ANY DISCREPANCIES.
- 4. CONTRACTOR IS TO VERIFY THE INVERT ELEVATION OF EXISTING STORM SEWERS, WHICH ARE TO BE CONNECTED WITH NEW STORM SEWERS. NOTIFY ENGINEER OF ANY DISCREPANCIES.

PLAN NOTES:

1) INSTALL CATCH BASIN WITH CASTING R-2535. SEE DETAIL ----2 INSTALL 22' OF 12" RCP @1% SLOPE. 3 INSTALL 43' OF 12" RCP @1% SLOPE. (4) INSTALL 58' OF 12" RCP @1% SLOPE. (5) INSTALL 35' OF 12" RCP @1% SLOPE.

(6) INSTALL 47' OF 24" RCP @1% SLOPE. 7 CONTRACTOR TO LOCATE STORM SEWER AT THIS LOCATION AND VERIFY ELEVATIONS PRIOR TO REMOVING EXISTING STORM SEWER.


(8) CONNECT THE TWO STORM DRAINS AT THIS LOCATION.

9 INSTALL CLEAN OUT. SEE DETAIL ----


(10) MATCH EXISTING GRADE. (11) INSTALL DRAIN TO CATCH BASIN.

2 Working Days
Before You Dig.
DIGMAN UNDERSTELLED PROTECTION SERVICE, INC. "IT'S THE LAW"

PER INDIANA STATE LAW IS-69-1991, IT IS
AGAINST THE LAW TO EXCAVATE VITHOUT
NOTIFYING THE UNDERGROUND LOCATION SERVICE
TWO (2) WORKING DAYS BEFORE COMMENCING WORK.

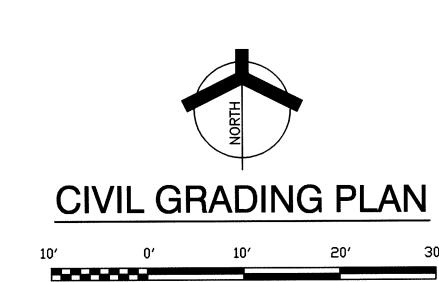

SCALE: 1'' = 10'-0"

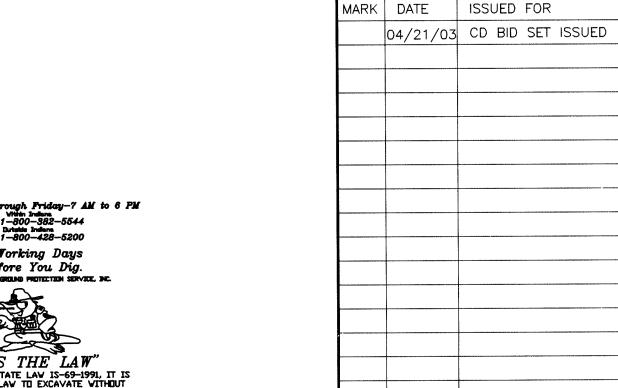

DRAWING GRADING PLAN

> LAWRENCE CENTRALIZED KINDERGARTEN NORTH & SOUTH CAMPUS ADDITIONS

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D E S I G N

ARCHITECTURE • ENGINEERING • INTERIOR DESIGN

LAWRENCE

CENTRALIZED

KINDERGARTEN

NORTH & SOUTH CAMPUS ADDITIONS

METROPOLITAN SCHOOL DISTRICT OF LAWRENCE TOWNSHIP

GIBRALTAR DESIGN

Indianapolis, IN 46260
Homepage www.GibraltarDesign.com
Email info@GibraltarDesign.com
Phone 317.580.5777 Fax 317.580.5778

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02-580

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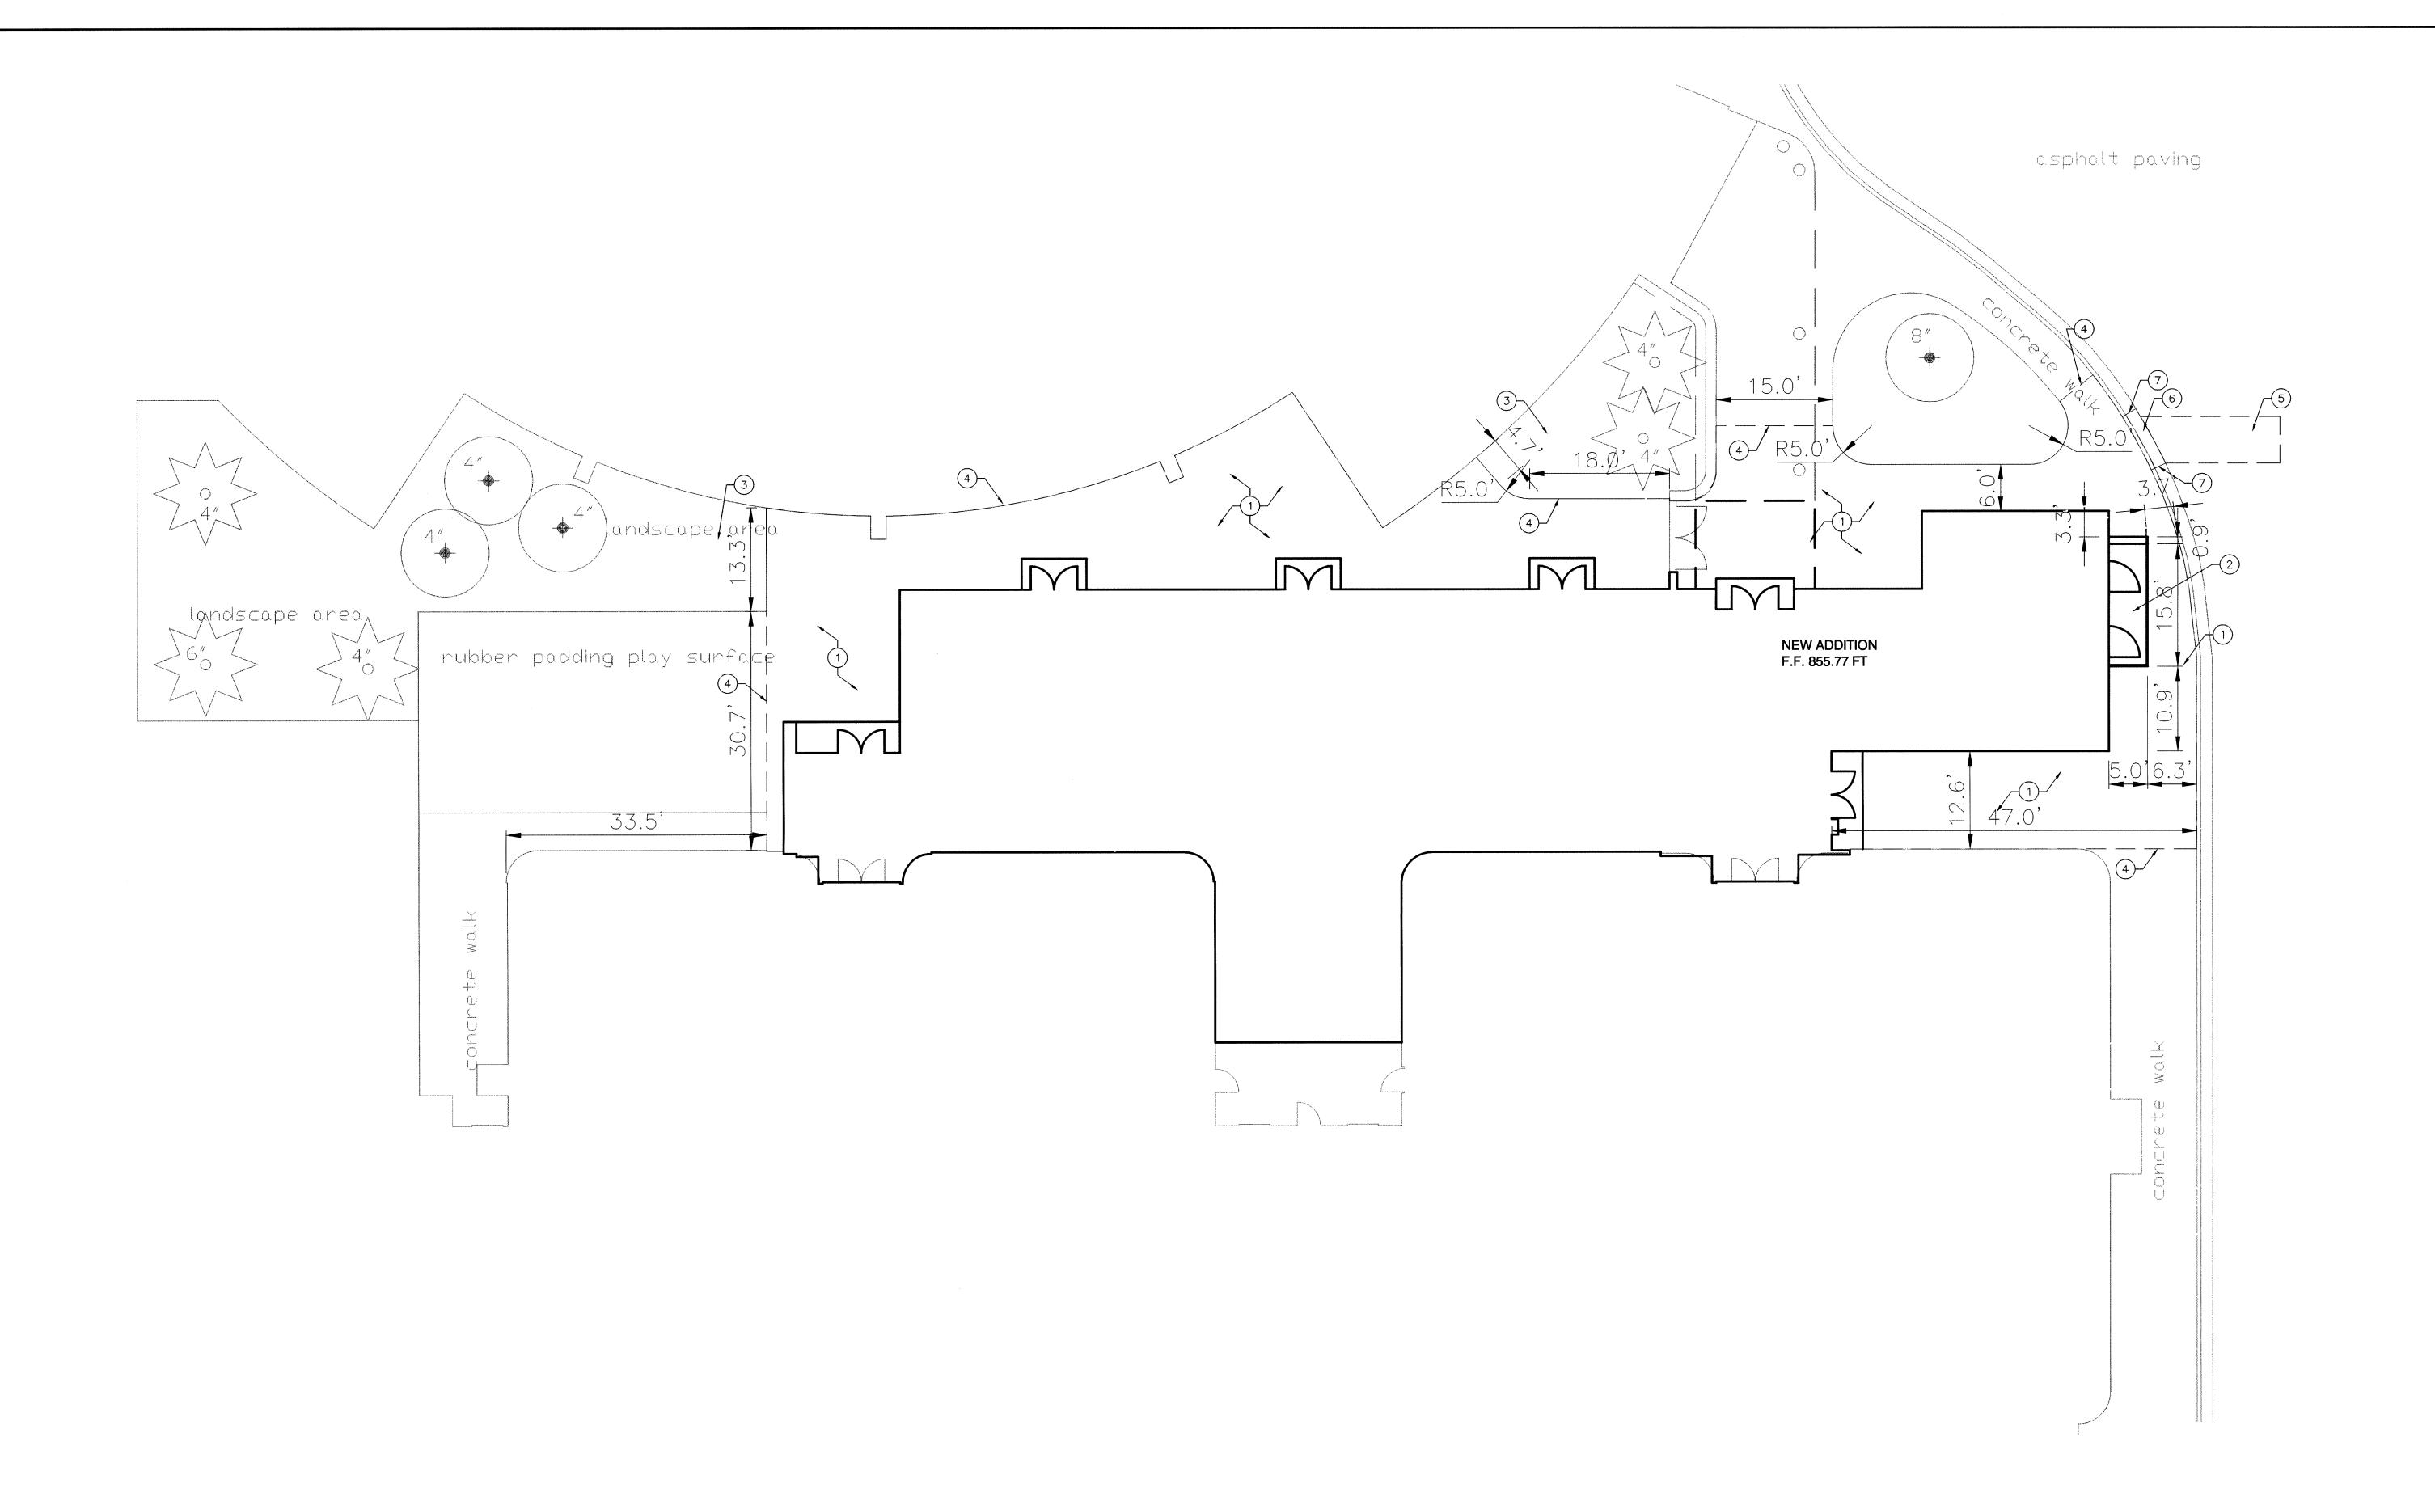
STATE OF

MARION COUNTY, INDIANA

PROJECT

GIBRALTAR DESIGN SHEET

CG101



1. LOCATIONS OF ALL UTILITIES SHOWN ARE APPROXIMATE. CONTRACTOR IS TO VERIFY THE EXACT LOCATION OF UTILITIES.

 CONTRACTOR IS TO VERIFY EXACT LOCATION OF ALL UNDERGROUND UTILITIES AND NOTIFY ENGINEER OF ANY DISCREPANCIES.

PLAN NOTES:

1 INSTALL SIDEWALK. SEE DETAIL

2 INSTALL HANDRAIL AND 2 STEPS WITH RISE OF 6". SEE DETAIL


3 PROVIDE ADDITIONAL FIBER OVER FILTER FABRIC IF REQUIRED.


4 PAVEMENT INSTALLATION LIMIT.

5 PAVEMENT REPAIR. SEE DETAIL———

6 CURB AND GUTTER REPAIR. SEE DETAIL——

7 MATCH EXISTING GRADE.

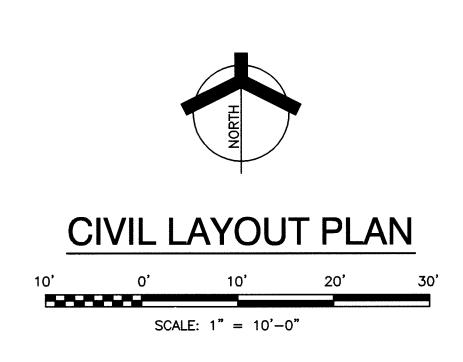

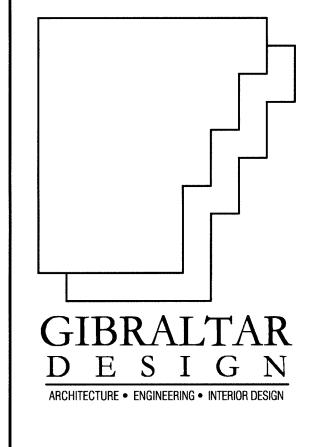

PROJECT

LAWRENCE CENTRALIZED KINDERGARTEN

NORTH & SOUTH CAMPUS ADDITIONS

METROPOLITAN SCHOOL DISTRICT OF LAWRENCE TOWNSHIP

MARION COUNTY, INDIANA

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DATE 04/21/03
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DRAWING
CIVIL
LAYOUT PLAN


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NORTH & SOUTH CAMPUS ADDITIONS

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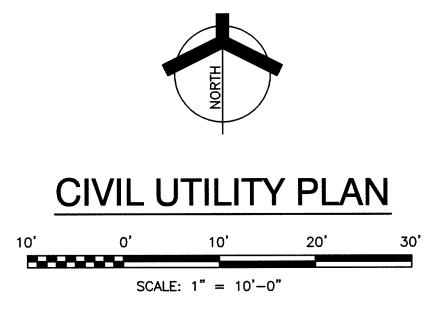
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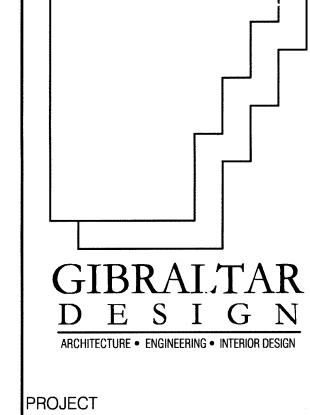


- LOCATIONS OF ALL UTILITIES SHOWN ARE APPROXIMATE. CONTRACTOR IS TO VERIFY THE EXACT LOCATION OF UTILITIES.
- 2. CONTRACTOR IS TO VERIFY EXACT LOCATION OF ALL UNDERGROUND UTILITIES AND NOTIFY ENGINEER OF ANY DISCREPANCIES.
- 3. CONTRACTOR IS TO COORDINATE THE RELOCATION OF UTILITIES WITH THE APPROPRIATE UTILITY COMPANY.

PLAN NOTES:

1) INSTALL 12' OF WATER LINE. 2 INSTALL FIRE HYDRANT. SEE DETAIL 5
C-001 (3) SEE PLUMBING DRAWINGS.

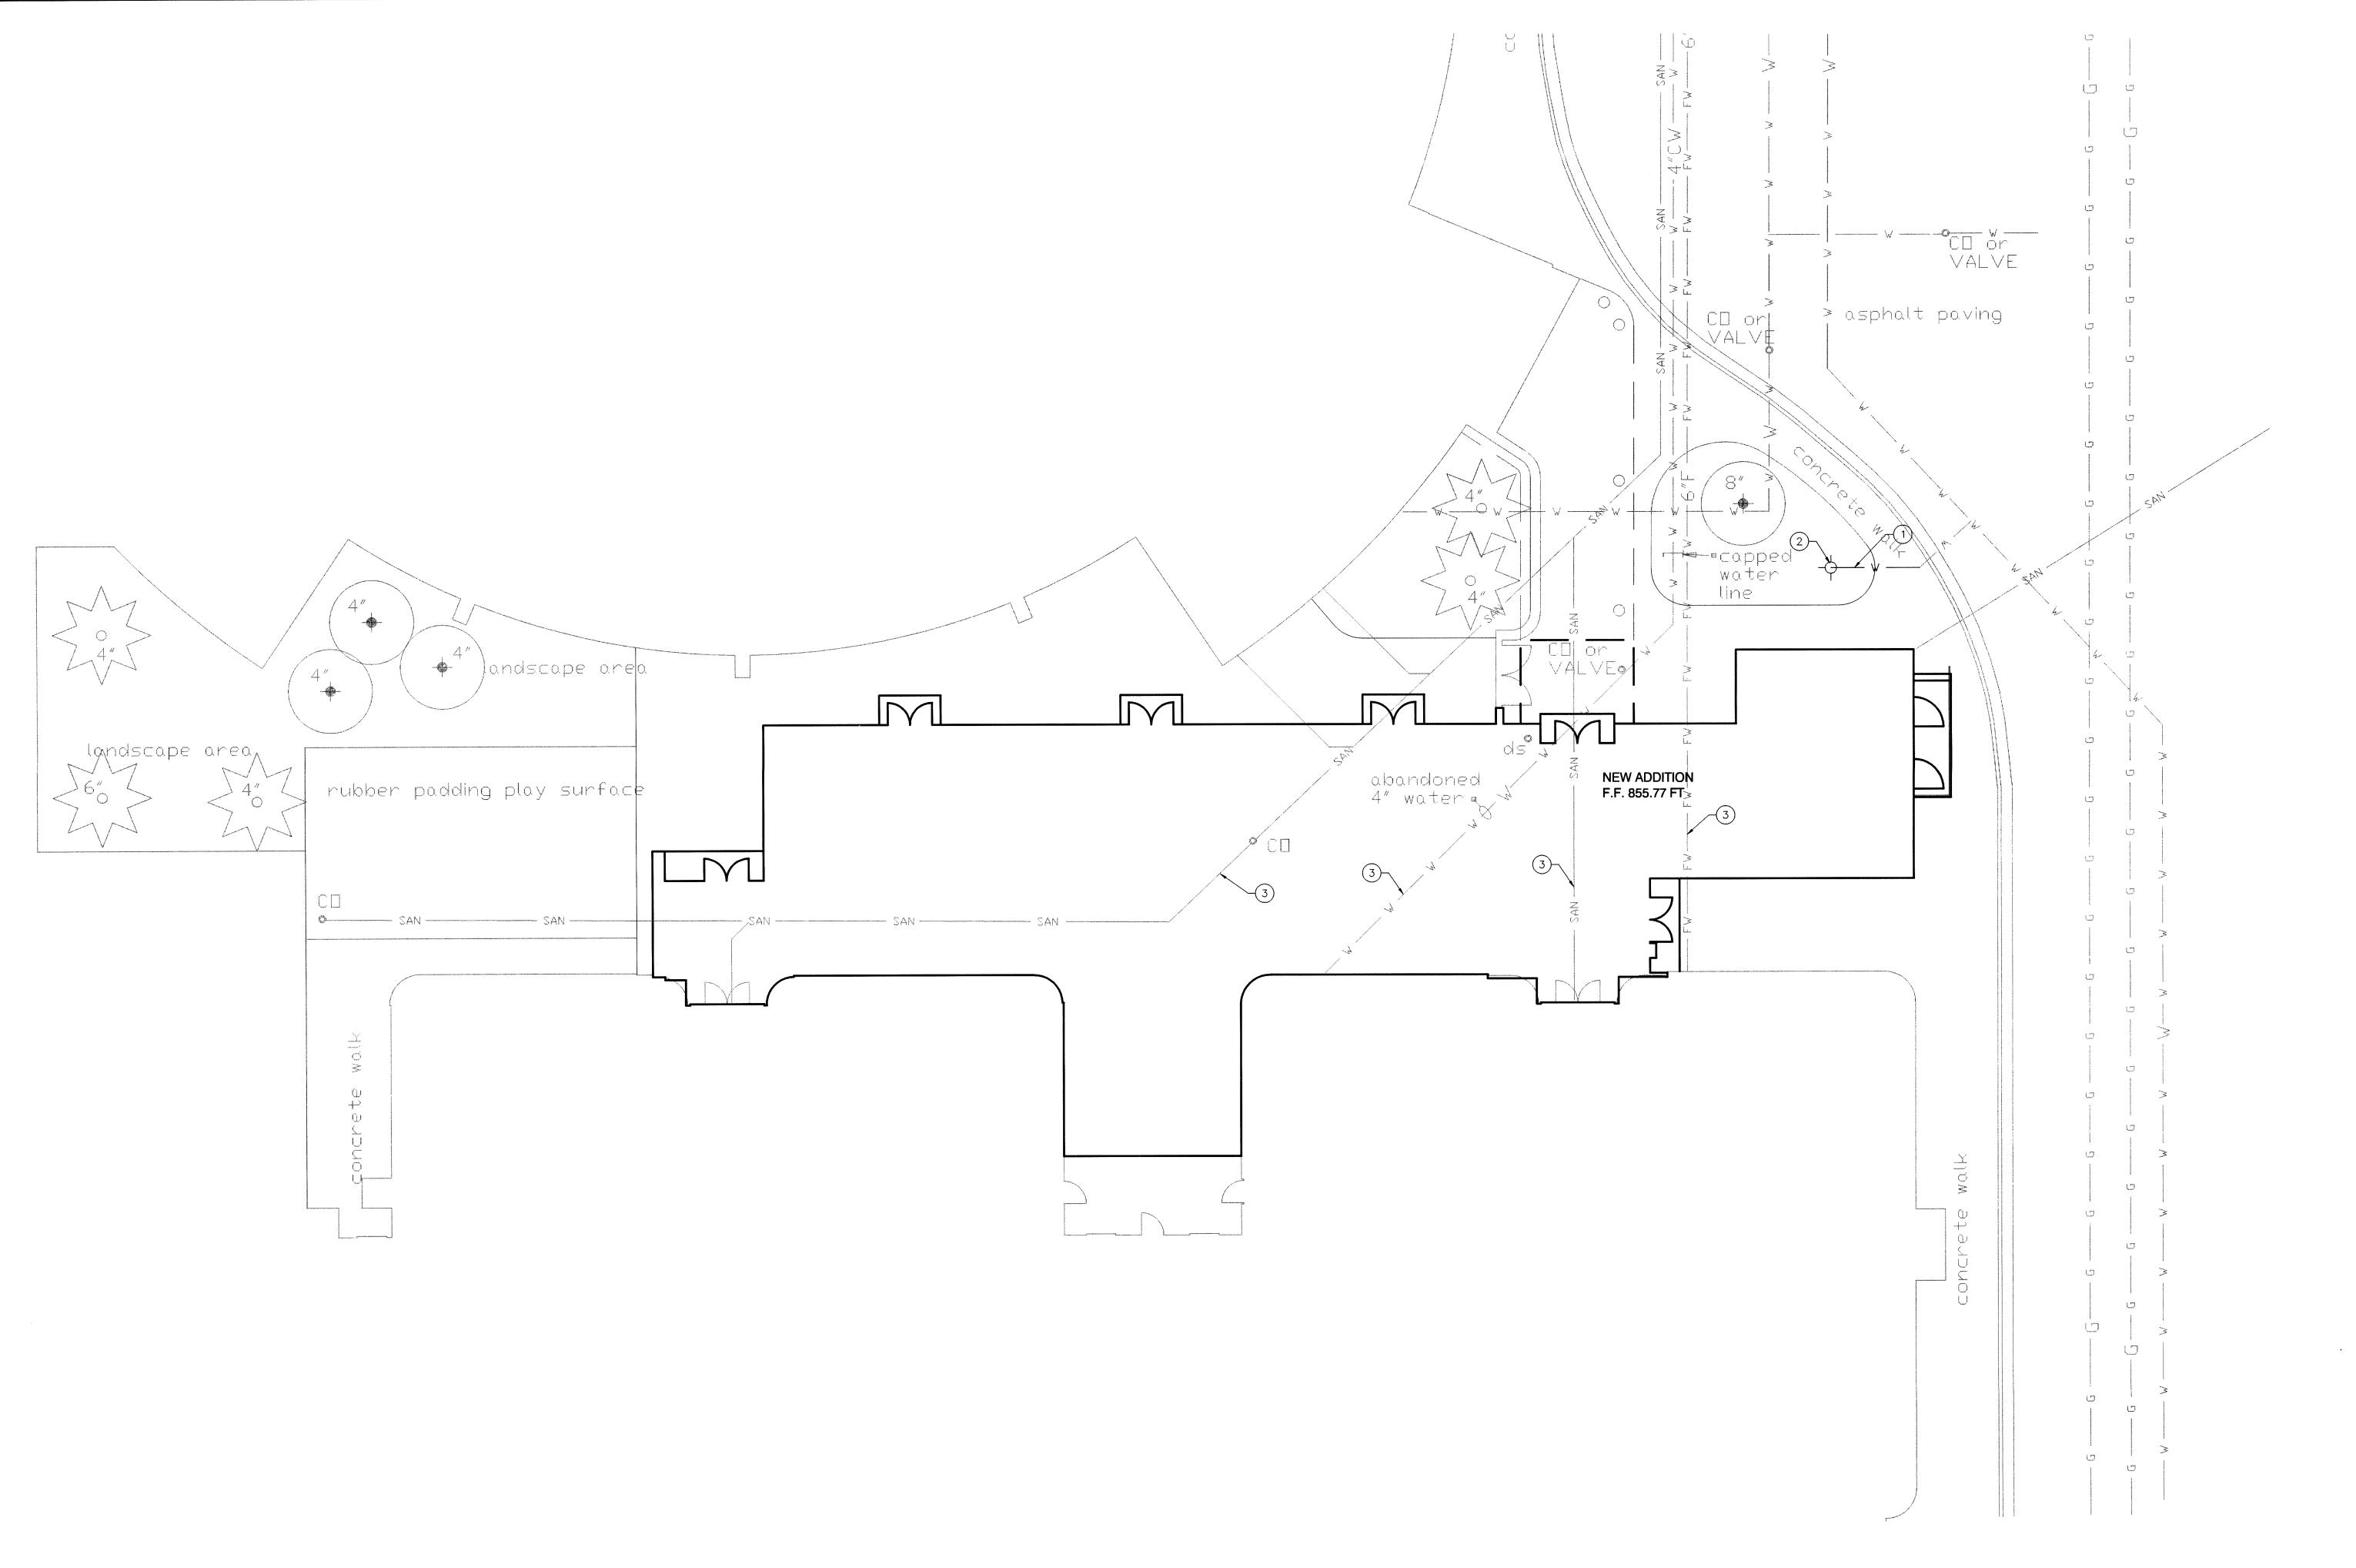



LAWRENCE CENTRALIZED KINDERGARTEN

NORTH & SOUTH CAMPUS ADDITIONS

METROPOLITAN SCHOOL DISTRICT
OF LAWRENCE TOWNSHIP

MARION COUNTY, INDIANA

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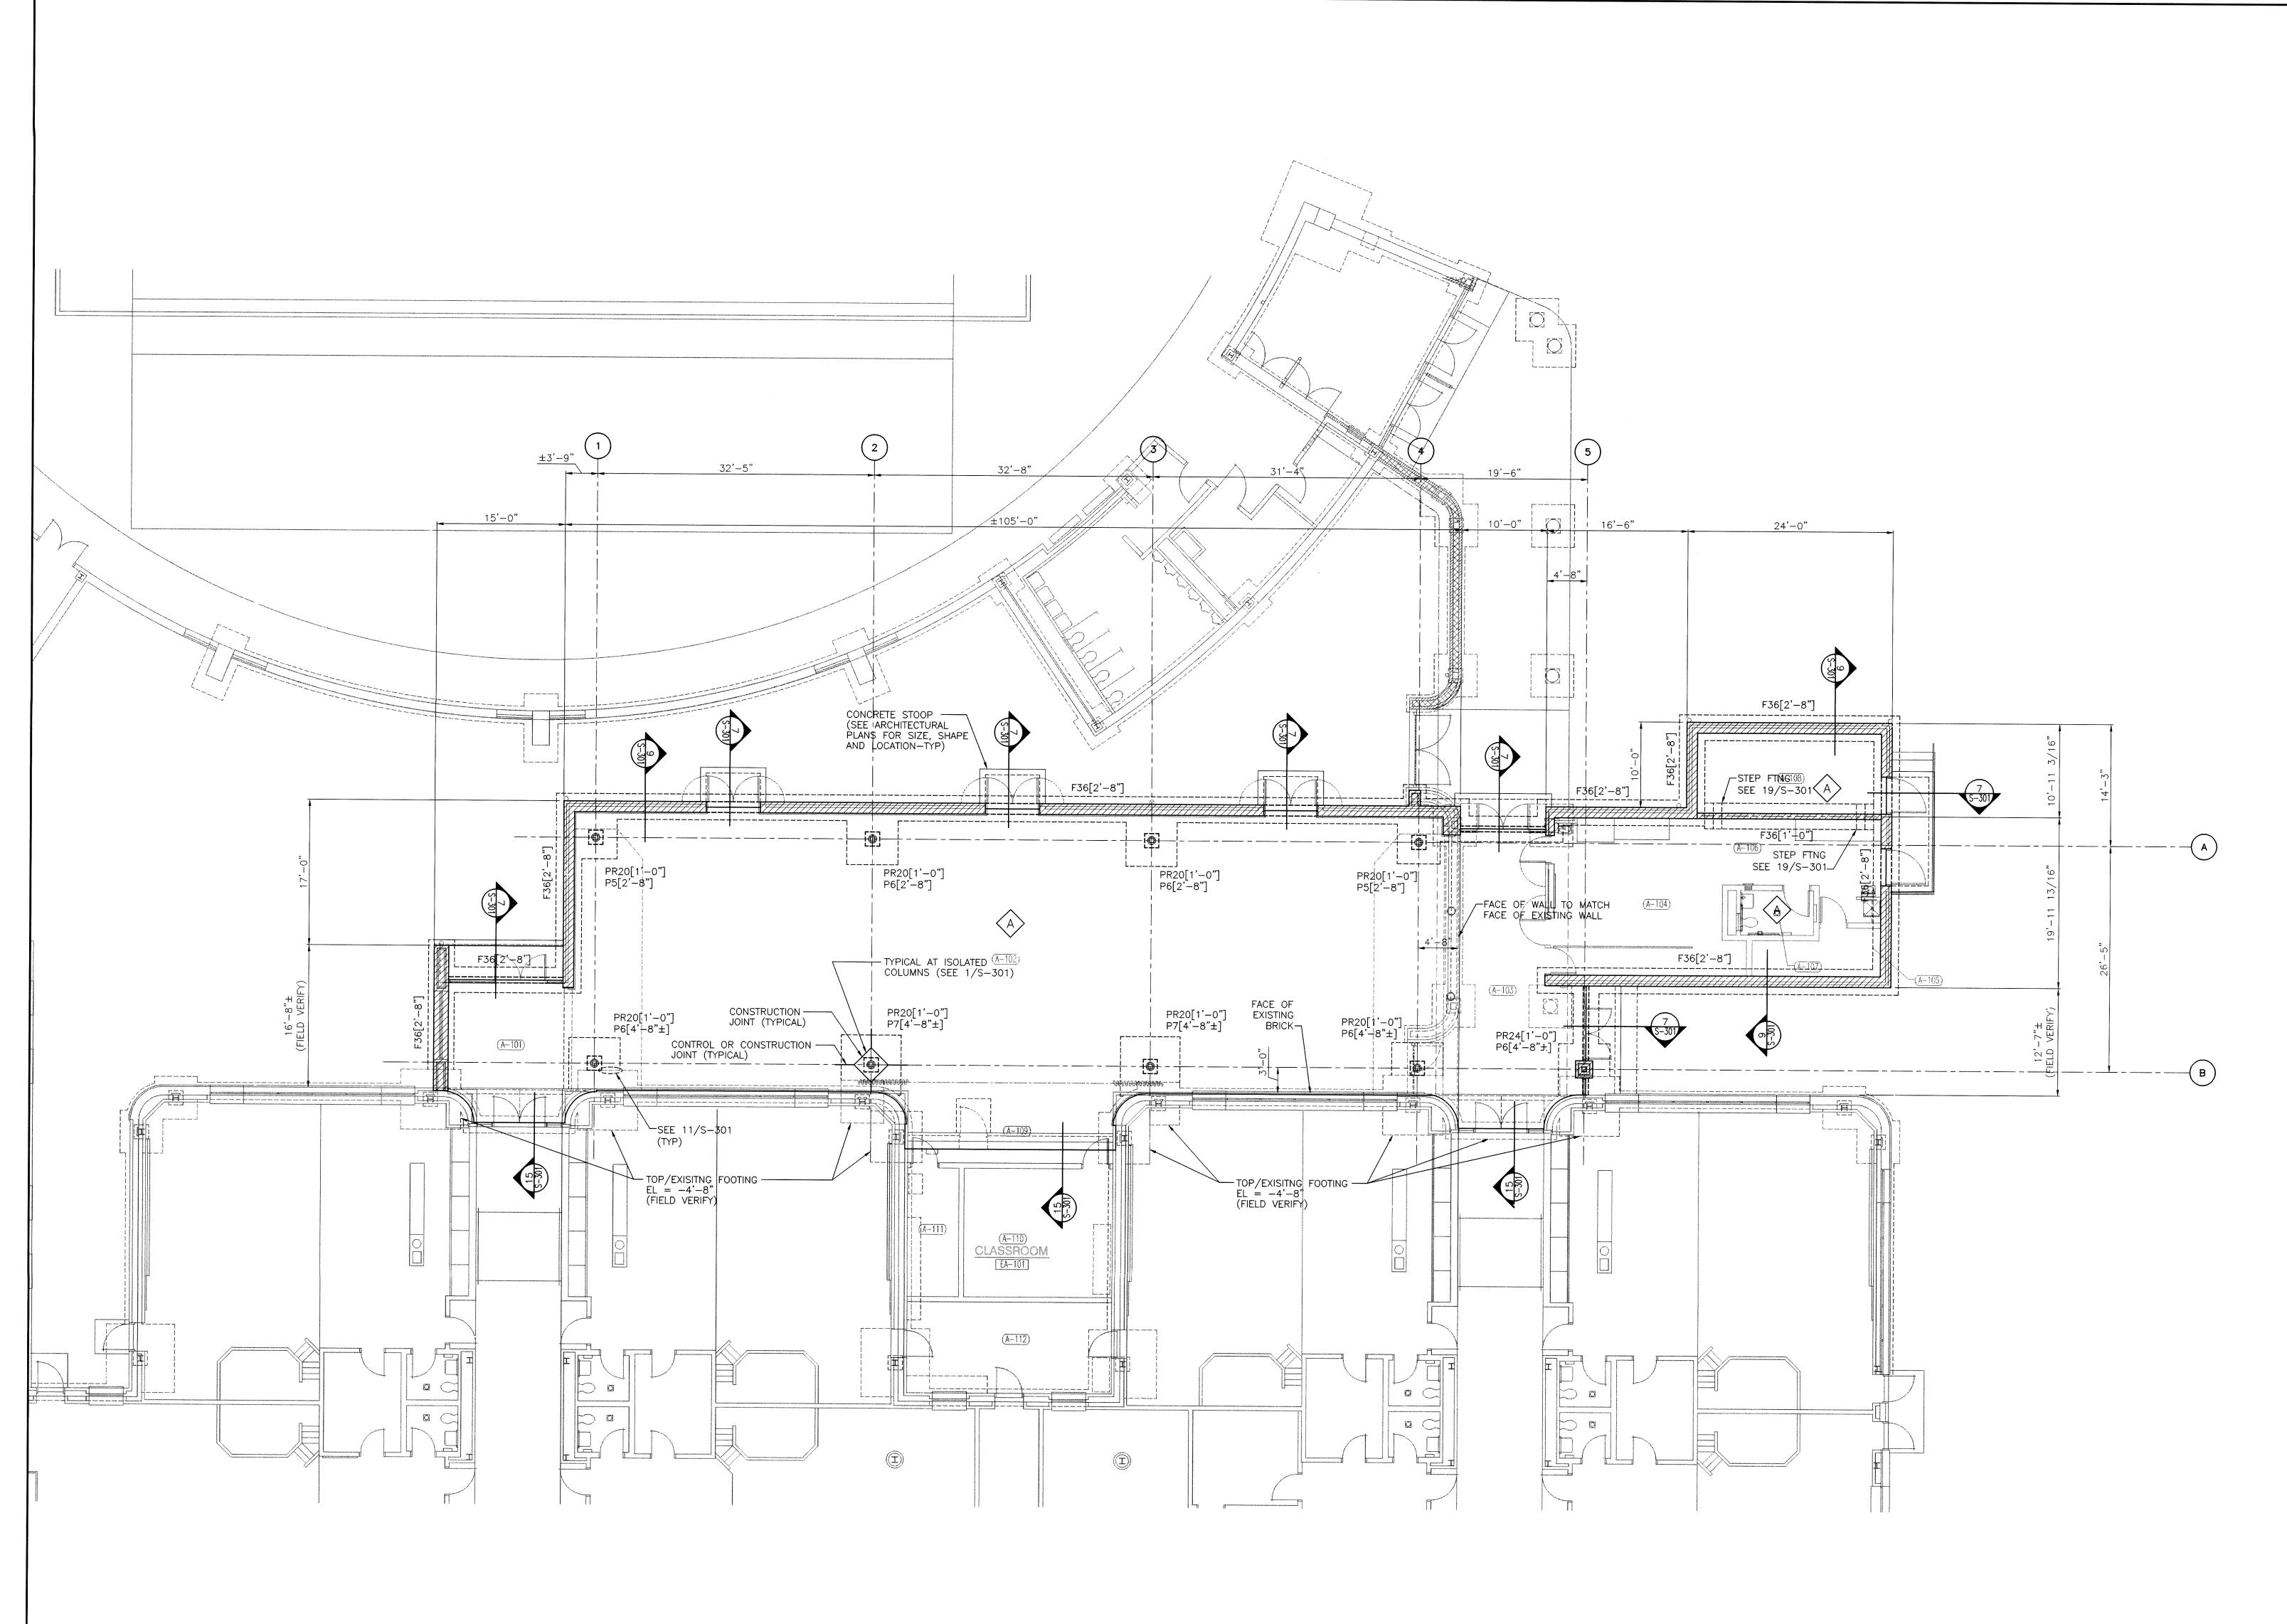
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DRAWING
CIVIL
UTILITY PLAN

PROJECT
LAWRENCE CENTRALIZED KINDERGARTEN
NORTH & SOUTH CAMPUS ADDITIONS


CU101



UNIT "A" FOUNDATION/SLAB PLAN SCALE: 1/8"=1'-0"

FOUNDATION/SLAB PLAN NOTES

- SEE SHEET S-001 FOR GENERAL NOTES, STRUCTURAL LEGEND, SCHEDULES AND TYPICAL DETAILS.
- 2. ALL ELEVATIONS ARE REFERENCED FROM A FINISH FLOOR ELEVATION OF 0'-0" PER AREA. SEE PLAN AND VERIFY WITH ARCHITECTURAL FLOOR PLANS
- 3. SLAB CONTROL AND CONSTRUCTION JOINTS ARE TO BE LAID OUT PER CONTRACTOR PLANNED SEQUENCE OF COMPLETION. (SEE SPECIFICATION)
- 4. SEE S-301 FOR FOUNDATION AND SLAB DETAILS.
- 5. TOP OF INTERIOR FOOTING ARE TYPICALLY 1'-0" BELOW FINISH FLOOR ELEVATION UNLESS OTHERWISE NOTED. (SEE PLAN)

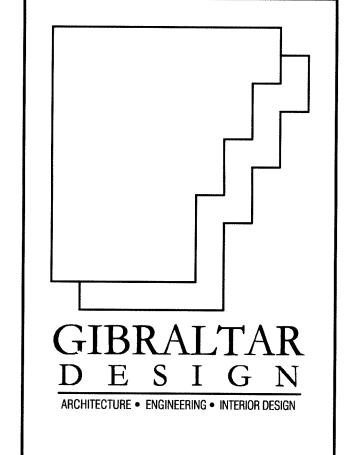


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LAWRENCE CENTRALIZED KINDERGARTEN

NORTH & SOUTH CAMPUS ADDITIONS

METROPOLITAN SCHOOL DISTRICT
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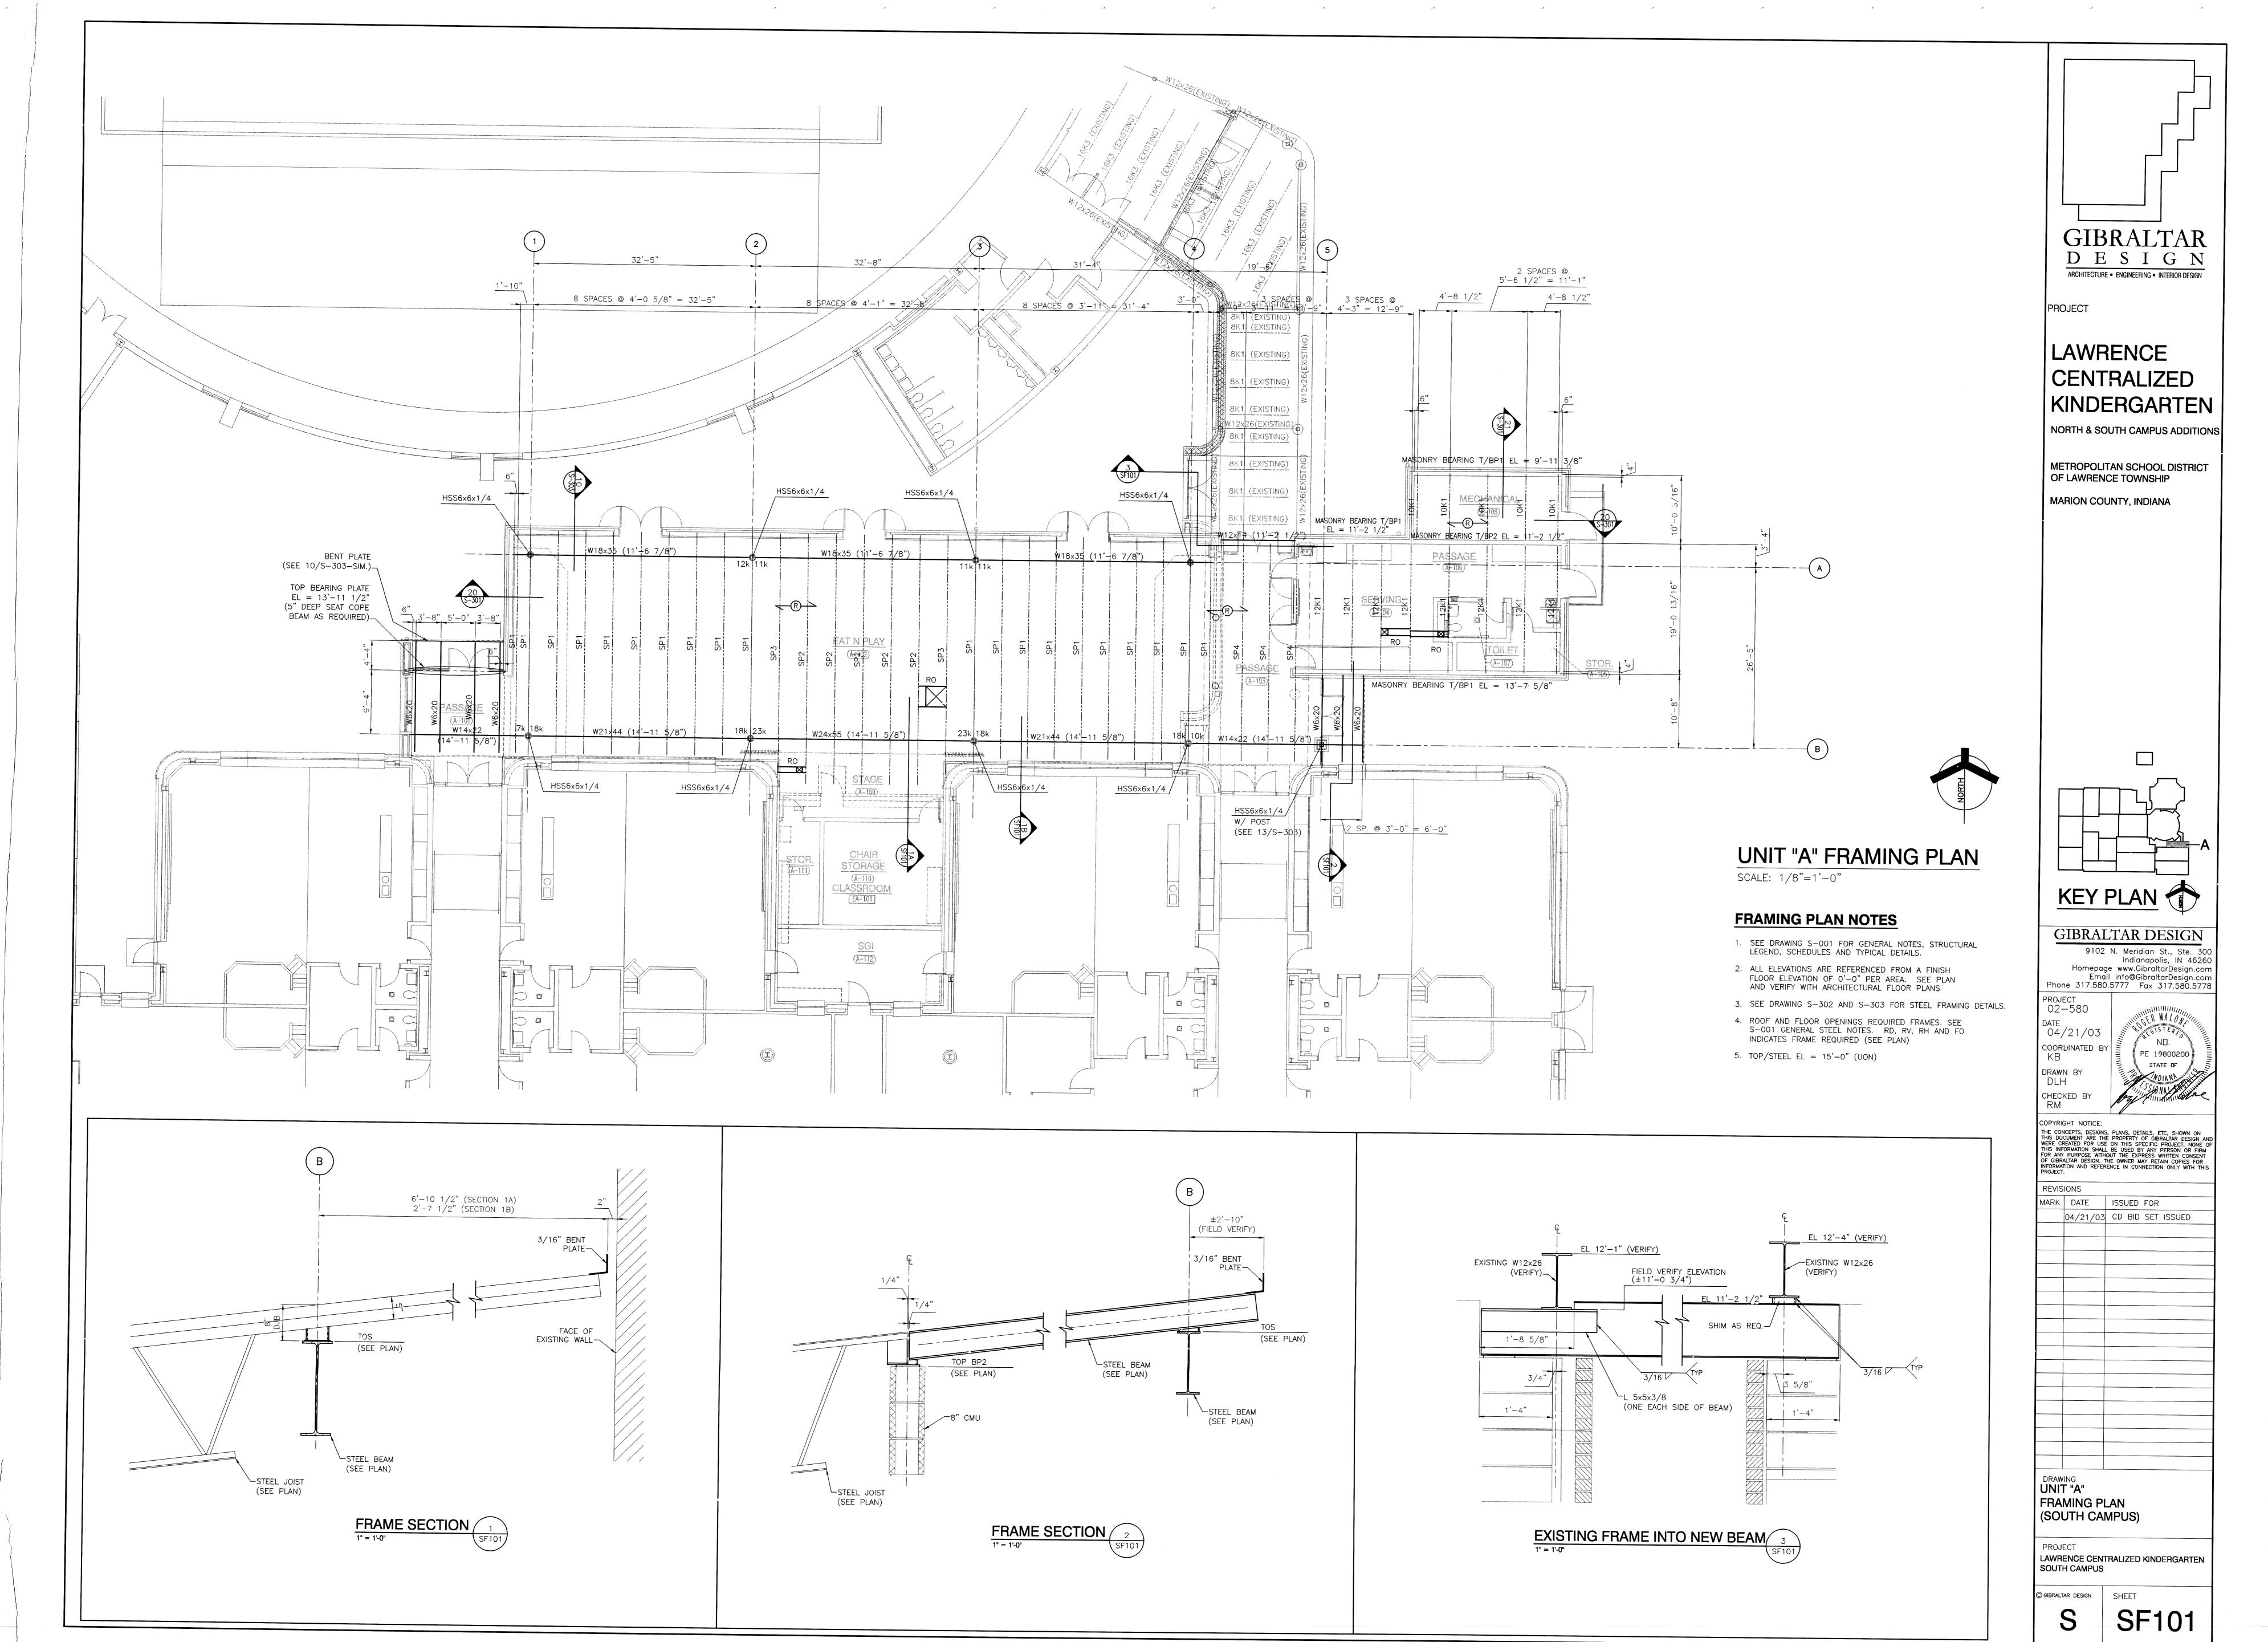
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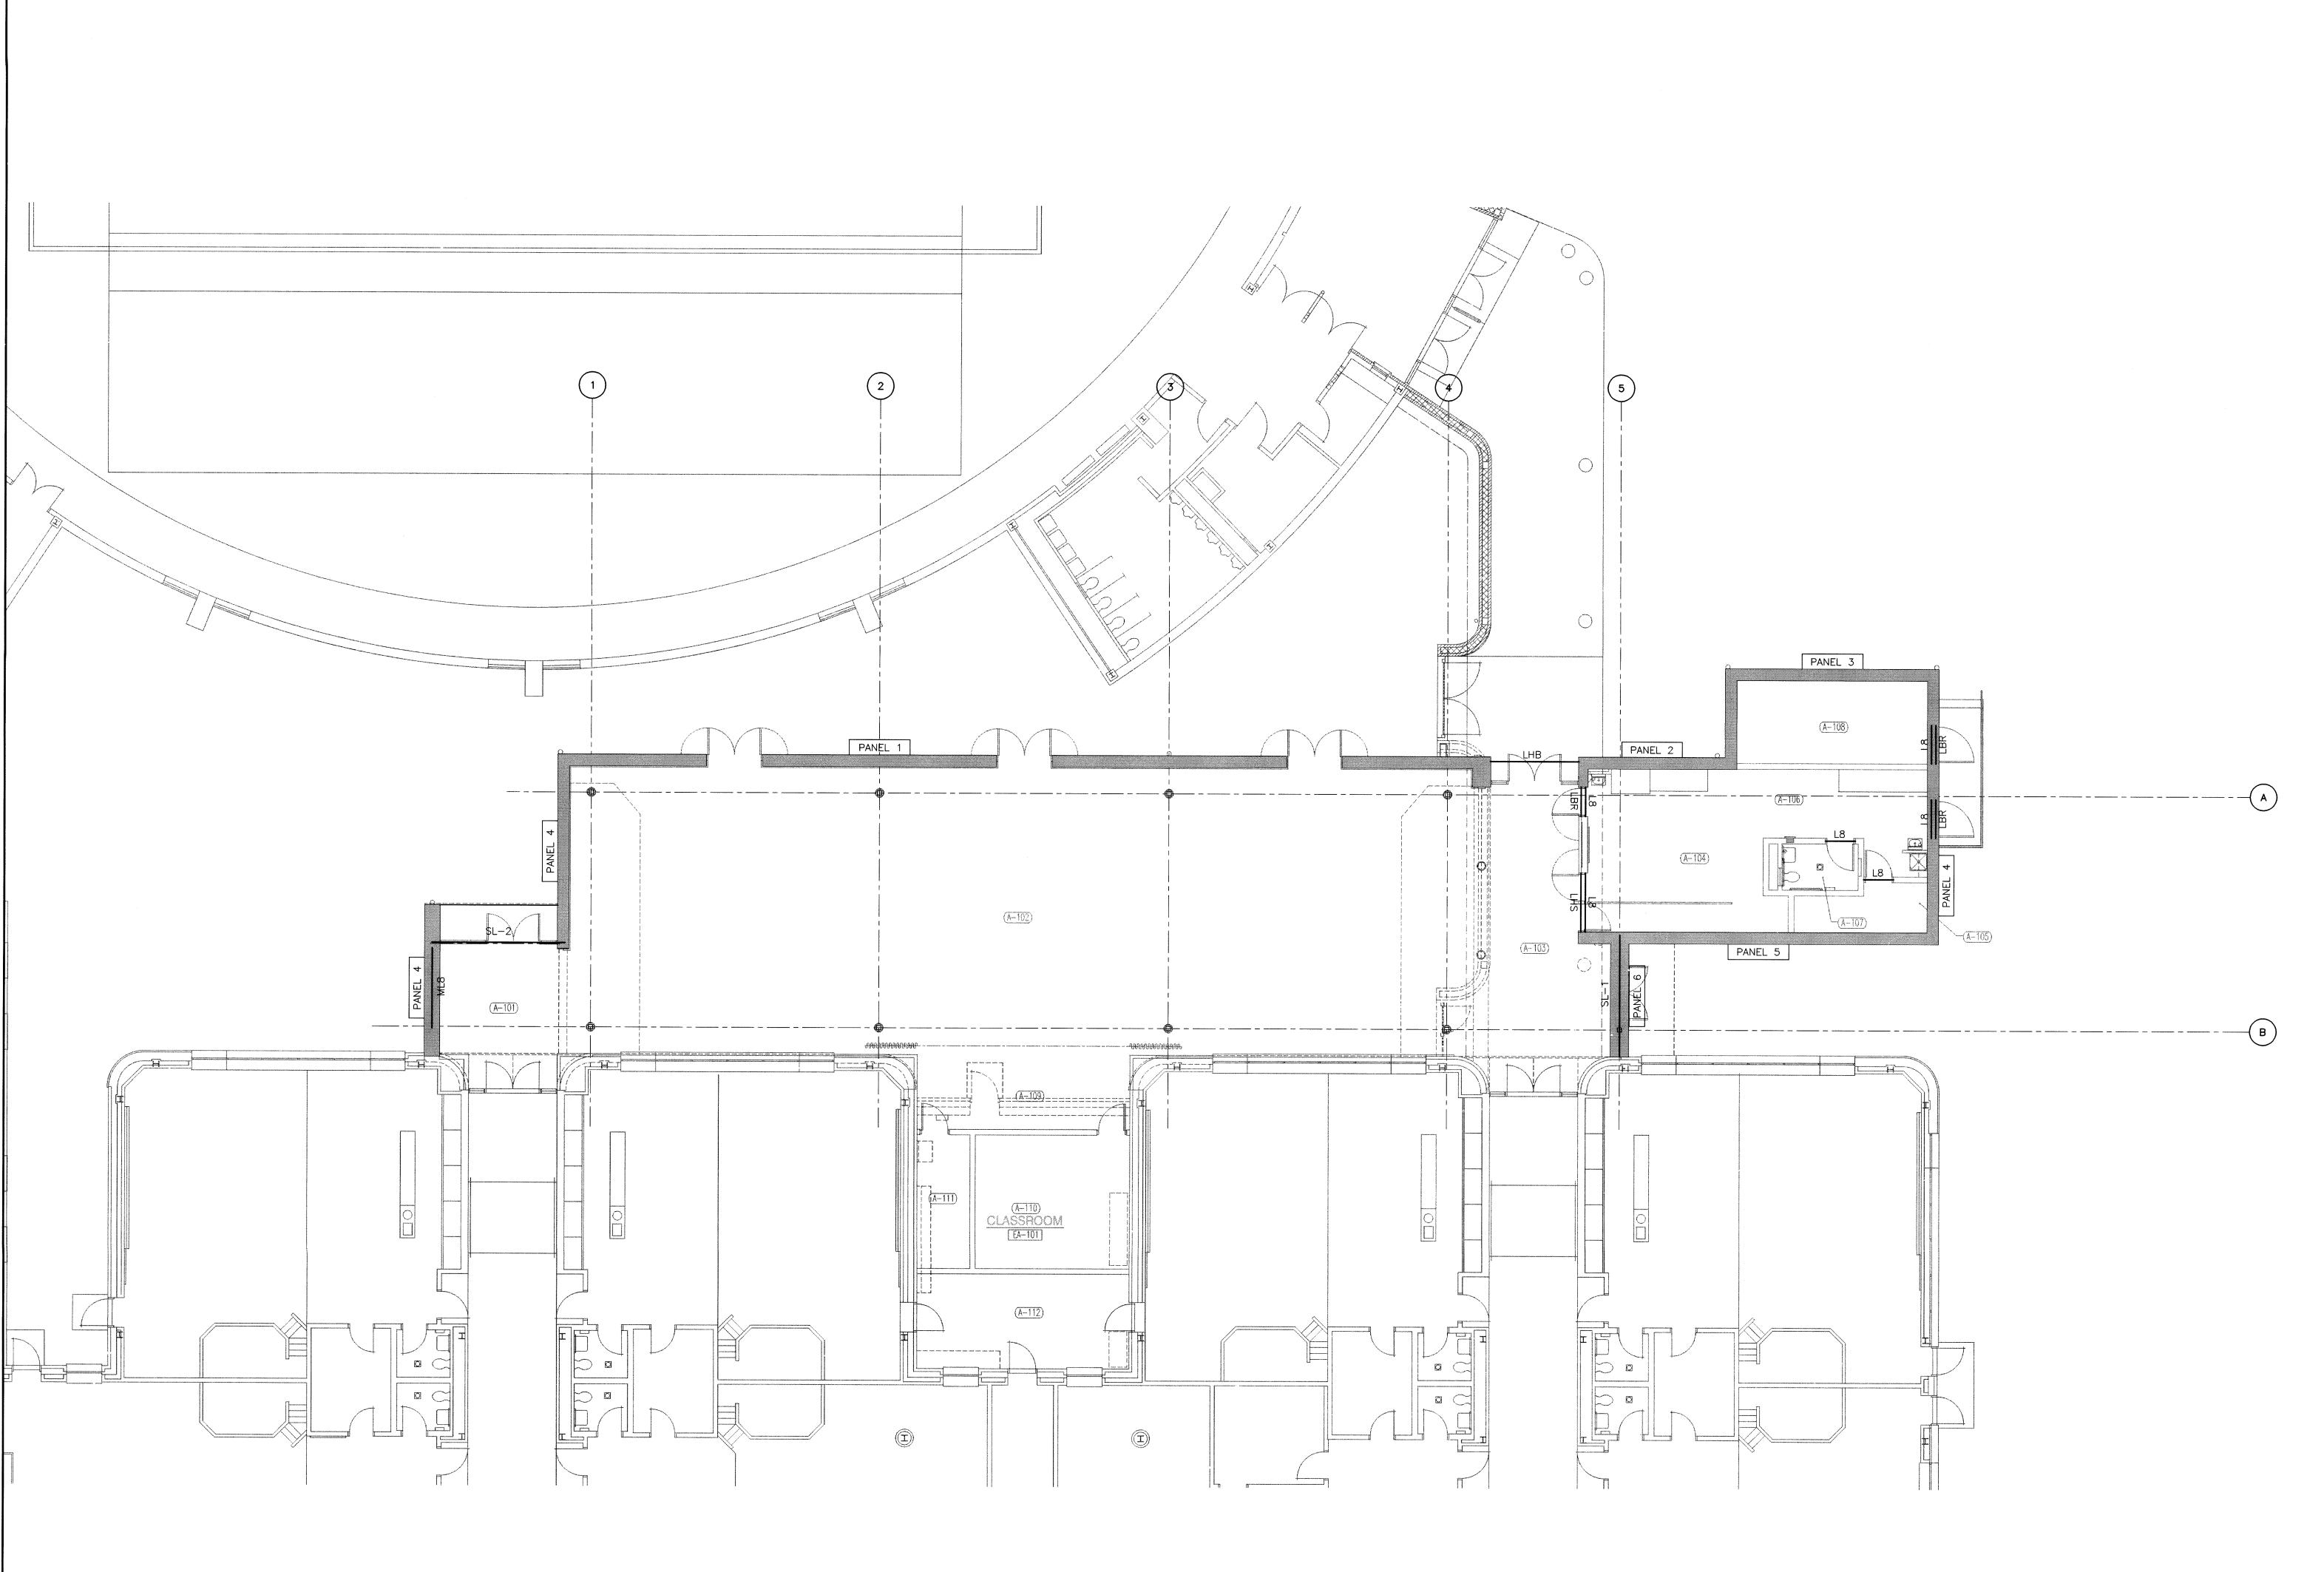
UNIT "A" FOUNDATION/SLAB PLAN (SOUTH CAMPUS)

PROJECT LAWRENCE CENTRALIZED KINDERGARTEN SOUTH CAMPUS

C) GIBRALTAR DESIGN SHEET

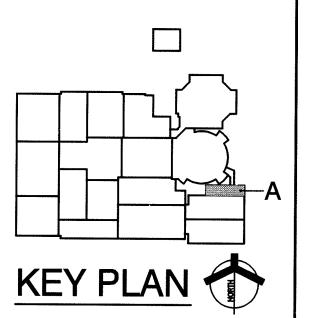SB101






UNIT "A" MASONRY PANEL REINFORCING/LINTEL PLAN


SCALE: 1/8"=1'-0"

MASONRY/LINTEL PLAN NOTES

- SEE DRAWING S-001 FOR NOTES, SCHEDULES AND TYPICAL DETAILS.
- SEE DRAWING S-303 FOR MASONRY WALL LINTEL DETAILS.
- 3. SEE DRAWING S-001 FOR MASONRY AND STEEL
- LINTEL SCHEDULES.
- 4. VERIFY ALL LINTEL OPENINGS AND ELEVATIONS WITH ARCHITECTURAL PLAN.
- 5. SL—? INDICATES SPECIAL LINTEL REQUIRED. SEE DRAWING S—001 FOR SPECIAL LINTEL SCHEDULE.
- 6. PANEL ? INDICATES MASONRY WALL PANEL. SEE DRAWING S-001 FOR MASONRY PANEL SCHEDULE AND REINFORCEMENT REQUIREMENTS.
- FOR MULTI-SPAN CONTINUOUS LINTELS MAINTAIN 16" MINIMUM CMU BETWEEN OPENINGS UNLESS OTHERWISE

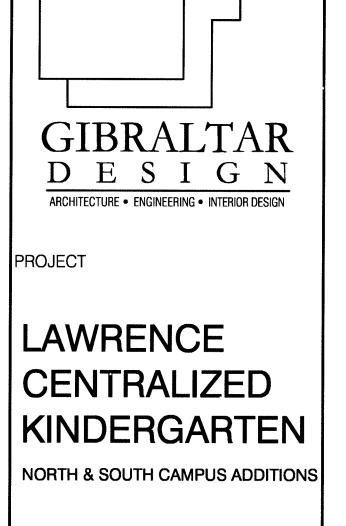

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Email info@GibraltarDesign.com
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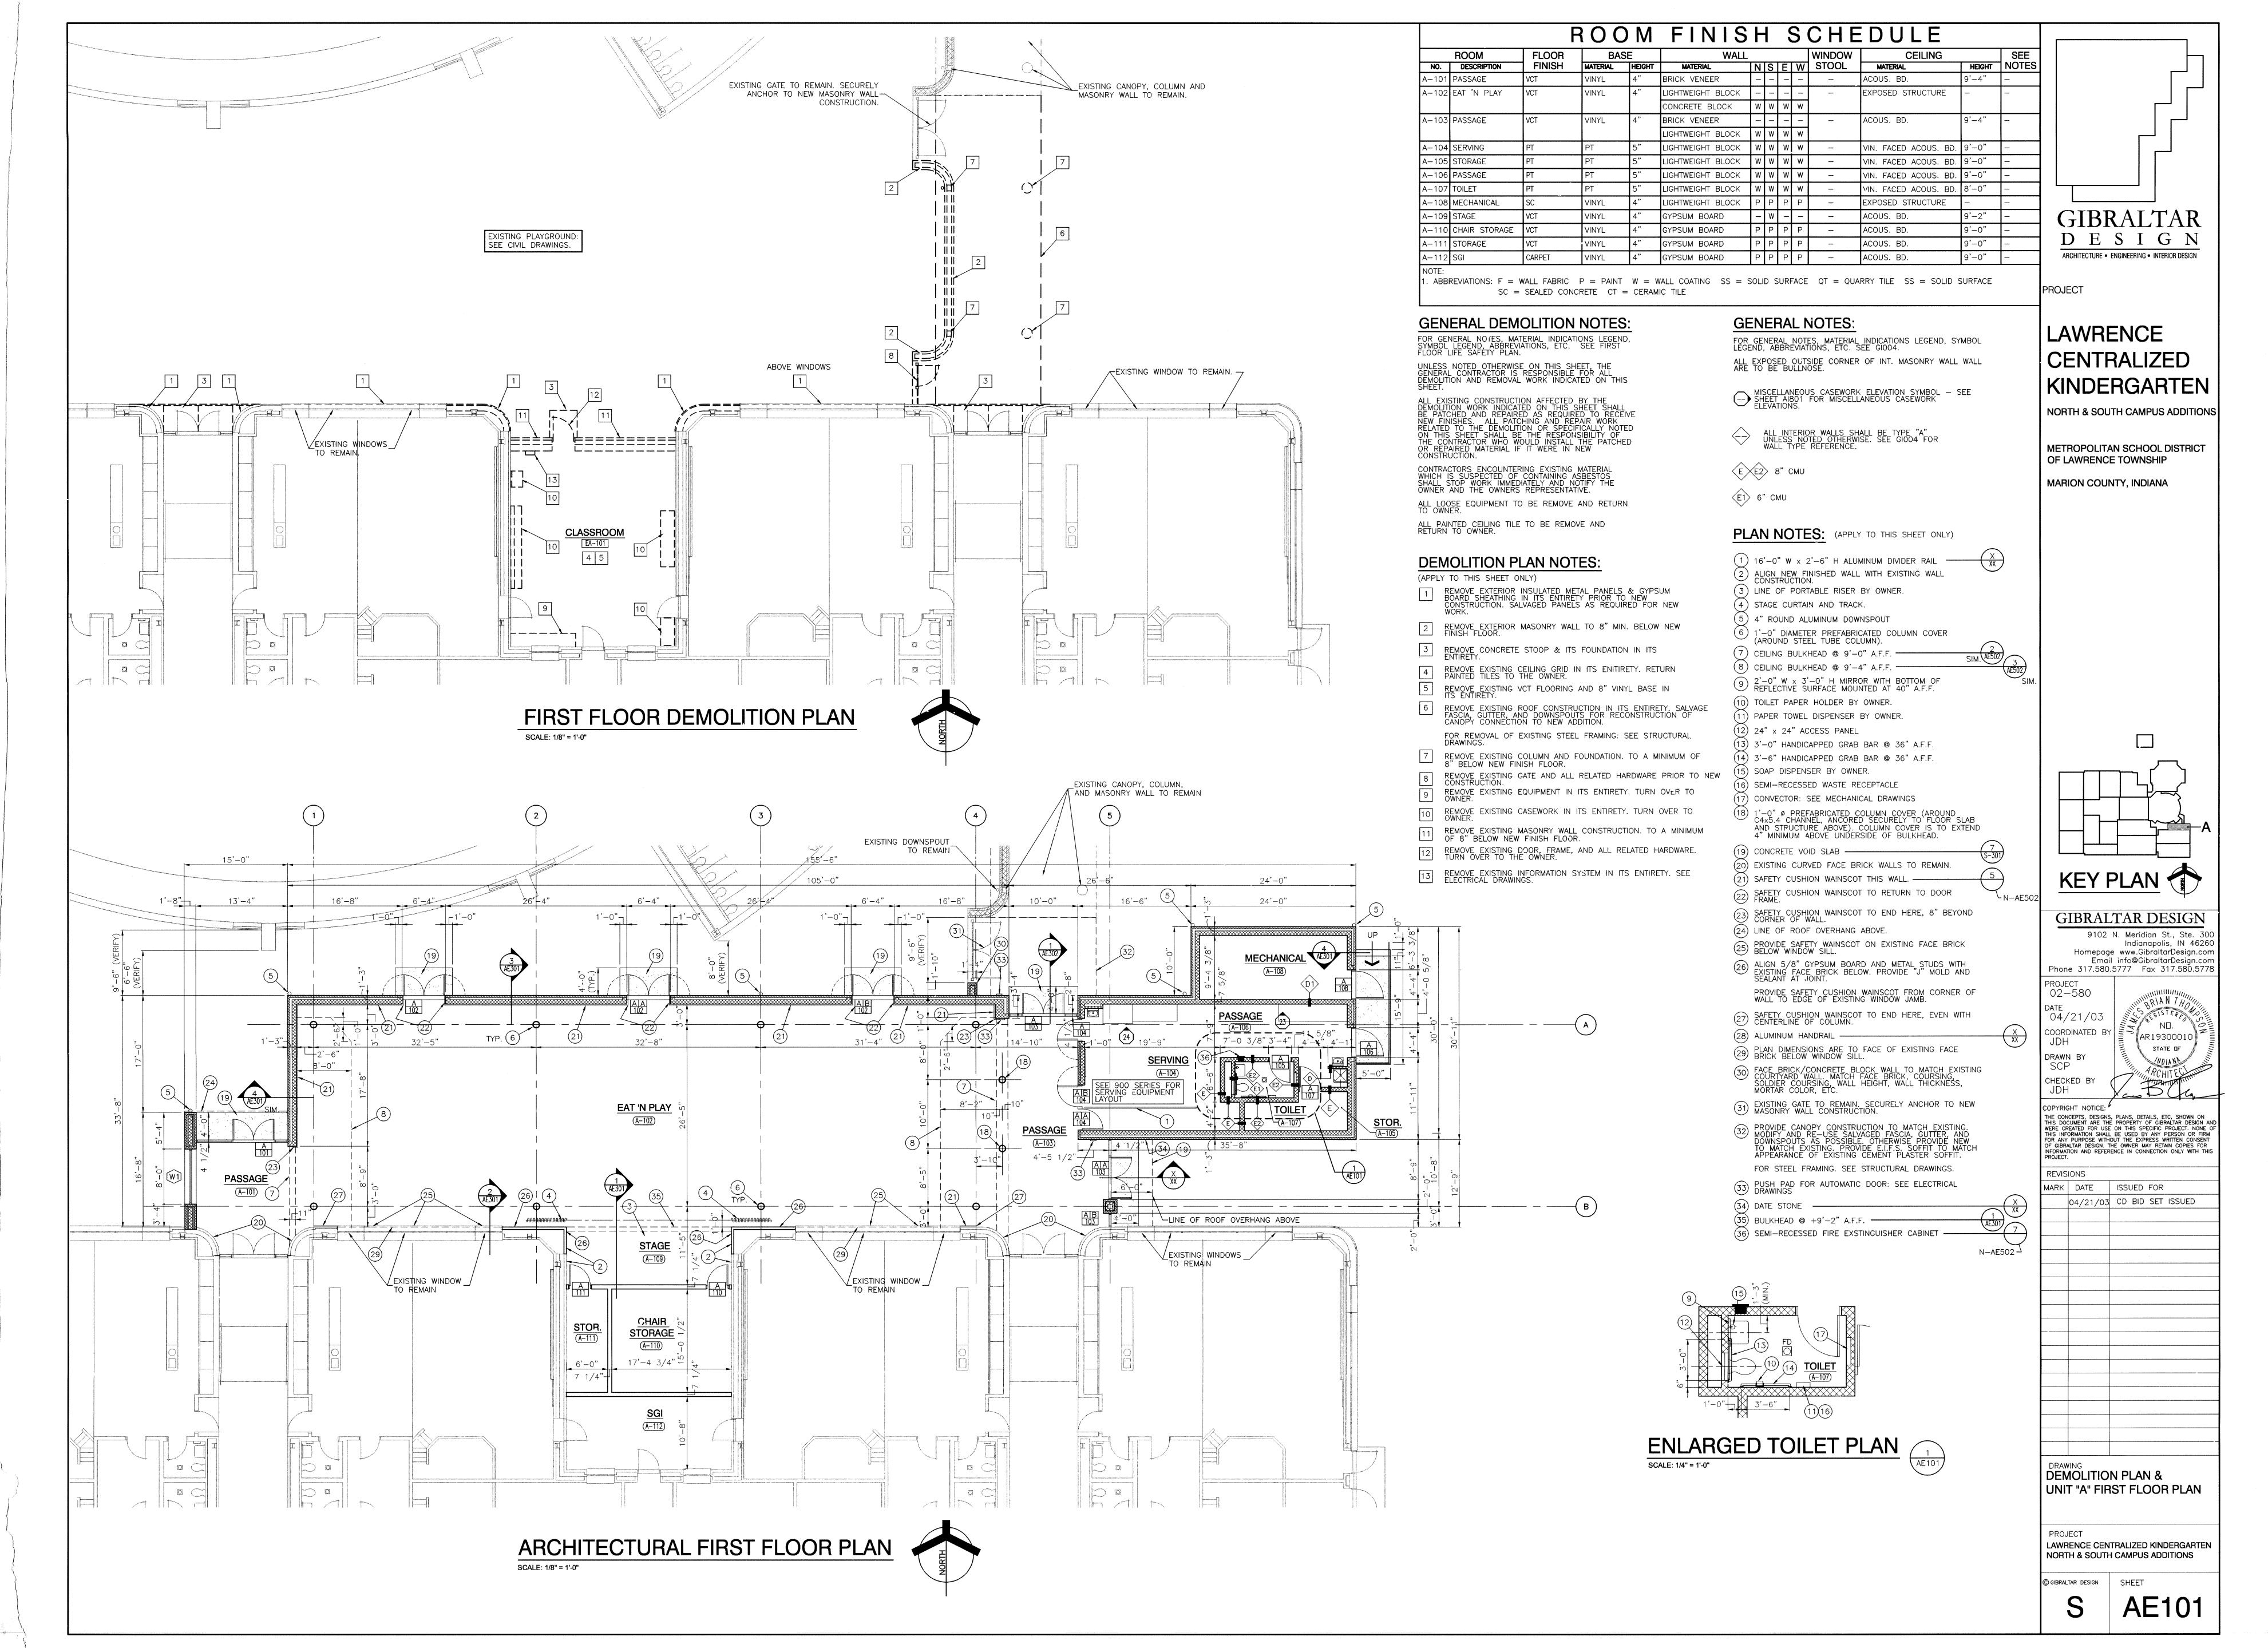
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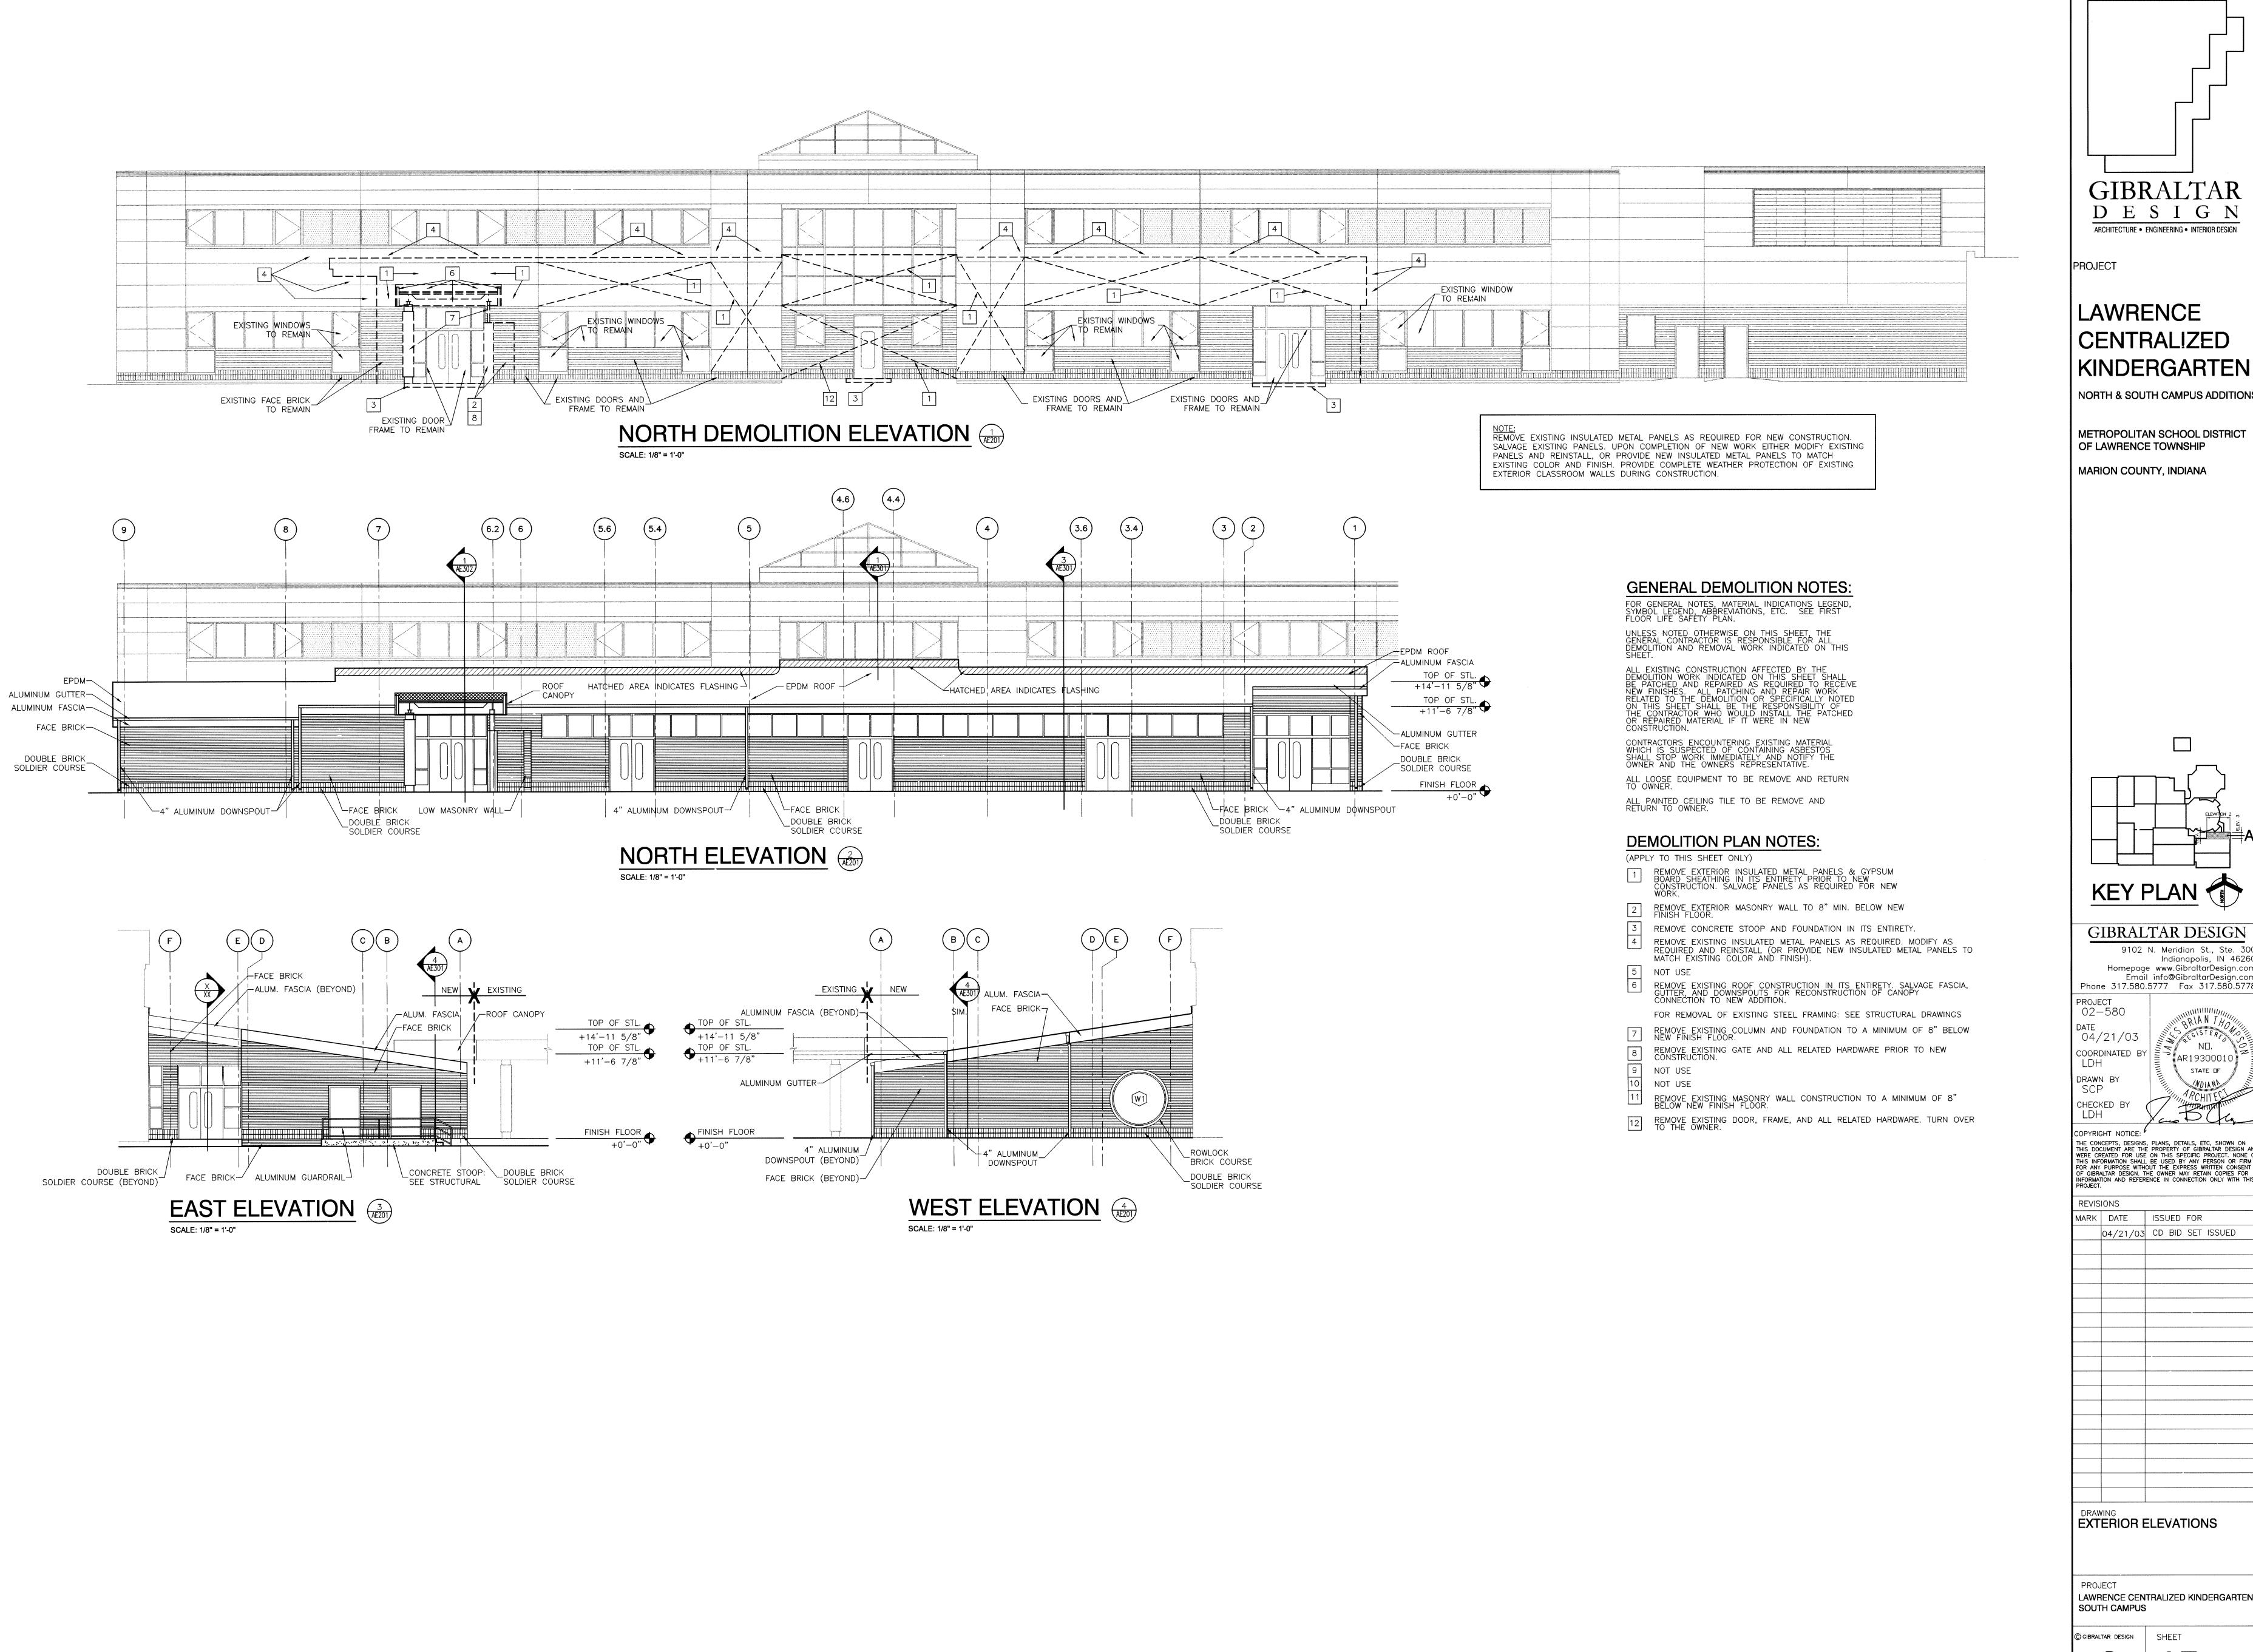
DRAWING
UNIT "A"
MASONRY PANEL
REINFORCING/LINTEL PLAN
(SOUTH CAMPUS)

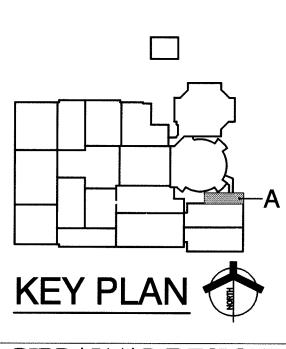PROJECT
LAWRENCE CENTRALIZED KINDERGARTEN
SOUTH CAMPUS

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SL10⁻






D E S I G N ARCHITECTURE • ENGINEERING • INTERIOR DESIGN

CENTRALIZED KINDERGARTEN

MARION COUNTY, INDIANA

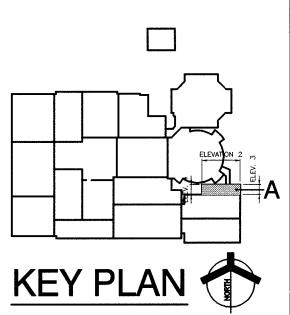


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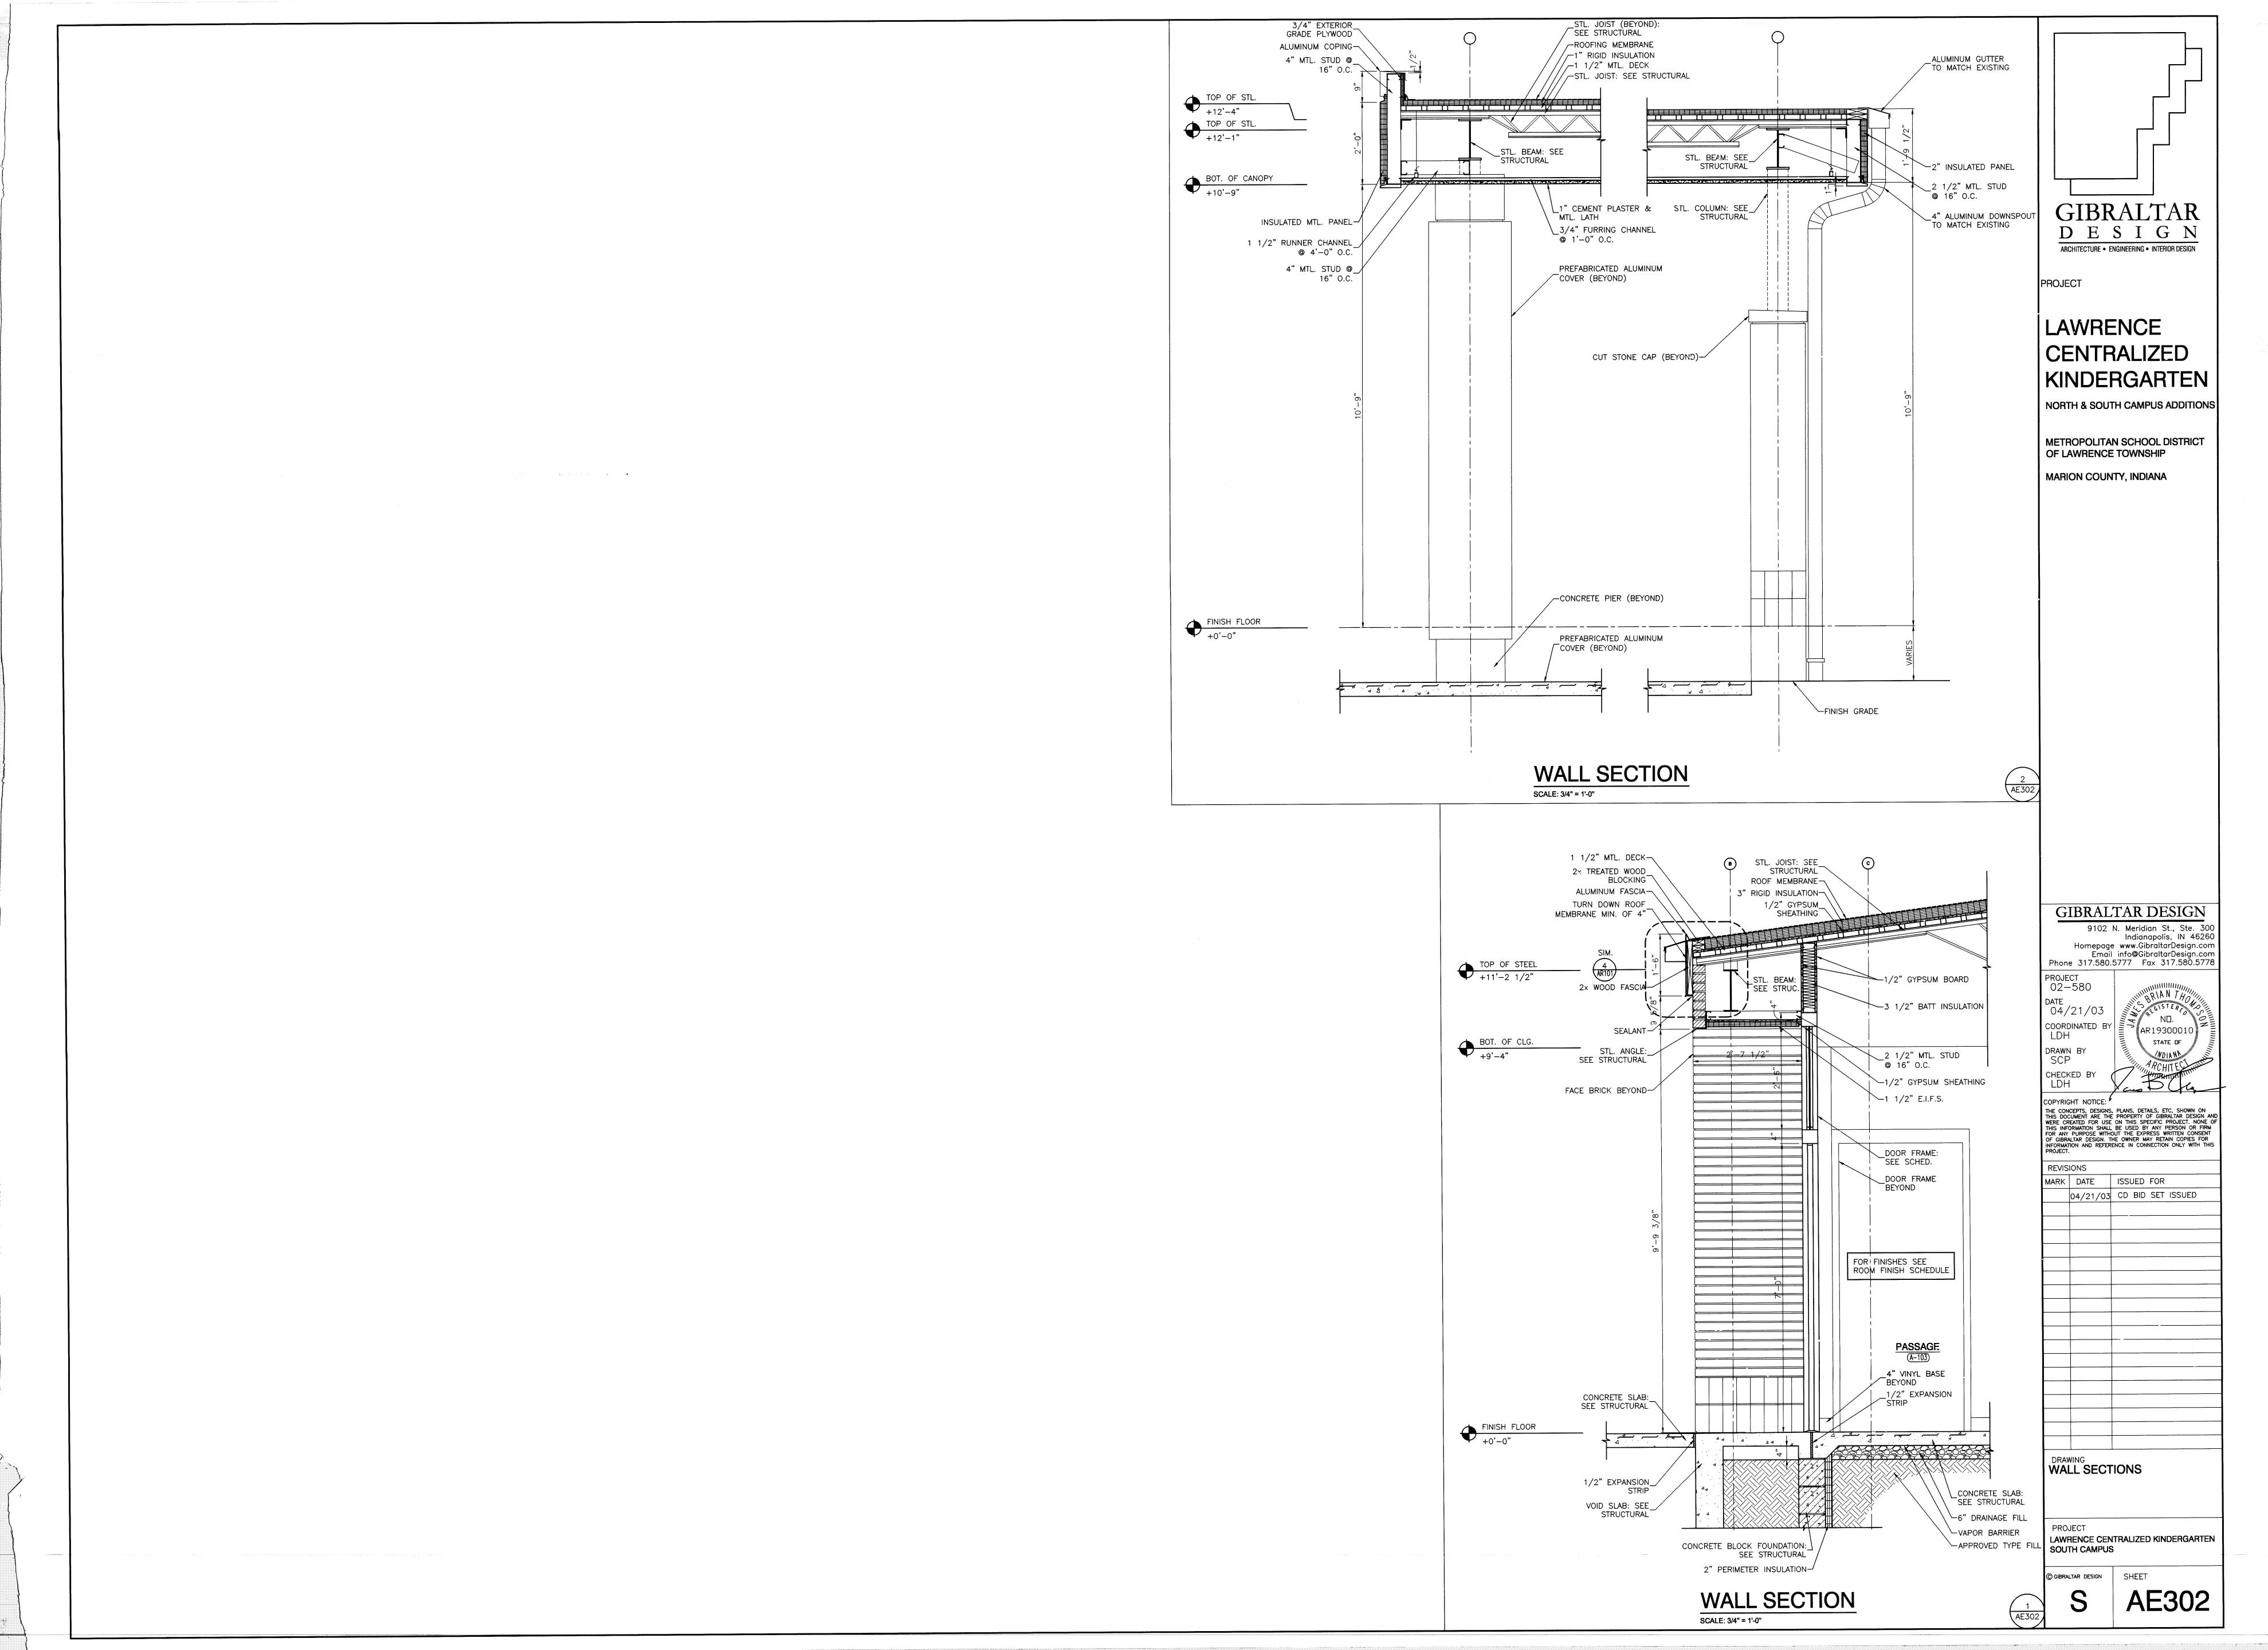
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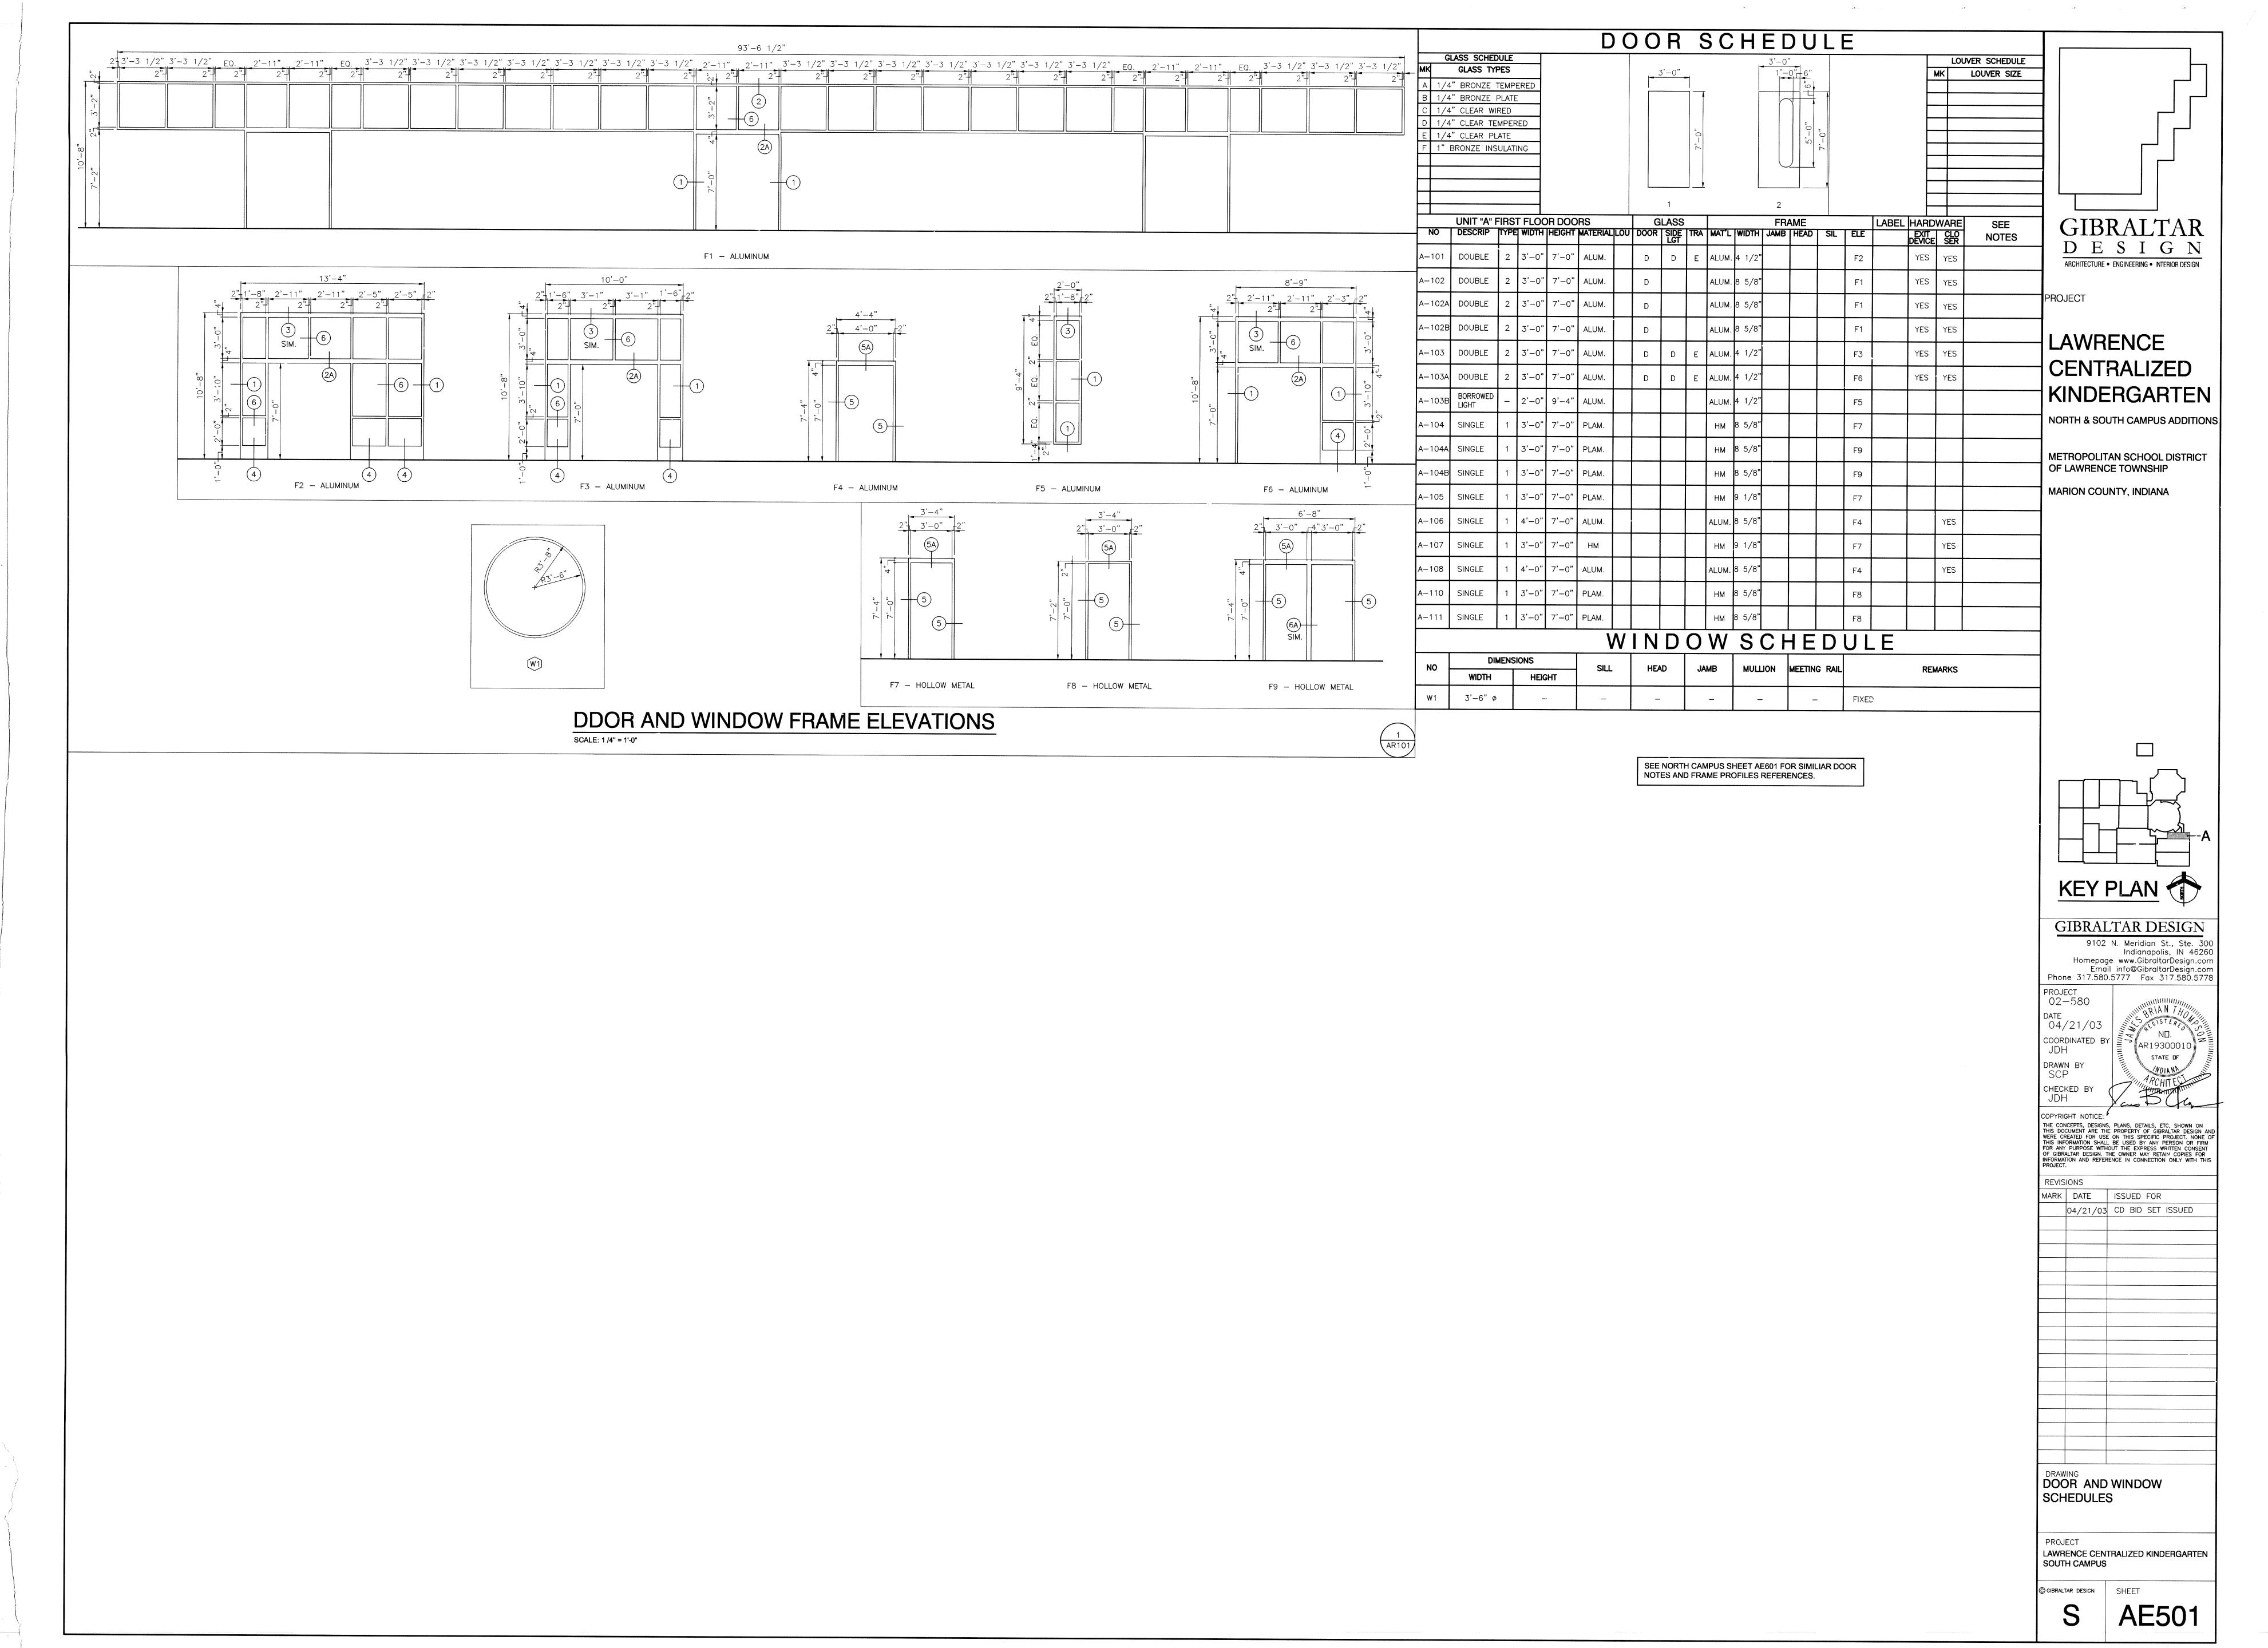
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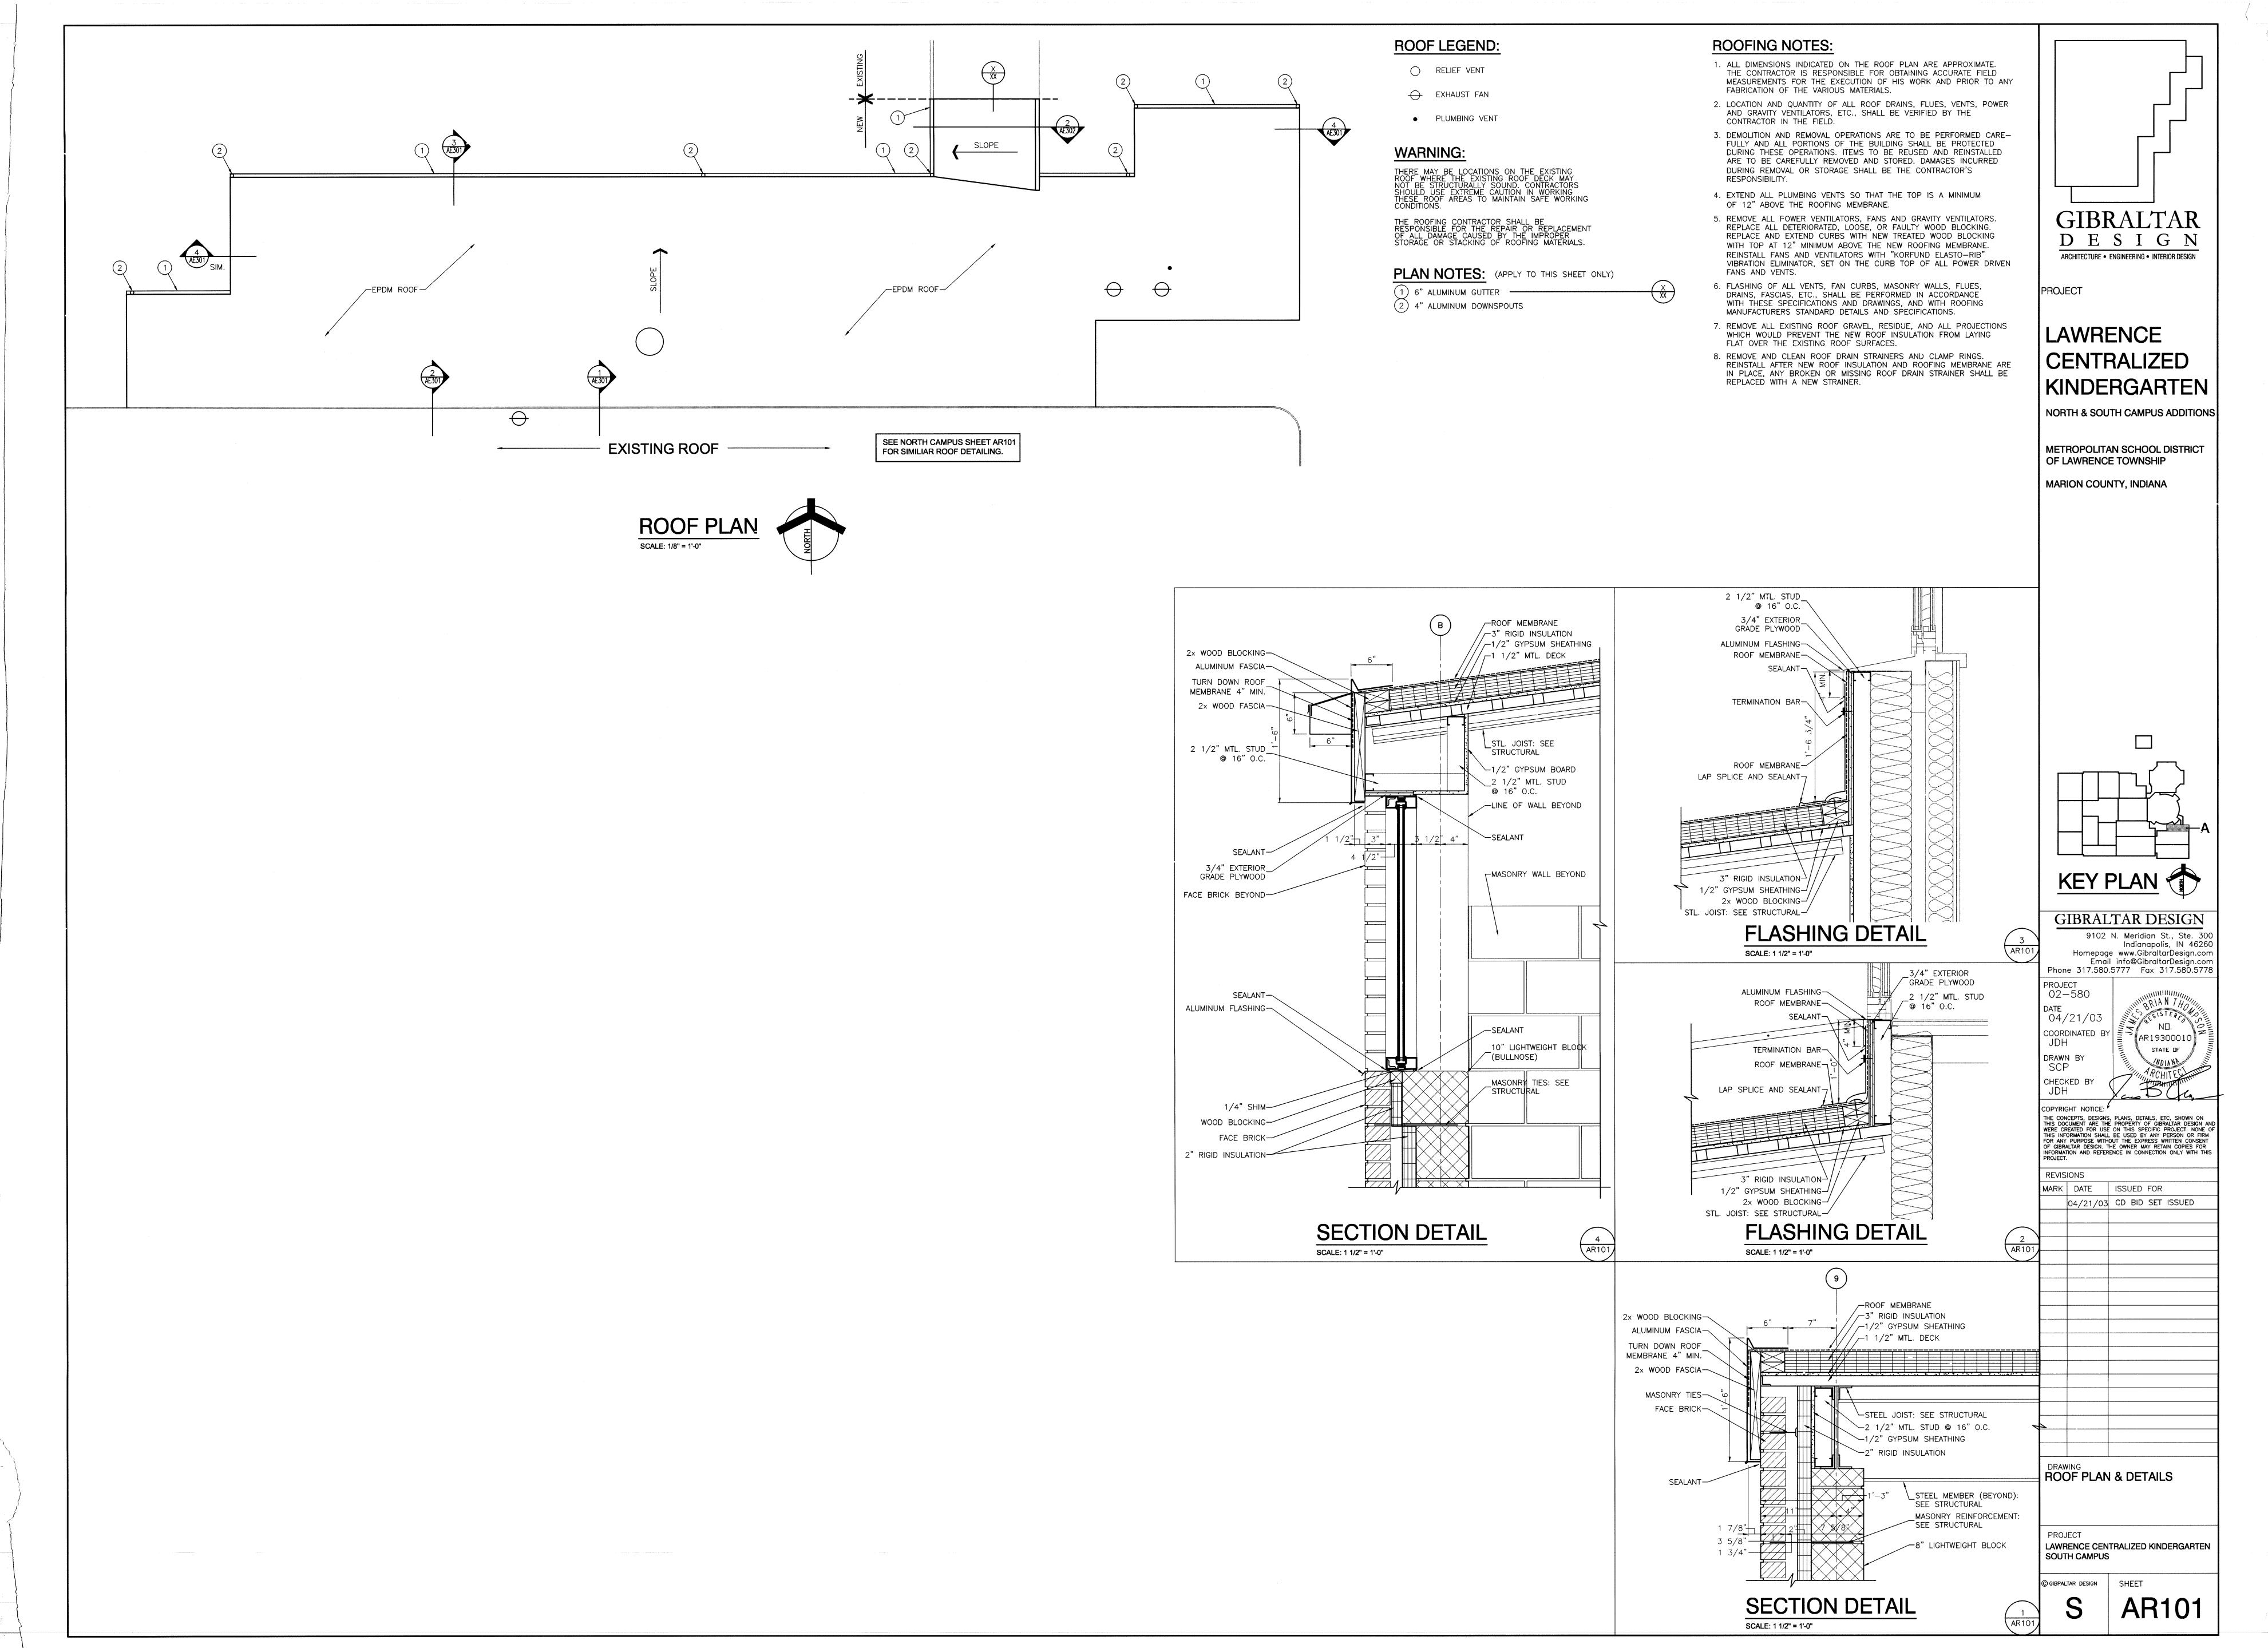
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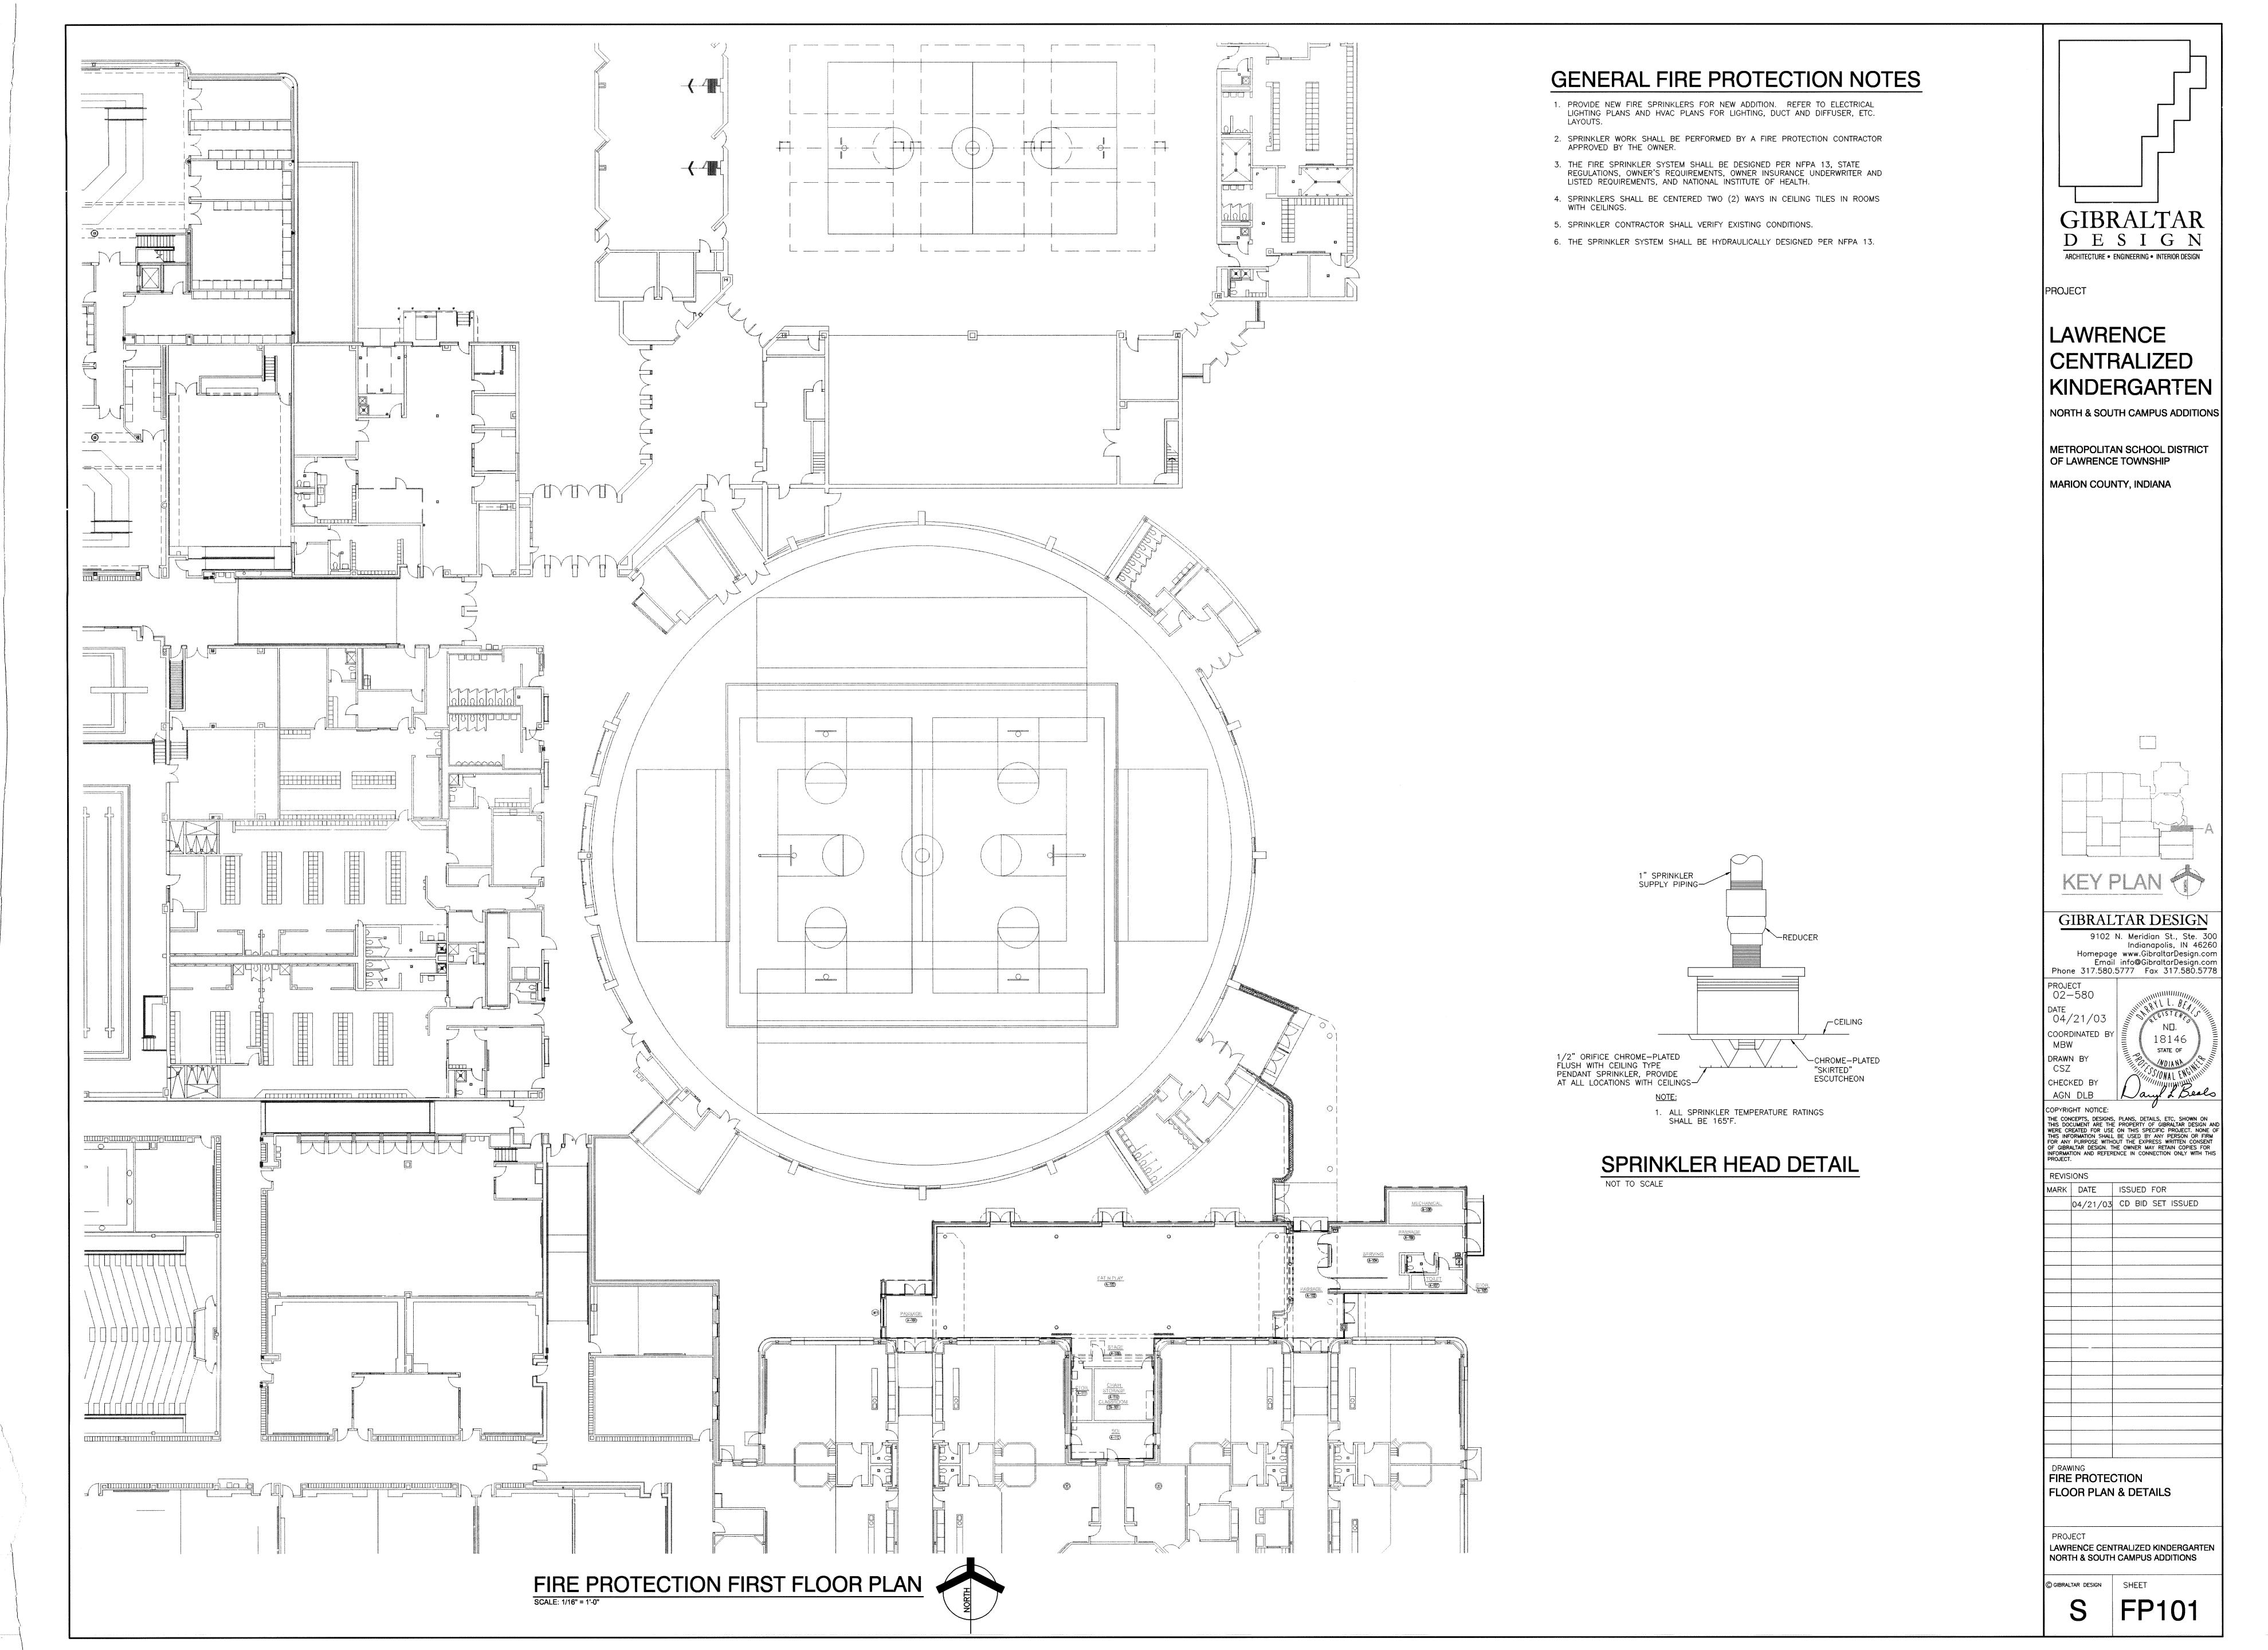
LAWRENCE CENTRALIZED KINDERGARTEN










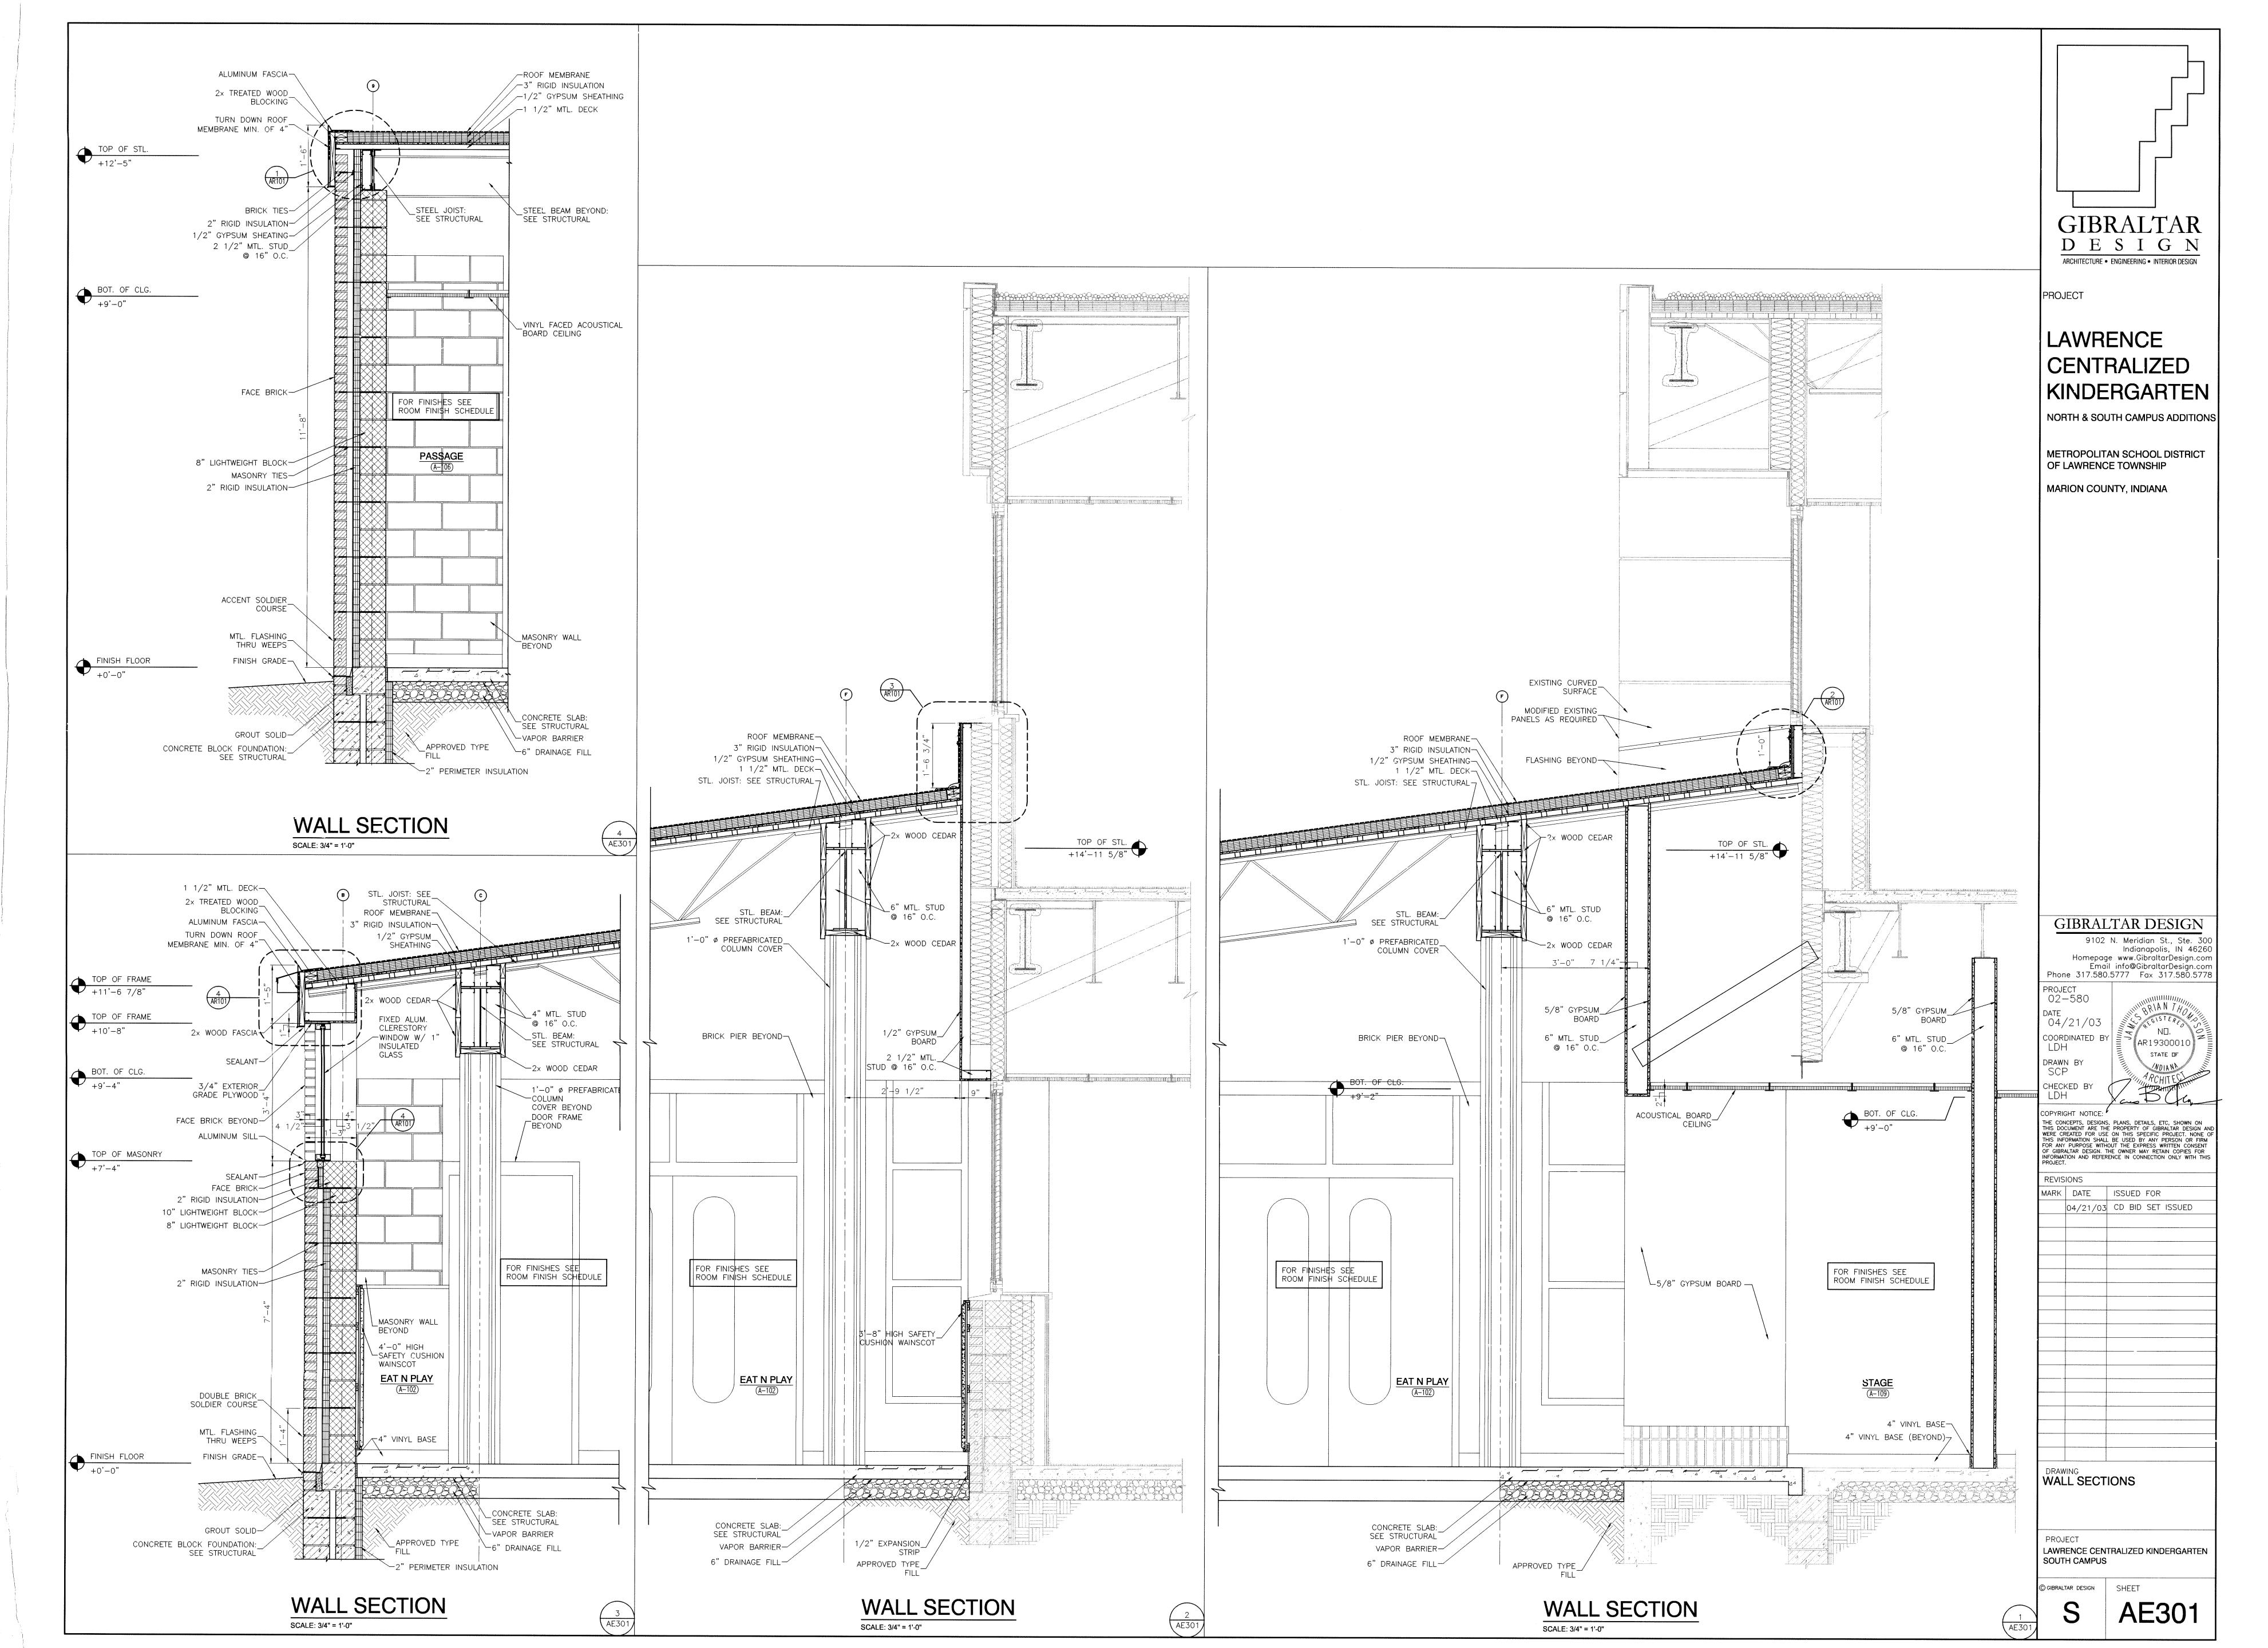

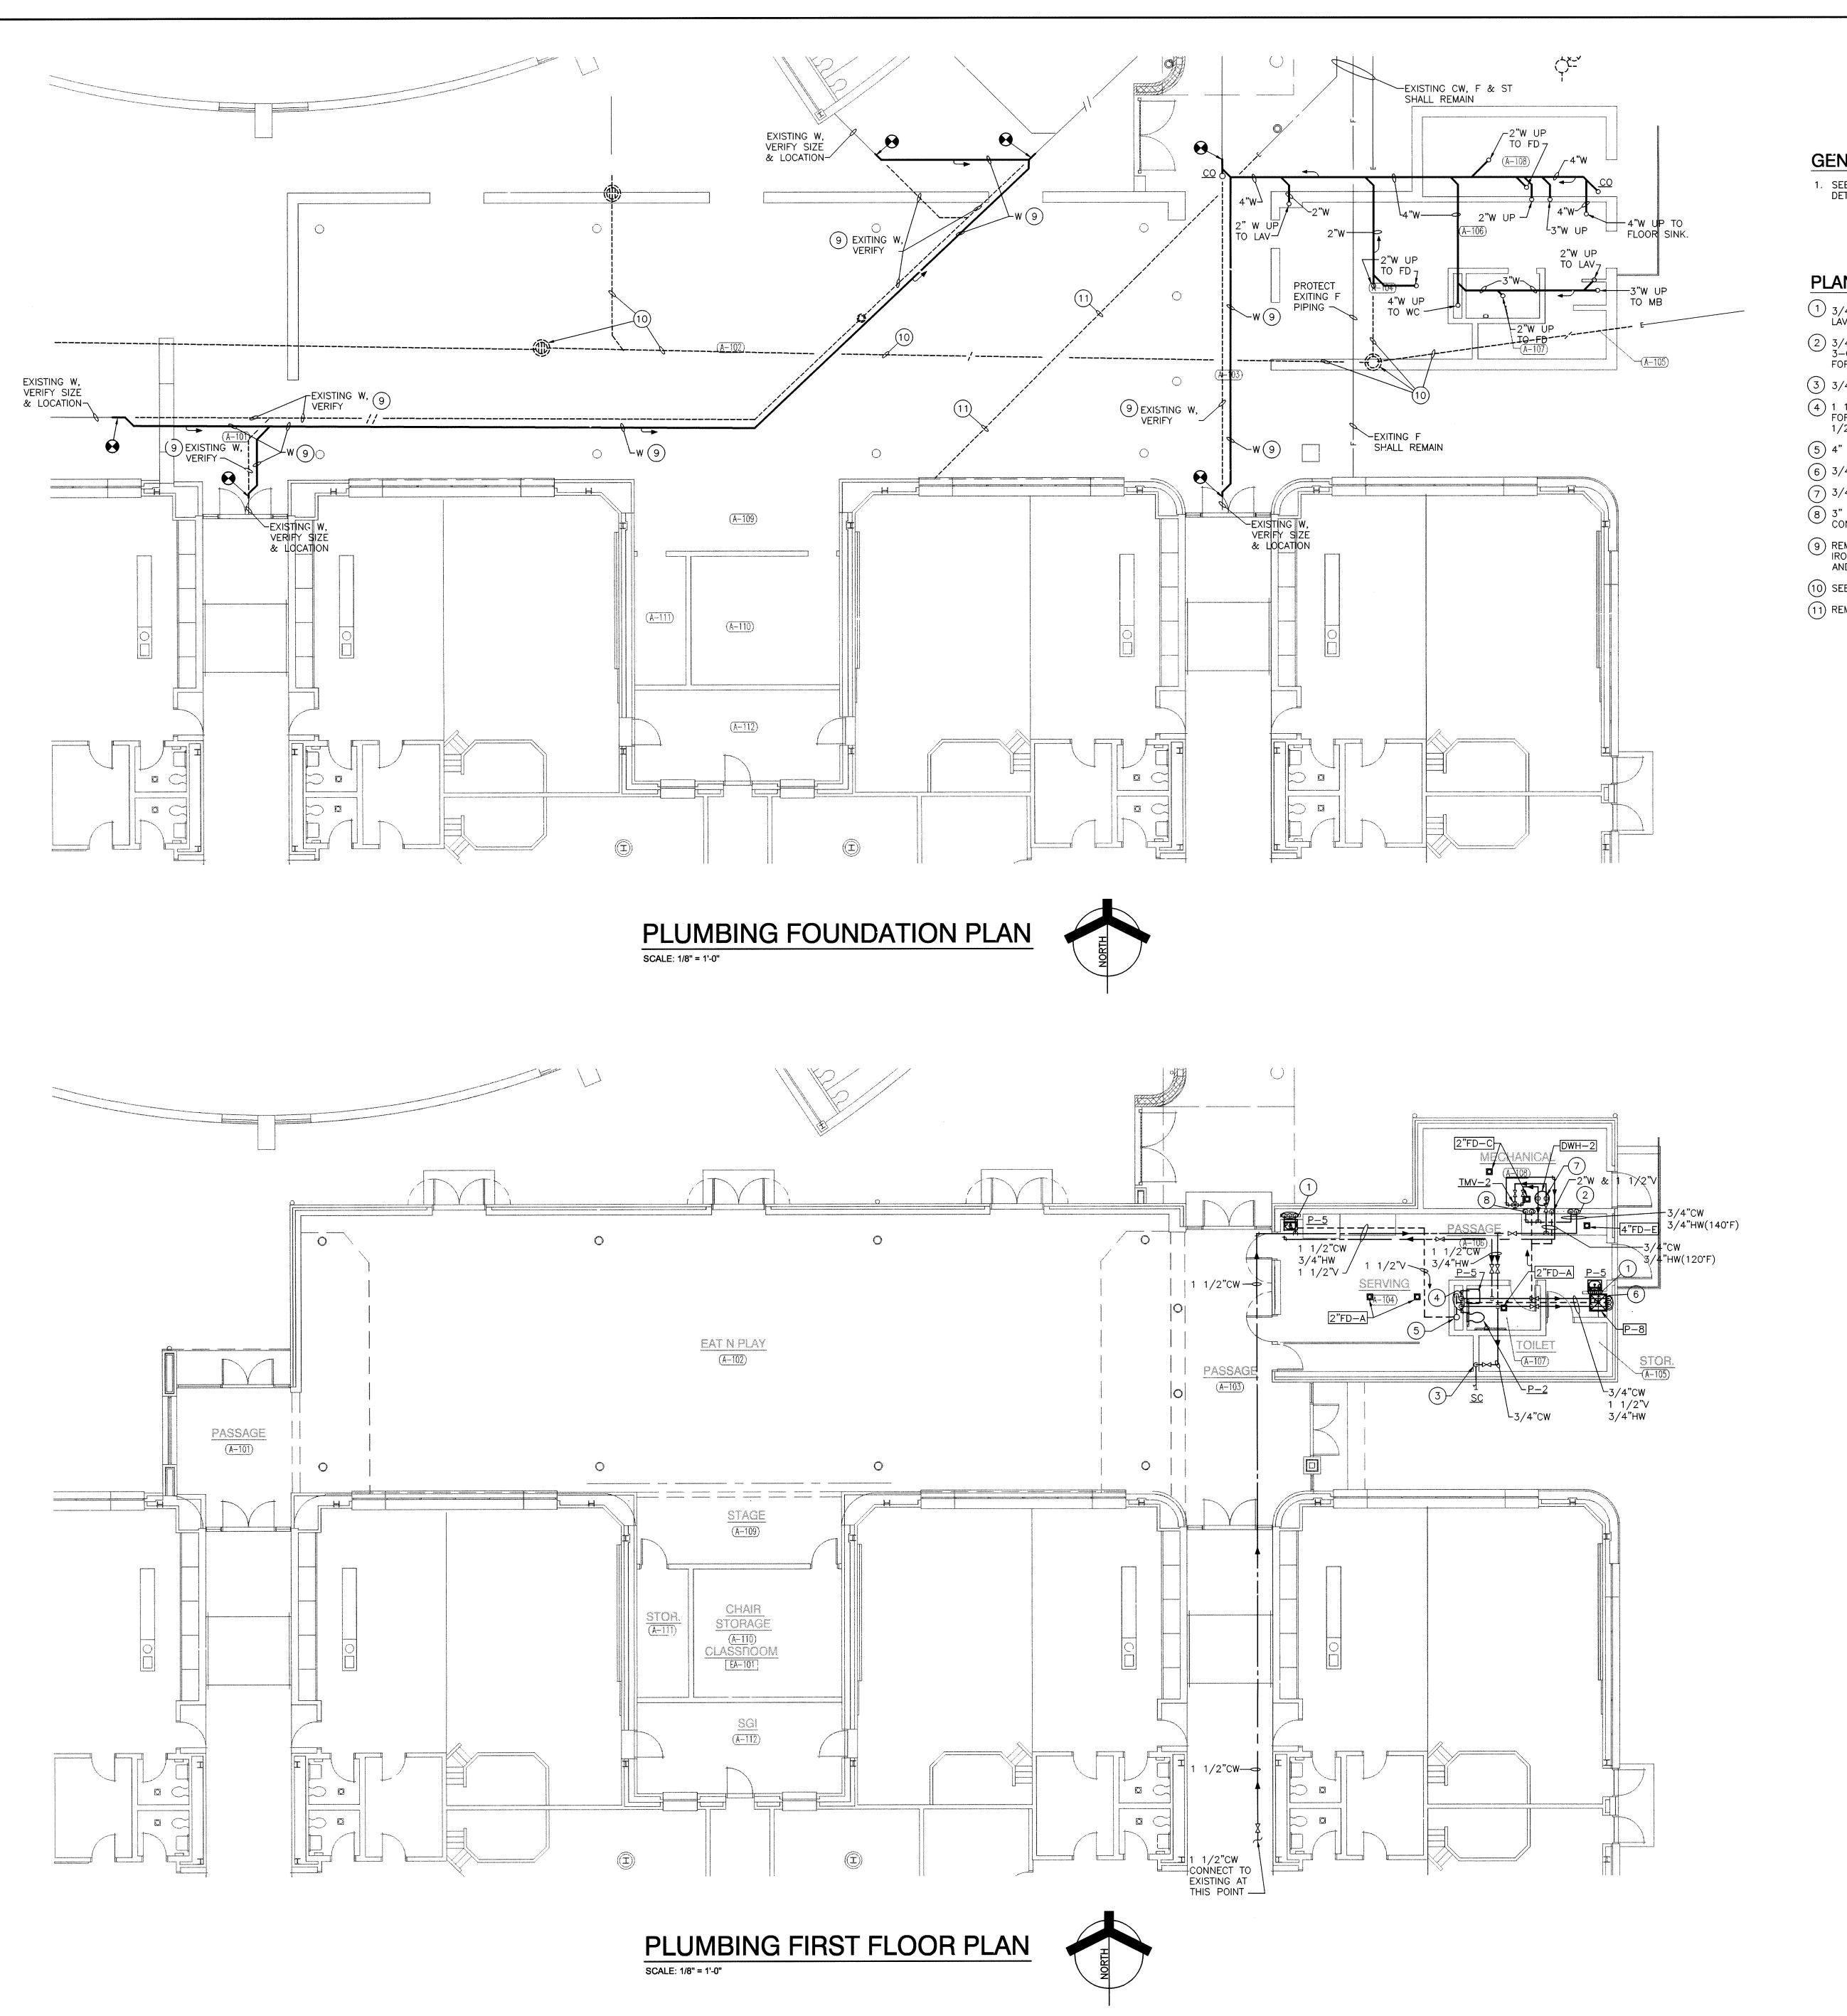


GENERAL NOTE:

SEE SHEET P-001 FOR PLUMBING LEGEND, GENERAL NOTES, DETAILS AND SECHEDULES.

PLAN NOTES:

- 1) 3/4"HW, 3/4"CW, 1 1/2"WASTE DROP FOR CONNECTION TO LAV 1 1/2" VENT UP.
- 2) 3/4"HW(140°F), 3/4"CW DROP IN WALL FOR CONNECTION TO 3-COMPARTMENT SINK. SEE KITCHEN EQUIPMENT DRAWINGS FOR EXACT LOCATION.
- 3) 3/4"CW DOWN IN WALL FOR CONNECTION TO SILL COCK. 4 1 1/2"CW WITH WHA TYPE "A", AND 3/4"HW DROP IN CHASE FOR CONNECTION TO WC AND LAV. 1 1/2" WASTE AND 1 1/2"V FROM LAV, 4" WASTE DOWN AND 2" VENT, FROM WC.
- (5) 4" WASTE DOWN, 2" VENT UP, 4" VTR.
- (6) 3/4"HW, 3/4"CW, 3" WASTE, AND 1 1/2" VENT DOWN. 7 3/4"HW AND 3/4"CW DROP AND 1 1/2" VENT FROM BELOW.
- 8 3" WASTE AND 2" VENT DOWN. 3/4"HW(140°F) DROP FOR CONNECTION TO DISHWASHER.
- 9 REMOVE AND REPLACE EXISTING SANITARY WITH NEW CAST IRON WASTE PIPING, REPLACE WITH SAME SIZE AS EXISTING AND MATCH SLOPE.
- (10) SEE CIVIL PLANS FOR REMOVAL.
- (11) REMOVE EXISTING ABANDONED CW AND YARD HYDRANT.

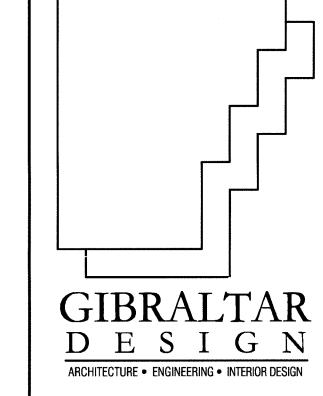


LAWRENCE CENTRALIZED **KINDERGARTEN**

PROJECT

NORTH & SOUTH CAMPUS ADDITIONS

METROPOLITAN SCHOOL DISTRICT
OF LAWRENCE TOWNSHIP

MARION COUNTY, INDIANA

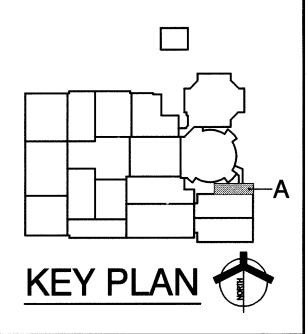

GIBRALTAR DESIGN

9102 N. Meridian St., Ste. 300 Indianapolis, IN 46260 Homepage www.GibraltarDesign.com Email info@GibraltarDesign.com Phone 317.580.5777 Fax 317.580.5778

PROJECT 02-580 DATE 04/21/03

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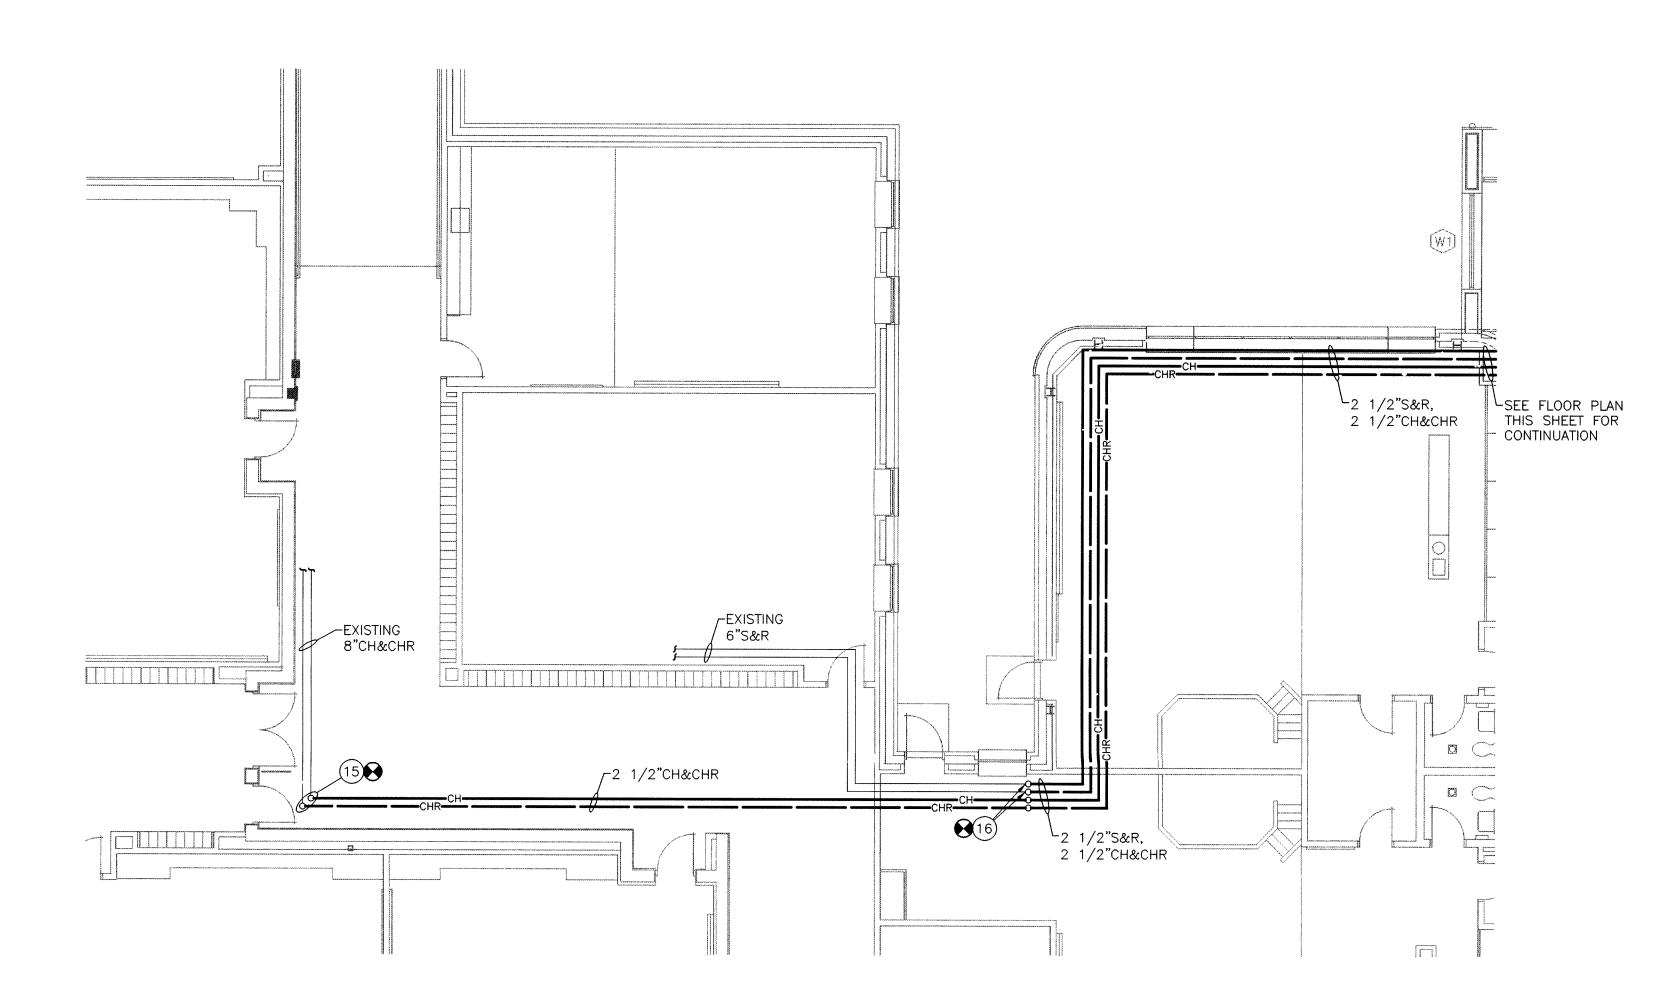
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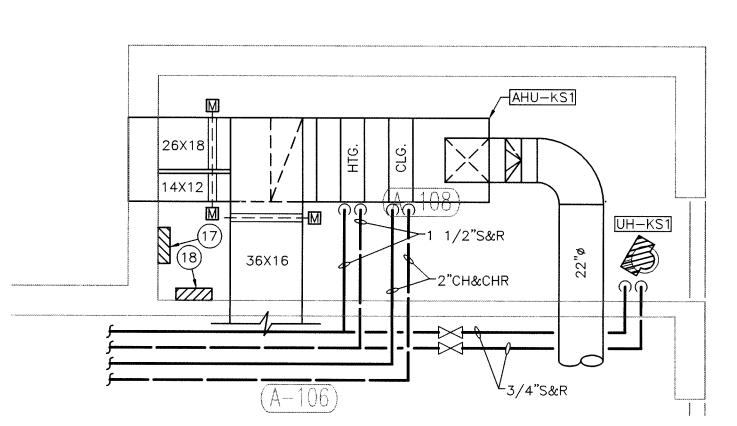
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DRAWING UNIT "A" PLUMBING FOUNDATION AND FIRST FLOOR PLANS

PROJECT LAWRENCE CENTRALIZED KINDERGARTEN SOUTH CAMPUS

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GENERAL NOTES:

- 1. SEE SHEET M-501 FOR MECHANICAL DETAILS.
- SEE SHEET M-601 FOR MECHANICAL LEGEND, GENERAL NOTES AND EQUIPMENT SCHEDULES.
- SEE SHEET M-801 FOR MECHANICAL TEMPERATURE CONTROL DIAGRAMS.


PLAN NOTES:

- 1) 36"X36" DUCT WITH 36"X36" MOTORIZED RELIEF DAMPER UP TO RELIEF VENT ON ROOF. MOTORIZED DAMPER SHALL BE CONTROLLED BY A STATIC PRESSURE SENSOR.
- 2 24"X12" RETURN AIR GRILLE IN CEILING.
- (3) 24"X24" RETURN AIR GRILLE IN CEILING.
- (4) STUB TRANSFER AIR DUCT THRU WALL ABOVE CEILING.
- 5 12"X12" TRANSFER AIR DUCT STUBBED THRU WALL ABOVE CEILING.
- (6) 12"X12" UP TO EF-KS2 ON ROOF.
- (7) 12"X12" ER 440 CFM (TYPICAL OF 3).
- (8) 8"X6" UP TO EF-KS1 ON ROOF.
- 9) 16"X16" UP TO EF-KS2 ON ROOF.
- (10) 10"X10" UP TO EF-KS3 ON ROOF.
- (11) 12"X12" ER 75 CFM.
- (12) 12"X12" ER 100 CFM.
- (13) 12"X12" ER 250 CFM.
- (14) 12"X12" ER 300 CFM.
- (15) CONNECT 2 1/2"CH&CHR WITH SHUTOFF VALVES TO EXISTING 8"CH&CHR LINES IN THIS AREA.
- (16) CONNECT 2 1/2"S&R WITH SHUTOFF VALVES TO EXISTING 6"S&R LINES IN THIS AREA.
- (17) VARIABLE FREQUENCY DRIVE.
- (18) TEMPERATURE CONTROL PANEL




DETAIL "A" MECHANICAL FIRST FLOOR PLAN



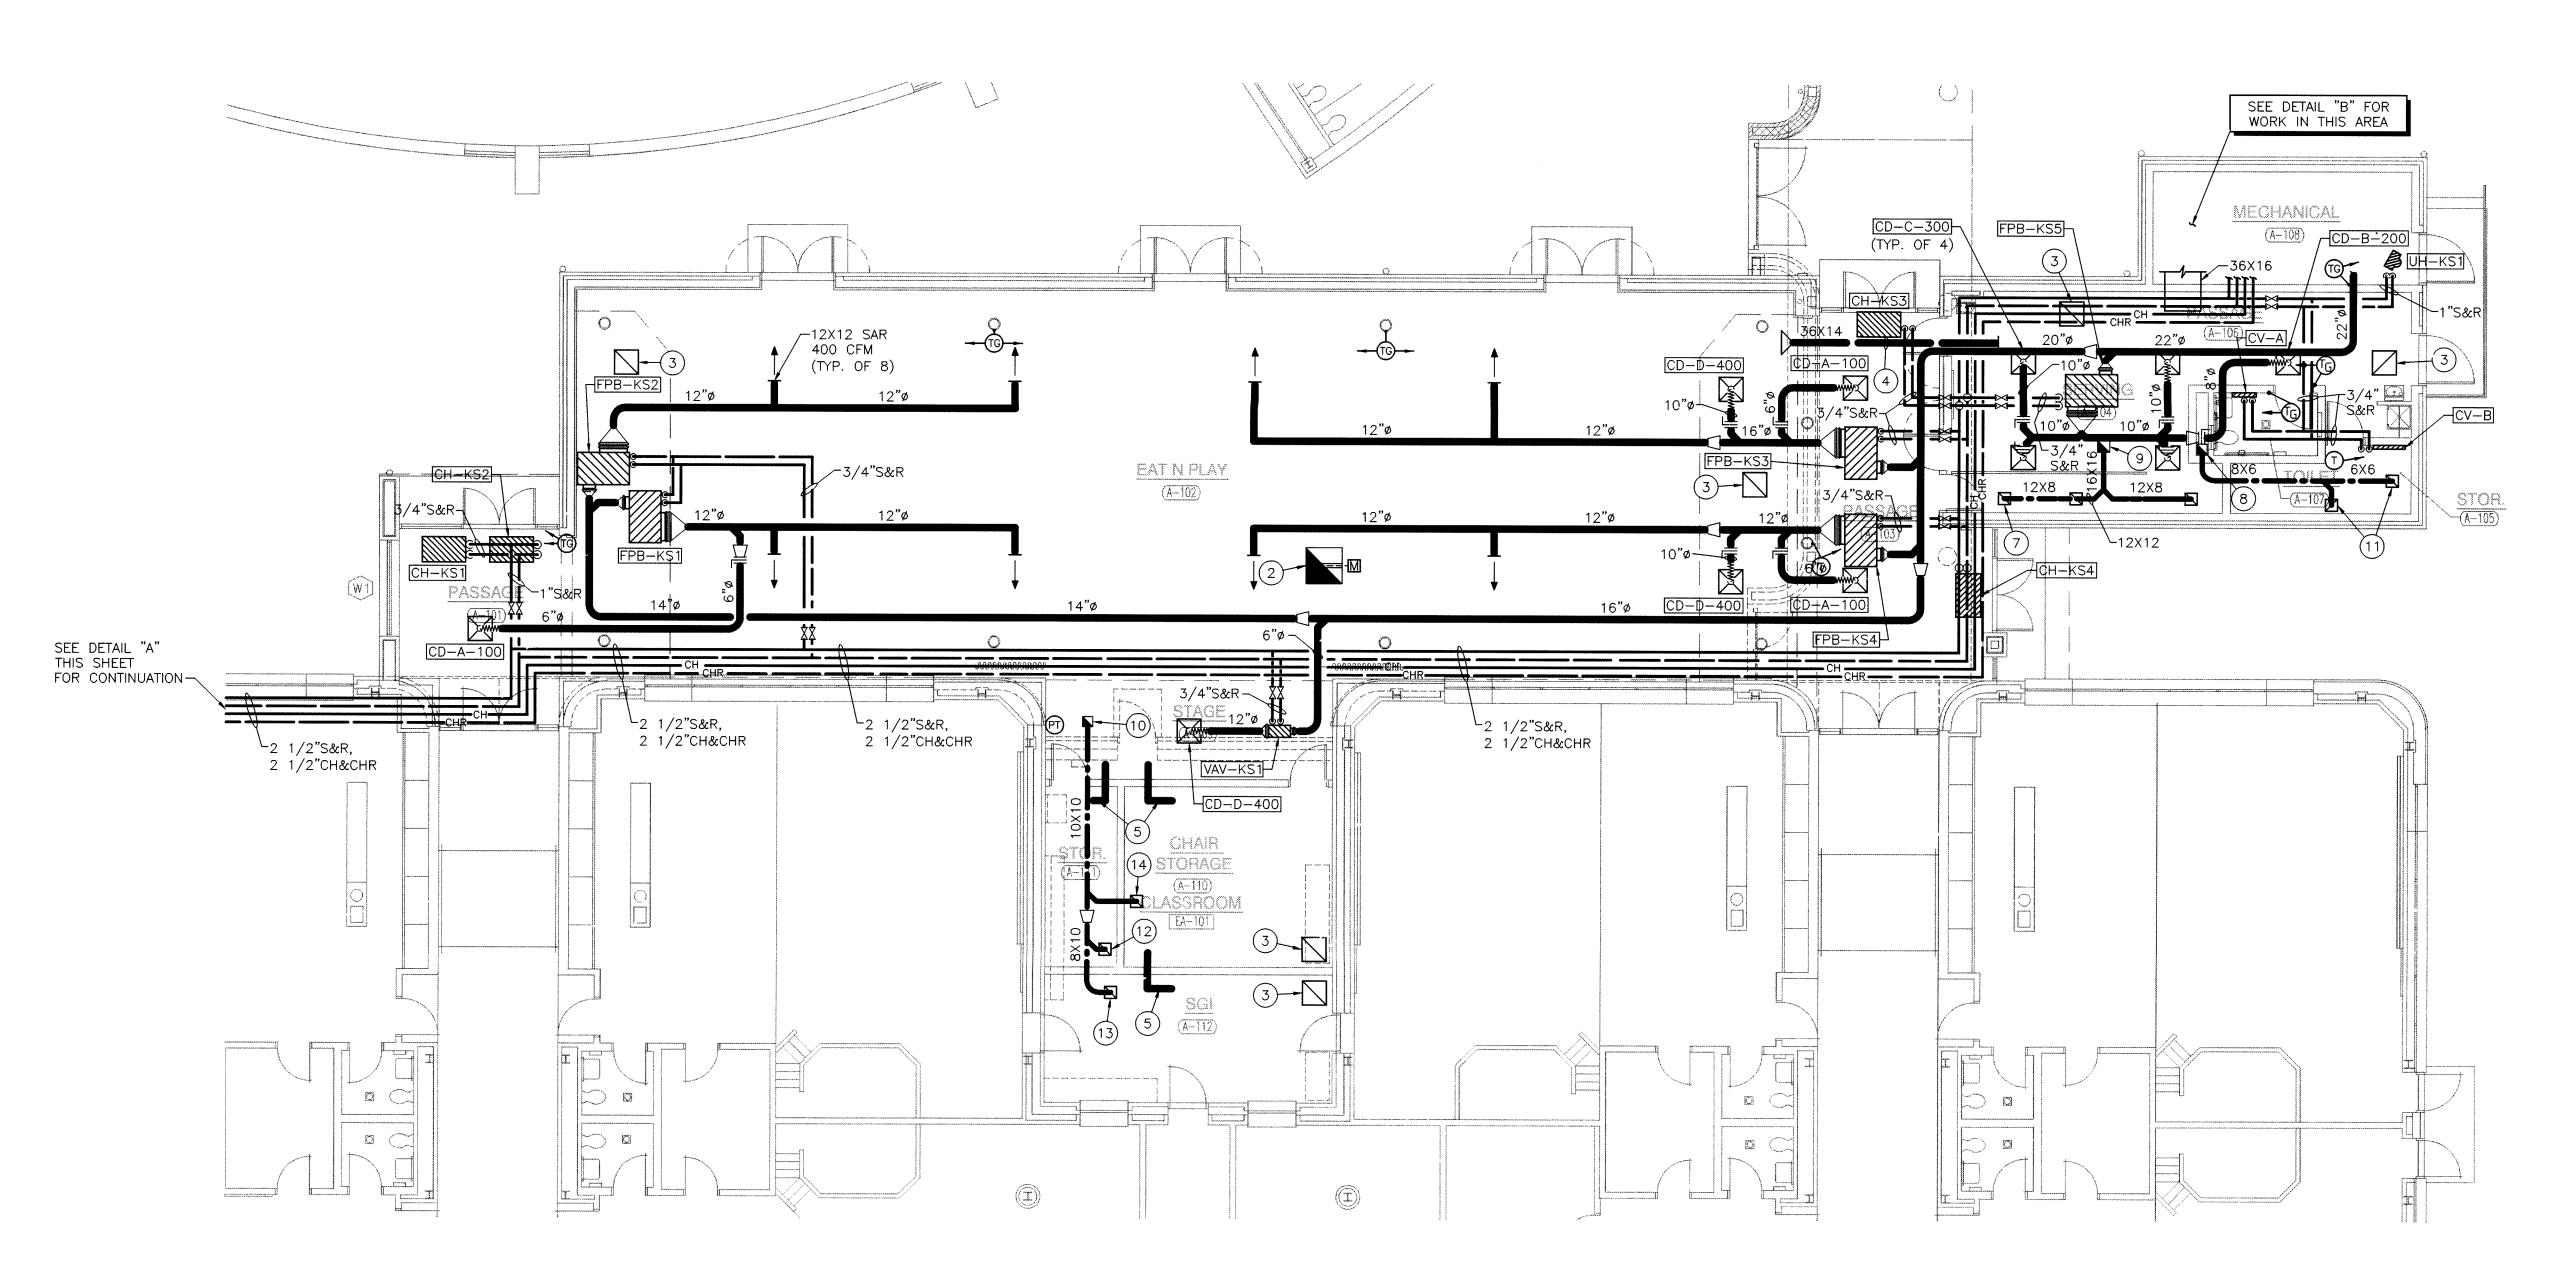



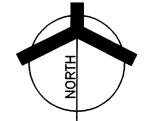

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PROJECT

LAWRENCE CENTRALIZED KINDERGARTEN

NORTH & SOUTH CAMPUS ADDITIONS

METROPOLITAN SCHOOL DISTRICT OF LAWRENCE TOWNSHIP

MARION COUNTY, INDIANA

KEY PLAN

GIBRALTAR DESIGN 9102 N. Meridian St., Ste. 300 Indianapolis, IN 46260 Homepage www.GibraltarDesign.com Email info@GibraltarDesign.com Phone 317.580.5777 Fax 317.580.5778

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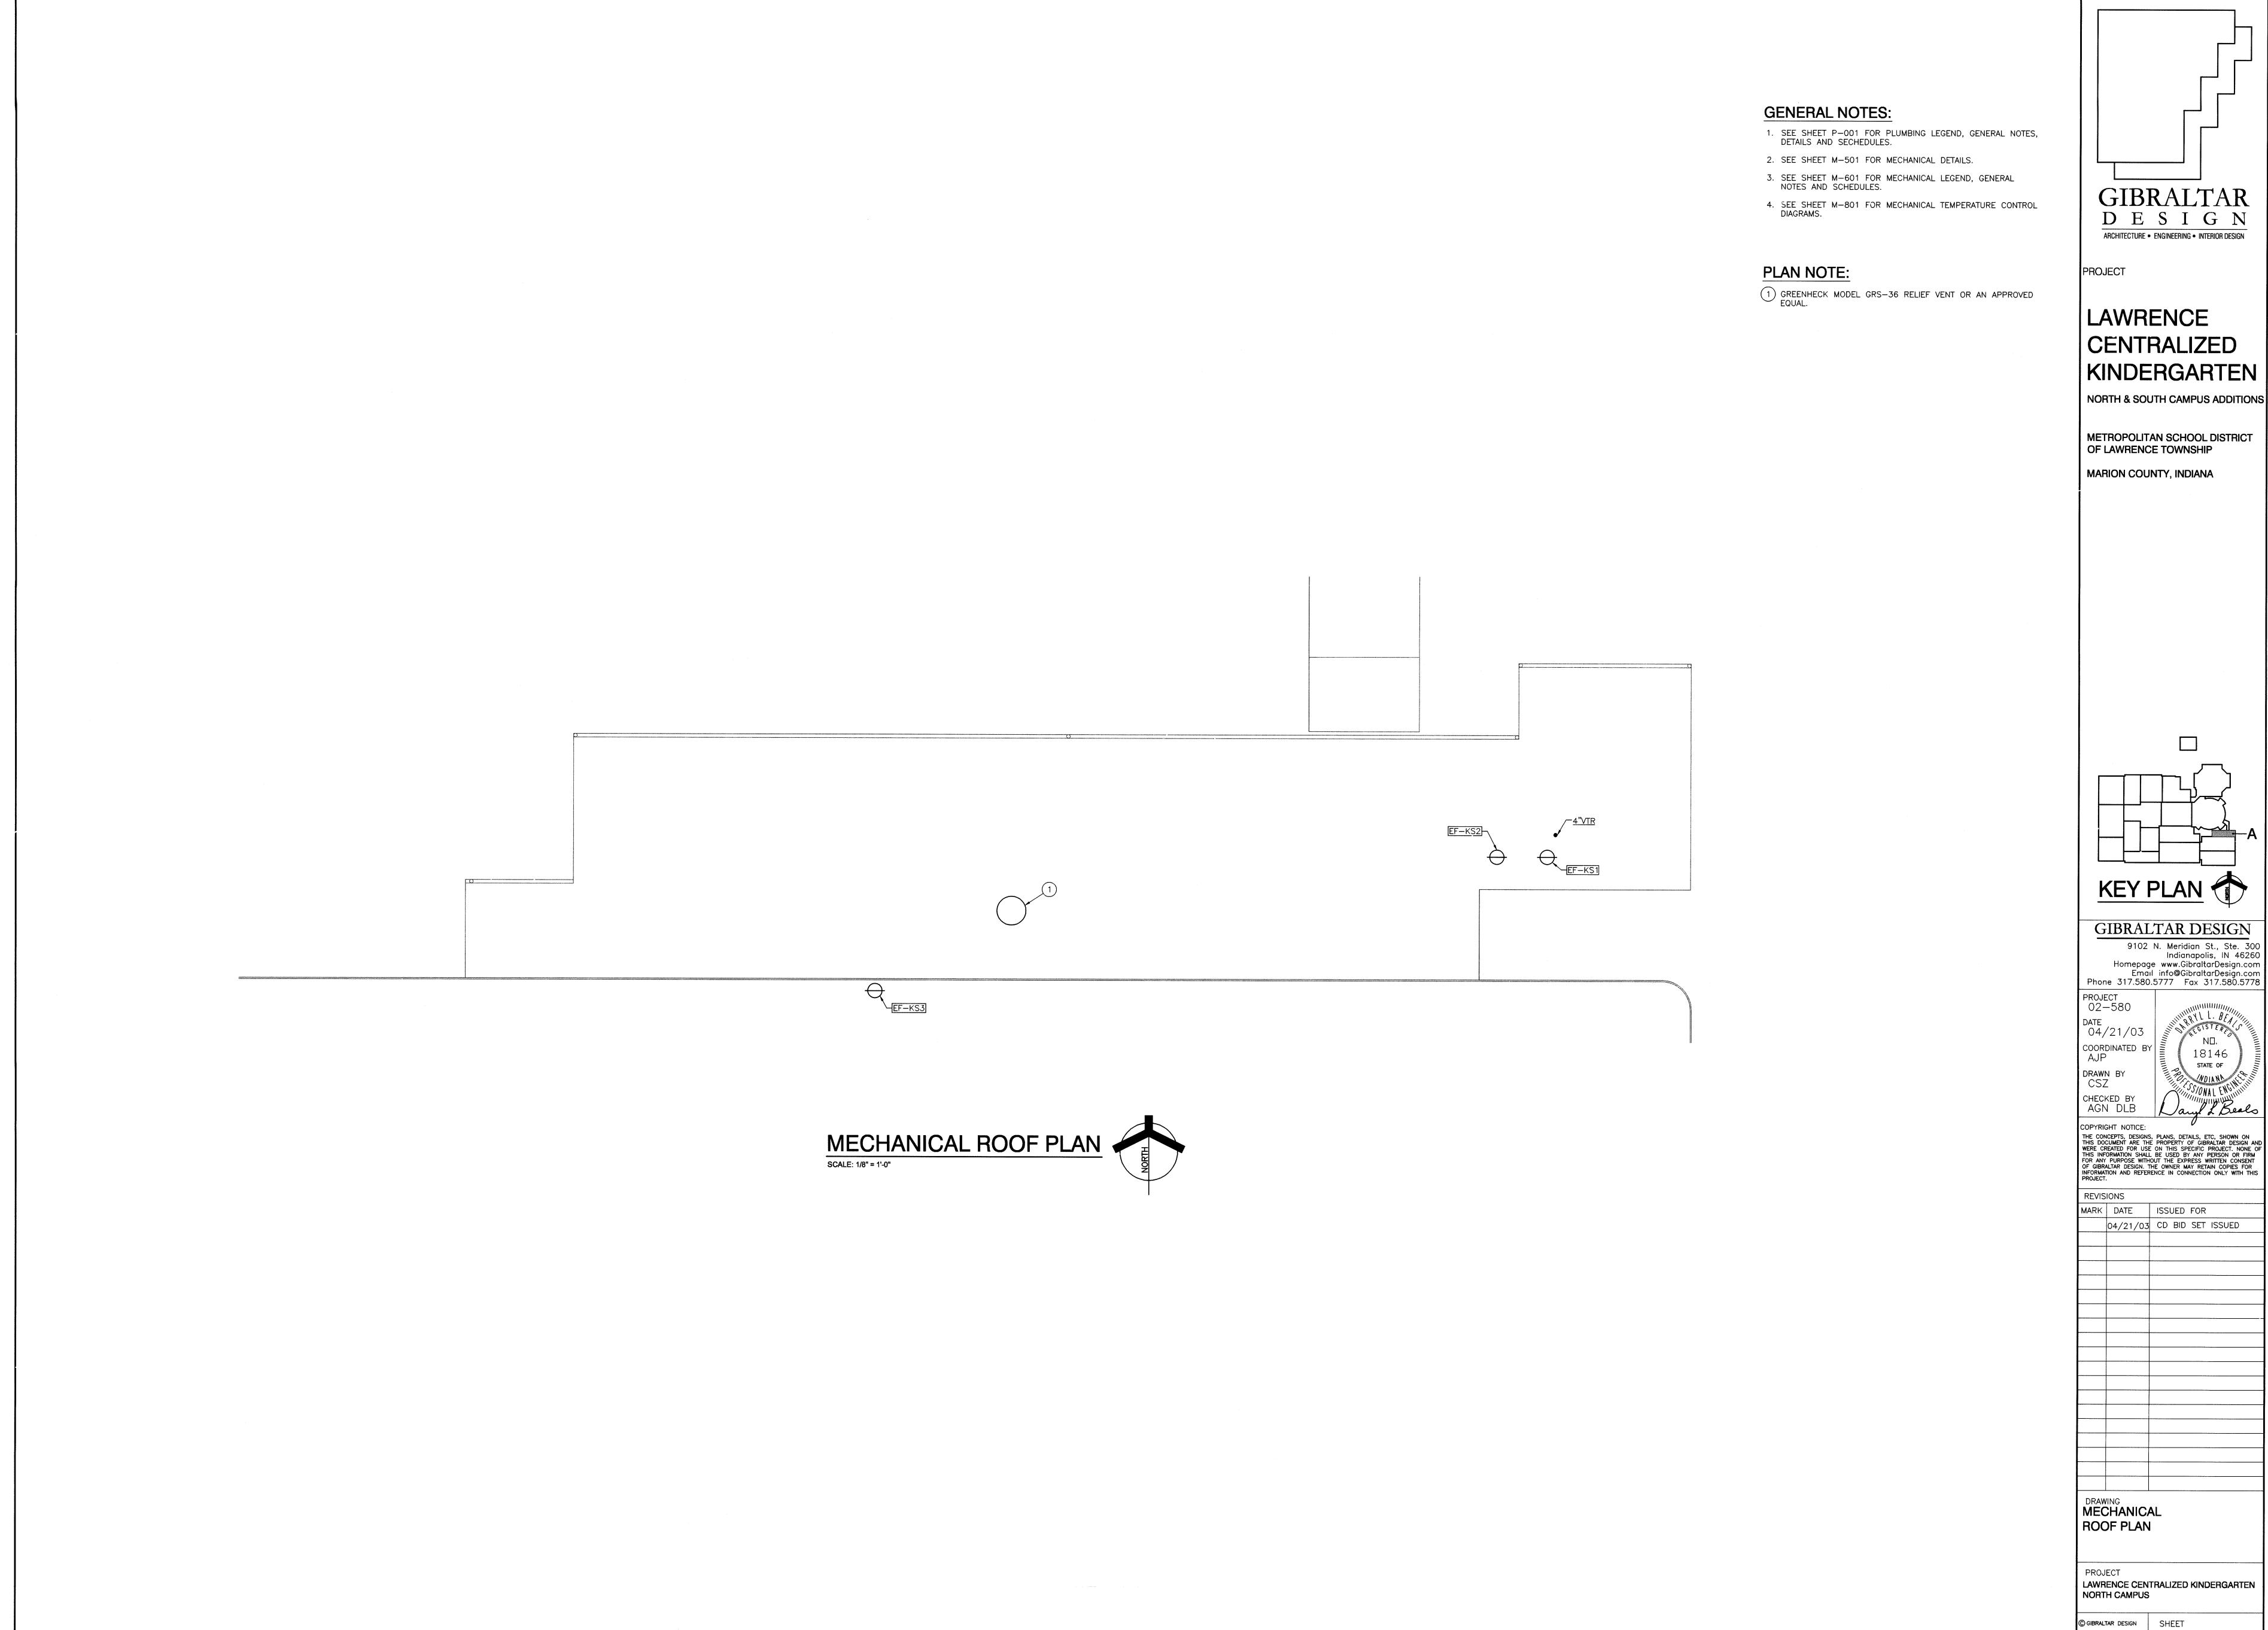
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DRAWING UNIT "A" MECHANICAL FIRST FLOOR PLAN AND MECHANICAL EQUIPMENT ROOM LAYOUT AND DETAILS


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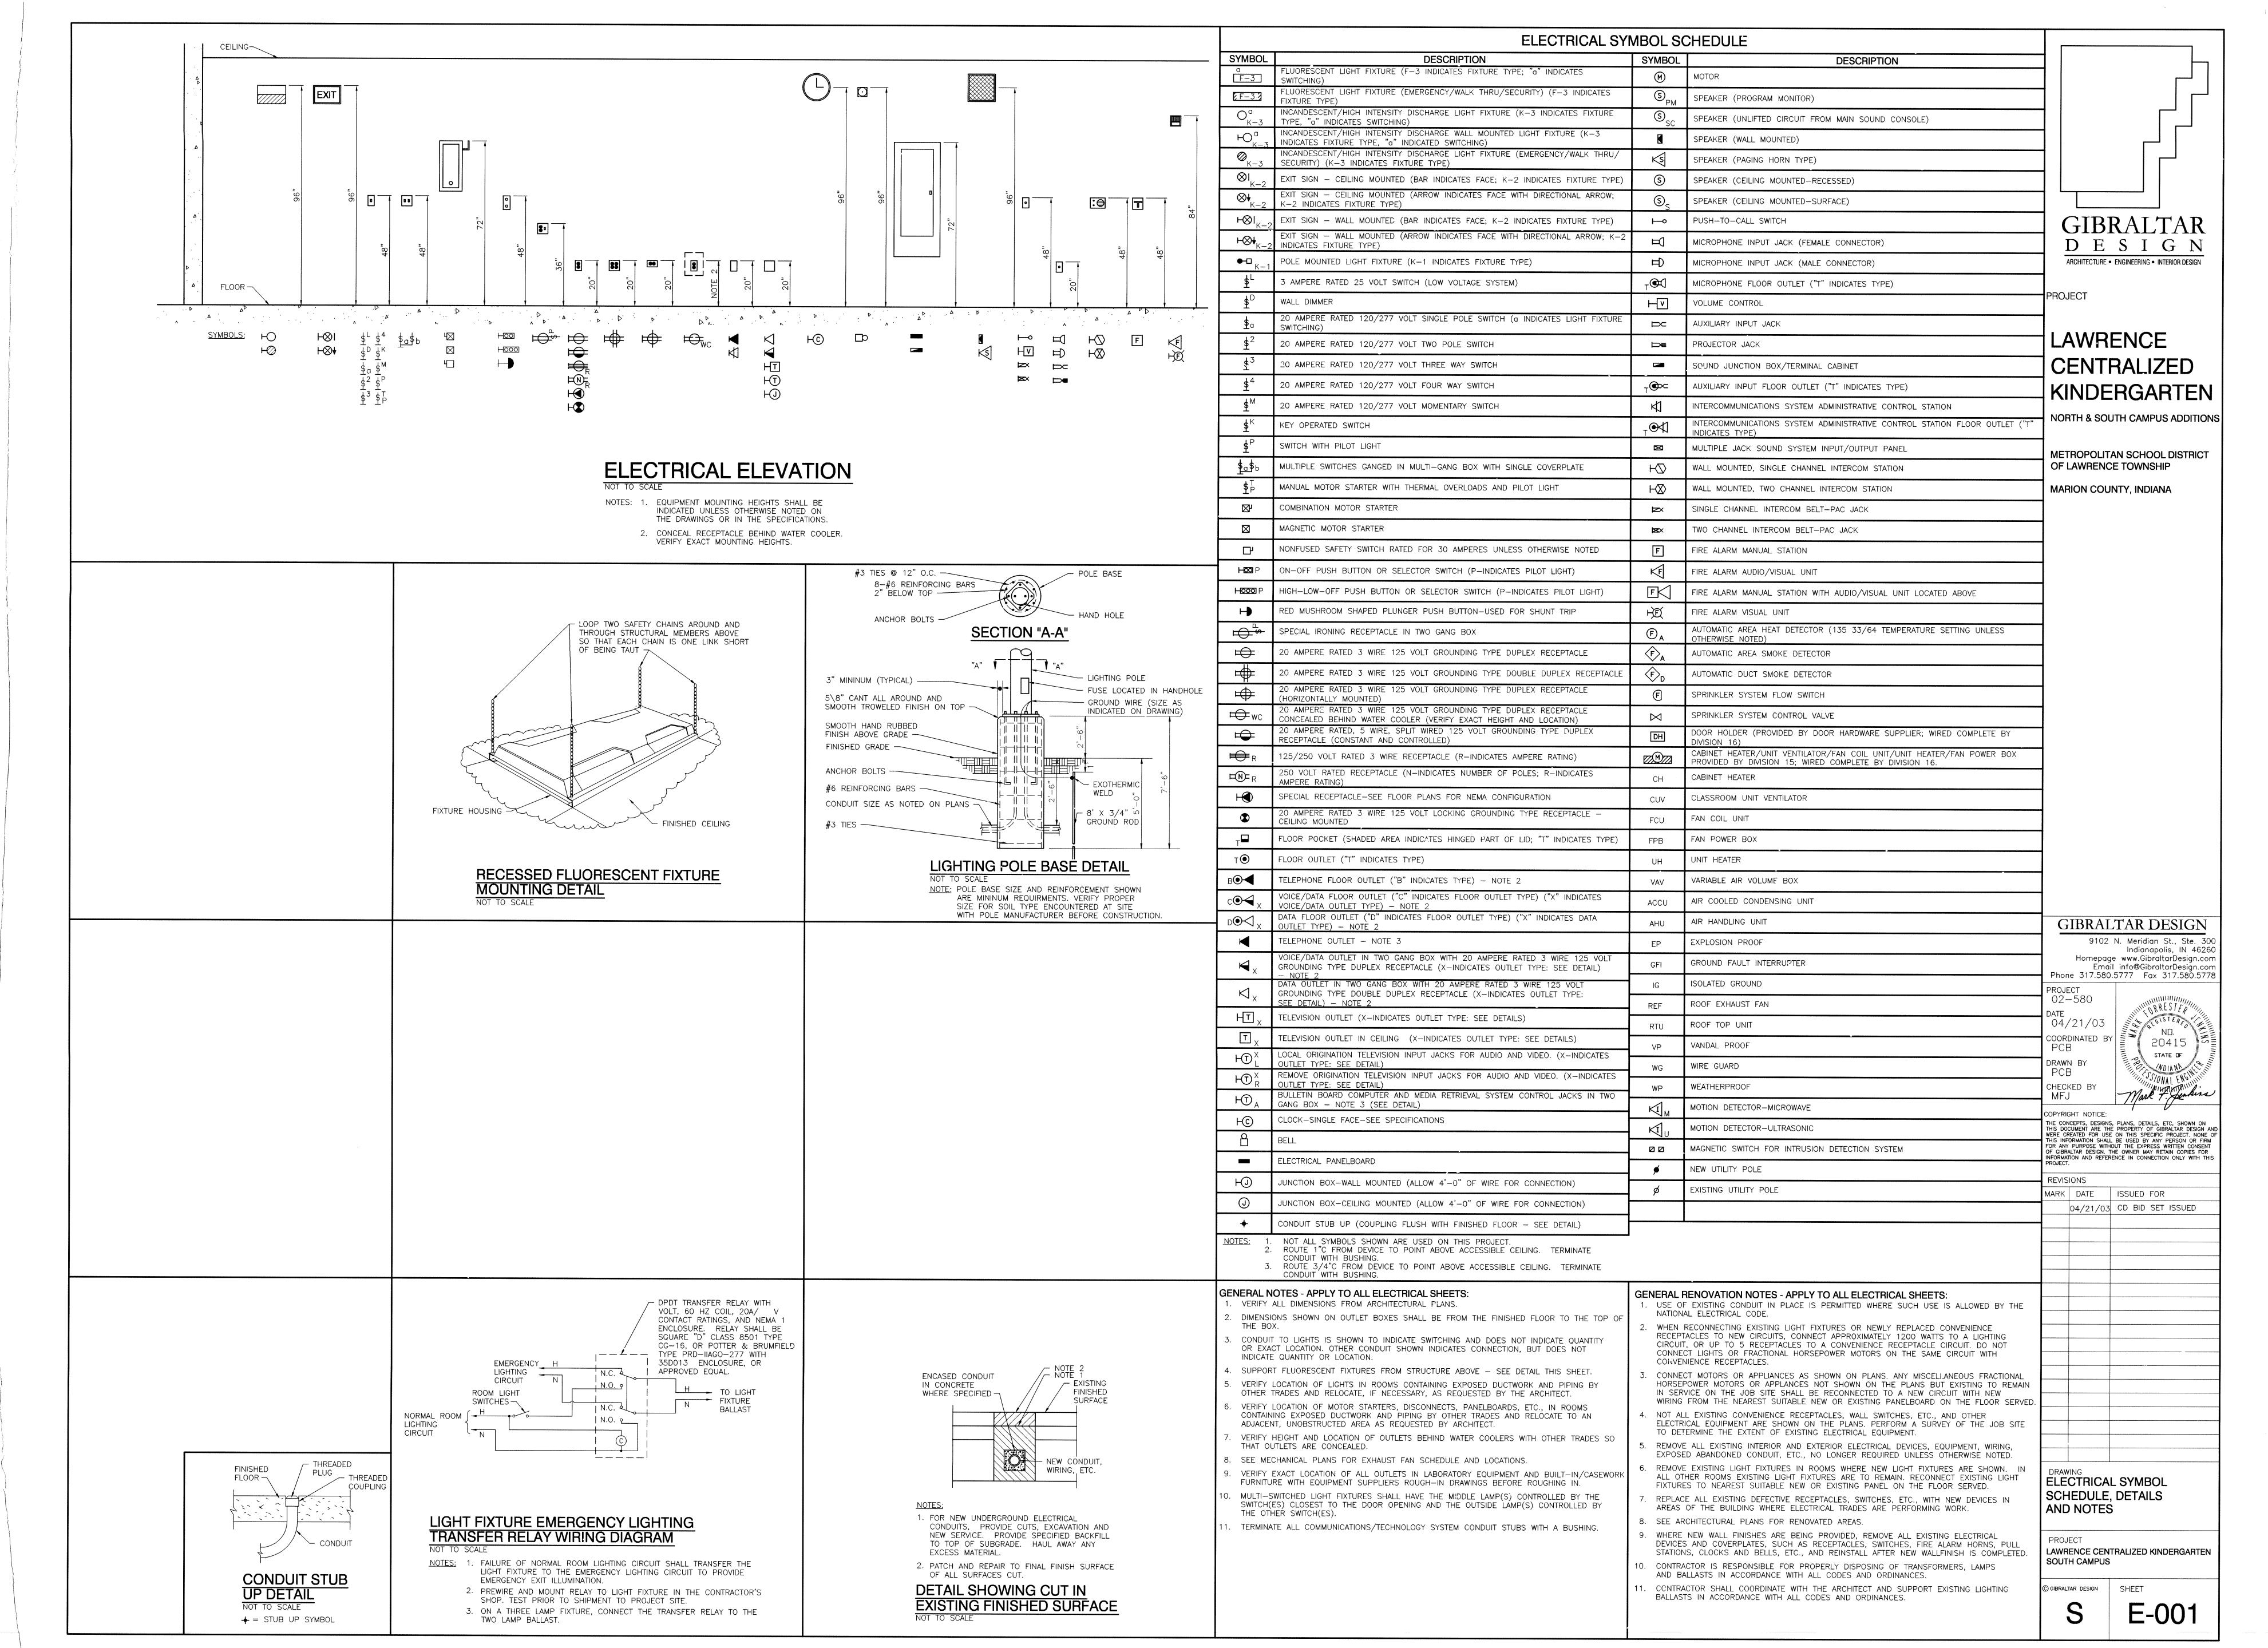
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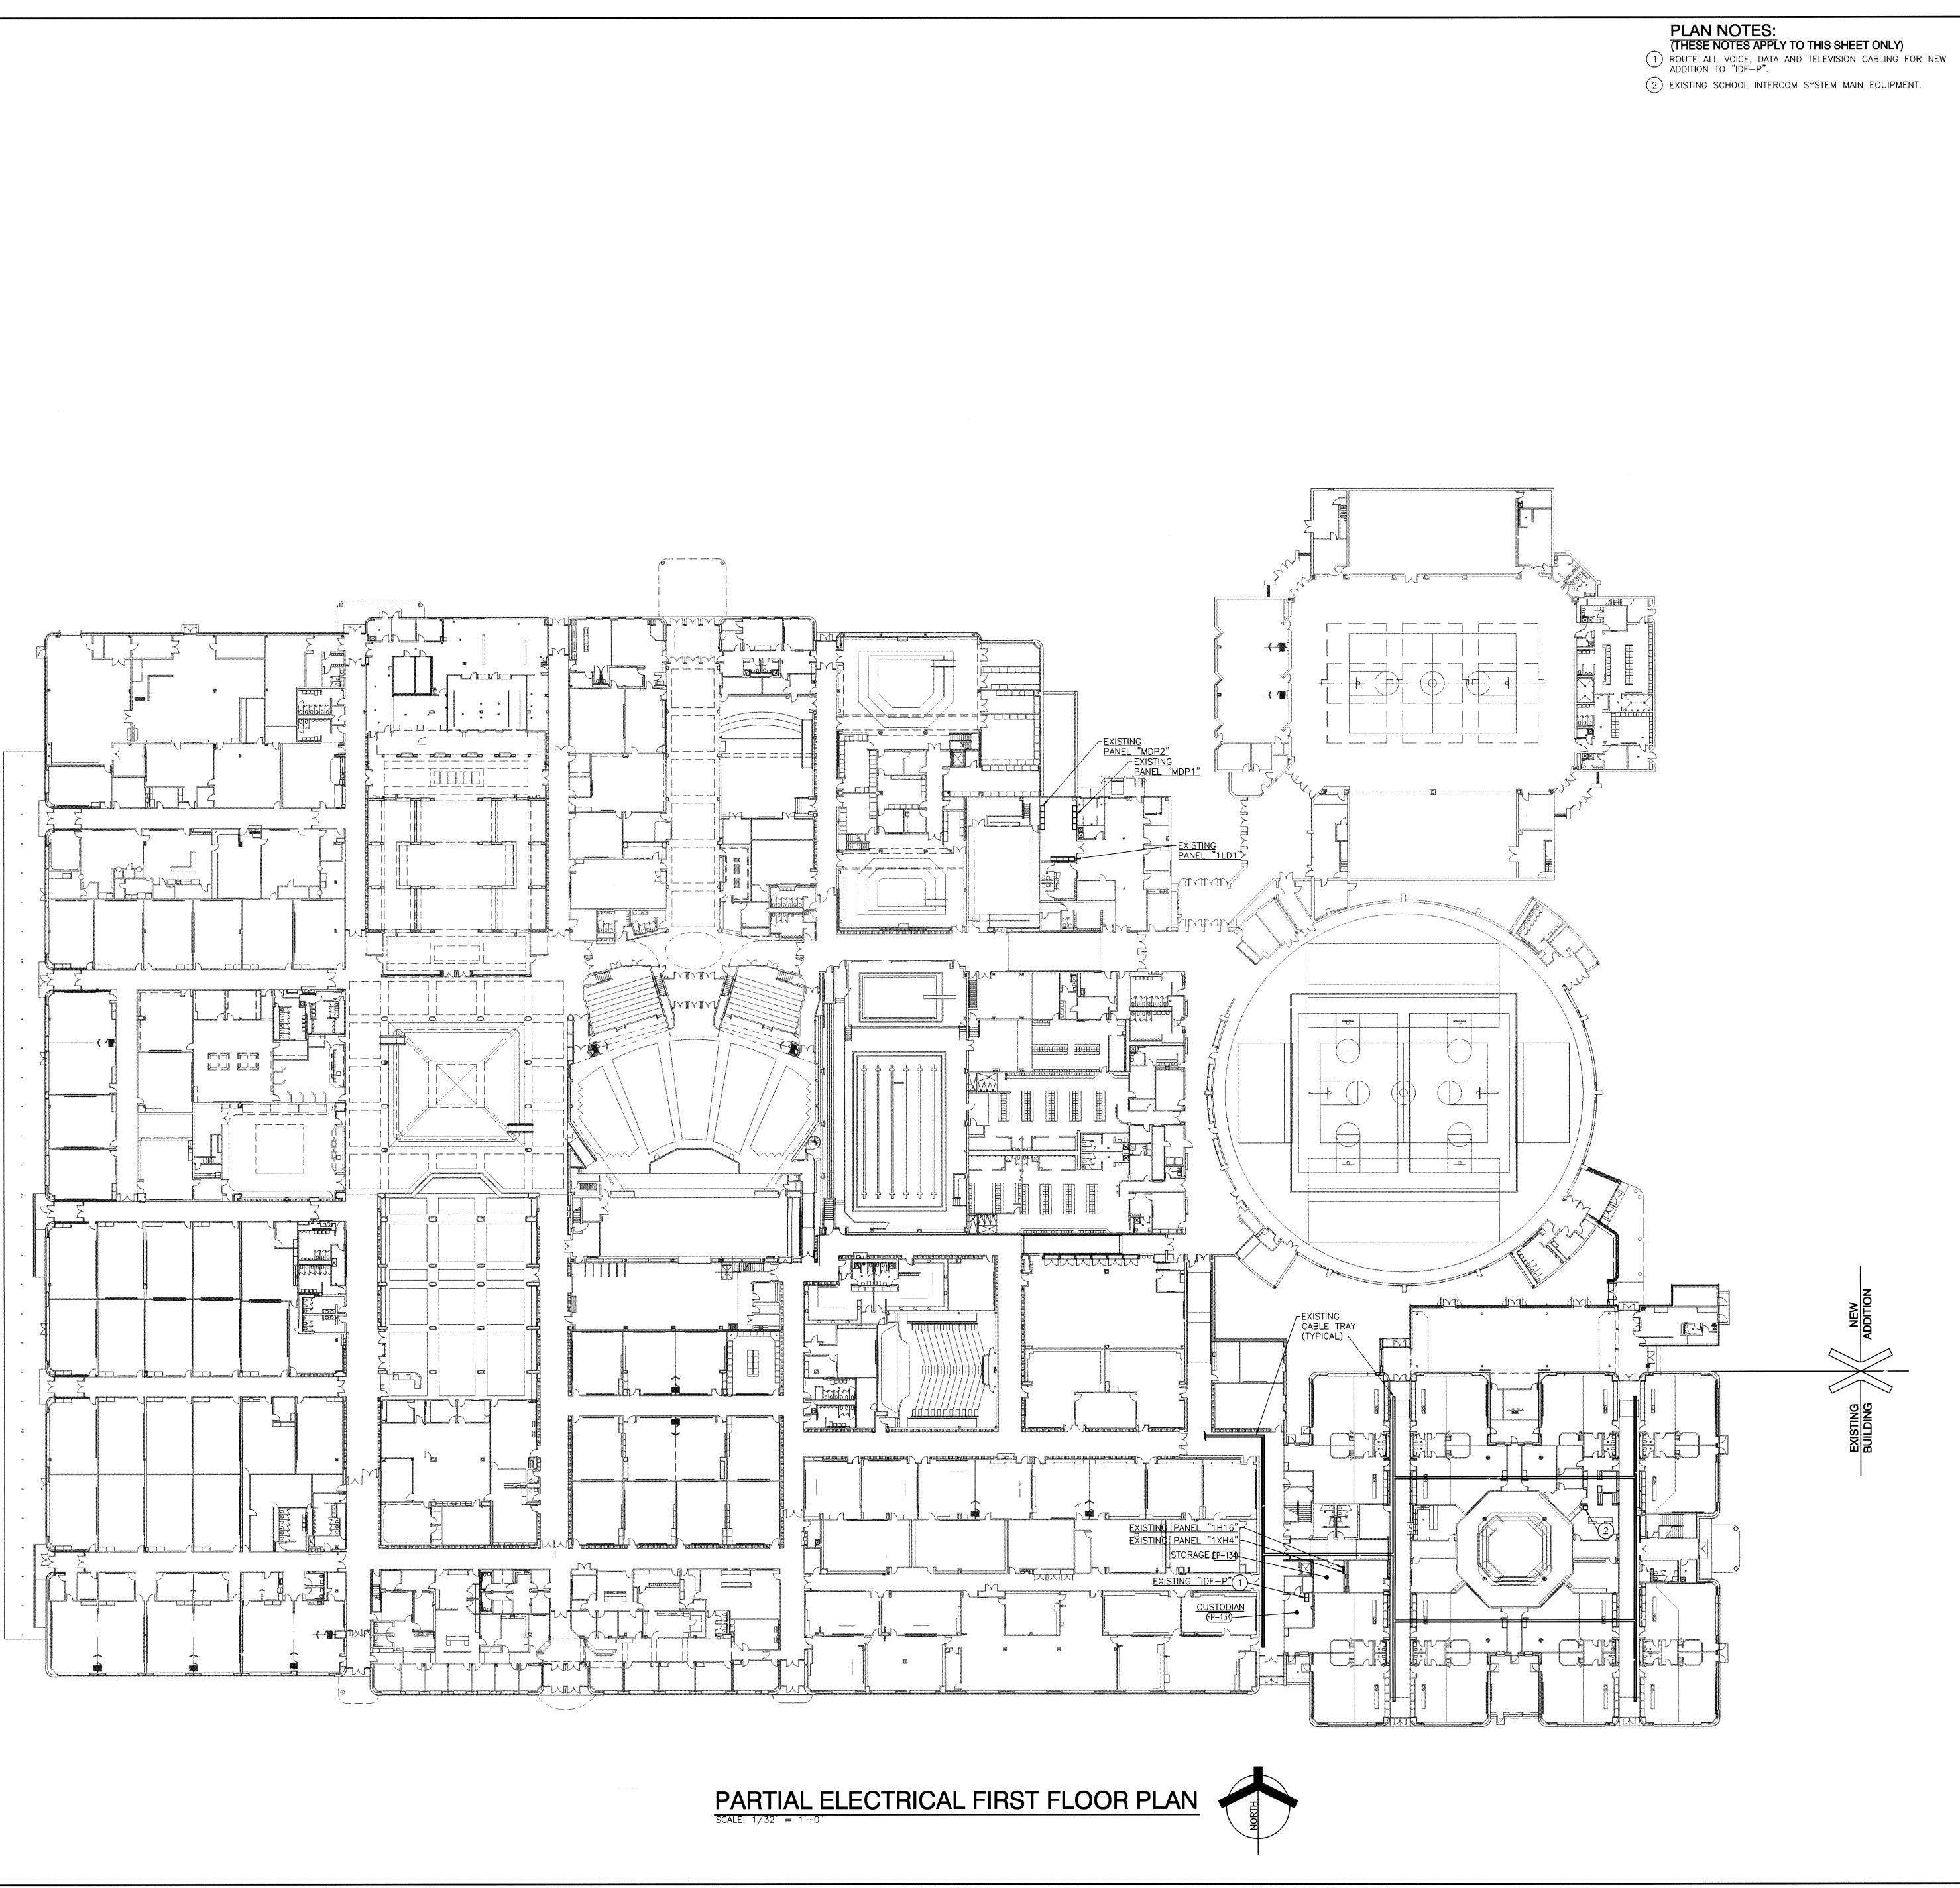
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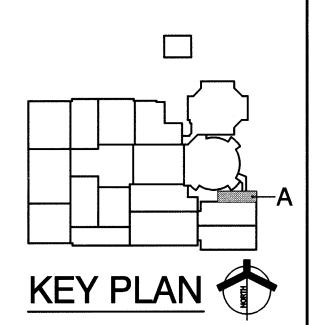
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9102 N. Meridian St., Ste. 300
Indianapolis, IN 46260
Homepage www.GibraltarDesign.com
Email info@GibraltarDesign.com
Phone 317.580.5777 Fax 317.580.5778

PROJECT
02-580

DATE
04/21/03

COORDINATED BY
PCB

DRAWN BY
PCB

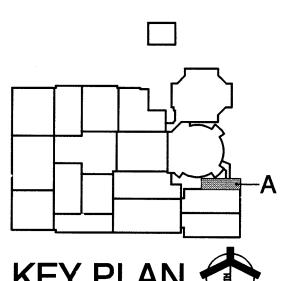CHECKED BY
MFJ

PROJECT
02-580

DATE
04/21/03

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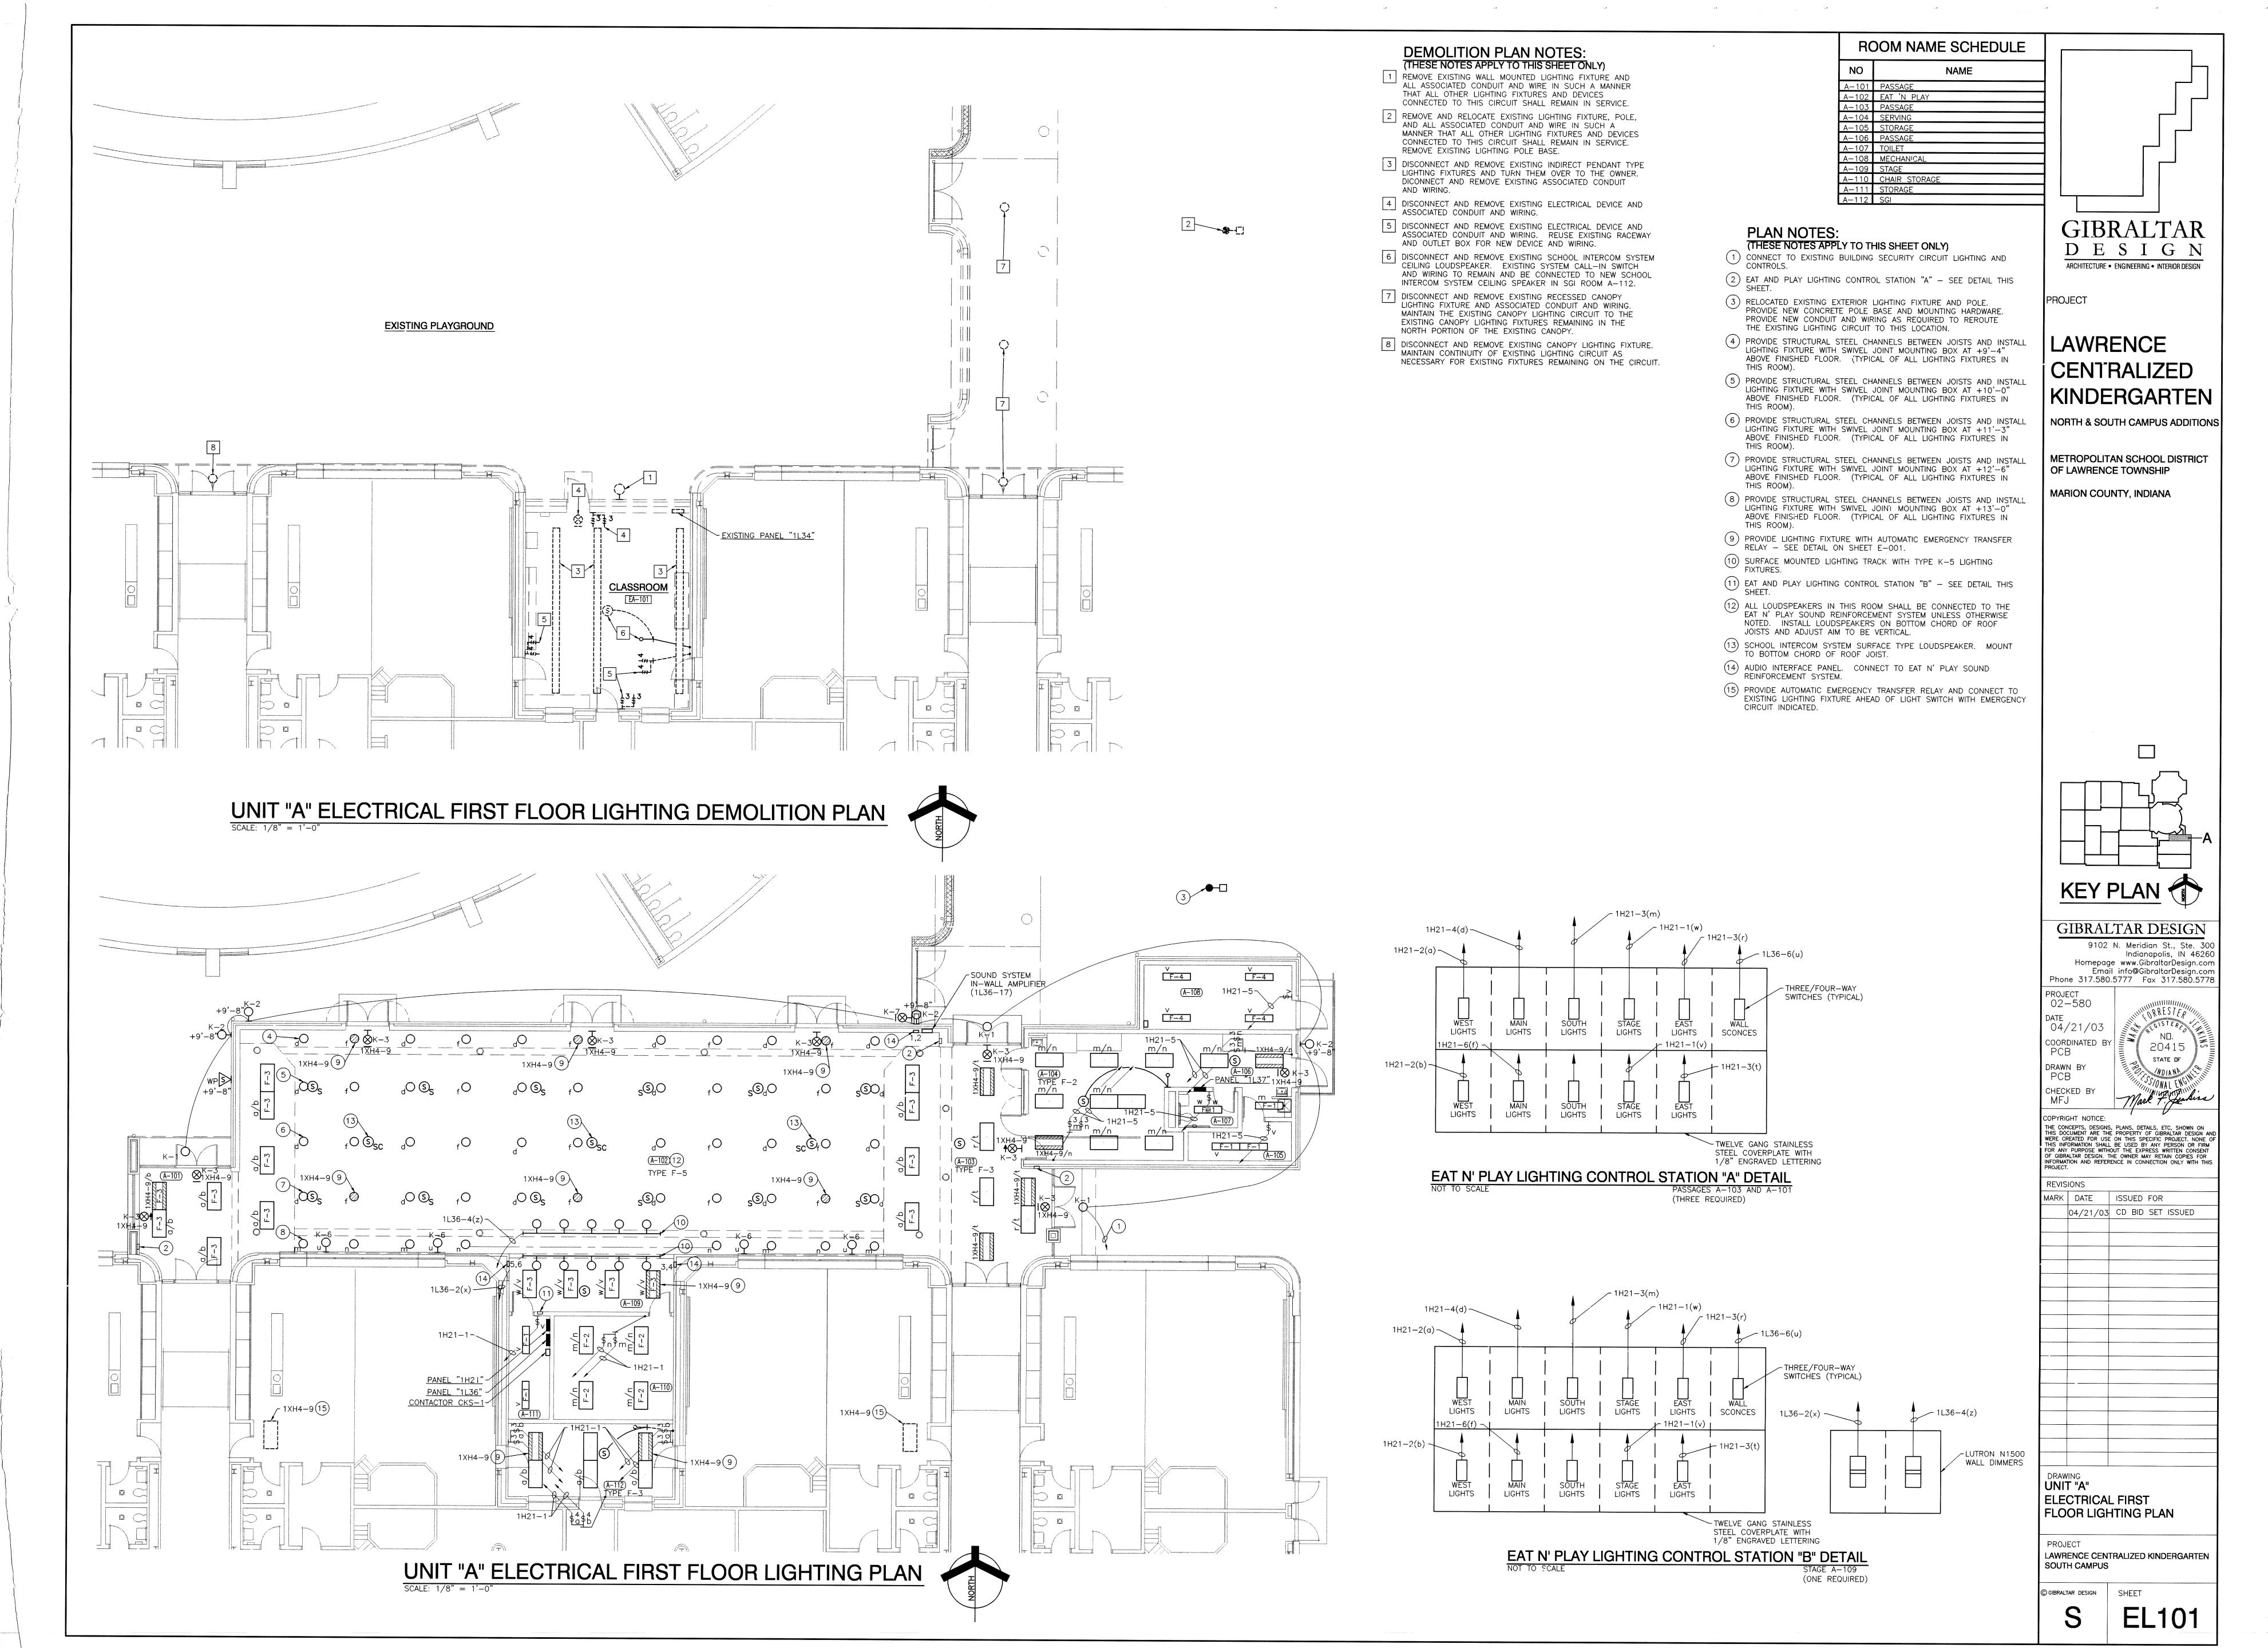
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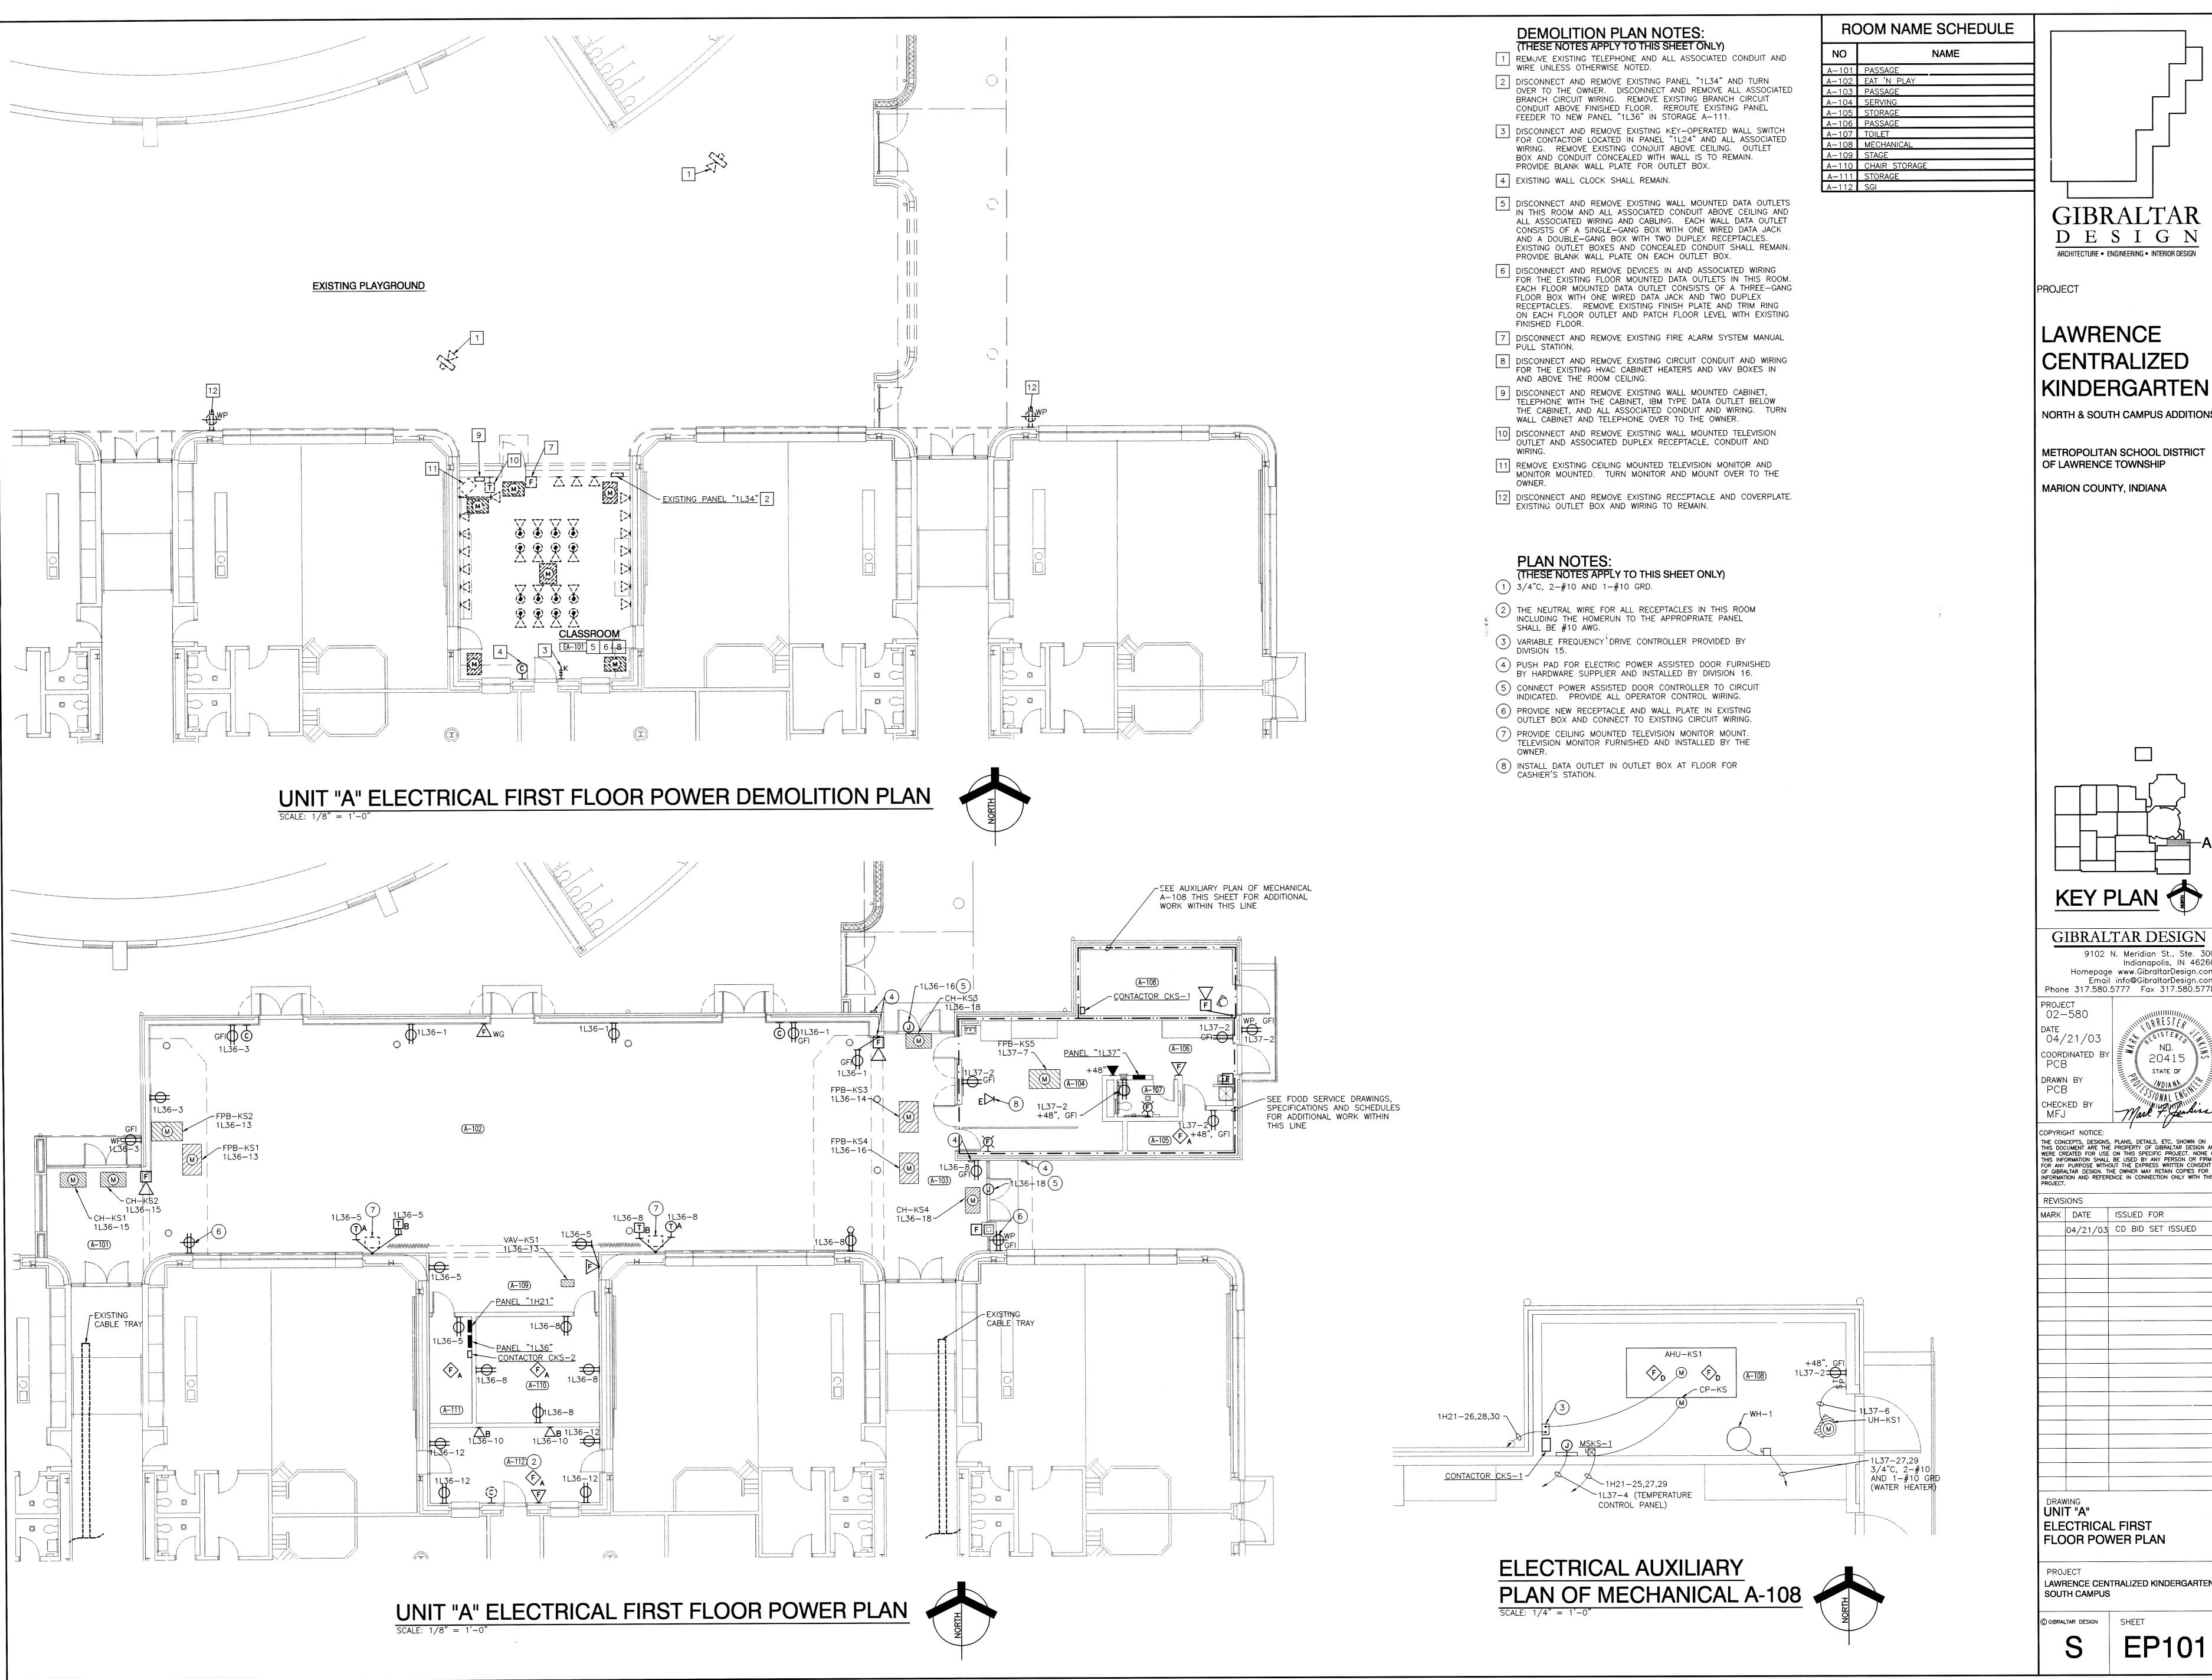
PARTIAL ELECTRICAL FIRST FLOOR PLAN


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SOUTH CAMPUS

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LAWRENCE CENTRALIZED KINDERGARTEN

METROPOLITAN SCHOOL DISTRICT OF LAWRENCE TOWNSHIP

KEY PLAN

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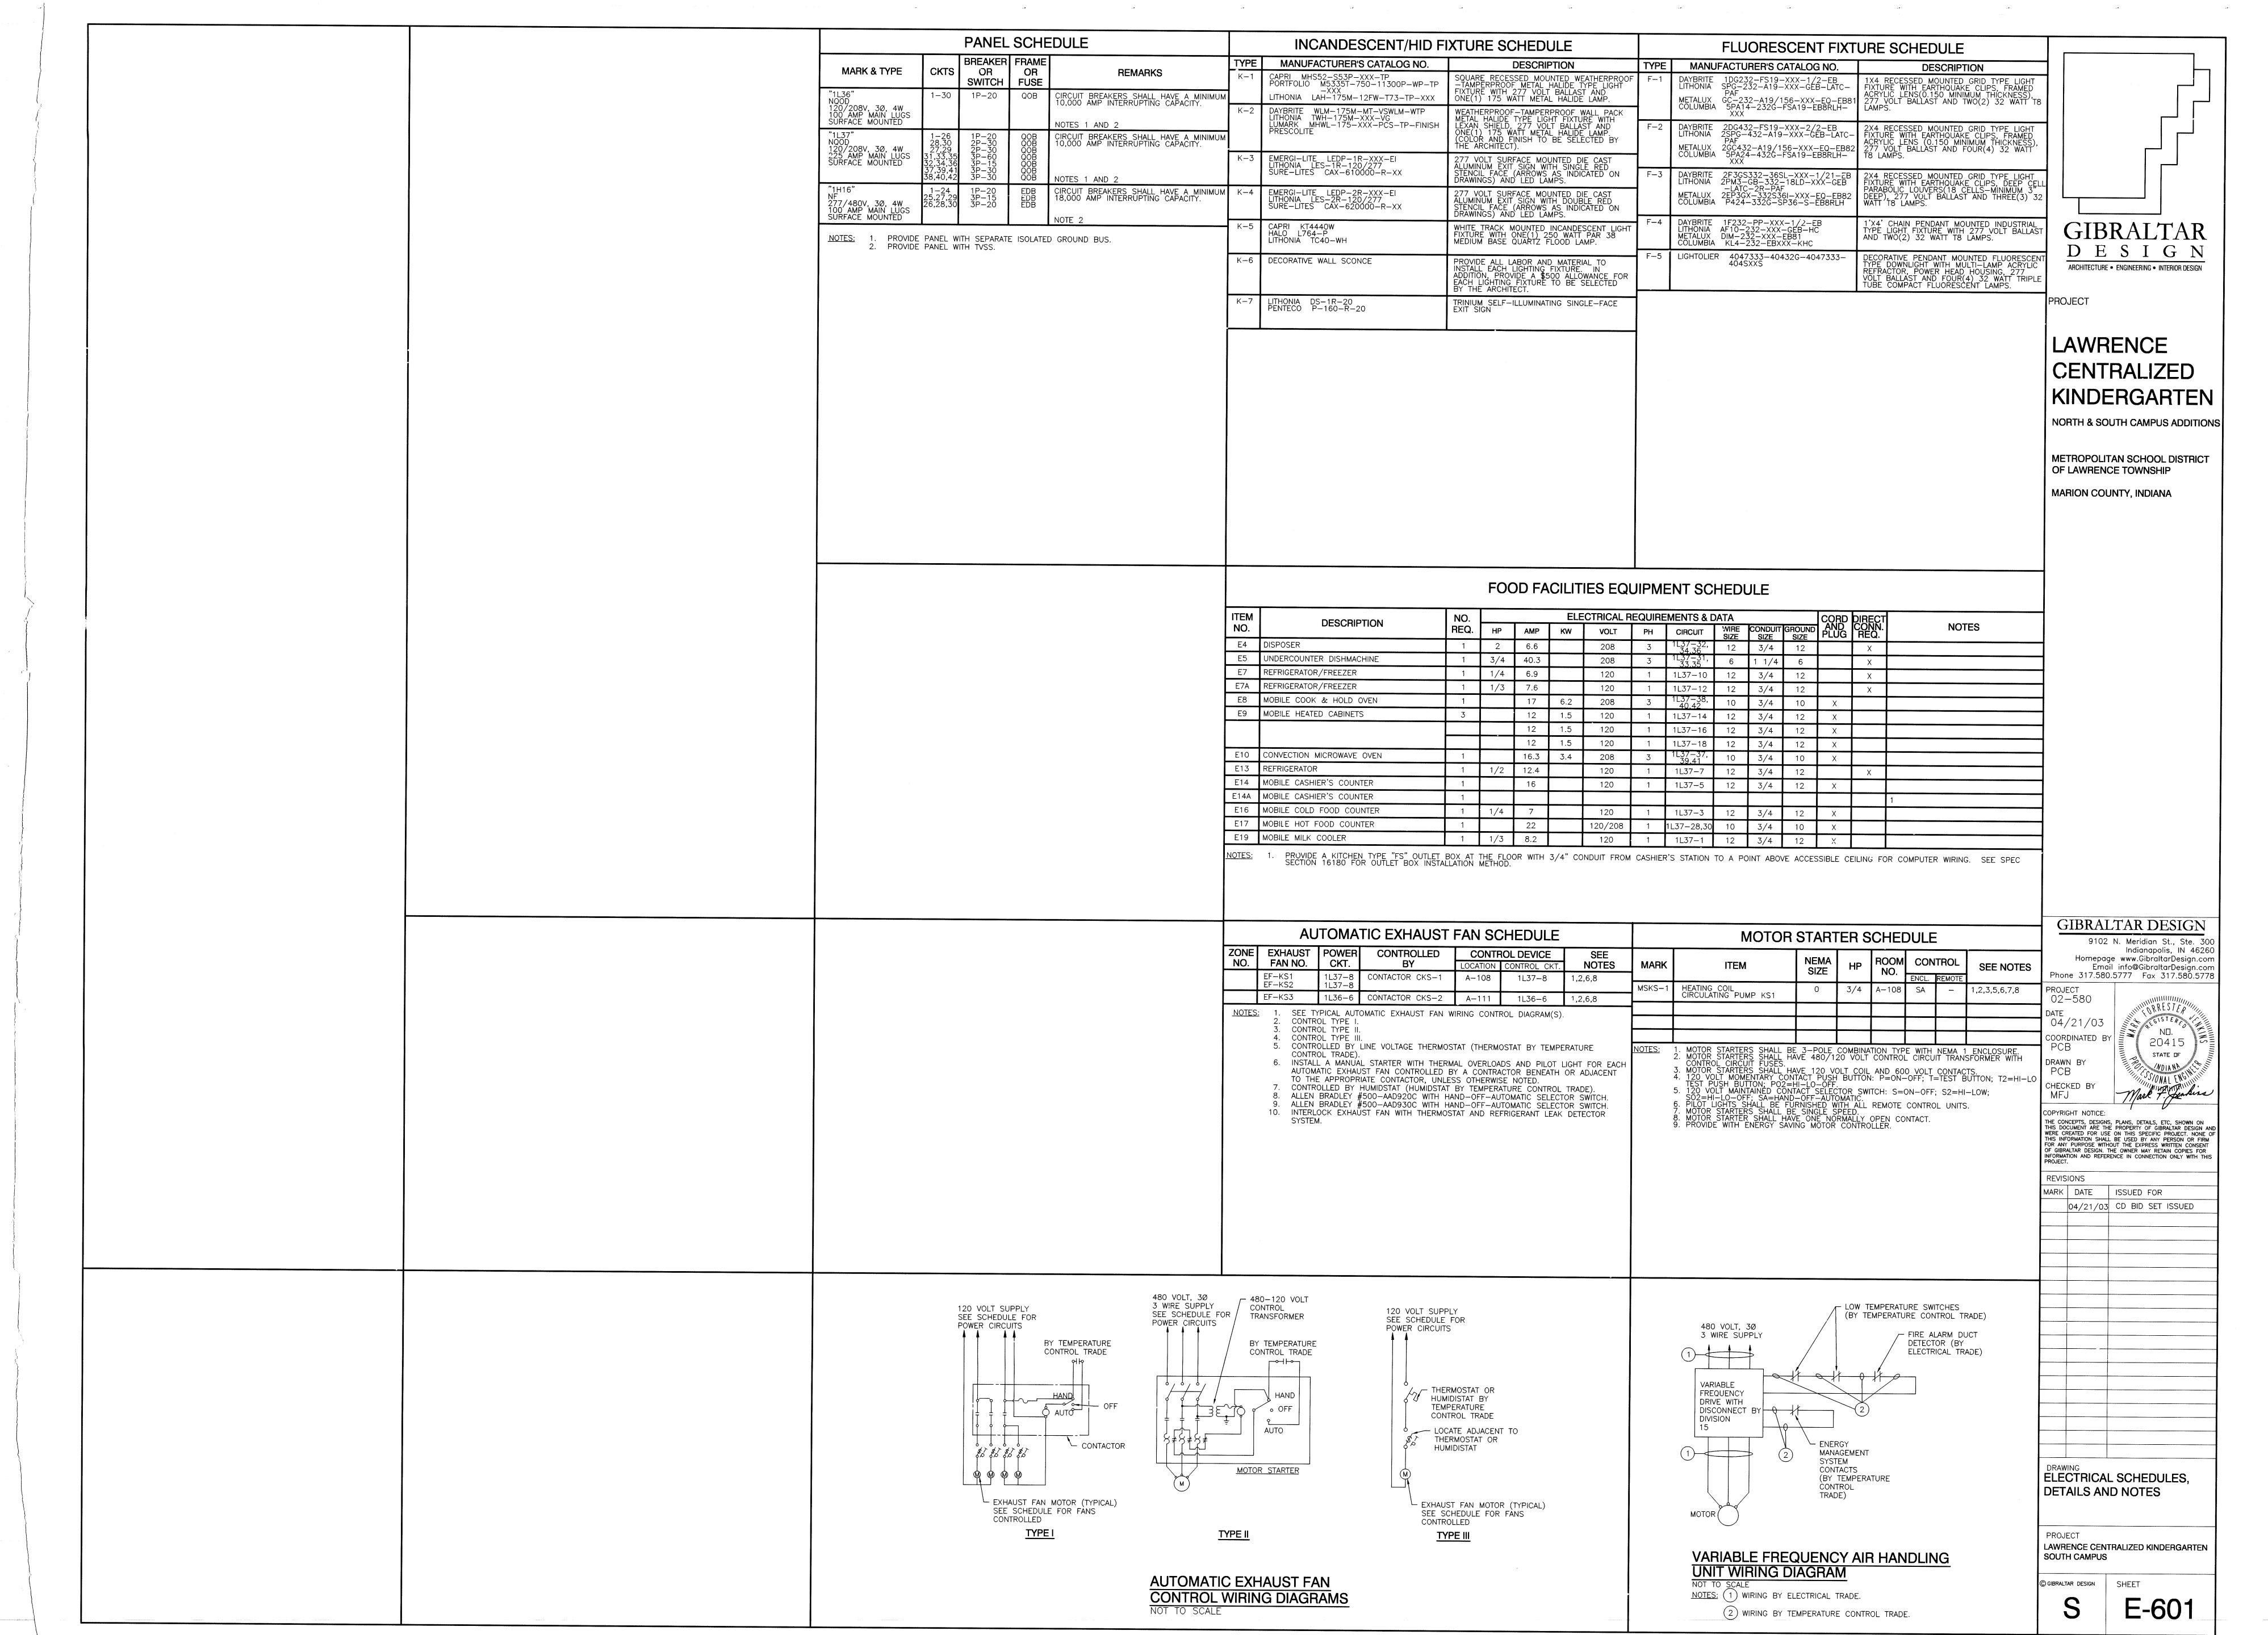
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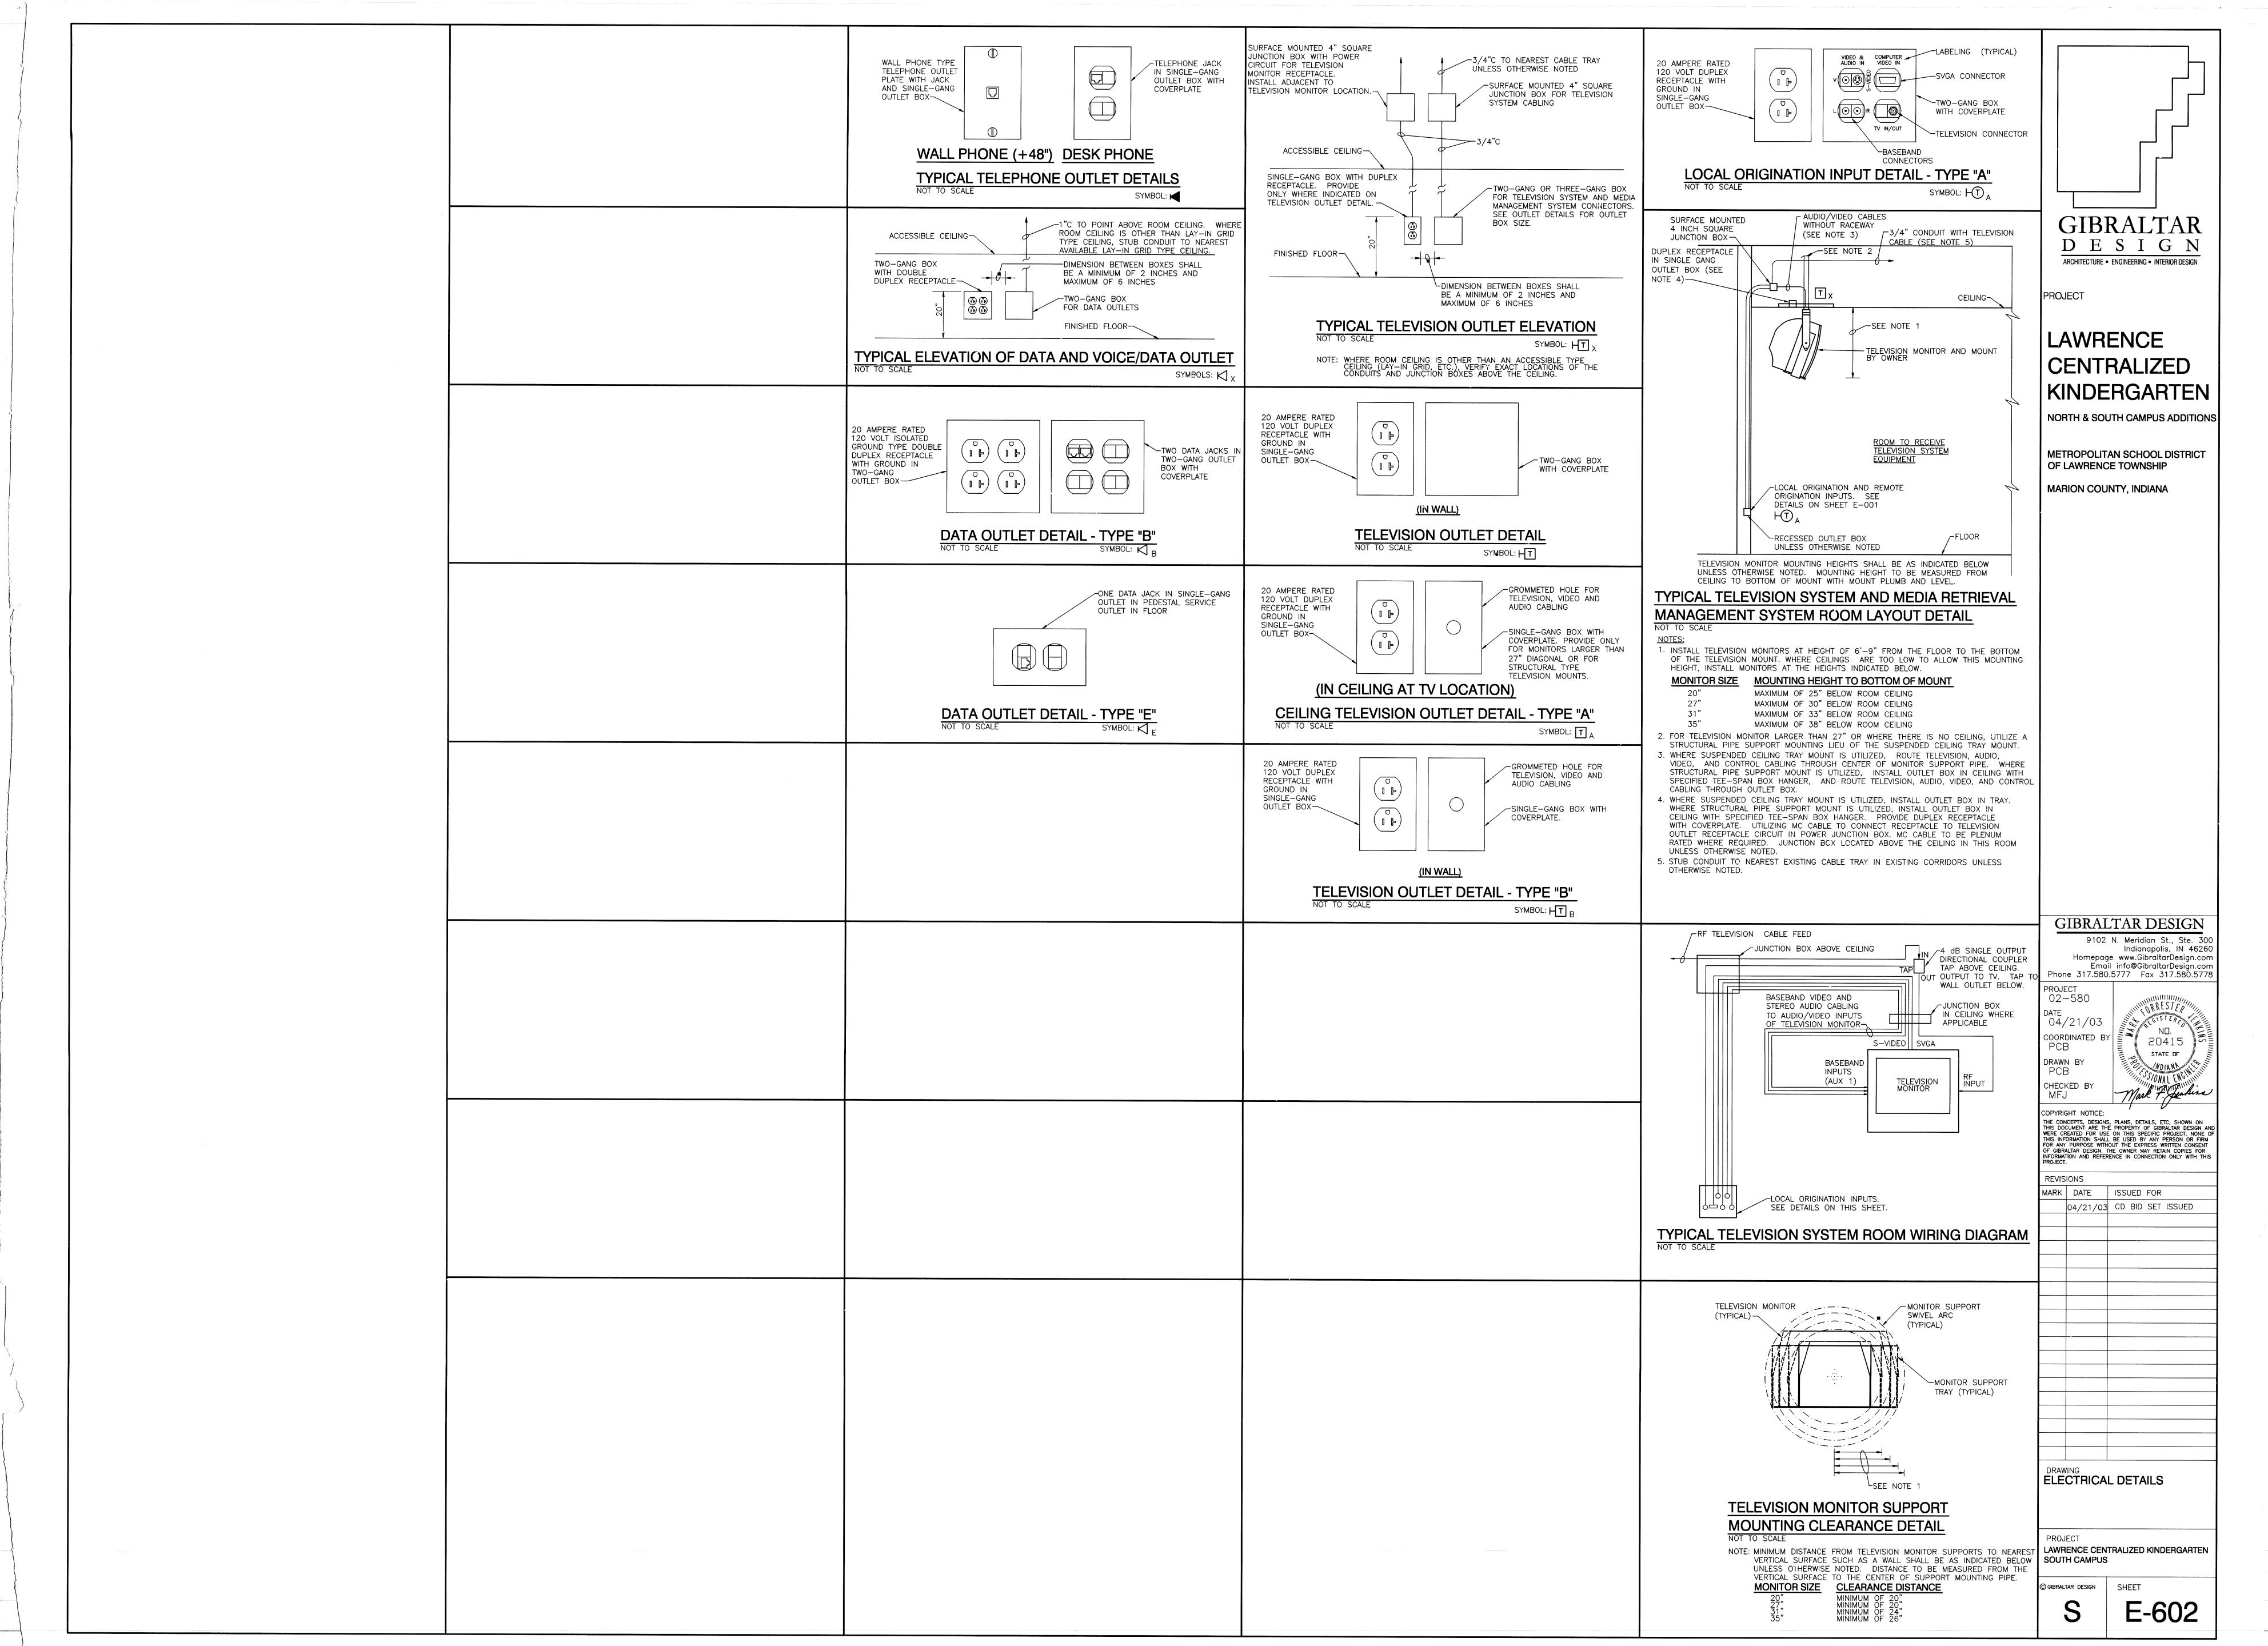
ELECTRICAL FIRST FLOOR POWER PLAN

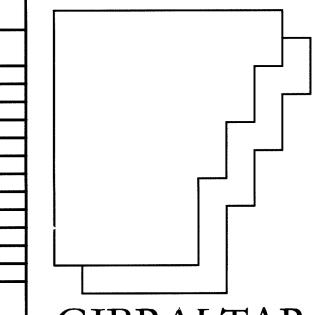
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SOUTH CAMPUS


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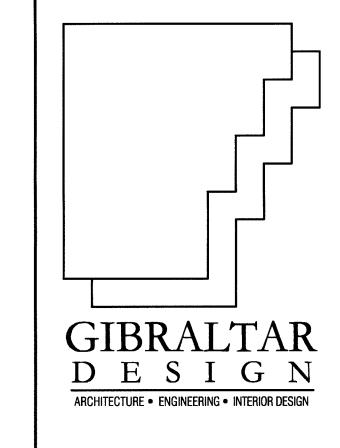


EAT 'N PLAY A-102 SOUND SYSTEM DISTRIBUTION DIAGRAM NOT TO SCALE



PARTIAL POWER DISTRIBUTION DIAGRAM NOT TO SCALE

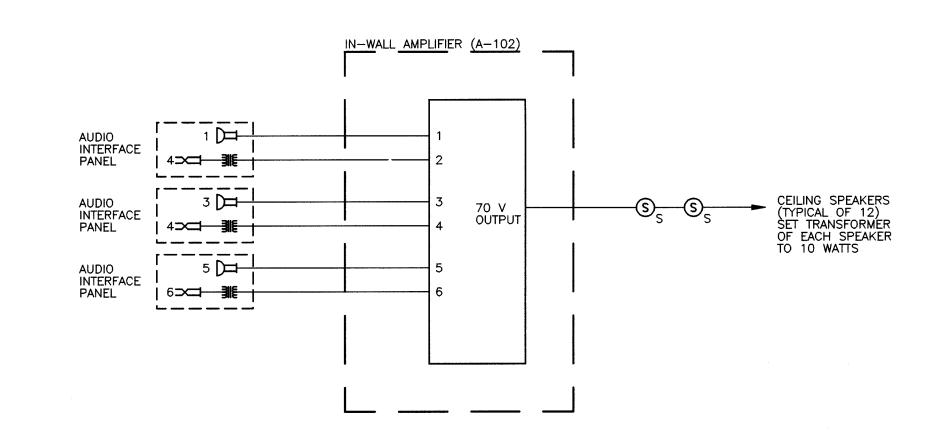- NOTES: 1 REMOVE EXISTING PANEL AND ALL ASSOCIATED CONDUIT AND WIRE UNLESS OTHERWISE NOTED.
 - 2) INTERCEPT EXISTING FEEDER CONDUIT AND EXTEND TO NEW PANEL. PROVIDE NEW CONDUCTORS AND GROUNDS FROM EXISTING PANEL "1LD1" TO NEW PANEL "1L36".
 - 3 CONNECT NEW PANEL "1L37" TO SPARE 3P-200 AMP FUSIBLE SWITCH AS INDICATED AND PROVIDE NEW 200 AMP FUSES.
 - 4 PROVIDE ISOLATED GROUND BUS IN EXISTING DISTRIBUTION PANEL.

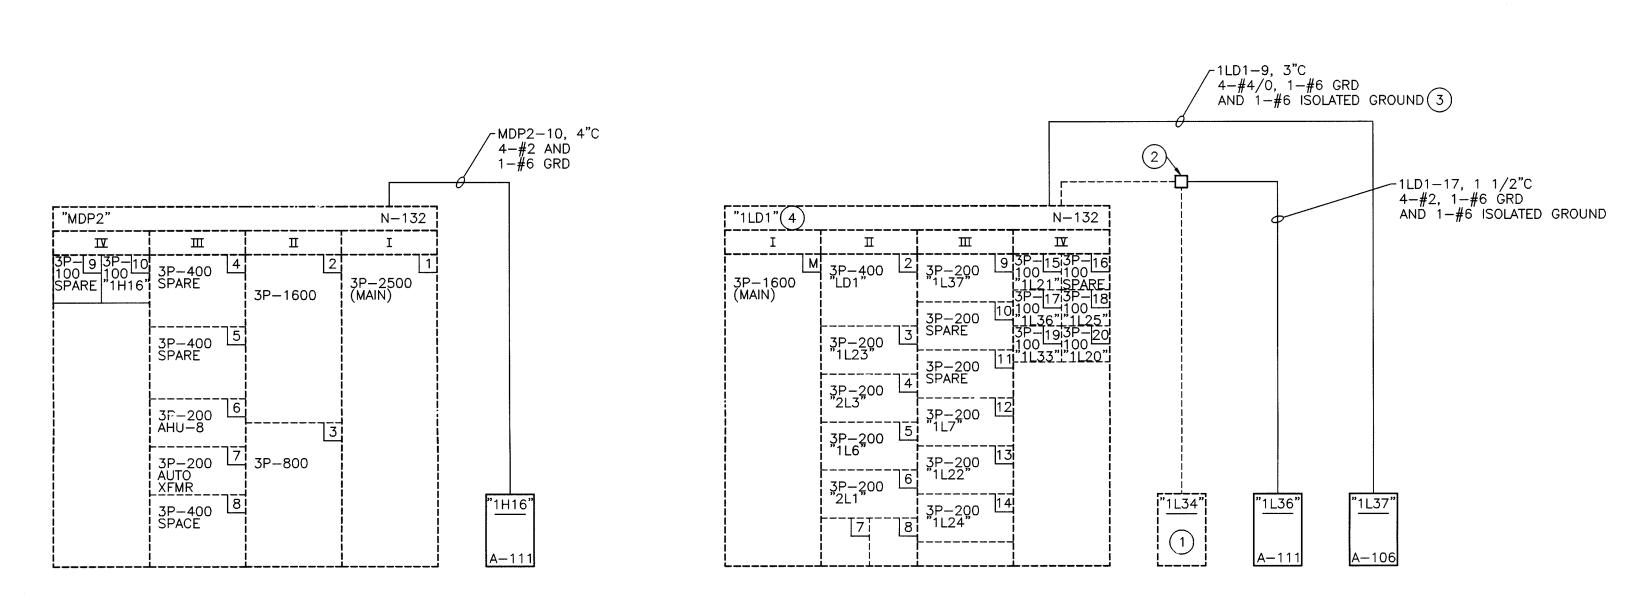

PROJECT

LAWRENCE CENTRALIZED KINDERGARTEN

NORTH & SOUTH CAMPUS ADDITIONS

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DRAWING ELECTRICAL DISTRIBUTION DIAGRAMS

PROJECT LAWRENCE CENTRALIZED KINDERGARTEN SOUTH CAMPUS

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