

April 21, 2022

LOPER ELEMENTARY SCHOOL RENOVATION 901 Loper Drive Shelbyville, IN 46176

TO: ALL BIDDERS OF RECORD

This Addendum forms a part of and modifies the Bidding Requirements, Contract Forms, Contract Conditions, the Specifications, and the Drawings dated April 6, 2022, by Lancer+Beebe, LLC. Acknowledge receipt of the Addendum in the space provided on the Bid Form. Failure to do so may subject the Bidder to disqualification.

This Addendum consists of Pages ADD 1-1 through ADD 1-2, Interior Phasing Plan, Site Logistics Plan, Guideline Schedule, and attached Lancer+Beebe Addendum No. 1, dated April 20, 2022, consisting of 6 pages, Specification Sections 12 32 16 – Plastic Laminate Casework, and Drawing Sheets: C201, C301, A011, A101A, A101B, A101C, A112, A121A, A141, A601, A720, A721A, A751, A762, A763, A764, A766, P-101B, PD101B:

A. <u>SPECIFICATION SECTION 00 20 00 – INFORMATION AVAILABLE TO BIDDERS</u>

Add Paragraph B.

B. Site Logistics Plan Dated April 20, 2022 has been included in Addendum 1 for Contractor reference.

B. <u>SPECIFICATION SECTION 01 12 00 – MULTIPLE CONTRACT SUMMARY</u>

1. Paragraph 3.02 General Requirements

C. Provided by designated contractors - Clarifications

Revise the following General Clarification

- 3. All contractors are responsible to protect adjacent finishes from damage during construction activities.
- 2. Paragraph 3.03 Bid Categories

A. Bid Category No. 1 – General Trades

Revise the following Project Specific Clarification

8. General Trades Contractor to provide downspout boots or adapters and all associated storm sewer piping at and below grade. General Trades Contractor to ensure existing downspouts are protected in place and tied into new downspout boots or adapters.

B. Bid Category No. 2 – Roofing.

Delete the following Bid Category

BC02 – Remove roofing scope of work from this project. Roofing scope of work for this project is to be included in separate project.

<u>G. Bid Category No. 7 – Plumbing & Mechanical</u>

Revise the following Project Specific Clarification

3. Regarding rooftop mechanical equipment demolition and installation, it is the responsibility of the Plumbing & Mechanical Contractor to remove any equipment scheduled for removal or demolition. The Plumbing & Mechanical Contractor is then responsible for all roof patching of openings and penetrations to create a weather tight roof system.

C. <u>SPECIFICATION SECTION 01 32 00 – SCHEDULES AND REPORTS</u>

1. 1.03 Guideline Schedule


Add Paragraph A.3

A.3. Loper Elementary School Renovation – Guideline Schedule Dated June 1, 2022 has been issued as part of Addendum 1 for Contractor reference.

Add Paragraph B.1


B.1. Interior Phasing Plan Dated April 20, 2022 has been issued as part of Addendum 1 for Contractor reference.



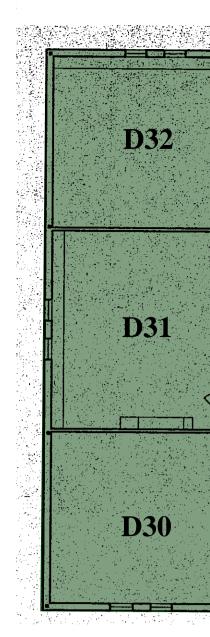







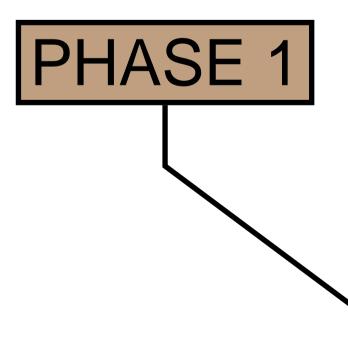

Interior Phasing Plan

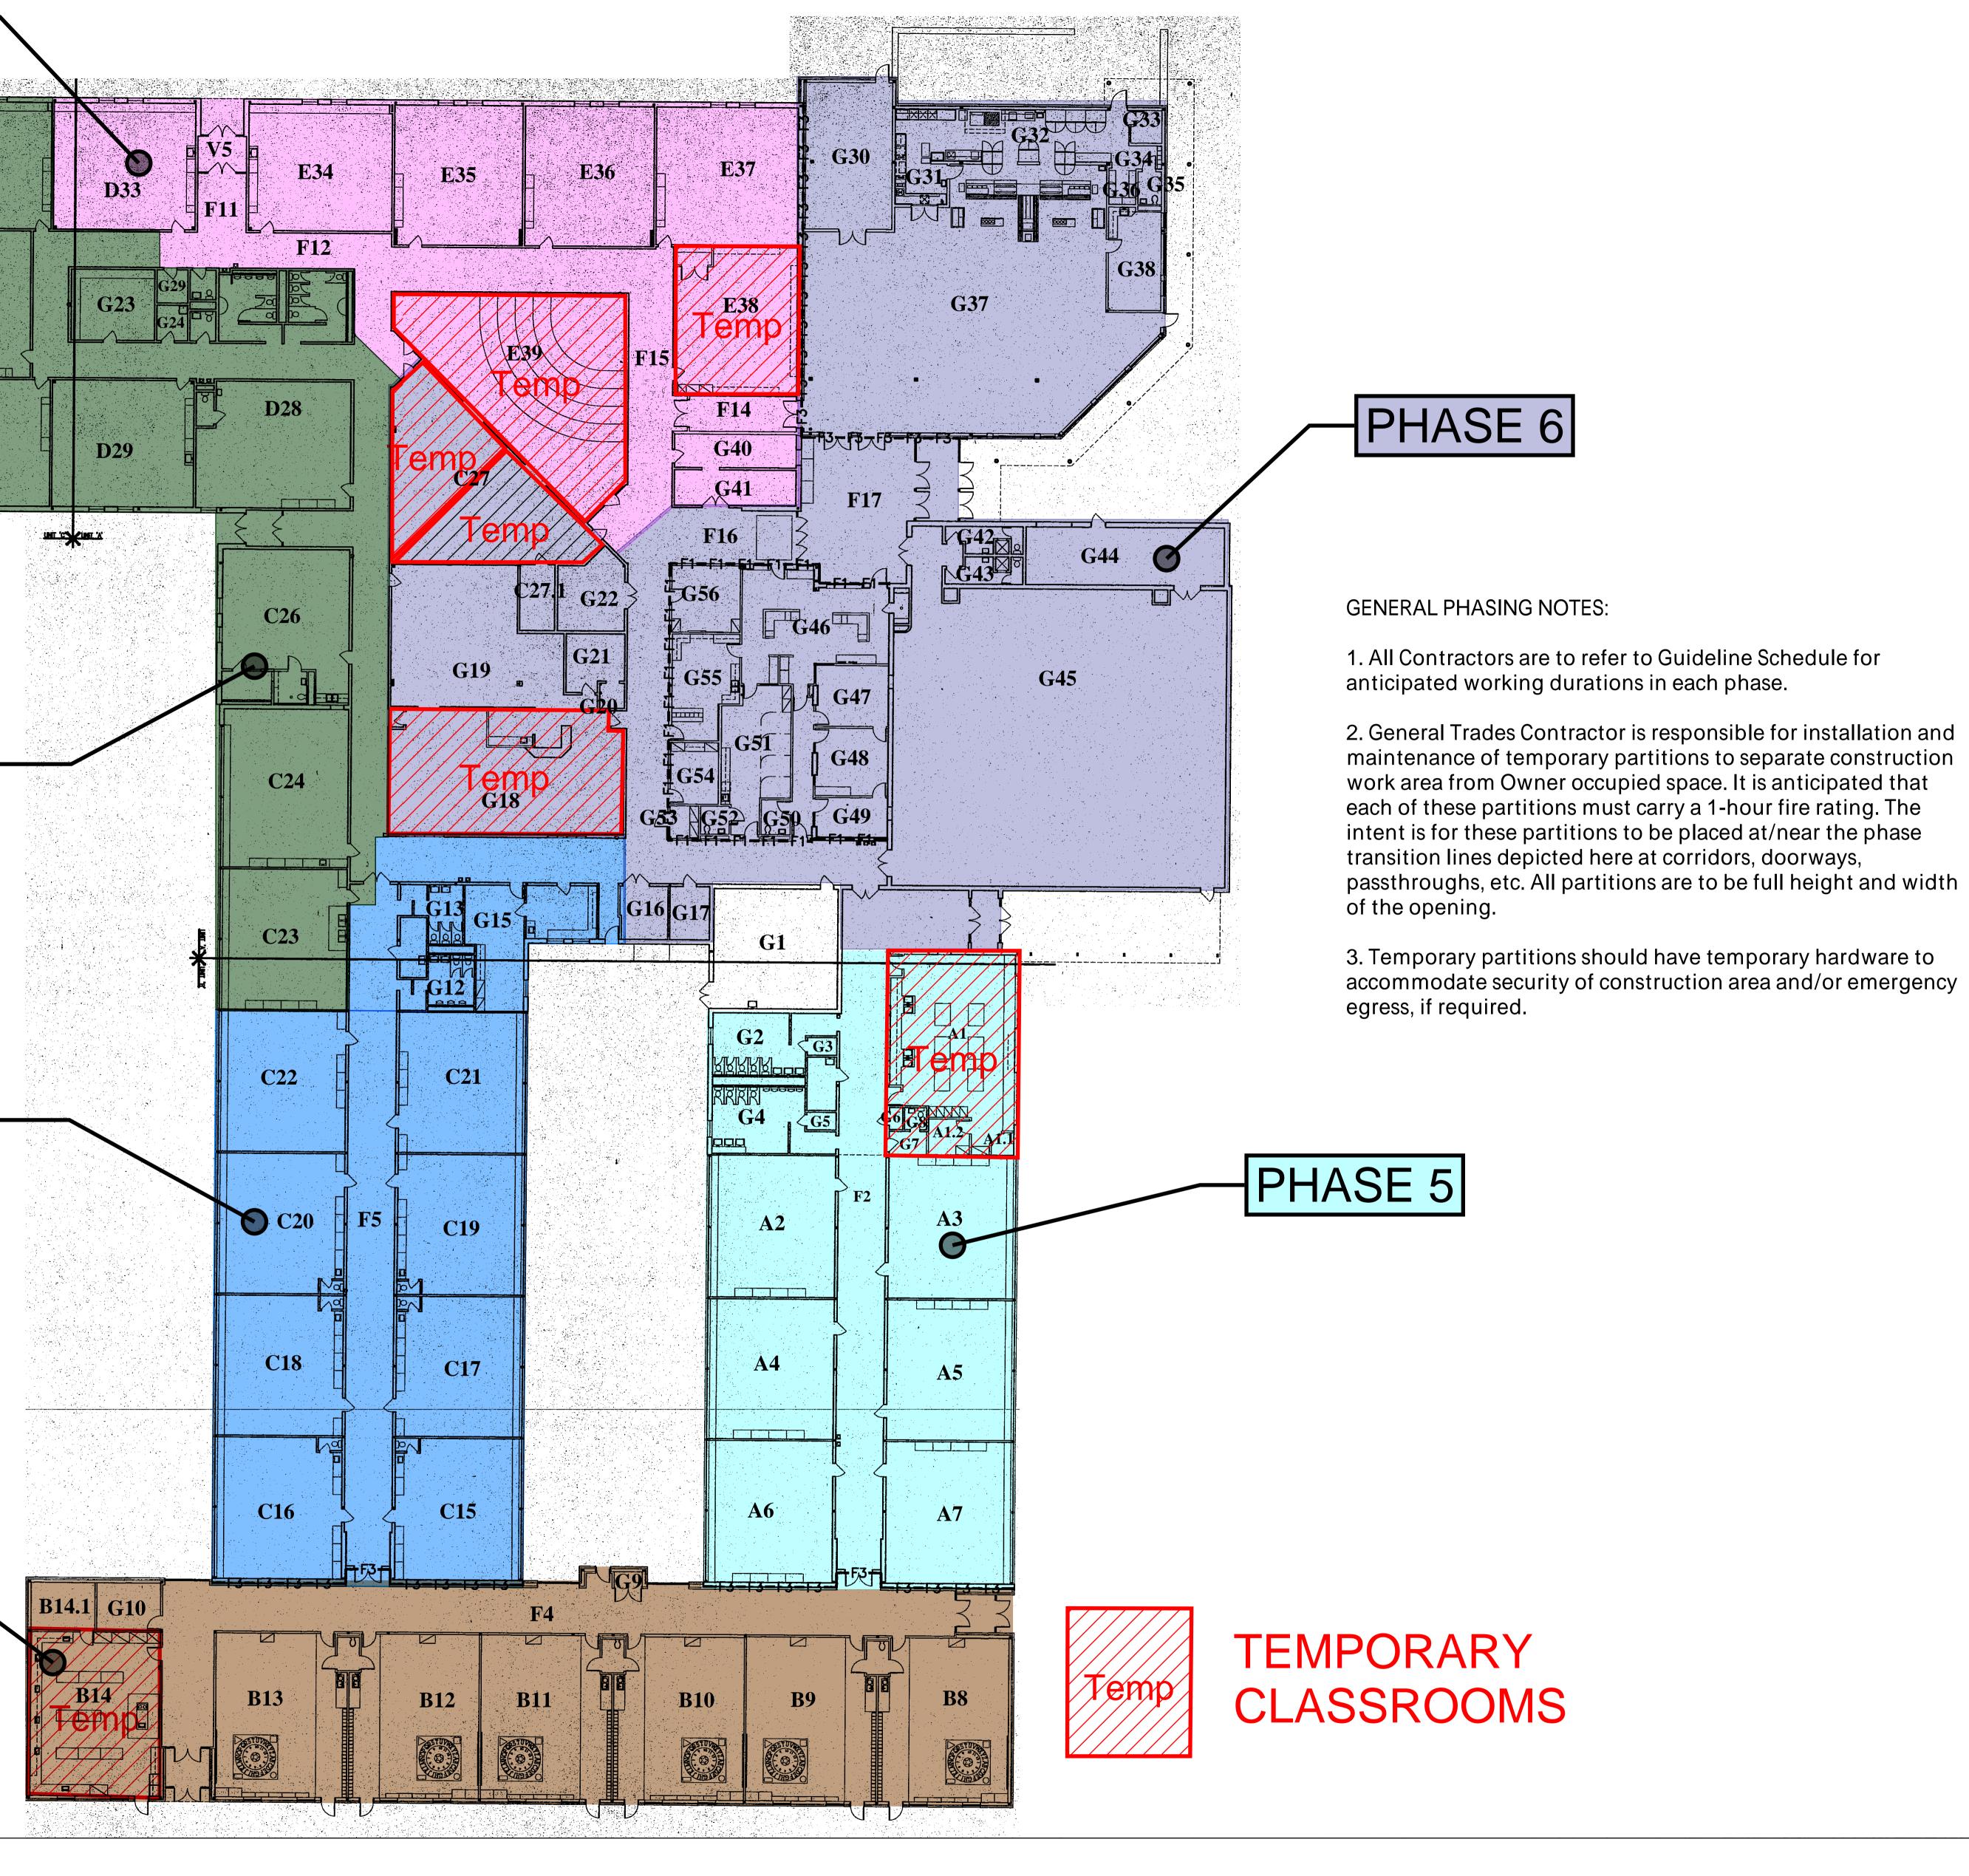

Drawing Date: April 20, 2022

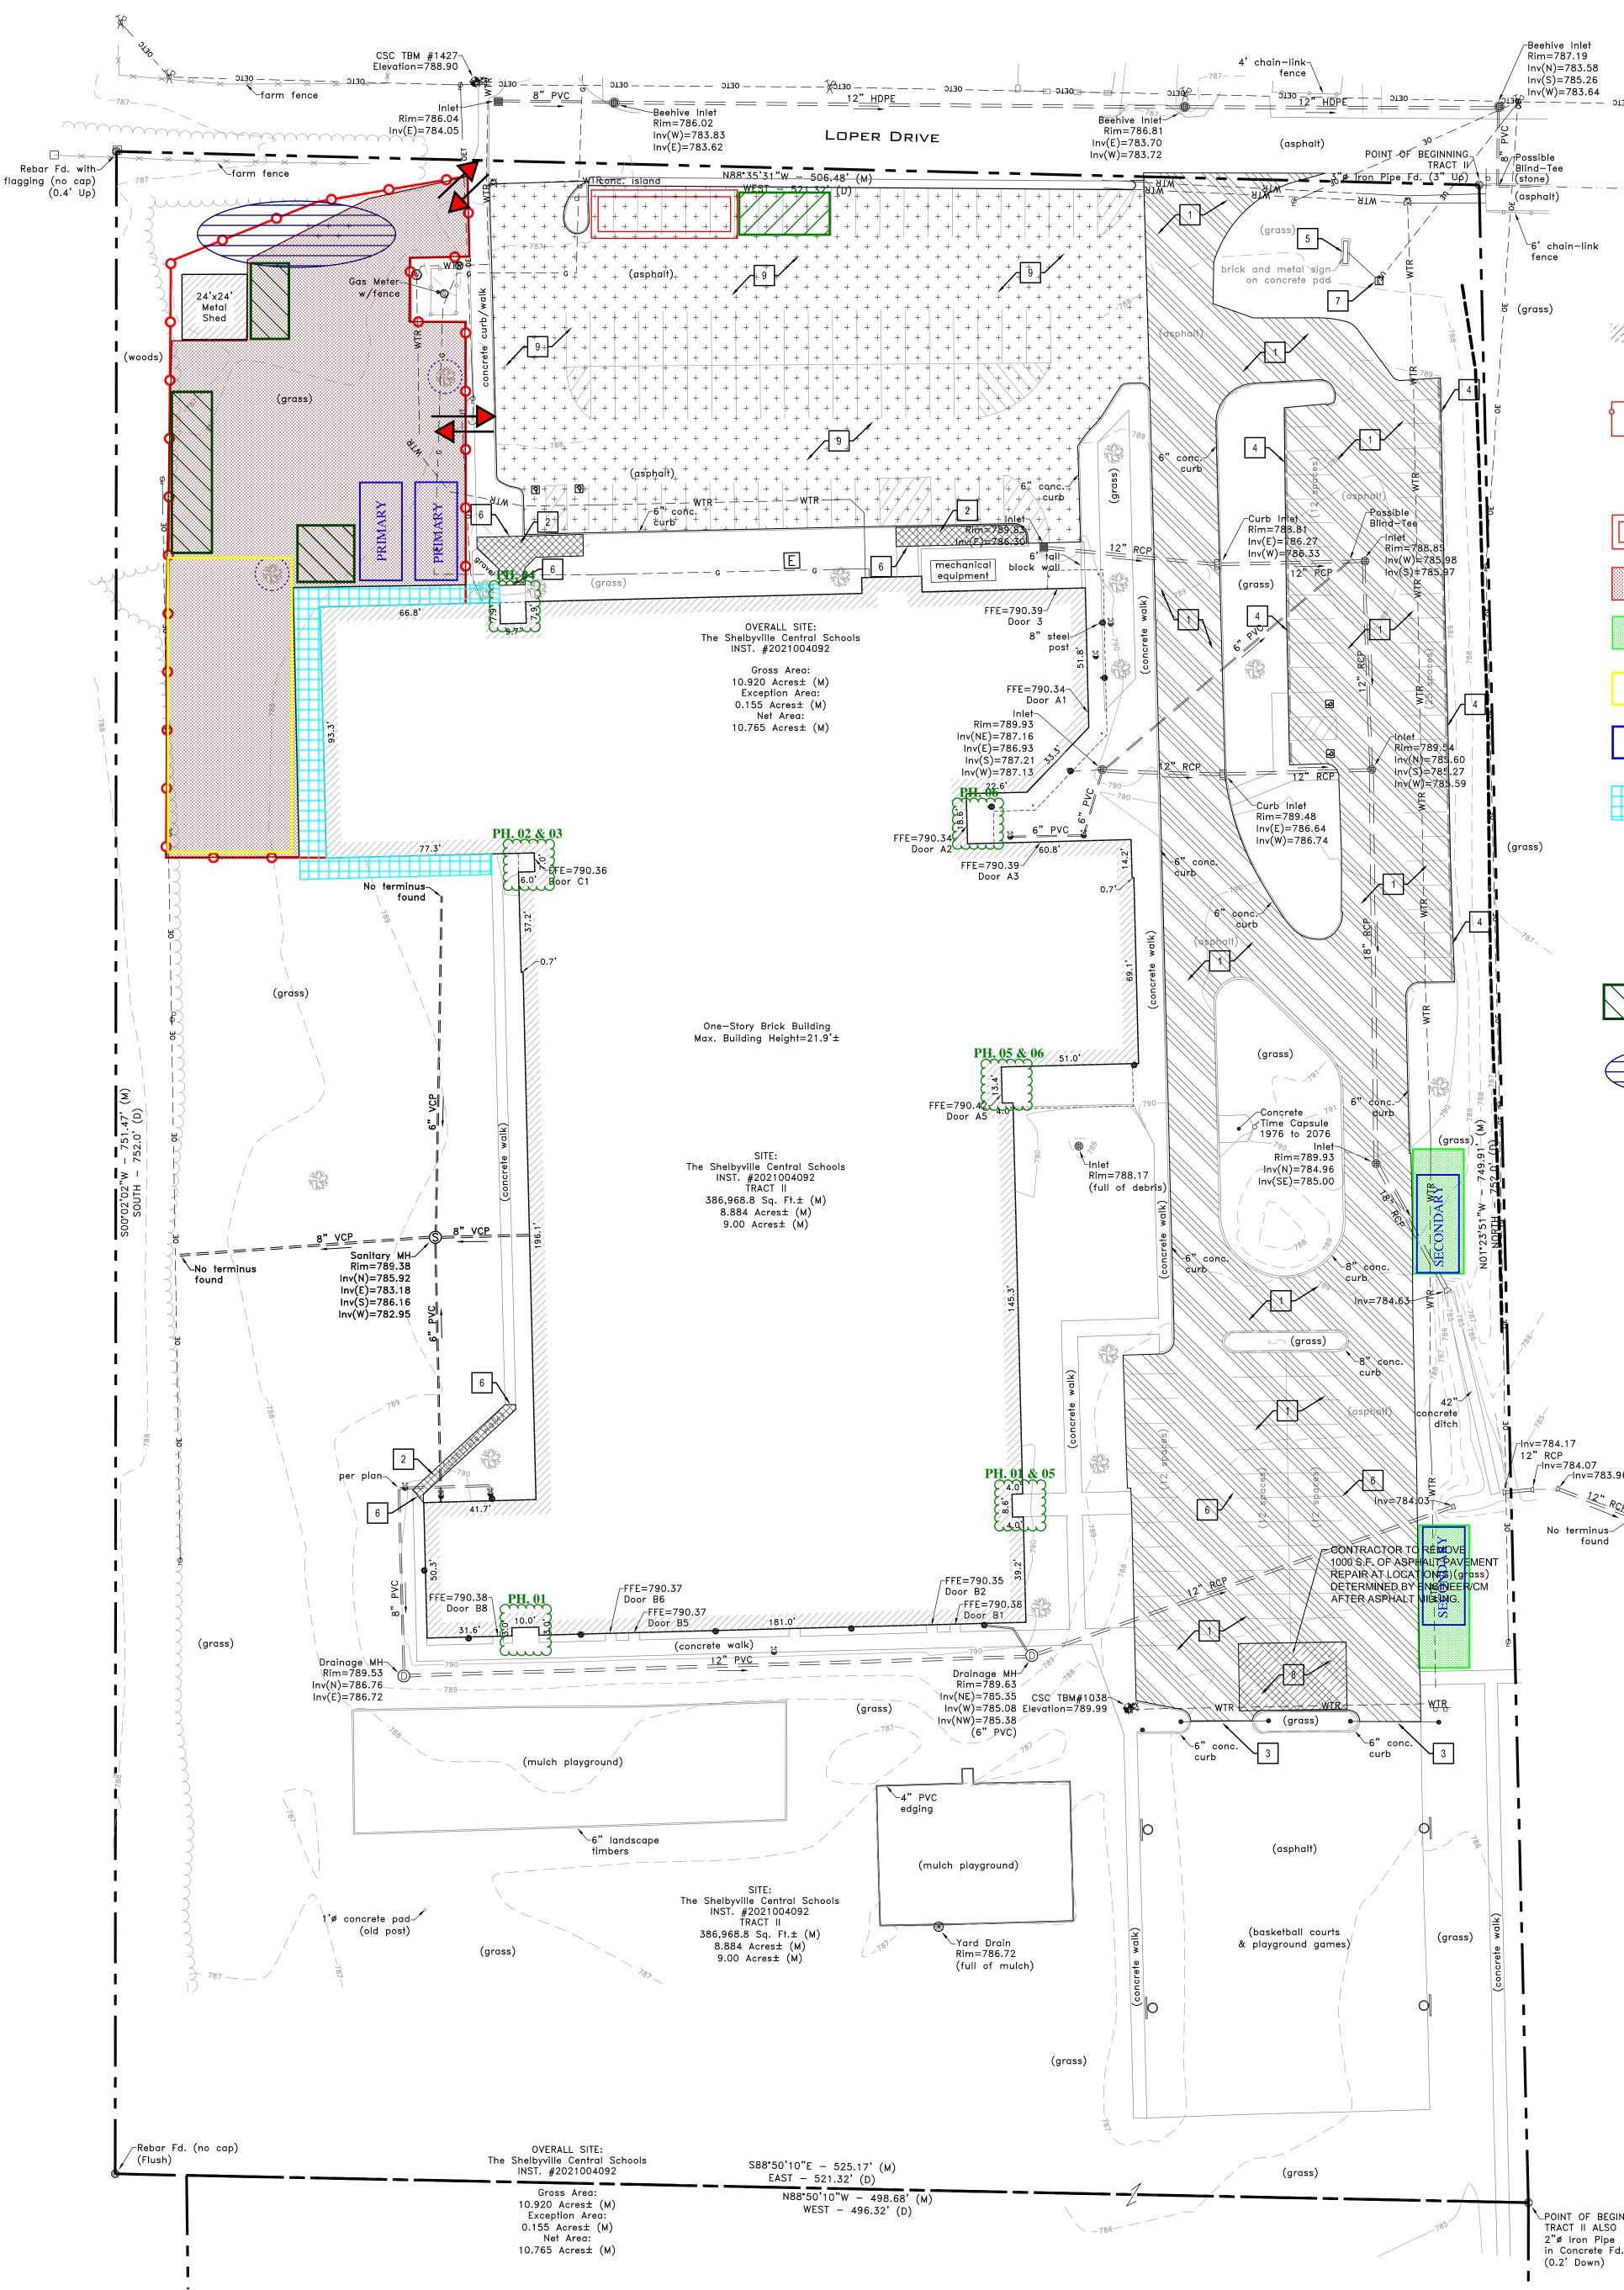

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Jobsite Construction Fencing

Proposed Gate Locations


Skillman Construction Trailer

Heavy-Duty Temporary Stone

Light-Duty Temporary Stone

Proposed Dumpster Locations

Contractor Laydown and Trailer Locations

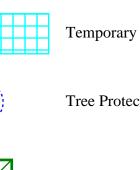

Temporary Compacted Stone Walking Path Tree Protection Fencing

Reserved Parking for Skillman Personnel

Contractor Parking

Anticipated Collection Area of Storm Runoff

Access Point for Each Construction Phase

GENERAL SITE LOGISTICS NOTES:

1. General Trades Contractor is responsible for installation and maintenance of all temporary stone access roads and laydown areas. This includes all locations noted to receive temporary stone.

2. Heavy-Duty Temporary Stone is to be installed with a combination of drainage fill and crushed stone to achieve a sturdy stone base capable of withstanding heavy equipment use, semi-truck deliveries, tri-axle trucks, and/or concrete trucks. Note, this is not an all-inclusive list and is to be used as reference.

3. Light-Duty Temporary Stone is to be installed with a combination of drainage fill and crushed stone to achieve a sturdy stone base capable of withstanding minor vehicle traffic, dumpster storage, and/or vehicle parking.

4. General Trades Contractor is responsible for all public and private utility locates prior to commencing with any form of earthwork, grading, excavation, or post-driven fencing.

5. General Trades Contractor is responsible for installation and maintenance of Temporary Compacted Stone Walking Path for the duration of the project.

6. Contractor Laydown and Trailer Locations are to be coordinated with the Construction Manager Prior to mobilization to jobsite.

7. Contractor Parking is shown for reference purposes. Exact locations of Contractor Parking is to be coordinated with the Construction Manager.

8. General Trades Contractor is responsible and maintenance of tree protection fencing for the duration of the project.

9. Primary Dumpster Locations are shown to depict the approximate locations of dumpsters for the duration of the project, Secondary Dumpster Locations are shown for possible locations to be used to minimize travel distance during certain interior renovation phases. Dumpster locations are to be coordinated with the Construction Manager.

10. Access Points for Each Construction Phase is not final. These are the anticipated exterior doors to be used for construction access during each phase, but final building access is to be coordinated with Construction Manager.

11. All Contractors should plan to minimize equipment operation around the jobsite. There will be consistent daily coordination with vehicles, buses, and pedestrians for the duration of the project. Contractors should intend on using trash carts for removal and transportation of debris from building interior. Activities that require equipment is to be planned and coordinated with Construction Manager.

12. It is prohibited to store any material or equipment outside of the Jobsite Construction Fencing for the duration of the project without prior approval of the Construction Manager.

13. Anticipated Collection Area of Storm Runoff is noted as this location tends to collect storm water. It is the responsibility of the General Trades Contractor to monitor this area and mitigate water collection after heavy precipitation events. It is the intent for the General Trades Contractor to have an operational sump pump on site with all necessary IDEM filters, bags, etc. to pump away this storm water when directed by the Construction Manager.


DEMOLITION NOTES


- 1. CONTRACTOR SHALL BE RESPONSIBLE FOR OBTAINING OR VERIFYING THAT PERMITS AND APP THE RESPECTIVE CITY, COUNTY OR STATE AGENCIES PRIOR TO STARTING ANY CONSTRUCTION IN ACCORDANCE WITH THE LOCAL AUTHORITIES STANDARDS AND SPECIFICATIONS.
- CONTRACTOR SHALL COORDINATE WORK WITH OTHER CONTRACTORS ON SITE. CONTRACTOR SHALL BE RESPONSIBLE FOR NOTIFICATION AND COORDINATION OF ALL CONSTRUCTION WITH THE RESPECTIVE UTILITY PROVIDERS PRIOR TO STARTING ANY CONSTRUCTION.
- 4. REMOVE ALL STRUCTURES, SUPPORT COLUMNS, FOOTINGS, ASPHALT PAVING, CONCRETE CURB, SIDEWALKS, CONCRETE PADS, TREES, STUMPS, HEDGES, UTILITIES, AND OTHER EXISTING SITE FEATURES WITHIN LIMITS OF DEMOLITION. ALL DEMOLITION MATERIALS SHALL BE REMOVED FROM THE SITE UNLESS OTHERWISE NOTED AND DISPOSED OF IN A MANNER ACCEPTABLE TO THE LOCAL AUTHORITY HAVING JURISDICTION.
- 5. CALL "811", OR 1-800-382-5544, 72 HOURS PRIOR TO THE START OF ANY EXCAVATION. CONTRACTOR SHAL BE RESPONSIBLE FOR MARKING & LOCATING PRIVATE UTILITIES INSIDE AREA OF NEW CONSTRUCTION IF THOSE UTILITIES ARE NOT MARKED OR LOCATED BY "HOLEY MOLEY".
- 6. CONTRACTOR SHALL PROTECT ALL EXISTING AND NEW CONSTRUCTION FROM DAMAGE. SHOULD ANY DAMAGE OCCUR, CONTRACTOR SHALL MAKE ALL NECESSARY REPAIRS AT NO COST TO THE OWNER.
- 7. EXISTING UNDERGROUND UTILITIES ARE PLOTTED FROM ORIGINAL SITE DRAWINGS AND TOPOGRAPHIC SURVEY. EVERY ATTEMPT HAS BEEN MADE TO SHOW ALL UTILITY LINES WHERE THEY EXIST. CONTRACTOR SHALL TAKE EVERY PRECAUTION IN EXCAVATING FOR NEW UTILITIES SINCE ACTUAL UNDERGROUND UTILITIES MAY NOT BE AS SHOWN. CONTRACTOR SHALL MAKE HIMSELF THOROUGHLY FAMILIAR WITH ALL UNDERGROUND UTILITY LOCATIONS PRIOR TO ANY EXCAVATION AND VERIFY LOCATIONS AND DEPTHS OF ALL UTILITIES.
- 8. CONTRACTOR SHALL MAINTAIN UTILITY SERVICES TO ADJACENT PROPERTIES AT ALL TIMES. ANY INTERRUPTION IN SERVICES MUST BE SCHEDULED WITH THE OWNER 48 HOURS PRIOR TO THE INTERRUPTION.
- CONSTRUCTION. 10. ALL CATCH BASIN AND MANHOLE FRAMES AND COVERS SPECIFIED TO BE REMOVED SHALL BE SALVAGED, CLEANED AND
- INSPECTED. IF THEY ARE DEEMED SOUND, THEY MAY BE REUSED AT LOCATIONS APPROVED BY ENGINEER. 11. PROTECT ALL TREES AND SHRUBS NOT SCHEDULED FOR REMOVAL. DO NOT OPERATE EQUIPMENT, STORE, STOCKPILE, OR
- PARK WITHIN DRIP LINE OF PLANTS. HOLD NECESSARY DISTURBANCE TO A MINIMUM. 12. REMOVAL ITEMS SHOWN ARE BASED ON BEST AVAILABLE INFORMATION AND ARE SHOWN SCHEMATICALLY. THE CONTRACTOR SHALL VISIT THE SITE PRIOR TO BID TO BE FULLY FAMILIAR WITH THE EXTENT OF REMOVAL ITEMS. THE CONTRACTOR IS RESPONSIBLE FOR ALL REMOVALS NECESSARY TO COMPLETE CONSTRUCTION. QUESTIONS REGARDING ITEMS TO BE REMOVED SHALL BE DIRECTED TO THE ENGINEER PRIOR TO CONSTRUCTION.

DEMO LEGEND

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EY NOTES
MILL ASPHALT PAVEMENT
REMOVE CONCRETE PAVEMENT
REMOVE EXISTING GATE
REMOVE / RE-INSTALL EX. PARKING BUMPER
REMOVE EXISTING SIGN / REPLACE WITH NE (SEE ELECTRICAL SITE PLAN)


6 SAW CUT PAVEMENT 7 REMOVE / RELOCATE EX. ELECTRICAL BOX (SEE ELECTRICAL SITE PLAN)

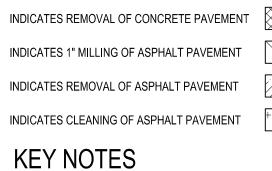8 REMOVE ASPHALT PAVEMENT

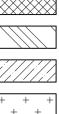9 CLEAN ASPHALT PAVEMENT PRIOR TO CLEAR COATING

	LE	EGEND:
		DESCRIPTION:
	/ 00	SIGN / TWO POST SIGN
WV S	¢ ())	WATER VALVE/FIRE HYD/METER
A	A	TELE / GAS MARKER
G	Xo	GAS METER / VALVE
c.	. °.	CLEAN-OUT
E	Æ	ELEC. METER BOX/TRANSFORMER
EP	TP	ELEC. / TELEPHONE PEDESTAL
•	-)	GUARD POST/POST with LIGHT
AC	GEN	AIR CONDITIONER / GENERATOR
M	\bigcirc	MAGNAIL SET/FOUND
R	R	REBAR SET/FOUND
		SQUARE / ROUND / CURB INLET
- ® (<i>₽</i> ₽	TRAFFIC/COMBO/ POWER POLE
-\$	♦ ♦	LIGHT POLE – SQUARE / ROUND
	204	CONIFEROUS TREE & SIZE
``12"	(K) ₃₆ "	DECIDUOUS TREE & SIZE
\bigcirc	S	DRAINAGE /SANITARY MANHOLE
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		BEEHIVE ROUND/SQUARE INLET
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	— — — G —	UNDG. GAS LINE
	— — — UT —	UNDG. TELEPHONE LINE
	— — — UE –	UNDG. ELECTRIC LINE
	— — — OET -	- OVERHEAD ELE. & TEL
	— — — оетс	-OVERHEAD ELE TEL & CAB
	— — — OE –	OVERHEAD ELECTRIC
		vitrified clay pipe reinforced concrete pipe
RC PV		reinforced concrete pipe polyethylene coated pipe
	PE	high-density polyethylene pipe
		ductile iron pipe



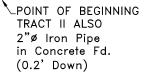

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- 12" RCP







PROVALS ARE OBTAINED FROM
N. ALL WORK SHALL BE DONE

3. PROVIDE BARRIERS OR OTHER PROTECTION TO KEEP VEHICULAR AND PEDESTRIAN TRAFFIC FROM CONSTRUCTION AREA.


9. EXCEPT FOR THOSE UTILITIES NOTED TO BE PLUGGED OR REMOVED, RECONNECT ALL LINES ENCOUNTERED DURING



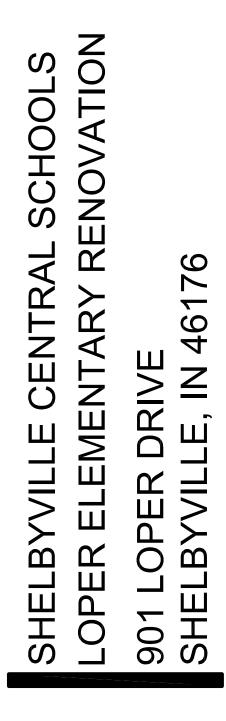

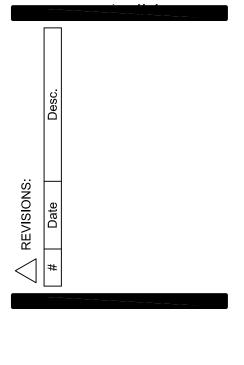




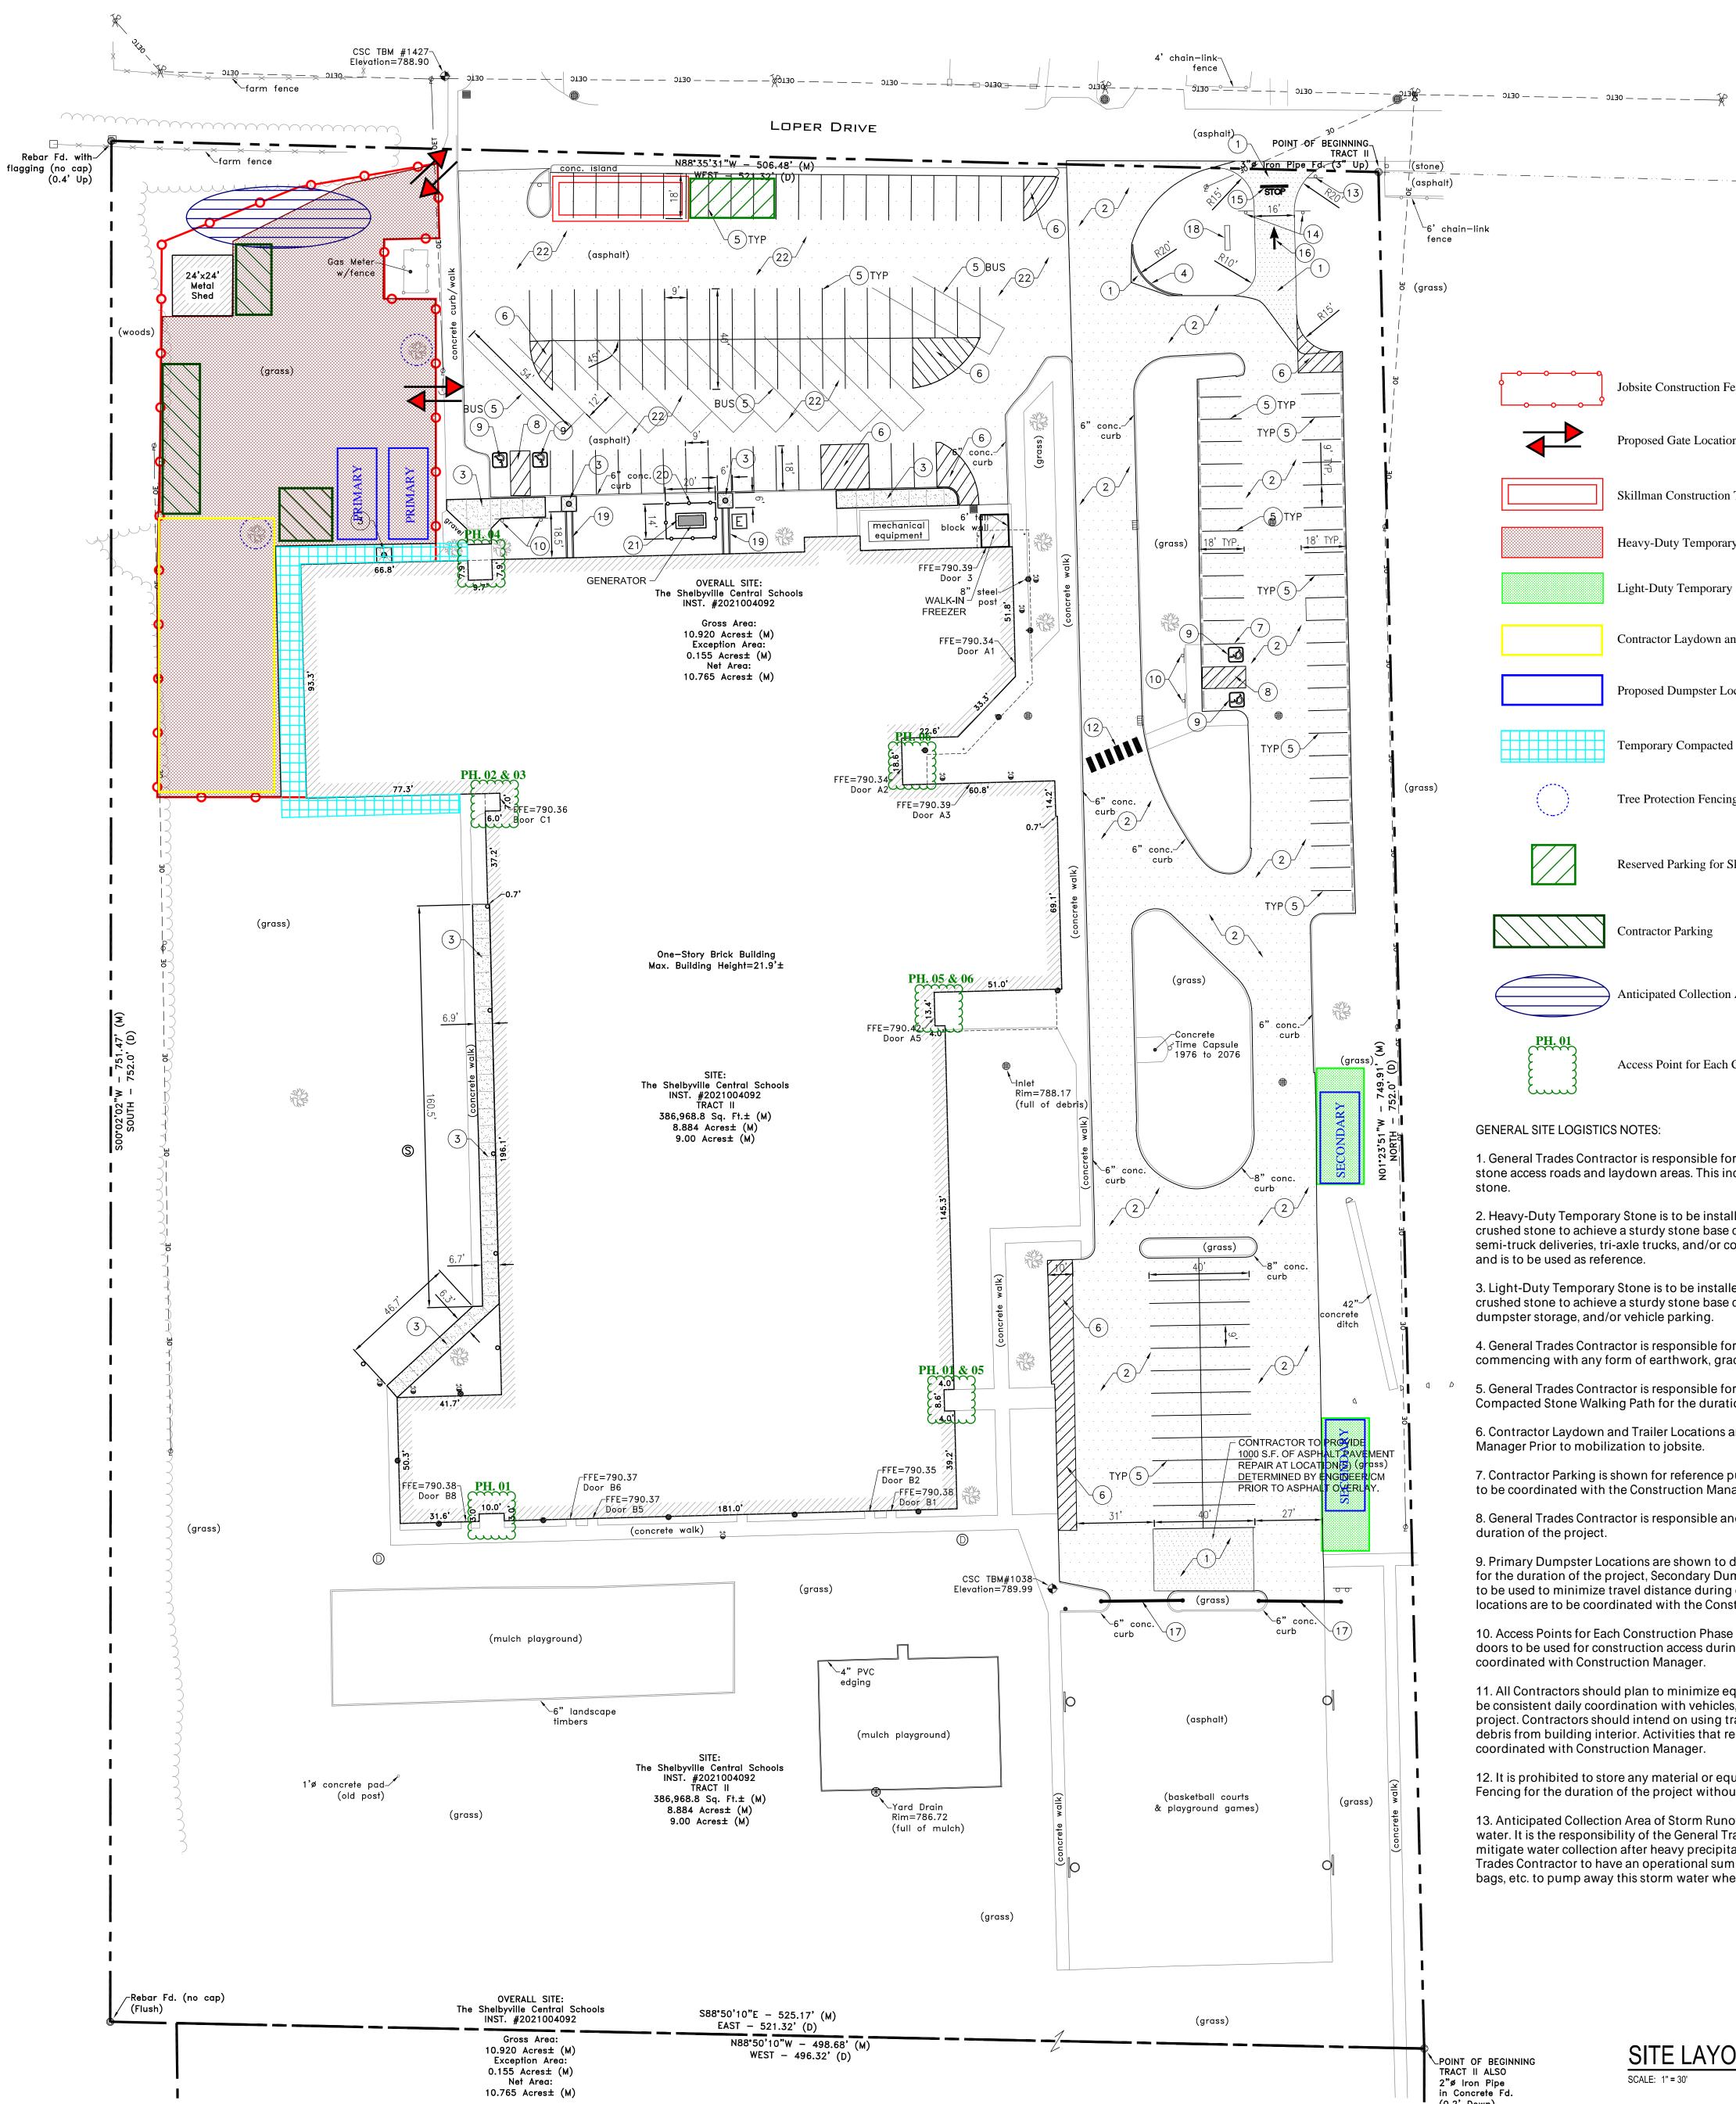

asphalt

[∟]6' chain−link fence

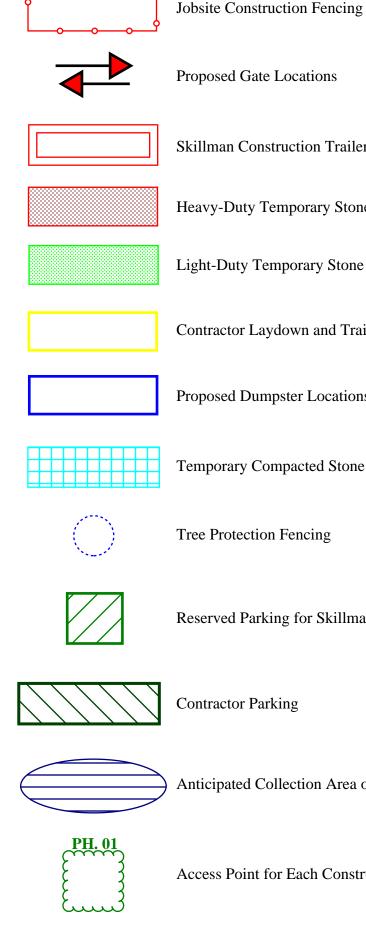

Skillman Construction Trailer Heavy-Duty Temporary Stone

Light-Duty Temporary Stone

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- 1. ALL DIMENSIONS IN CURBED AREAS ARE FACE TO FACE OF CURB. ALL DIMENSIONS IN AREAS WITHOUT CURB SHALL BE TO EDGE OF PAVEMENT.
- ALL EXISTING PAVEMENT SHALL BE SAW CUT TO A CLEAN EDGE WHERE NEW PAVEMENT IS TO BE INSTALLED ADJACENT TO EXISTING PAVEMENT.
- 3. THE CONTRACTOR SHALL VERIFY ALL DIMENSIONS IN FIELD BEFORE STARTING CONSTRUCTION. THE
- CONTRACTOR SHALL BE RESPONSIBLE FOR ALL FIELD DIMENSIONS. IF ANY DISCREPANCIES ARE FOUND IN THESE PLANS FROM ACTUAL FIELD CONDITION, THE CONTRACTOR SHALL CONTACT A/E IMMEDIATELY.
- 4. SEE DETAIL SHEETS FOR TYPICAL CONSTRUCTION DETAILS.
- ALL AREAS WHERE THE EXISTING PAVEMENT OR PAVEMENTS ARE DAMAGED DURING CONSTRUCTION FROM TRAFFIC BY THE GENERAL CONTRACTOR, SUBCONTRACTORS, OR SUPPLIERS SHALL BE RESURFACED OR RECONSTRUCTED AT LEAST TO THEIR ORIGINAL CONDITION AFTER CONSTRUCTION WORK IS COMPLETED.
- ALL RADII INDICATED SHALL BE FORMED AS CIRCULAR ARCS.
- ALL DIMENSIONS ARE PARALLEL AND PERPENDICULAR TO RIGHT-OF-WAY LINES OR PROPERTY LINES, UNLESS OTHERWISE NOTED.
- 9. DISABLED RAMPS SHALL BE IN ACCORDANCE WITH FEDERAL, STATE, COUNTY, CITY AND LOCAL CODES. SEE PLAN FOR LOCATION AND DETAIL SHEETS FOR SPECIFICATIONS.
- 10. SEE DETAIL SHEETS FOR TYPICAL PAVEMENT SECTIONS AND CURB DETAILS.
- 11. ENDS OF ALL CURBS SHALL BE CHAMFERED.
- 12. THE CONTRACTOR SHALL BE RESPONSIBLE TO PROVIDE AT HIS EXPENSE ALL AUTOMOBILE AND PEDESTRIAN TRAFFIC CONTROL DEVICES REQUIRED BY FEDERAL, STATE, COUNTY, CITY OR LOCAL AGENCY. THE AMOUNT, LOCATION AND SIZE SHALL BE PER DIRECTION OF AGENCY.
- 13. IT IS THE RESPONSIBILITY OF THE CONTRACTOR TO REMOVE ALL MUD, DIRT, GRAVEL, AND ANY OTHER MATERIALS TRACKED ONTO ANY PUBLIC OR PRIVATE STREETS OR SIDEWALKS. THE CONTRACTOR MUST CLEAN THESE DAILY IF NECESSARY. THE CONTRACTOR MUST USE WATER OR OTHER METHODS TO KEEP AIRBORNE DUST TO A REQUIRED MINIMUM.
- 14. ALL AREAS WHERE PROPOSED ASPHALT PAVEMENT MEETS THE EXISTING PAVEMENT THE EXISTING PAVEMENT EDGE SHALL BE PROPERLY SEALED WITH A TACK COAT MATERIAL.
- 15. ALL CURB RADIUS TO BE A MINIMUM OF 2'-0" UNLESS NOTED OTHERWISE.

SITE LEGEND

STANDARD DUTY ASPHALT = ASPHALT OVERLAY = BITUMINOUS SEAL COAT = CONCRETE SIDEWALK =

KEY NOTES

1) ASPHALT PAVEMENT (SEE DETAIL ON C801)

- 2) ASPHALT OVERLAY (SEE DETAIL ON C801)
- 3 4" CONCRETE SIDEWALK (SEE DETAIL ON C801)
- 4 6" CONCRETE CURB (SEE DETAIL ON C801) 5 4" PAINTED STRIPE, WHITE
- (6) 4" STRIPING, 45°, YELLOW, 3' O.C.
- (7) 4" PAINTED STRIPE, BLUE
- 8 4" STRIPING, 45°, BLUE, 3' O.C.
- (9) DISABLED PARKING SYMBOL, BLUE PAINTED (SEE DETAIL ON C801)
- 10) DISABLED PARKING SIGN (SEE DETAIL ON C801)
- 1) EXISTING CONCRETE WHEEL STOP
- (REMOVE AND REPLACE AFTER SEALING)) PEDESTRIAN CROSSING
- (SEE DETAIL ON C801)
- (13) STOP SIGN (SEE DETAIL ON C801)
- (14) ONE WAY NOT ENTER SIGN
- (15) PAINTED STOP BAR (SEE DETAIL ON C801)
- (16) PAINTED ARROW, WHITE (SEE DETAIL ON C801)

(17) NEW VEHICLE GATE (SEE DETAIL ON C801)


- (18) LED MONUMENT SIGN (SEE ELECTRICAL PLANS)
- (19) CONCRETE VALLEY CURB
- (SEE DETAIL ON C801)) GENERATOR ENCLOSURE
- (SEE ARCHITECTURAL PLANS) (21) 6" CONCRETE GENERATOR PAD
- (22) BITUMINOUS SEAL COAT










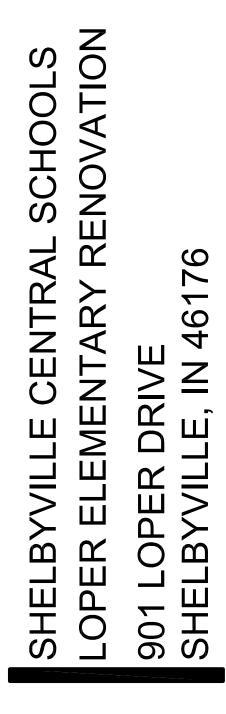

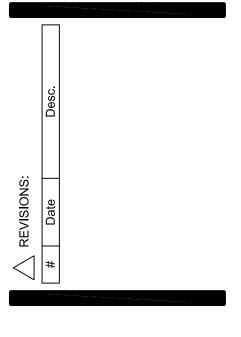



ivity Name	Original Duration	Start	Finish	2022 2023 M Apr M J Jul A S Oct N D Jan F M Apr M J Jul A S Oct N A N
Loper Elementary School Renovation	559	06-Jun-22	05-Aug-24	Loper Elementary School Renovation
Project Administration	559	06-Jun-22	05-Aug-24	Project Administration
Notice to Proceed	0	06-Jun-22*	r i	Notice to Proceed
Issuance of Contracts	30	06-Jun-22	18-Jul-22	Ssuance of Contracts
Critical Submittals w/ Extreme Lead Time	30	06-Jun-22	18-Jul-22	Critical Submittals w/ Extreme Lead Time
Pre-Construction Meeting	0	27-Jun-22*	r	Pre-Construction Meeting
Mobilization to Site	10	17-Oct-22*	28-Oct-22	Mobilization to Site
Start Construction	0	31-Oct-22*	r	Start Construction
Project Closeout Meeting	0	01-Apr-24*	r	♦ Pro
Project Closeout	85	01-Apr-24	26-Jul-24	
TAB Verification	15	08-Jul-24	26-Jul-24	
Final Certificate of Occupancy	0		26-Jul-24	
Final Completion	0		05-Aug-24	
Submittals and Material Procurement	150	06-Jun-22	09-Jan-23	Submittals and Material Procurement
HVAC Equipment Submission & Review	20	06-Jun-22	01-Jul-22	HVAC Equipment Submission & Review
General PD & SD Submittals	100	06-Jun-22	25-Oct-22	General PD & SD Submittals
General Samples & Color Selections	60	06-Jun-22	29-Aug-22	General Samples & Color Selections
Rooftop Equipment Submission & Review	20	06-Jun-22	01-Jul-22	Rooftop Equipment Submission & Review
HVAC Equipment Procurement	120	05-Jul-22	22-Dec-22	HVAC Equipment Procurement
Rooftop Equipment Procurement	130	05-Jul-22	09-Jan-23	Rooftop Equipment Procurement
General Material Procurement	75	30-Aug-22	15-Dec-22	General Material Procurement
Critical School Dates	518	03-Aug-22	05-Aug-24	Critical School Dates
Start Fall Semester 2022	0	03-Aug-22	*	Start Fall Semester 2022
Fall Break	6	14-Oct-22*	21-Oct-22	⊿ Fall Break
Phase 1	78	31-Oct-22	21-Feb-23	A Phase 1
Thanksgiving Break	1	23-Nov-22	* 23-Nov-22	Thanksgiving Break
Winter Break	10	16-Dec-22	* 30-Dec-22	🖾 Winter Break
Phase 2	78	22-Feb-23	09-Jun-23	✓ ✓ Phase 2
Spring Break	6	17-Mar-23	* 24-Mar-23	Image: Arrow Spring Break
End Spring Semester 2023	0		24-May-23*	 End Spring Semester 2023
Phase 6A - Classrooms & Offices	51	29-May-23	3 08-Aug-23	Phase 6A + Classrooms & Of
Phase 3	78	12-Jun-23	28-Sep-23	Phase 3
Phase 4	78	29-Sep-23	6 16-Jan-24	Phase 4
Phase 5	78	17-Jan-24	03-May-24	
Phase 6B - Gym, Cafeteria, Corridors & Mechani	51	27-May-24	05-Aug-24	┃

 Milestone ٠

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Sitework	203	17-Oct-22	02-Aug-23	M Apr M	J Jul A	S Oct N D	Jan F M Sitew		J Jul	A S Oct N	D Jan F	MAM	I J Jul A	S Oct	N D Jar	F M Ap	r M J J
Construction Fencing	200	17-Oct-22	18-Oct-22			Constr											
Erosion Control Measures	2	17-Oct-22	18-Oct-22	-		Z Erosio			lres								
Contractor Laydown Earthmoving	5	19-Oct-22	25-Oct-22	-		🖉 Contr				/ing							
Contractor Laydown Stone	5	26-Oct-22	01-Nov-22	-			ractor La	i i	i i i	U							
Power/Data for Skillman Trailer	5	02-Nov-22	08-Nov-22				/er/Data f		1 I I	ler							
Site Demolition & Sawcutting	10	24-May-23	06-Jun-23	_				4	Site D	emolition &	Sawcutti	ing					
Remove Parking Bumpers	5	24-May-23	30-May-23	-				4	Remo	ve Parking	Bumpers	•					
Asphalt Milling	10	31-May-23	13-Jun-23	-				1.1.1	1 1 1	alt Milling							
Concrete Sidewalks & Curbs	15	07-Jun-23	27-Jun-23	-						ncrete Side	walks & C	urbs					
Asphalt Patching & Repairs	5	07-Jun-23	13-Jun-23						🖉 Asph	alt Patching	a & Repai	rs					
Earthwork & Grading	5	07-Jun-23	13-Jun-23	-					i i i	work & Gr	i i i						
Asphalt Cleaning	5	14-Jun-23	20-Jun-23	-					🖉 Aspl	halt Cleanir	g						
Asphalt Stone & Binder	5	28-Jun-23	05-Jul-23	-					⊿ As	phalt Stone	& Binder						
Asphalt Surfacing	10	06-Jul-23	19-Jul-23	-						\sphalt Sur	acing						
Asphalt Seal Coating	5	20-Jul-23	26-Jul-23						i i i	Asphalt Se							
Site Furnishings & Signage	10	20-Jul-23	02-Aug-23	-					i i i	Site Furnis	i i i	i i i					
Asphalt Striping	5	20-Jul-23	26-Jul-23	-					1 1 1	Asphalt Str		•••					
Building Shell	60	03-Apr-23	23-Jun-23				Е	Building	1 1 1								
West Elevation Masonry Repairs	15	03-Apr-23*	21-Apr-23						i i	ation Maso	nry Repair	т S					
North Elevation Masonry Repairs	15	24-Apr-23	12-May-23					-i -i	1 1 1	evation Ma							
East Elevation Masonry Repairs	15	15-May-23	02-Jun-23	-				-i -i -	i i i	levation M							
South Elevation Masonry Repairs	15	05-Jun-23	23-Jun-23	-						th Elevatio							
Interior Renovations	456	31-Oct-22	05-Aug-24						Interio	r Renovatio	ins						
Phase 1	78	31-Oct-22	21-Feb-23			Pha	se 1										
Temporary Construction Barriers	1	31-Oct-22	31-Oct-22			Temp	orary Co	onstruc	ion Barri	ers							
Architectural Demolition	5	01-Nov-22	07-Nov-22	-		⊿⊽ Arch	nitectural	Demol	tion								
MEP Demolition & Temporary Service	10	01-Nov-22	14-Nov-22	-		∆⊽ ME	P Demol	ition &	Tempora	ry Service							
MEP Overhead Rough-Ins	15	15-Nov-22	07-Dec-22	-			IEP Ove	1 1									
MEP Wall Rough-Ins	10	01-Dec-22	14-Dec-22	-		ا 🕰	MEP Wa	ll Roug	h-Ins								
Wall Patching	10	01-Dec-22	14-Dec-22			۵ 🕰 ۱	Wall Pato	hing									
First Coat Paint	5	15-Dec-22	21-Dec-22	-		Δ	First Coa	at Pain									
Ceilings	10	15-Dec-22	29-Dec-22				⁷ Ceilings	5									
Lighting	10	22-Dec-22	06-Jan-23			Δ	✓ Lightin	g									
Casework	22-Dec-22	06-Jan-23			Δ	✓ Casew	/ork										
 Actual Work Remaining Work Critical Remaining Work Milestone 		Loper Elementary School Renovation Guideline Schedule 01-Jun-22 2 of 7									SKILL	MAN					

Activity Na	me	Original Duration	Start	Finish	2022									
				40.1.00	M Apr M J Jul A	S Oct N D Jan F A		A S Oct N D	Jan F M A M	J Jul A	S Oct N	I D Jan F	M Apr	M J Ju
		10	30-Dec-22	13-Jan-23			ring cialties, Wallcover	ringe 8 Mice Ed	nuinmont					
	Specialties, Wallcoverings & Misc. Equipment	5	09-Jan-23	13-Jan-23		⊿ Spec ⊿ Final		$r_{\rm H}$	laibilieur					
	Final Paint	5	09-Jan-23	13-Jan-23										
	Doors & Hardware	5	16-Jan-23	20-Jan-23			ors & Hardware							
	MEP Finishes & Trim Out	5	16-Jan-23	20-Jan-23	· - - -		P Finishes & Trin	n Qut					·	
	HVAC TAB	5	23-Jan-23	27-Jan-23			AC TAB							
	Partial Certificate of Occupancy	0		27-Jan-23			rtial Certificate of							
	HVAC TAB & Controls Complete	0		27-Jan-23			AC TAB & Contro							
	Substantial Completion	0		27-Jan-23			bstantial Complet	tion						
	Punchlist	10	30-Jan-23	10-Feb-23			Punchlist							
	Construction Complete	0		10-Feb-23			Construction Com	plete						
	Final Cleaning	5	13-Feb-23	17-Feb-23			-inal Cleaning							
	Owner Furnished FF&E/Technology	5	15-Feb-23	21-Feb-23		⊿ (Owner Furnished	FF&E/Technol	ogy					
	Phase 2	78	22-Feb-23	09-Jun-23			Phase 2							
	Temporary Construction Barriers	1	22-Feb-23	22-Feb-23		X -	Temporary Const	truction Barriers						
	Architectural Demolition	5	23-Feb-23	01-Mar-23		Ø	Architectural De	molition						
	MEP Demolition & Temporary Service	10	23-Feb-23	08-Mar-23			7 MEP Demolition	n & Temporary	Service					
	MEP Overhead Rough-Ins	15	09-Mar-23	29-Mar-23		Δ	🗢 MEP Overhe	ad Rough-Ins						
	MEP Wall Rough-Ins	10	23-Mar-23	05-Apr-23			MEP Wall R	ough-Ins						
	Wall Patching	10	23-Mar-23	05-Apr-23			△ Wall Patchin	g						
	First Coat Paint	5	06-Apr-23	12-Apr-23			🖉 First Coat P	Paint						
	Ceilings	10	06-Apr-23	19-Apr-23			🖾 Ceilings							
	Lighting	10	13-Apr-23	26-Apr-23			△ Lighting							
	Casework	10	13-Apr-23	26-Apr-23										
	Flooring	10	20-Apr-23	03-May-23			△ Flooring							
	Specialties, Wallcoverings & Misc. Equipment	5	27-Apr-23	03-May-23	·		🖉 Specialtie	s, Wallcovering	s & Misc. Equip	ment				
	Final Paint	5	27-Apr-23	03-May-23			🖉 Final Pair	nt						
	Doors & Hardware	5	04-May-23	10-May-23			⊿ Doors &	Hardware						
	MEP Finishes & Trim Out	5	04-May-23	10-May-23			🖉 MEP Fin	nishes & Trim O	ut					
	HVAC TAB	5	11-May-23	17-May-23			A HVAC T	ГАВ						
	Partial Certificate of Occupancy	0		17-May-23			Partial C	Certificate of Oc	cupancy					
-	HVAC TAB & Controls Complete	0		17-May-23				AB & Controls						
	Substantial Completion		17-May-23				ntial Completion							
	Punchlist	0	18-May-23	31-May-23			∆⊽ Punch							
	Construction Complete	0	10-10lay-20	31-May-23				ruction Complet	e					
				per Elementary Sch	hool Renovation	<u> </u>		1 1 1 1			1 1 1	<u> i i i</u>	1 1	
	✓ Actual Work ✓ Remaining Work		L	·					SKILLN					
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Name	Original Duration	Start	Finish	M Apr M	2022	ASON		lan F	2023 M Apr M J Jul A S Oct N D Jan F M A
Final Cleaning	5	01-Jun-23	07-Jun-23		JJUI	A 5 00		Jan F	
Owner Furnished FF&E/Technology	5	05-Jun-23							Owner Furnished FF&E/Technolog
Phase 3	78	12-Jun-23							Phase 3
Temporary Construction Barriers	1	12-Jun-23	· · · · · · · · · · · · · · · · · · ·						Temporary Construction Barriers
Architectural Demolition	5	13-Jun-23							Architectural Demolition
MEP Demolition & Temporary Service	10	13-Jun-23							MEP Demolition & Temporary Se
MEP Overhead Rough-Ins	15	27-Jun-23							MEP Overhead Rough-Ins
MEP Wall Rough-Ins	10	12-Jul-23	25-Jul-23						MEP Wall Rough-Ins
Wall Patching	10	12-Jul-23	25-Jul-23						🖾 Wall Patching
First Coat Paint	5	26-Jul-23	01-Aug-23						🖉 First Coat Paint
Ceilings	10	26-Jul-23							∠ Ceilings
Lighting	10	02-Aug-23							∠ Lighting
Casework	10	02-Aug-23							A Casework
Flooring	10	09-Aug-23							A Flooring
Specialties, Wallcoverings & Misc. Equipment	5	16-Aug-23	-						Specialties, Wallcoverings
Final Paint	5	16-Aug-23		· 1 1	+		 		🖉 Final Paint
Doors & Hardware	5	23-Aug-23	29-Aug-23						A Doors & Hardware
MEP Finishes & Trim Out	5	23-Aug-23	29-Aug-23						A MEP Finishes & Trim Out
HVAC TAB	5	30-Aug-23							A HVAC TAB
Partial Certificate of Occupancy	0		05-Sep-23						Partial Certificate of Occu
HVAC TAB & Controls Complete	0		05-Sep-23						HVAC TAB & Controls C
Substantial Completion	0		05-Sep-23						Substantial Completion
Punchlist	10	06-Sep-23	6 19-Sep-23						△ Punchlist
Construction Complete	0		19-Sep-23						 Construction Complete
Final Cleaning	5	20-Sep-23	26-Sep-23						AV Final Cleaning
Owner Furnished FF&E/Technology	5	22-Sep-23	28-Sep-23		· · · · · · · · · · · · · · · · · · ·				Ø Owner Furnished FF&
Phase 4	78	29-Sep-23	6 16-Jan-24						Phase 4
Temporary Construction Barriers	1	29-Sep-23	29-Sep-23						Temporary Construction
Architectural Demolition	5	02-Oct-23	06-Oct-23						🖉 Architectural Demoliti
MEP Demolition & Temporary Service	10	02-Oct-23	13-Oct-23						A MEP Demolition & To
MEP Overhead Rough-Ins	15	16-Oct-23	03-Nov-23				+		MEP Overhead R
MEP Wall Rough-Ins	10	30-Oct-23	10-Nov-23						A MEP Wall Rough
Wall Patching	10	30-Oct-23	10-Nov-23						A Wall Patching
First Coat Paint	5	13-Nov-23	6 17-Nov-23						🖉 First Coat Paint
Ceilings	10	13-Nov-23	24-Nov-23						Ceilings
Actual Work			La	per Eleme	entary S	School R	enovati	on	
Remaining Work				Guidelin	·				
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Critical Remaining Work

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Guideline Schedule 01-Jun-22

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Name	Original Duration	Start	Finish	MApr	202 M . I	 Oct N E) Jan E	MApr	2023 M J Julu	AS		Jan F M A	
Lighting	10	20-Nov-23	01-Dec-23		J			w Apr	u J Ju			Lighting	4
Casework	10	20-Nov-23	01-Dec-23									Casework	
Flooring	10	27-Nov-23	08-Dec-23									Flooring	
Specialties, Wallcoverings & Misc. Equipment	5	04-Dec-23	08-Dec-23									Specialties, V	V
Final Paint	5	04-Dec-23	08-Dec-23									Final Paint	
Doors & Hardware	5	11-Dec-23	15-Dec-23			 				· -	Δ	7 Doors & Har	Ċ
MEP Finishes & Trim Out	5	11-Dec-23	15-Dec-23								Δ	MEP Finishe	×
HVAC TAB	5	18-Dec-23	22-Dec-23								2	HVAC TAB	
Partial Certificate of Occupancy	0		22-Dec-23								•	Partial Cert	if
HVAC TAB & Controls Complete	0		22-Dec-23									HVAC TAB	ξ
Substantial Completion	0		22-Dec-23			 				· -		 Substantial 	Ċ
Punchlist	10	25-Dec-23	05-Jan-24									AV Punchlist	
Construction Complete	0		05-Jan-24									Constructi	d
Final Cleaning	5	08-Jan-24	12-Jan-24									Final Clear	a
Owner Furnished FF&E/Technology	5	10-Jan-24	16-Jan-24									A Owner F	ų
Phase 5	78	17-Jan-24	03-May-24			 				· -		Phase 5	
Temporary Construction Barriers	1	17-Jan-24	17-Jan-24									Tempora	r
Architectural Demolition	5	18-Jan-24	24-Jan-24									Archited	t
MEP Demolition & Temporary Service	10	18-Jan-24	31-Jan-24									🖾 MEP D	¢
MEP Overhead Rough-Ins	15	01-Feb-24	21-Feb-24									🟧 MEP	
MEP Wall Rough-Ins	10	15-Feb-24	28-Feb-24			 						🖾 Wer	כ
Wall Patching	10	15-Feb-24	28-Feb-24									∆⊽ Wall	1
First Coat Paint	5	29-Feb-24	06-Mar-24									⊿ Firs	st
Ceilings	10	29-Feb-24	13-Mar-24									∆⊽ Ce	;i
Lighting	10	07-Mar-24	20-Mar-24									∆⊽ Li	g
Casework	10	07-Mar-24	20-Mar-24			 <u>-</u> <u>+</u>						V C	ą
Flooring	10	14-Mar-24	27-Mar-24									AV F	ķ
Specialties, Wallcoverings & Misc. Equipment	5	21-Mar-24	27-Mar-24									⊿ S	ŗ
Final Paint	5	21-Mar-24	27-Mar-24									⊿7 F	iţ
Doors & Hardware	5	28-Mar-24	03-Apr-24									A [כ
MEP Finishes & Trim Out	5	28-Mar-24	03-Apr-24			 						ן 🗖	V
HVAC TAB	5	04-Apr-24	10-Apr-24										ŀ
Partial Certificate of Occupancy	0		10-Apr-24									•	Ē
HVAC TAB & Controls Complete	0		10-Apr-24									•	ŀ
Substantial Completion	0		10-Apr-24									•	Ċ

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Guideline Schedule 01-Jun-22

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Punchlist	10	11-Apr-24	24-Apr-24								
Construction Complete	0		24-Apr-24								(
Final Cleaning	5	25-Apr-24	01-May-24								
Owner Furnished FF&E/Technology	5	29-Apr-24	03-May-24								
Phase 6	310	29-May-23	05-Aug-24						Phase	e6	
6A - Clasrooms and Office Spaces	51	29-May-23	08-Aug-23	······································	6A - Clasro	oms ar	nd Offic	ce Spac	es		
Temporary Construction Barriers	1	29-May-23*	29-May-23			🛛 Te	mpora	ry Cons	struction	n Barrie	ers
Architectural Demolition	5	30-May-23	05-Jun-23			Δ Α	rchited	tural De	emolitio	n	
MEP Demolition	15	30-May-23	19-Jun-23				MĖP [Demoliti	on		
MEP Overhead Rough-Ins	20	06-Jun-23	03-Jul-23				7 MEF	Overhe	ead Rou	ugh-Ins	5
MEP Wall Rough-Ins	10	20-Jun-23	03-Jul-23		·		7 MEF	Wall R	ough-In	IS	
Wall Patching	10	20-Jun-23	03-Jul-23				7 Wall	Patchin	g		
First Coat Paint	5	05-Jul-23	11-Jul-23			2	🗸 Firs	t Coat P	Paint		
Ceilings	10	05-Jul-23	18-Jul-23			4	🔽 Ce	lings			
Lighting	10	12-Jul-23	25-Jul-23				∆⊽ Lig	phting			
Casework	10	12-Jul-23	25-Jul-23		· 	+	∆V Ca	asework			· - -
Specialties, Wallcoverings & Misc. Equipment	5	19-Jul-23	25-Jul-23				AV Sp	ecialties	s, Wallo	overing	js&N
Flooring	10	19-Jul-23	01-Aug-23				△ F	ooring			
Final Paint	5	19-Jul-23	25-Jul-23				⊿ Fir	nal Pain	t		
MEP Finishes & Trim Out	5	19-Jul-23	25-Jul-23				⊿ MI	EP Finis	shes & T	Γrim Οι	ut
Final Cleaning	5	26-Jul-23	01-Aug-23		•	+	AV F	inal Clea	aning		· - 1 1 -
Owner Furnished FF&E/Technology	5	02-Aug-23	08-Aug-23				A (Dwner F	urnishe	d FF&E	E/Tech
6B - Gym, Cafeteria, Corridors & Mechanical	51	27-May-24	05-Aug-24						6B - C	Gym, C	afeter
Temporary Construction Barriers	1	27-May-24*	27-May-24								
Architectural Demolition	5	28-May-24	03-Jun-24								
MEP Demolition	10	28-May-24	10-Jun-24		· 	+					· - -
MEP Overhead Rough-Ins	15	04-Jun-24	24-Jun-24								
Flooring	20	04-Jun-24	01-Jul-24								
Ceilings	15	11-Jun-24	01-Jul-24								
MEP Wall Rough-Ins	10	18-Jun-24	01-Jul-24								
Wall Patching	5	18-Jun-24	24-Jun-24		· · · · · · · · · · · · · · · · · · · 	+			·		$-\frac{1}{1}\frac{1}{1}-$
Lighting	15	18-Jun-24	08-Jul-24								
Final Paint	10	18-Jun-24	01-Jul-24								
MEP Finishes & Trim Out	5	18-Jun-24	24-Jun-24								
First Coat Paint	10	25-Jun-24	08-Jul-24								

Remaining WorkCritical Remaining Work

Milestone

Guideline Schedule 01-Jun-22

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	Specialties, Wallcoverings & Misc. Equipment	5	25-Jun-24	01-Jul-24					1														A S	peciali	ies, N	/allco\	ering	s & Mi	sc. Ec	Juipm
	HVAC TAB	5	25-Jun-24	01-Jul-24																			🛉 F	VACI	AB					
	Partial Certificate of Occupancy	0		01-Jul-24																			• F	artial (Certific	ate o	Occi	ipancy	/	
	HVAC TAB & Controls Complete	0		01-Jul-24																			♦ F	VACI	AB &	Conti	ols Co	omple	te	
	Substantial Completion	0		01-Jul-24																			• 5	ubstar	tial Co	omple	tion			
	Punchlist	10	02-Jul-24	15-Jul-24																				Punch	list				+	÷
	Construction Complete	0		15-Jul-24																			•	Const	uctior	Com	plete			
	Final Cleaning	10	16-Jul-24	29-Jul-24																				7 Fina	Clear	ning				
	Owner Furnished FF&E/Technology	5	30-Jul-24	05-Aug-24*																				V Ow	her Fu	rnishe	d FF	&E/Te	chnolc	ygy

Actual Work

Summary

△ ____ Remaining Work

Critical Remaining Work

Milestone

Loper Elementary School Renovation

Guideline Schedule 01-Jun-22

7 of 7



LANCER + BEEBE, LLC Project # 21140

ADDENDUM NO. ONE

PROJECT: Shelbyville Central Schools – 2022 Loper Elementary Renovation

PROJECT NUMBER: 21140

DATE OF ADDENDUM: April 20, 2022



THIS ADDENDUM FORMS A PART OF THE CONTRACT DOCUMENTS AND IS ISSUED IN ACCORDANCE WITH THE INSTRUCTIONS TO BIDDERS. ACKNOWLEDGE RECEIPT OF THIS ADDENDUM BY SIGNING THE ADDENDUM ACKNOWLEDGMENT SECTION OF THE BID FORM.

SPECIFICATIONS:

1. Spec Section: 12 32 16 Spec Title: PLASTIC LAMINATE CASEWORK

Change:

PART 2 - PRODUCTS

2.1 MANUFACTURERS F. Advanced Cabinet Systems

DRAWINGS:

- Drawing Sheet Number: C201 Drawing Sheet Title: Site Layout Plan Change:
 - Site Layout General Notes: Delete blank note 6 and renumber notes.
- Drawing Sheet Number: C301 Drawing Sheet Title: Grading & Drainage Plan Change:
 - Grading General Notes: Add note 8.
- Drawing Sheet Number: A011
 Drawings Sheet Title: Floor Plan First Floor Overall Change:
 - Fix typo of "Bull-nose" in General Note 2
 - Change General Note 6 to include janitor closets
- Drawing Sheet Number: A101A Drawings Sheet Title: Floor Plan – First Floor – Unit A Change:
 - Fix typo of "Bull-nose" in General Note 2
 - Change General Note 6 to include janitor closets
 - Add "Confirm final install height and placement with owner" to Keynote 27
 - Add Keynote 31: Install two rows of tack strips. Top tack strip shall be at 5'-0" AFF, and spaced 1'-8" O.C.
 - Add/adjust keynote 27 on the plan
 - Add keynote 31 with dimensions of tacks trips on plan
 - Relocation of circulation desk in room G18
 - Clarify locations of keynote 5 in room C26.2

- Add Keynote 32: New wall mural / vinyl wall decal at full height of available wall
- New doors G15.1 and G1.1
- Casework elevation reference in G38 changed from 16/A763
 to 17/A763
- Drawing Sheet Number: A101B Drawings Sheet Title: Floor Plan – First Floor – Unit B Change:
 - Fix typo of "Bull-nose" in General Note 2
 - Change General Note 6 to include janitor closets
 - Add "Confirm final install height and placement with owner" to Keynote 27
 - Add Keynote 31: Install two rows of tack strips. Top tack strip shall be at 5'-0" AFF, and spaced 1'-8" O.C.
 - Add/adjust keynote 27 on the plan
 - Add keynote 31 with dimensions of tacks trips on plan
- Drawing Sheet Number: A101C Drawings Sheet Title: Floor Plan – First Floor – Unit C Change:
 - Fix typo of "Bull-nose" in General Note 2
 - Change General Note 6 to include janitor closets
 - Add "Confirm final install height and placement with owner" to Keynote 27
 - Add Keynote 31: Install two rows of tack strips. Top tack strip shall be at 5'-0" AFF, and spaced 1'-8" O.C.
 - Add/adjust keynote 27 on the plan
 - Add keynote 31 with dimensions of tacks trips on plan

- 7. Drawing Sheet Number: A112 Drawings Sheet Title: Enlarged Plans Change:
 - New Enlarged Media Center Plan
- Drawing Sheet Number: A121A Drawings Sheet Title: Reflected Ceiling Plan – First Floor – Unit A Change:
 - Add General Note 2: 2-hour fire rated gypsum board ceiling construction.
 - Add Note 4 to Cafeteria G39 Bulkhead: Existing bulkhead to remain. Paint PT-1. Ref Finish Legend.
- 9. Drawing Sheet Number: A141 Drawings Sheet Title: Roof Plan Change:
 - Remove sheet
- 10. Drawing Sheet Number: A601 Drawings Sheet Title: Door Schedule Change:
 - Add doors G1.1 and G15.1
- 11. Drawing Sheet Number: A720Drawings Sheet Title: Interior Finish Legend Change:
 - Add RS-1, RSB-1, AP-4 (PL-3??)
- Drawing Sheet Number: A721A Drawings Sheet Title: Interior Finish Plan – First Floor – Unit A Change:
 - Change Flooring material to RS-1 and Wall Base material to RSB-1 in the following rooms: G31, G32, G33, G34, G35, G36, and G37


- Update flooring pattern install in Media Center G18
- Casework elevation reference in G38 will now show 7/A763
- 13. Drawing Sheet Number: A751 Drawings Sheet Title: Interior Elevations Change:
 - Add keynote 10: Acoustical Panels (AP-4). Ref finish Legend.
 - Change all keynotes on 1/A751 to keynote 10
- 14. Drawing Sheet Number: A762 Drawings Sheet Title: Casework Elevations Change:
 - Casework Typ. Section referenced in 13/A762 changed to 7/A766
- 15. Drawing Sheet Number: A763 Drawings Sheet Title: Casework Elevations Change:
 - Casework Elevation 16/A763 changed to 17/A763
 - Update elevations for new circulation desk
 - Add keynote 11, 12, and 13 to clarify finishes at new circulation desk
 - Casework Typ. Section referenced in 4,6,710,11/A763, changed from 4/A766 to 7/A766
- 16. Drawing Sheet Number: A764 Drawings Sheet Title: Casework Elevations - Alternates Change:
 - Casework Typ. Section referenced in 7/A764, changed from 4/A766 to 7/A766
- 17. Drawing Sheet Number: A766 Drawings Sheet Title: Casework Details Change:

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- Update sections for new circulation desk.
- Detail Section 4/A766 changed to 7/A766.
- 18. Drawing Sheet Number: P-101B Drawings Sheet Title: FIRST FLOOR PLUMBING PLAN – UNIT B Change:
 - UPDATED PLAN NOTE 5
- 19. Drawing Sheet Number: PD101B Drawings Sheet Title: FIRST FLOOR PLUMBING DEMO PLAN – UNIT B Change:
 - UPDATED PLAN NOTE 16

Attachments:

END OF ADDENDUM NO. ONE

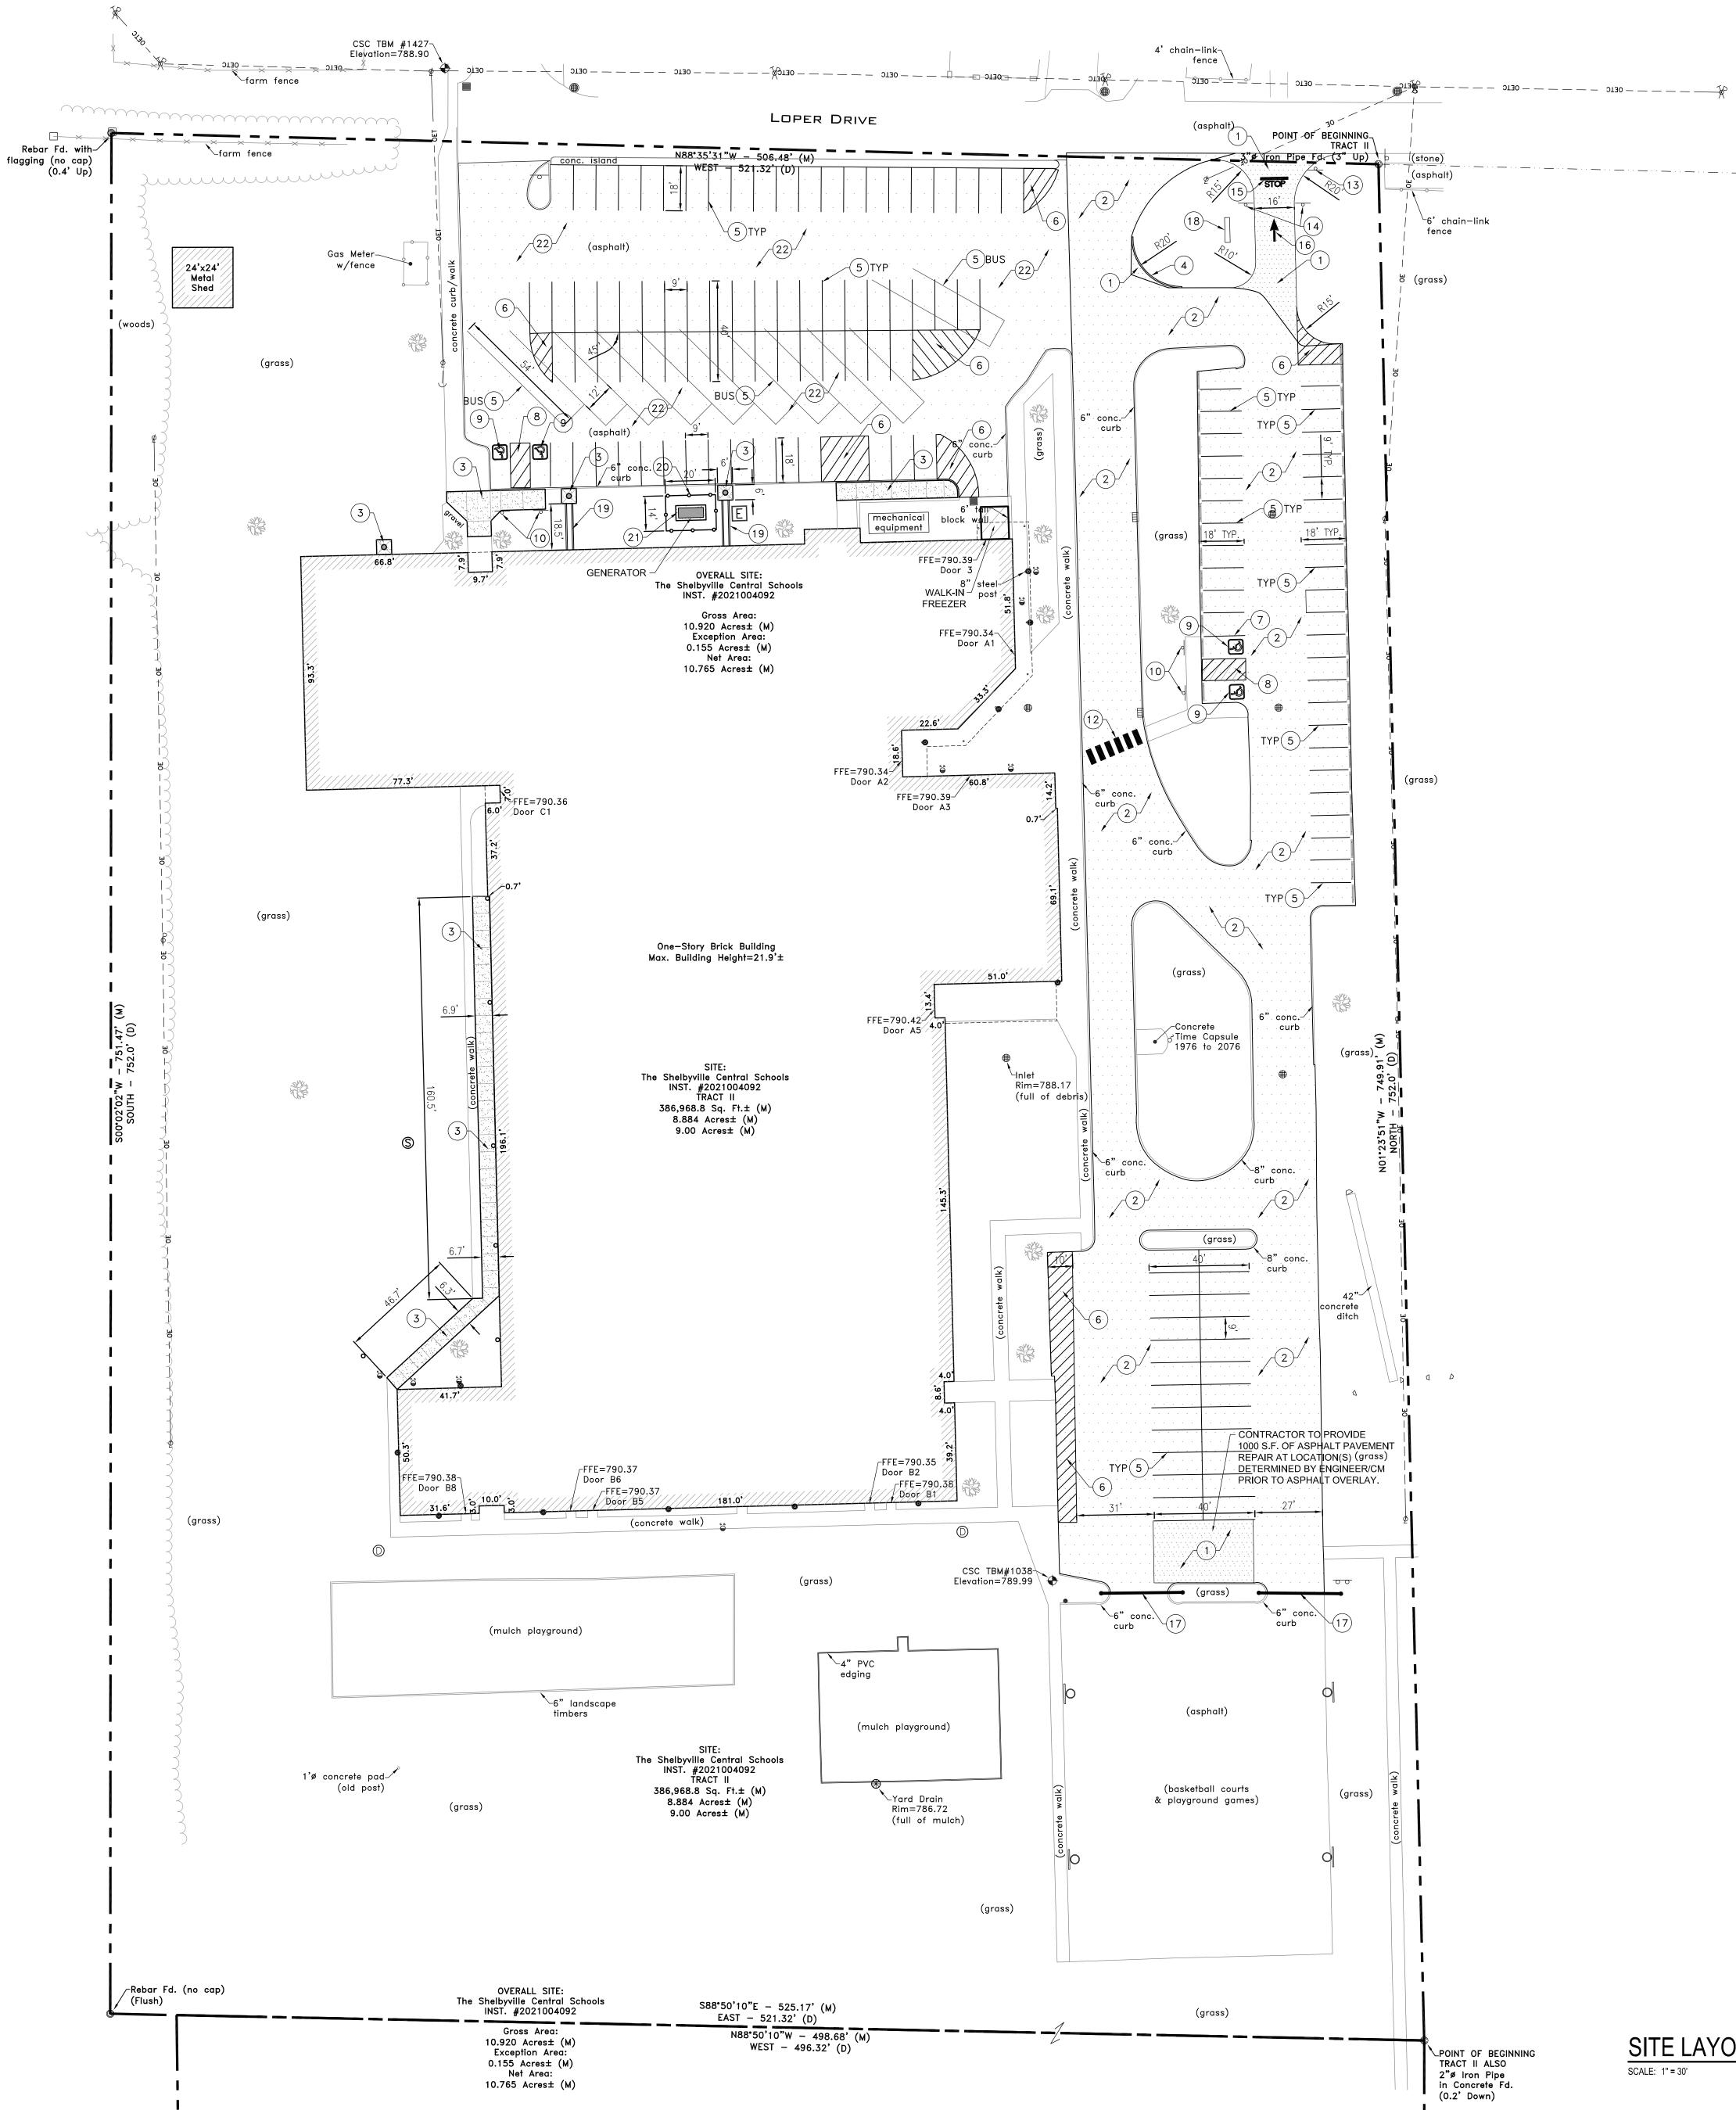

SITE LAYOUT GENERAL NOTES

1. ALL DIMENSIONS IN CURBED AREAS ARE FACE TO FACE OF CURB. ALL DIMENSIONS IN AREAS WITHOUT CURB SHALL BE TO EDGE OF PAVEMENT. 2. ALL EXISTING PAVEMENT SHALL BE SAW CUT TO A CLEAN EDGE WHERE NEW PAVEMENT IS TO BE INSTALLED ADJACENT TO EXISTING PAVEMENT. 3. THE CONTRACTOR SHALL VERIFY ALL DIMENSIONS IN FIELD BEFORE STARTING CONSTRUCTION. THE CONTRACTOR SHALL BE RESPONSIBLE FOR ALL FIELD DIMENSIONS. IF ANY DISCREPANCIES ARE FOUND IN THESE PLANS FROM ACTUAL FIELD CONDITION, THE CONTRACTOR SHALL CONTACT A/E IMMEDIATELY. 4. SEE DETAIL SHEETS FOR TYPICAL CONSTRUCTION DETAILS. ALL AREAS WHERE THE EXISTING PAVEMENT OR PAVEMENTS ARE DAMAGED DURING CONSTRUCTION FROM TRAFFIC BY THE GENERAL CONTRACTOR, SUBCONTRACTORS, OR SUPPLIERS SHALL BE RESURFACED OR RECONSTRUCTED AT LEAST TO THEIR ORIGINAL CONDITION AFTER CONSTRUCTION WORK IS COMPLETED. \sim ALL RADII INDICATED SHALL BE FORMED AS CIRCULAR ARCS. ALL DIMENSIONS ARE PARALLEL AND PERPENDICULAR TO RIGHT-OF-WAY LINES OR PROPERTY LINES, UNLESS OTHERWISE NOTED. DISABLED RAMPS SHALL BE IN ACCORDANCE WITH FEDERAL, STATE, COUNTY, CITY AND LOCAL CODES. SEE PLAN FOR LOCATION AND DETAIL SHEETS FOR SPECIFICATIONS. 9. SEE DETAIL SHEETS FOR TYPICAL PAVEMENT SECTIONS AND CURB DETAILS. 10. ENDS OF ALL CURBS SHALL BE CHAMFERED. 11. THE CONTRACTOR SHALL BE RESPONSIBLE TO PROVIDE AT HIS EXPENSE ALL AUTOMOBILE AND PEDESTRIAN TRAFFIC CONTROL DEVICES REQUIRED BY FEDERAL, STATE, COUNTY, CITY OR LOCAL AGENCY. THE AMOUNT, LOCATION AND SIZE SHALL BE PER DIRECTION OF AGENCY. 12. IT IS THE RESPONSIBILITY OF THE CONTRACTOR TO REMOVE ALL MUD, DIRT, GRAVEL, AND ANY OTHER MATERIALS TRACKED ONTO ANY PUBLIC OR PRIVATE STREETS OR SIDEWALKS. THE CONTRACTOR MUST CLEAN THESE DAILY IF NECESSARY. THE CONTRACTOR MUST USE WATER OR OTHER METHODS TO KEEP \langle AIRBORNE DUST TO A REQUIRED MINIMUM. 13. ALL AREAS WHERE PROPOSED ASPHALT PAVEMENT MEETS THE EXISTING PAVEMENT THE EXISTING PAVEMENT EDGE SHALL BE PROPERLY SEALED WITH A TACK COAT MATERIAL.

14. ALL CURB RADIUS TO BE A MINIMUM OF 2'-0" UNLESS NOTED OTHERWISE.

SITE LEGEND

STANDARD DUTY ASPHALT =	· · · · · · · · ·
ASPHALT OVERLAY =	
BITUMINOUS SEAL COAT =	

CONCRETE SIDEWALK =

KEY NOTES

1 ASPHALT PAVEMENT (SEE DETAIL ON C801)

2 ASPHALT OVERLAY (SEE DETAIL ON C801)

3 4" CONCRETE SIDEWALK (SEE DETAIL ON C801)


- (4) 6" CONCRETE CURB (SEE DETAIL ON C801)
- 5 4" PAINTED STRIPE, WHITE
- 6 4" STRIPING, 45°, YELLOW, 3' O.C.
- 7 4" PAINTED STRIPE, BLUE
- 8 4" STRIPING, 45°, BLUE, 3' O.C.
- (9) DISABLED PARKING SYMBOL, BLUE PAINTED (SEE DETAIL ON C801)
- 10 DISABLED PARKING SIGN (SEE DETAIL ON C801)
- (1) EXISTING CONCRETE WHEEL STOP (REMOVE AND REPLACE AFTER SEALING)
- 12 PEDESTRIAN CROSSING (SEE DETAIL ON C801)
- (13) STOP SIGN (SEE DETAIL ON C801)
- (14) ONE WAY NOT ENTER SIGN
- (15) PAINTED STOP BAR (SEE DETAIL ON C801)
- (16) PAINTED ARROW, WHITE (SEE DETAIL ON C801)


17 NEW VEHICLE GATE (SEE DETAIL ON C801)


- (18) LED MONUMENT SIGN (SEE ELECTRICAL PLANS)
- (19) CONCRETE VALLEY CURB (SEE DETAIL ON C801)
- 20) GENERATOR ENCLOSURE (SEE ARCHITECTURAL PLANS)
- (21) 6" CONCRETE GENERATOR PAD

22) BITUMINOUS SEAL COAT



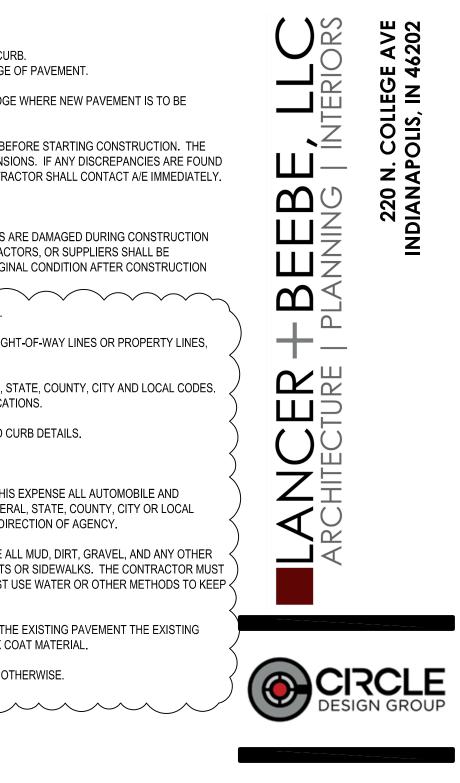

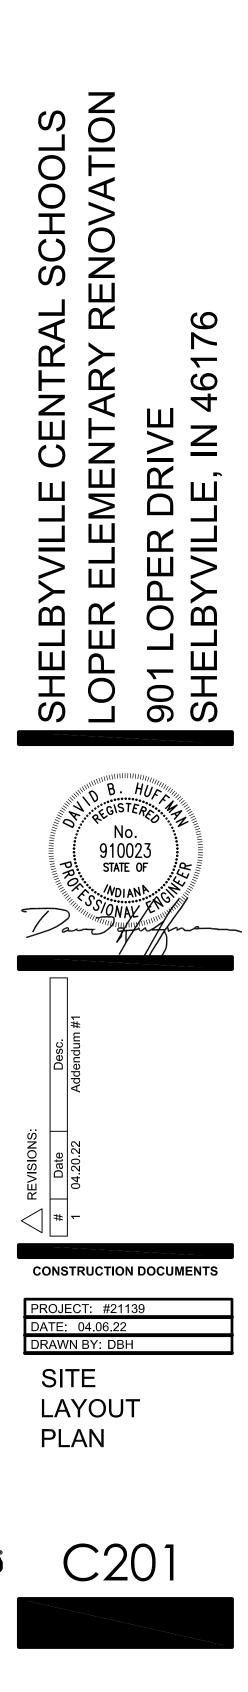

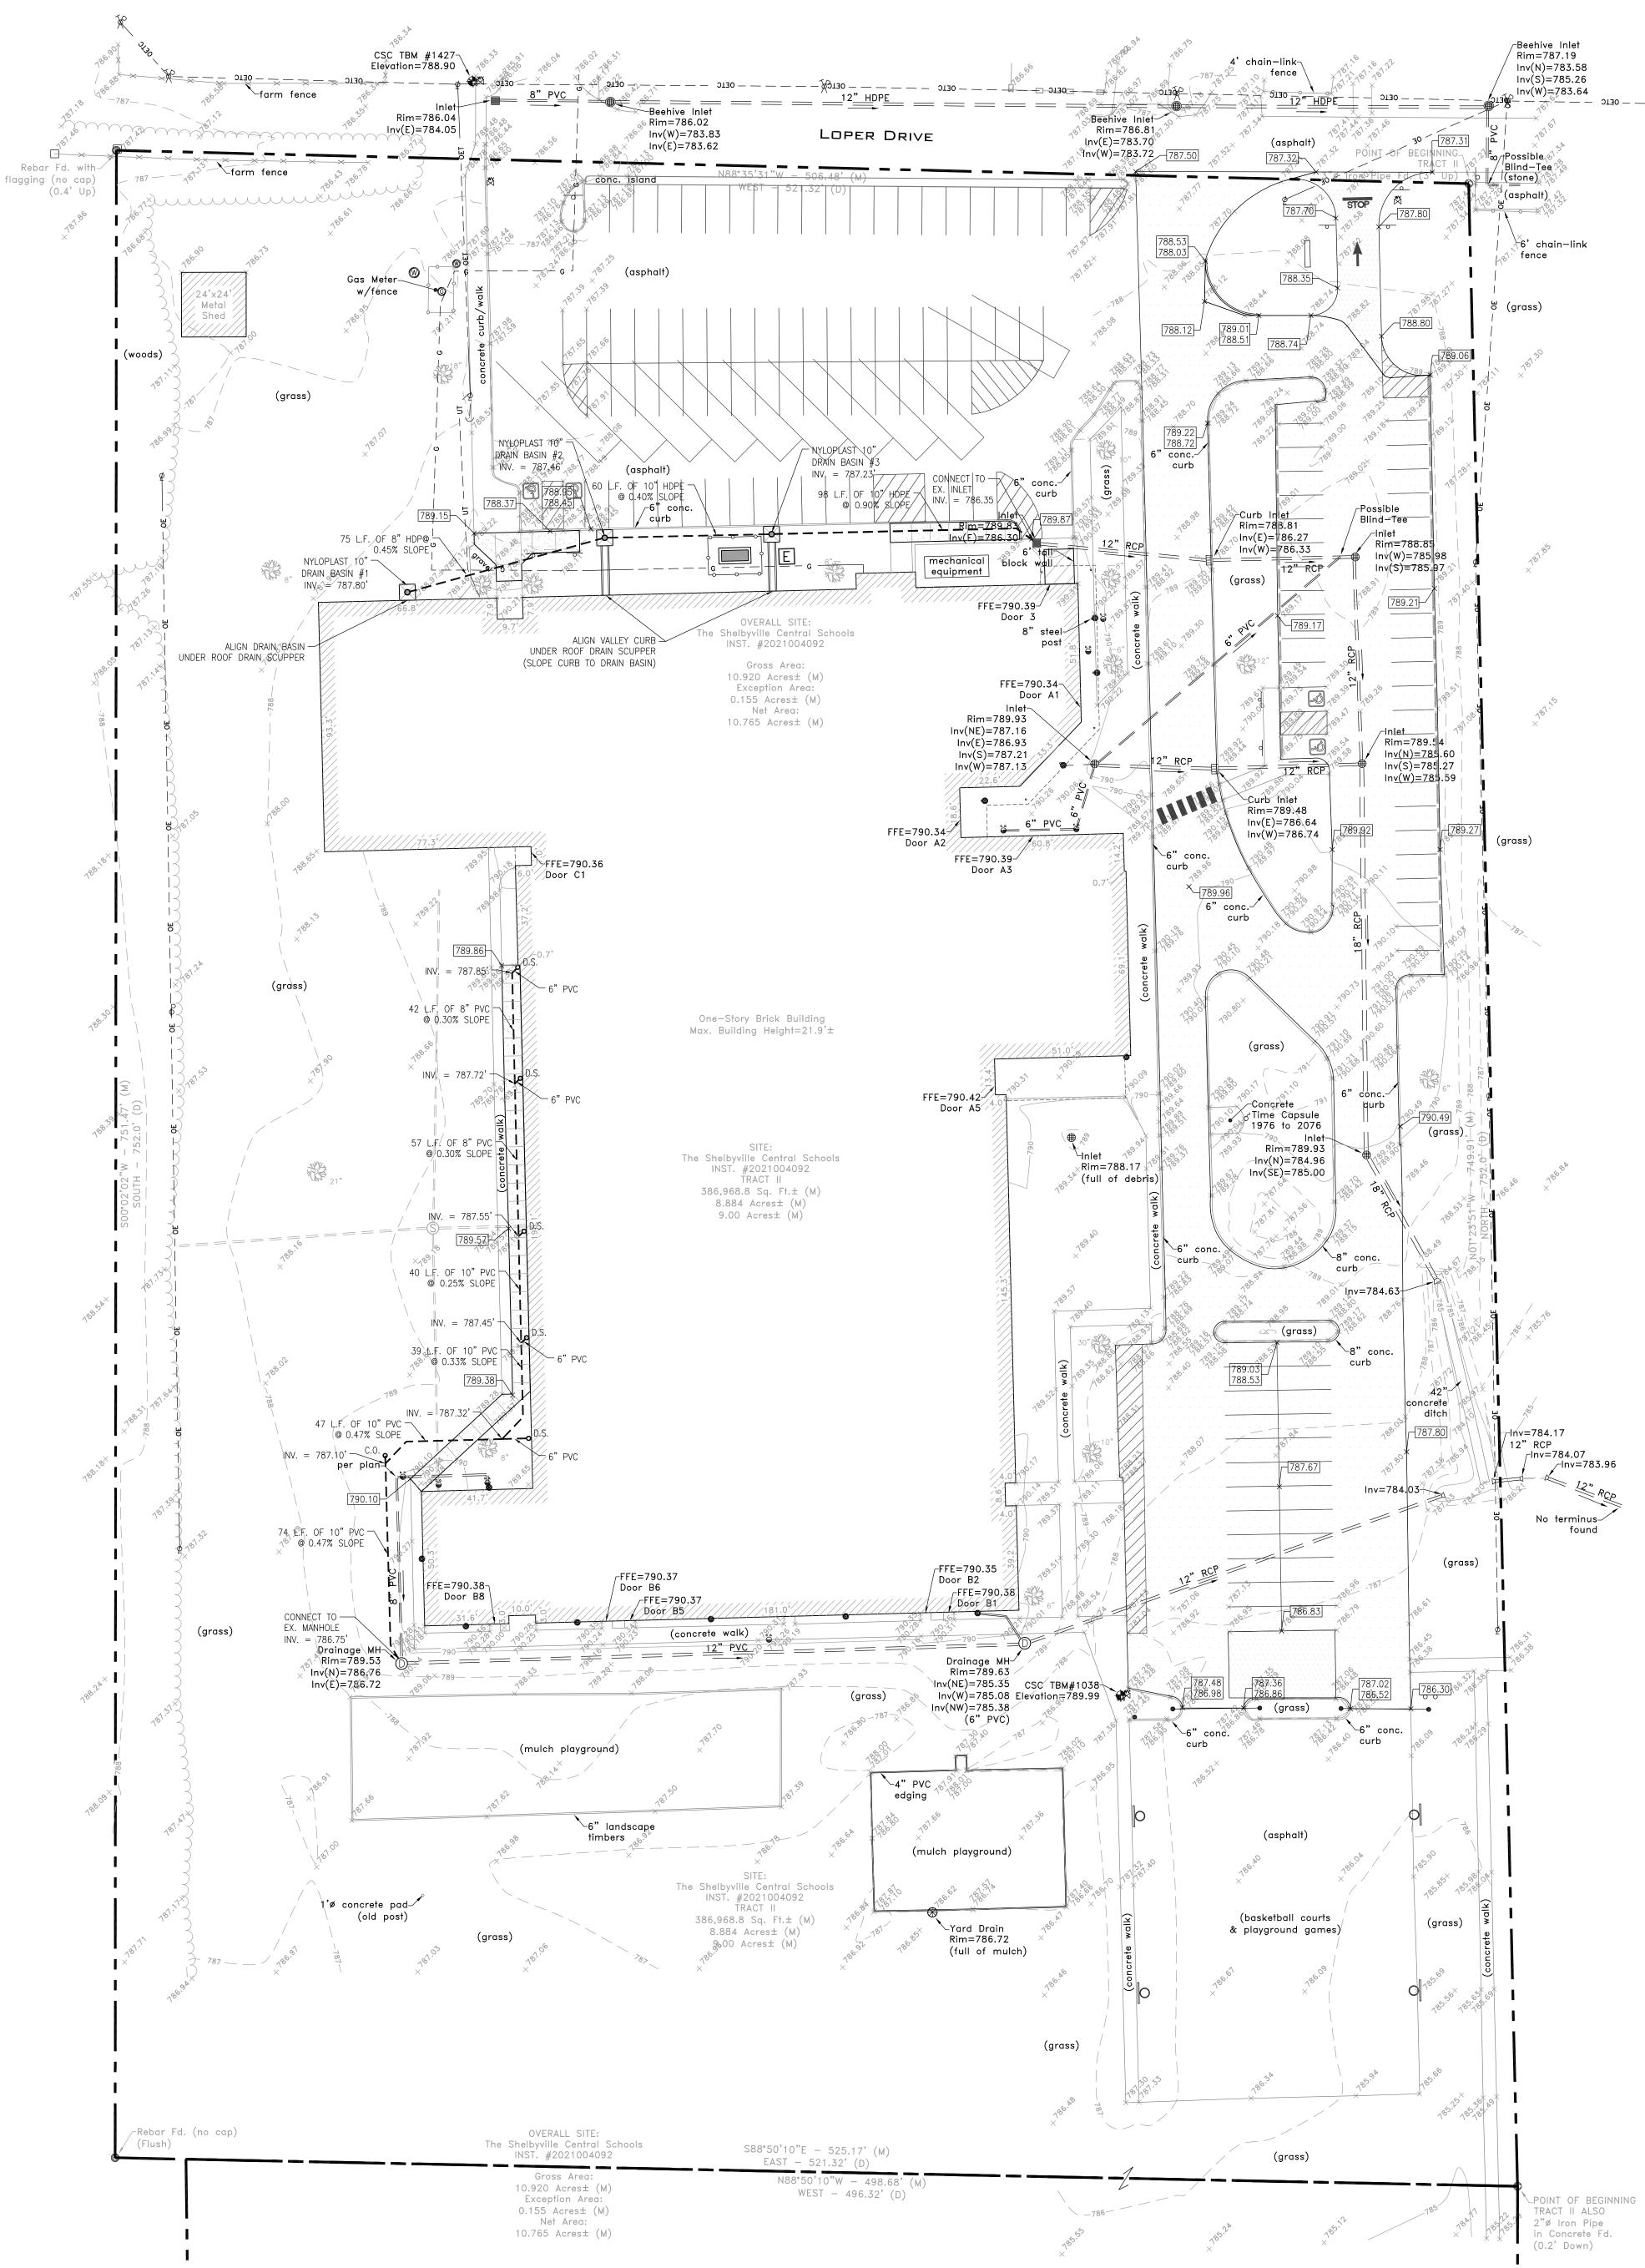

Beehive Inlet Rim=787.19 Inv(N)=783.58 Inv(S)=785.26 _Inv(W)=783.64

∑6' chain−link fence

nv=784.17 *∟*lnv=784.07 ∕-Inv=783.96 12" RCP No terminus-⁄

found

(0.2' Down)

GRADING & DRAINAGE PLAN SCALE: 1" = 30'

GRADING GENERAL NOTES

- 1. PROVIDE POSITIVE DRAINAGE IN ALL AREAS. PAVING CONTRACTOR SHALL TEST FOR ANY PONDING CONDITIONS AFTER INSTALLATION AND CORRECT.
- 2. PROVIDE SMOOTH TRANSITION FROM NEW AREAS TO EXISTING FEATURES AS NECESSARY.
- 3. ALL AREAS WHERE PROPOSED ASPHALT PAVEMENT MEETS THE EXISTING PAVEMENT THE EXISTING PAVEMENT EDGE SHALL BE PROPERLY SEALED WITH A TACK COAT MATERIAL.
- 4. THE EXCAVATING CONTRACTOR MUST TAKE PARTICULAR CARE WHILE EXCAVATING AROUND EXISTING TREES SO NOT TO DISTURB AND TO MINIMIZE OR ELIMINATE DAMAGE TO ROOT SYSTEM.
- THE EXCAVATING CONTRACTOR MUST TAKE PARTICULAR CARE WHEN EXCAVATING IN AND AROUND EXISTING UTILITY LINES AND EQUIPMENT. VERIFY COVER REQUIREMENTS BY UTILITY CONTRACTORS AND/OR UTILITY COMPANIES SO NOT TO CAUSE DAMAGE.
- 6. THE EXCAVATING CONTRACTOR OR LANDSCAPING CONTRACTOR SHALL INSTALL THE FINISH GRADE AT 1/2" BELOW PAVEMENTS WHEN SHEET DRAINAGE IS PROPOSED ACROSS THAT SEEDED AREA.

7. ALL AREAS WHERE THE EXISTING PAVEMENT OR PAVEMENTS ARE DAMAGED DURING CONSTRUCTION FROM TRAFFIC BY THE GENERAL CONTRACTOR, SUBCONTRACTORS OR SUPPLIERS, SHALL BE RESURFACED OR RECONSTRUCTED AT LEAST TO THEIR ORIGINAL CONDITION AFTER THE CONSTRUCTION WORK IS COMPLETED. $\checkmark \checkmark \checkmark \checkmark \checkmark \checkmark$ ALL ROOF DRAIN AND STORM SEWER PIPING, STRUCTURES, CASTINGS, DOWN SPOUT ADAPTERS, AND OTHER ACCESSORIES TO BE PROVIDED BY GENERAL TRADES. LOCATION OF DOWN SPOUT BOOTS TO BE COORDINATED WITH ROOFING CONTRACTOR.

GRADING & DRAINAGE LEGEND

INDICATES TOP/BOTTOM CURB ELEVATION PROPOSED SPOT ELEVATION	835.19 834.69 835.54
PROPOSED GROUND CONTOUR	8 ₂₁
EXISTING GROUND CONTOUR	823
EXISTING SPOT ELEVATION	×800.15
PROPOSED ROOF-DRAIN / STORM SEWER	
DOWNSPOUT CONNECTION	o ^{D.S.}
PROPOSED CLEAN-OUT	o ^{C.O.}
PROPOSED NYLOPLAST DRAIN BASIN	٢


VERTIGAL DATUM:

- 1		
	CGS N 269 1947 ELEVATION 798.17 (NAVD	88)
	A DISK SET ABOUT 0.4 FEET BELOW THE RAILROAD THE SOUTHEAST ALONG THE NEW YORK CENTRAL RAILROAD IN SHELBYVILLE, SET IN THE TOP OF THE SOUTHEAST END HEAD WALL OF CONCRETE ARCH RAILROAD OVER PASS ROAD, ABOUT 30 YARDS NORTHWEST OF LIGHT SIGNAL NORTHEAST OF THE NORTHEAST RAIL.	FROM TH OF THE NO. 398
	CSC TBM #1427 ELEVATION 788.90	
	CUT "X" ON THE NORTH MOST BONNET BOLT OF A FIRI THE NORTHWEST CORNER OF LOPER DRIVE AND DRAKE FEET NORTHWEST OF THE INTERSECTION.	
	CSC TBM #1038 ELEVATION 789.99	
	CUT "X" ON THE NORTH NORTHWEST BONNET BOLT OF 31.9 FEET SOUTH AND 38.1 FEET EAST OF THE SOUTH BRICK BUILDING KNOWN CURRENTLY AS WILLIAM F LOPE	EASTERN
- L		









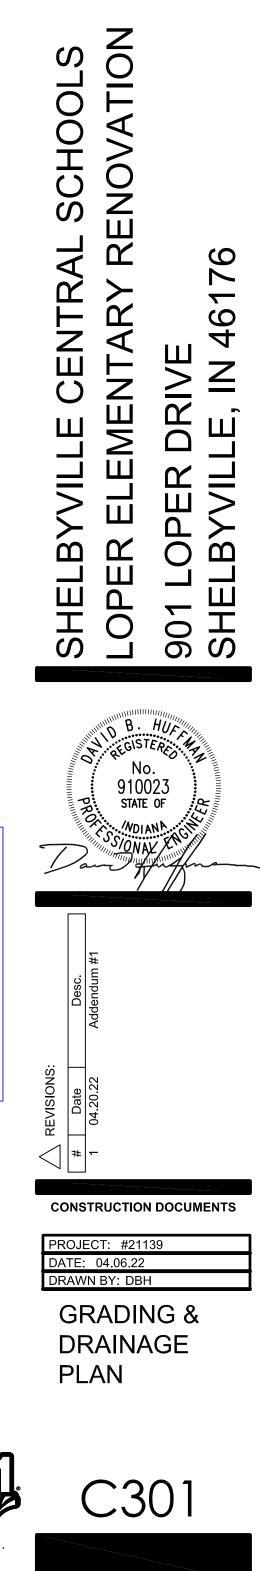

ABOUT 2.05 MILES THE STATION AT IE NORTHEAST 98A OVER MCKAY 302, AND 6 FEET RANT LOCATED AT APPROXIMATELY 34 RE HYDRANT LOCATED CRN CORNER OF THE EMENTARY SCHOOL.

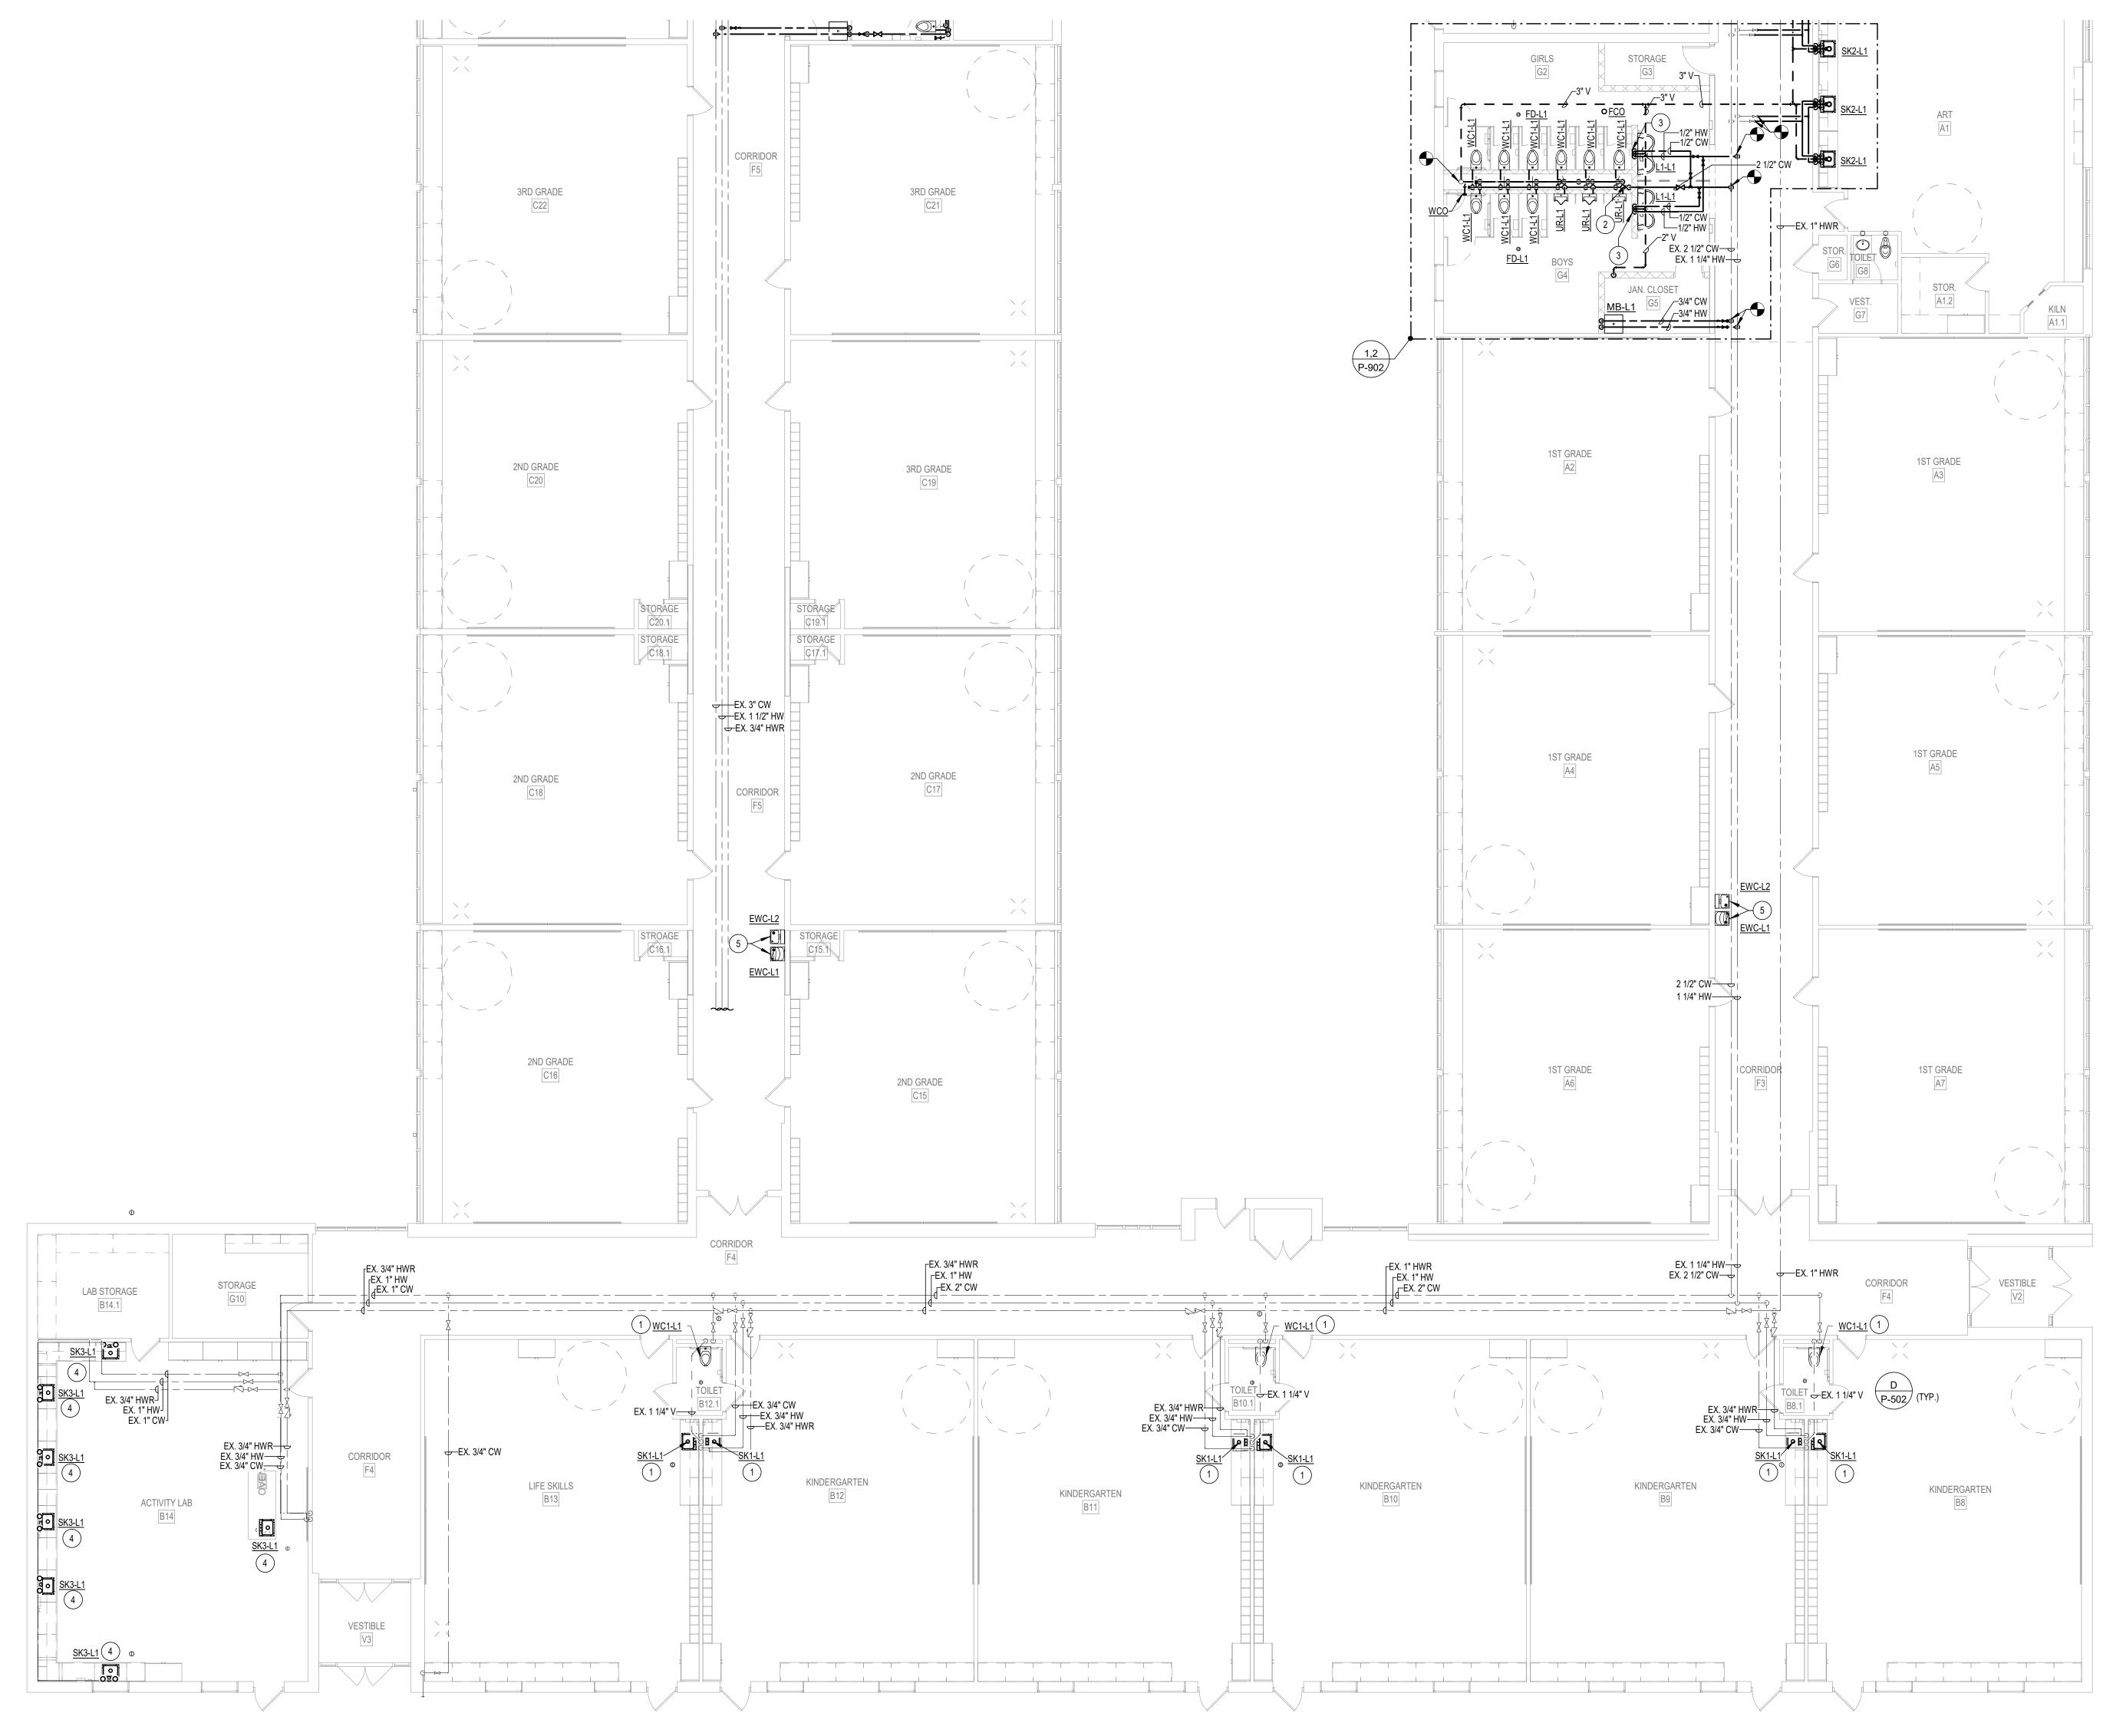

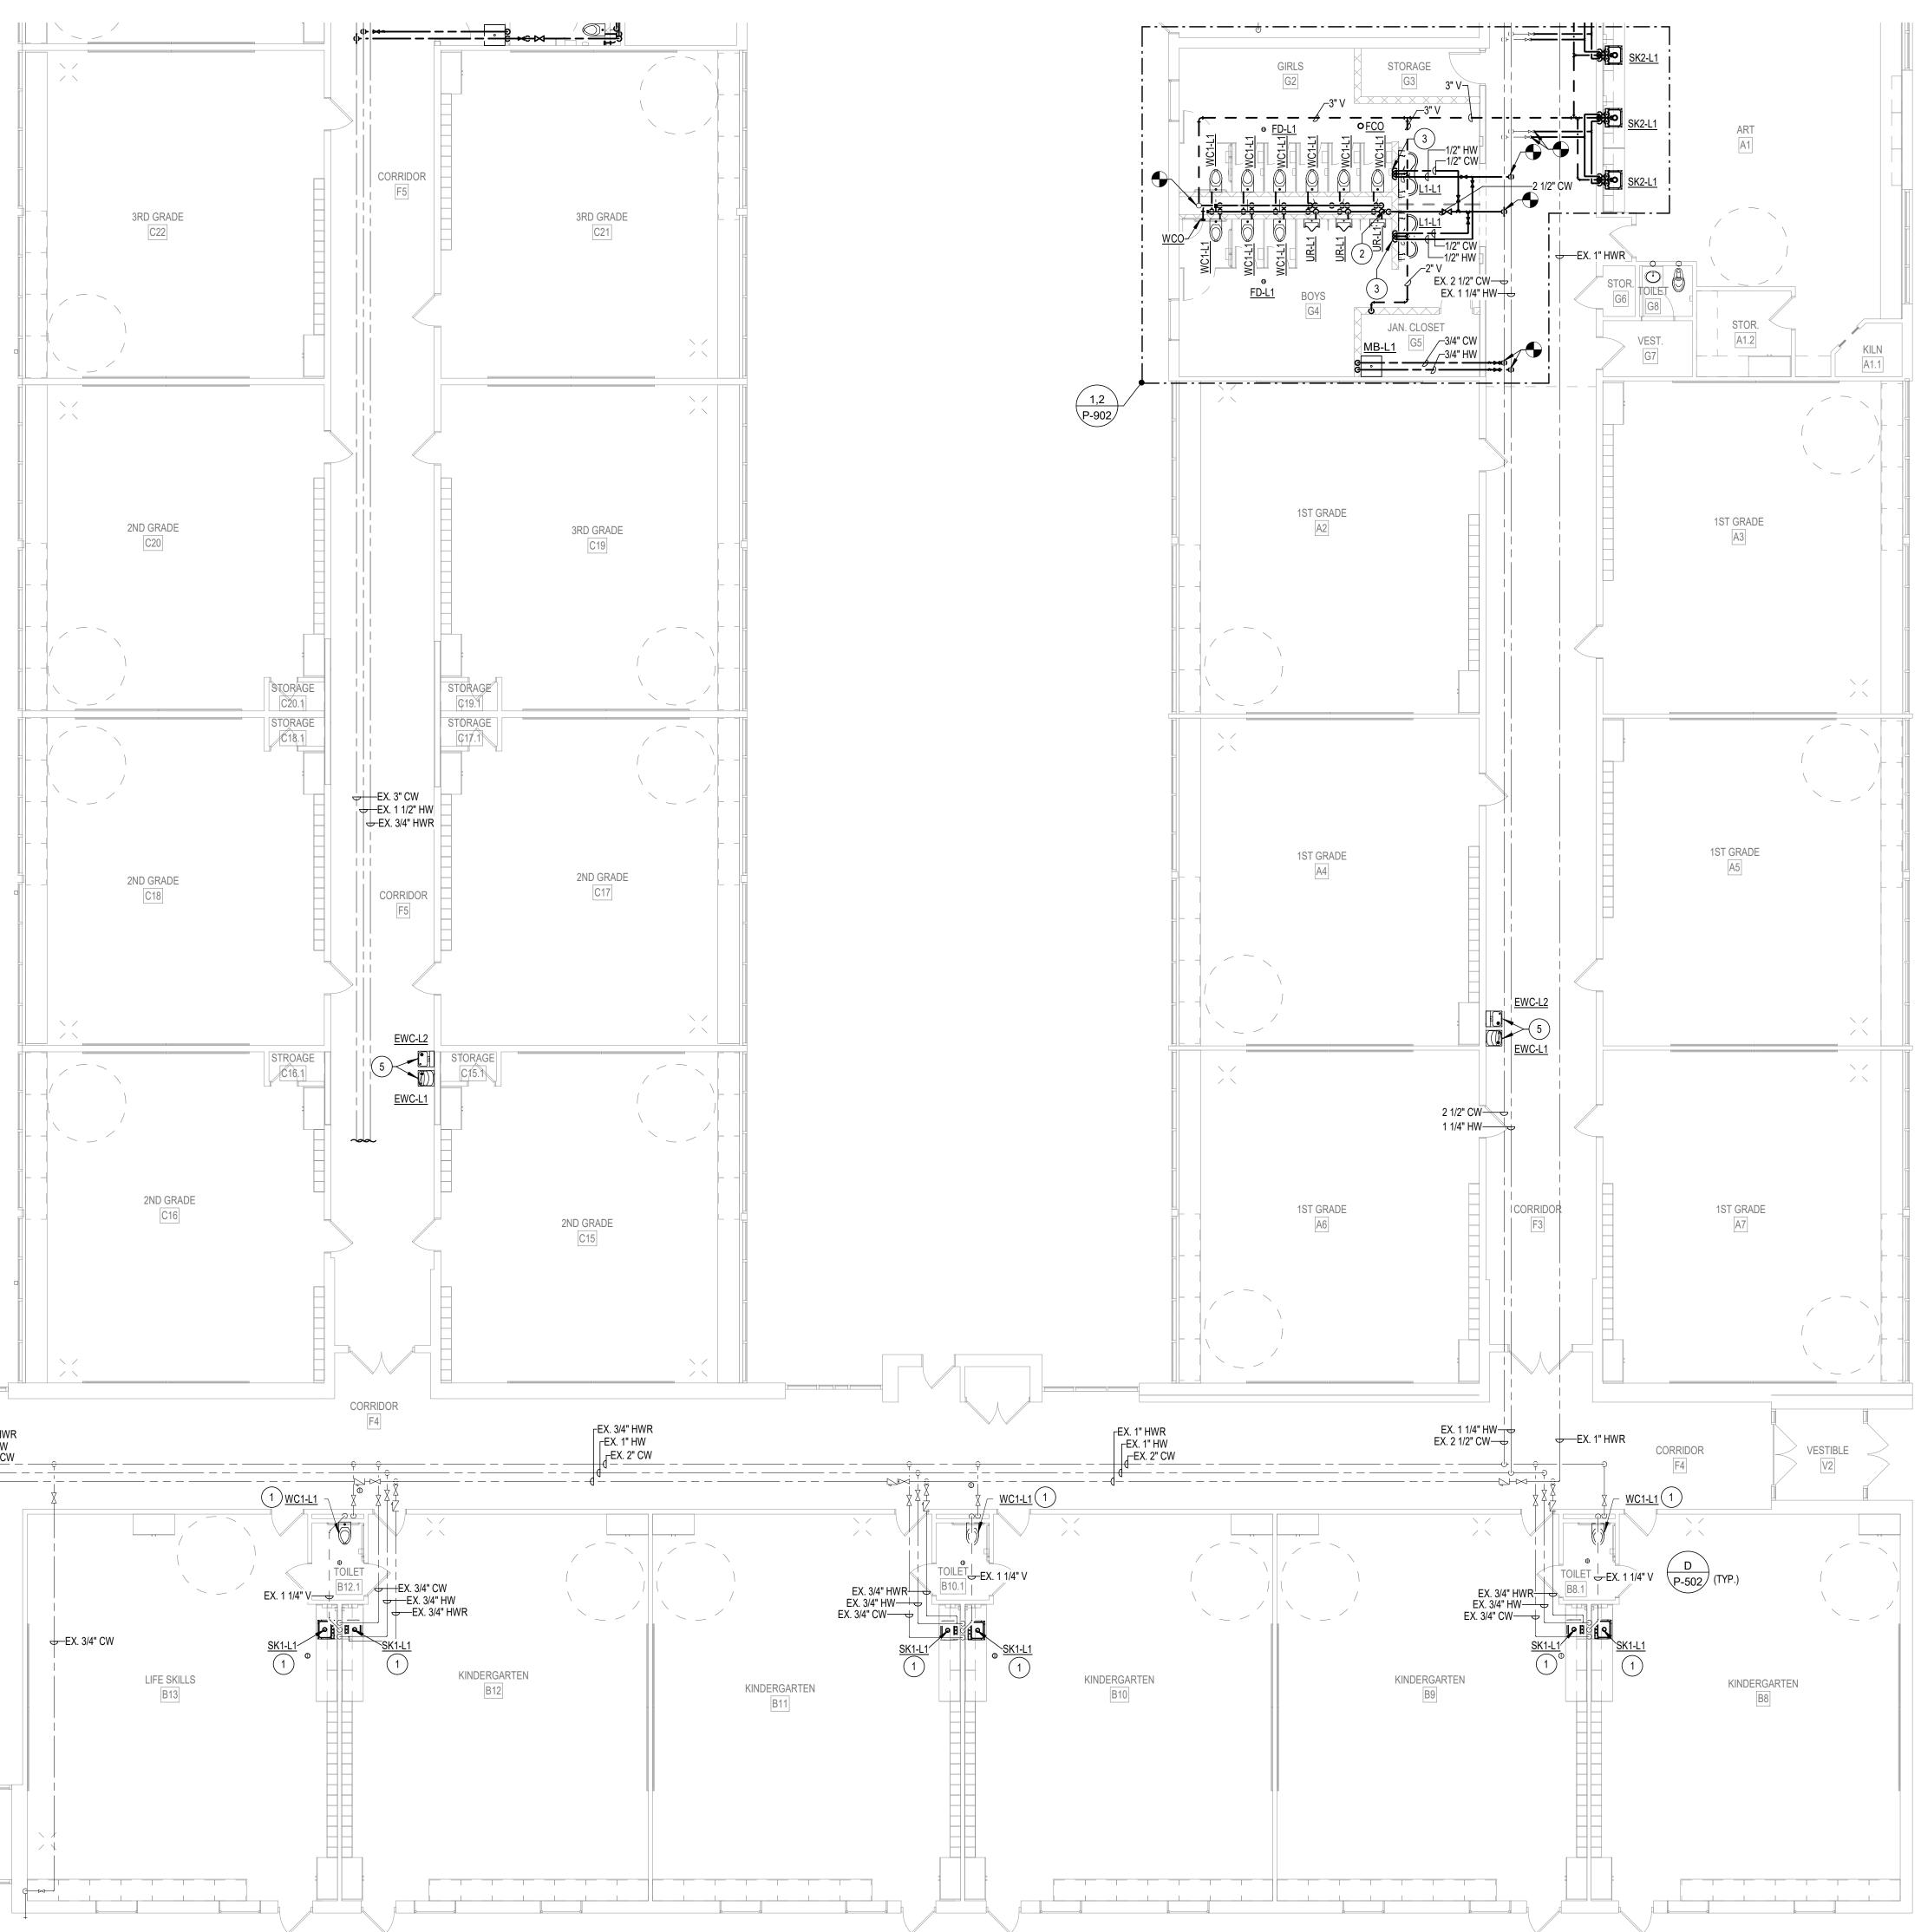




GENERAL PLUMBING NOTES:


A. REFERENCE SHEET M-000 FOR PLUMBING SYMBOLS, LEGENDS, ABBREVIATIONS AND ADDITIONAL GENERAL NOTES.

\cap	SHEET PLAN NOTES
\bigcirc	SHELT LAN NOTES


- 1 CONNECT NEW PLUMBING FIXTURE TO EXISTING WATER, WASTE, AND VENT PIPING.
- 2 2 1/2"CW DOWN IN CHASE. ROUTE 2 1/2"CW LINE FULL SIZE. PROVIDE WHA 'D'. 3 1/2"CW AND 1/2"HW DROP, 1 1/2"V RISE, 2"W DOWN.
- 4 CONNECT NEW SINK TO EXISTING WASTE, WATER, AND VENT
- 5 CONNECT NEW PLUMBING FIXTURE TO EXISTING WATER, WASTE, AND VENT PIPING. PROVIDE SHUT OFF VALVE ON COLD WATER LINE.




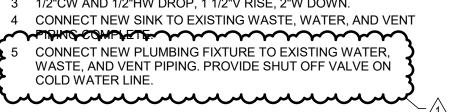


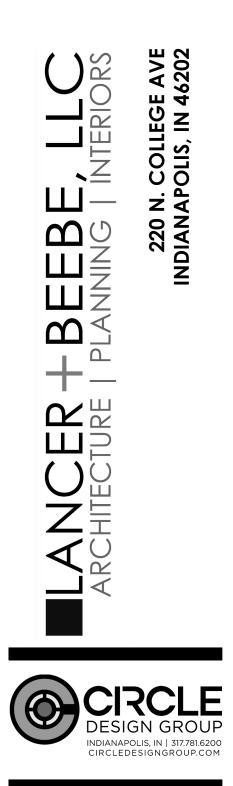

SHELBYVILLE CENTRAL SCHOOLS CORPORATION
LOPER ELEMENTARY RENOVATIONS & ADDITIONS
901 LOPER DRIVE

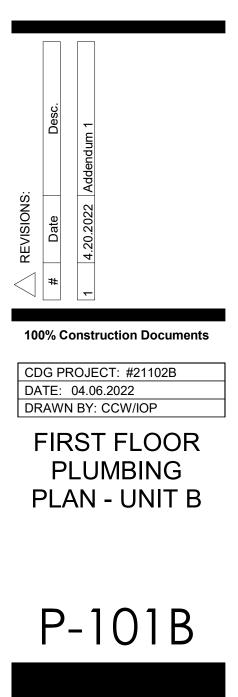

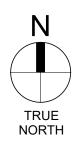

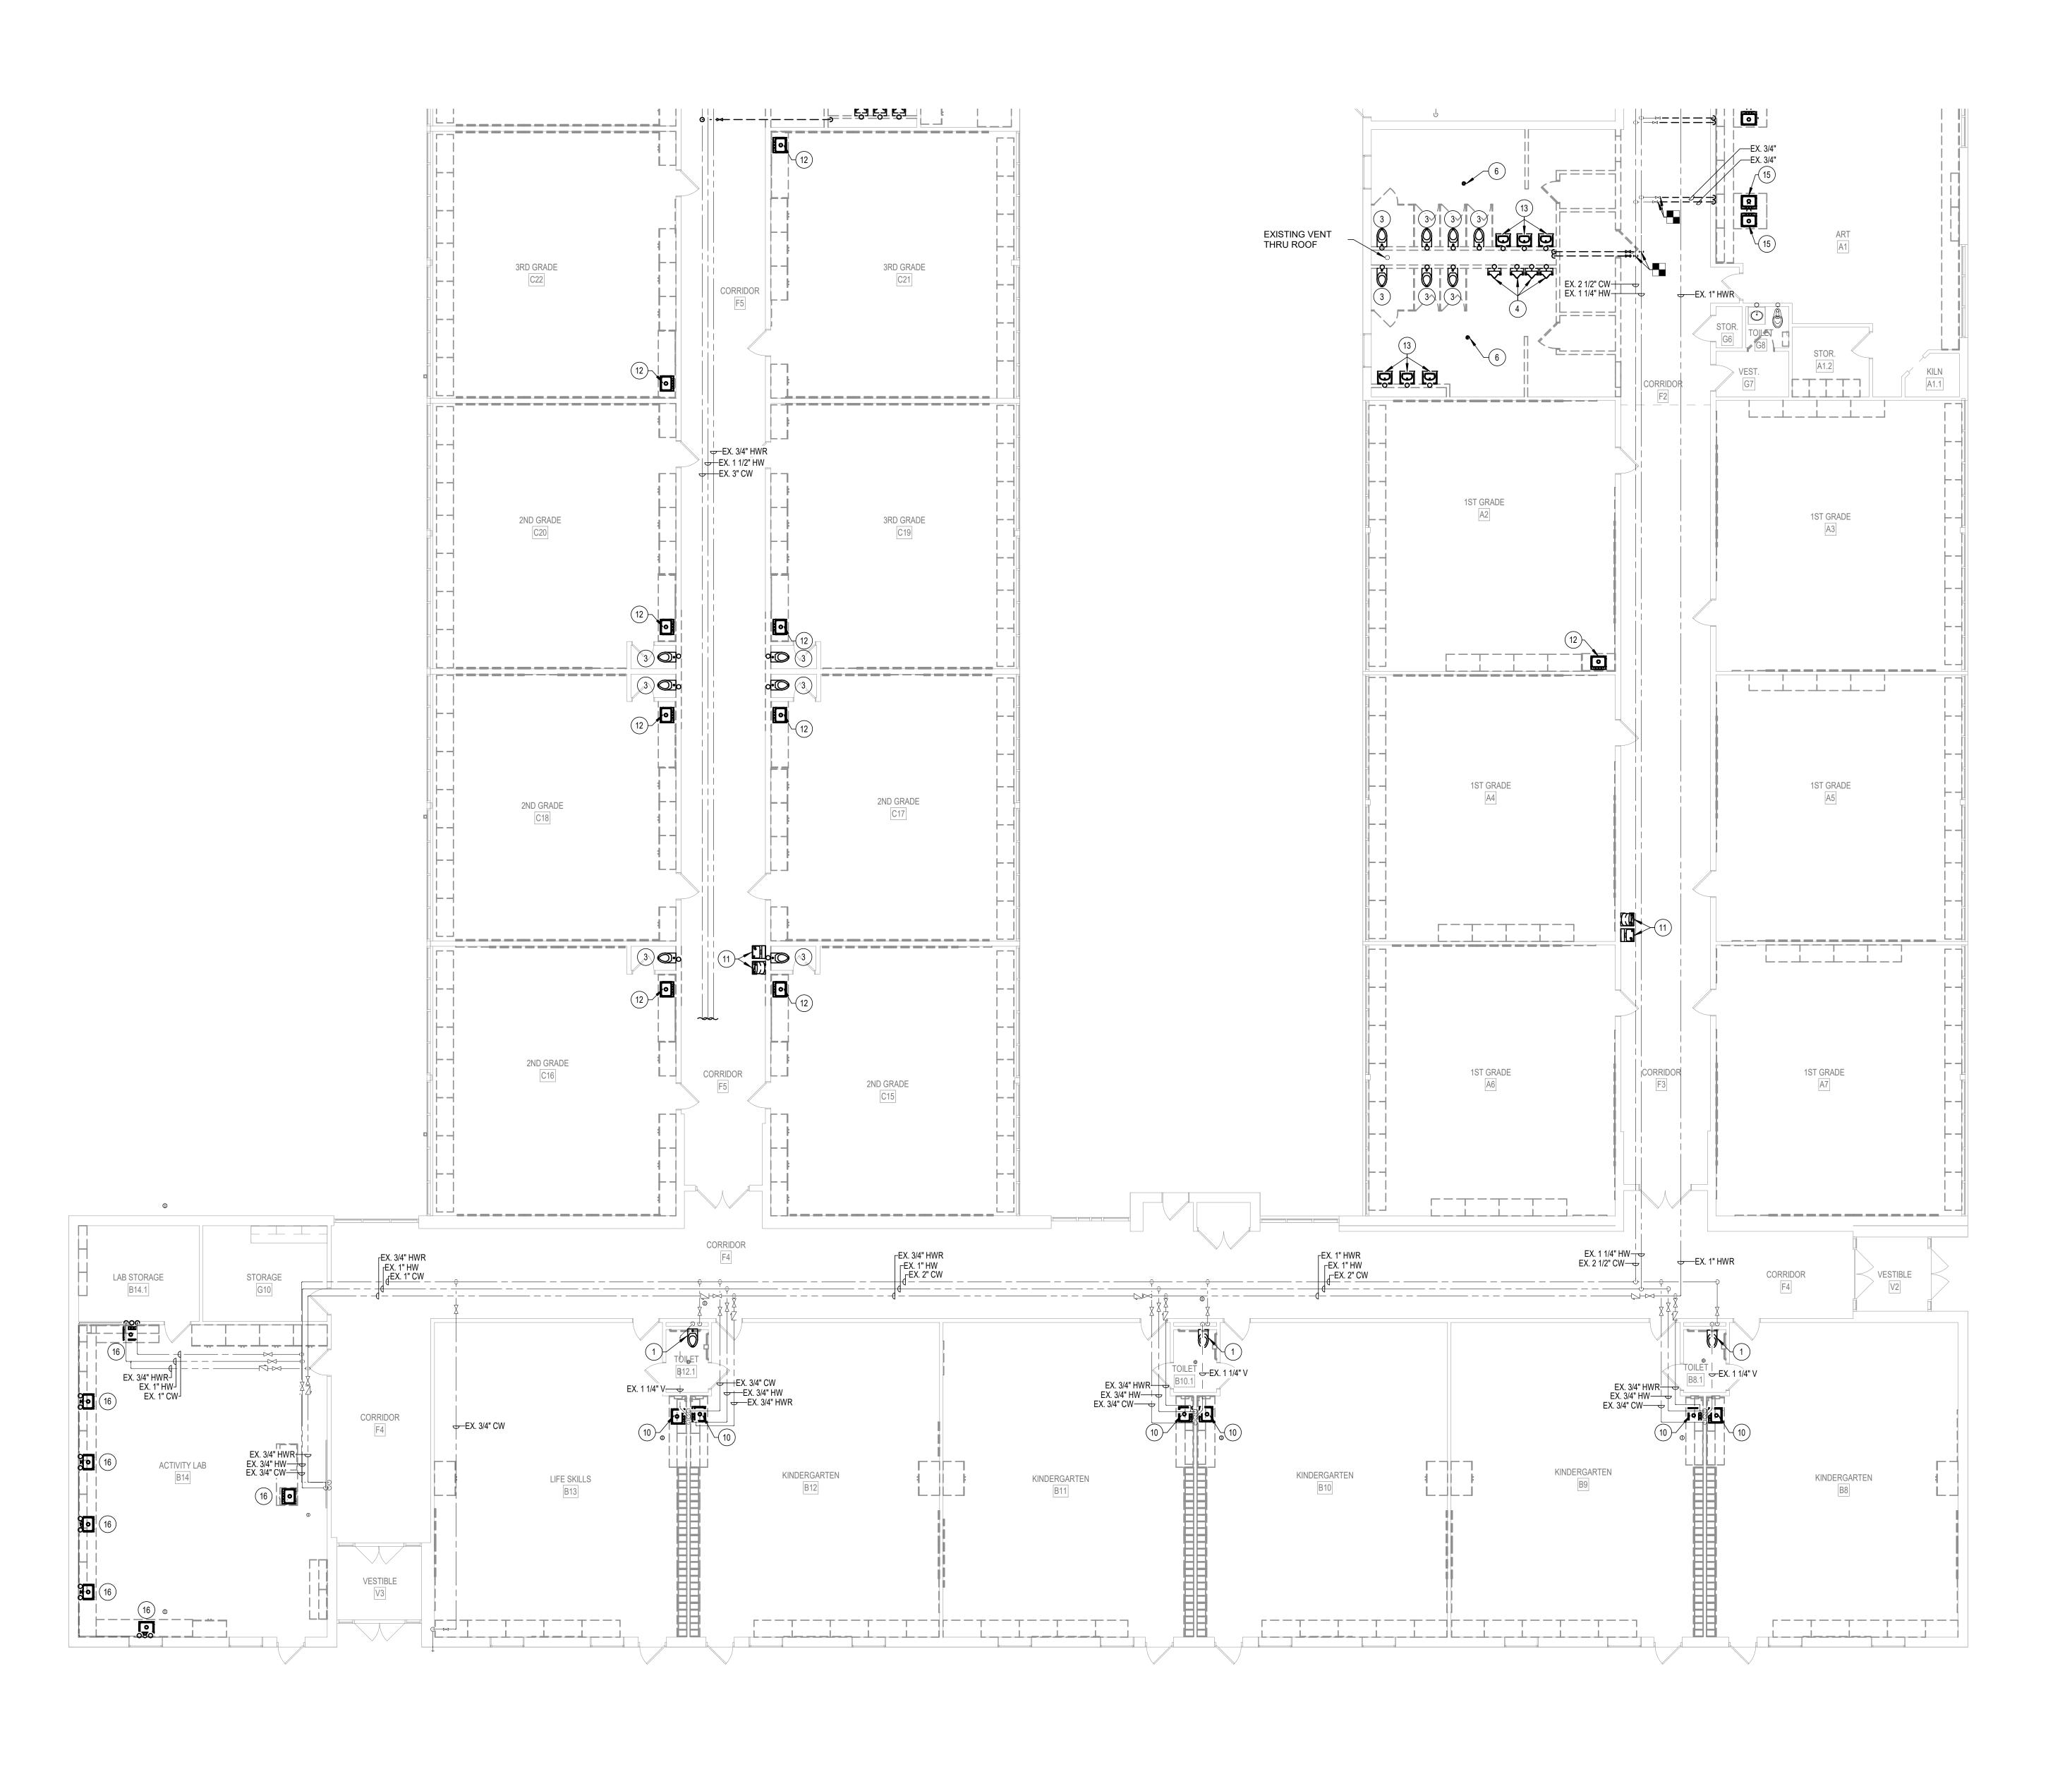

FIRST FLOOR PLUMBING DEMO PLAN - UNIT B 1/8" = 1'-0" 0 4' 8'

GENERAL DEMOLITION NOTES:

A. REFERENCE SHEET M-000 FOR PLUMBING SYMBOLS,

LEGENDS, ABBREVIATIONS AND ADDITIONAL GENERAL NOTES. B. FIELD VERIFY LOCATION AND SIZES OF EXISTING WASTE, VENT, CW, AND HW PIPING PRIOR TO ANY WORK. SHEET DEMO PLAN NOTES 1 EXISTING WATER CLOSET TO BE REMOVED COMPLETE. PREPARE ROUGH-IN FOR NEW FIXTURE. 2 EXISTING LAVATORY TO BE REMOVED COMPLETE. PREPARE ROUGH-IN FOR NEW FIXTURE. 3 EXISTING WATER CLOSET TO BE REMOVED COMPLETE. REMOVE FIXTURE SUPPORT, ALL ASSOCIATED WATER, WASTE, AND VENT 4 EXISTING URINAL TO BE REMOVED COMPLETE. REMOVE FIXTURE SUPPORT, ALL ASSOCIATED WATER, WASTE, AND VENT PIPING. 5 EXISTING WASHFOUNTAIN TO BE REMOVED COMPLETE. REMOVE ALL ASSOCIATED WATER, WASTE, AND VENT PIPING. PATCH WALL SURFACE AT ROUGH-INS. 6 EXISTING FLOOR DRAIN TO BE REMOVED COMPLETE. CAP/ABANDON WASTE PIPE. PATCH FLOOR TO MATCH ADJACENT FLOOR ELEVATION/FINISH. 7 EXISTING WATER COOLER ROUGH-IN. WASTE/VENT ROUGH-IN TO 8 DISCONNECT EXISTING COLD WATER BRANCH PIPING FROM MAIN AND PREPARE BRANCH FOR NEW CONNECTION. CAP BRANCH AT 9 EXISTING SINK TO BE REMOVED COMPLETE. REMOVE ALL ASSOCIATED WATER, WASTE, AND VENT PIPING. CAP WASTE ROUGH-IN BEYOND FINISHED SURFACE. CAP WATER PIPE AT 10 EXISTING SINK TO BE REMOVED COMPLETE. PREPARE ROUGH-INS 11 EXISTING WATER COOLER TO BE REMOVED COMPLETE. PREPARE ROUGH-INS FOR NEW FIXTURE. 12 EXISTING SINK TO BE REMOVED COMPLETE. REMOVE, CAP WATER AND WASTE ROUGH-IN BEYOND FINISHED SURFACE. 13 EXISTING LAVATORY TO BE REMOVED COMPLETE. REMOVE FIXTURE SUPPORT, ALL ASSOCIATED WATER, WASTE, AND VENT PIPING. 14 EXISTING WASHER BOX TO BE REMOVED COMPLETE. REMOVE

- PIPING

- REMAIN. WATER ROUGH-IN TO BE REMOVED.
- MAIN
- CONNECTION TO MAIN.
- FOR NEW FIXTURE.


- FIXTURE SUPPORT, ALL ASSOCIATED WATER, WASTE, AND VENT PIPING. CAP WASTE PIPE BELOW FINISHED FLOOR, CAP WATER, WASTE, AND VENT PIPING AT MAIN. 15 EXISTING SINK TO BE REMOVED COMPLETE. REMOVE ALL

ASSOCIATED WATER, WASTE, AND VENT PIPING. CAP WASTE PIPE

16 EXISTING SINK TO BE REMOVED COMPLETE. PREPARE ROUGH-INS FOR NEW CONNECTION.




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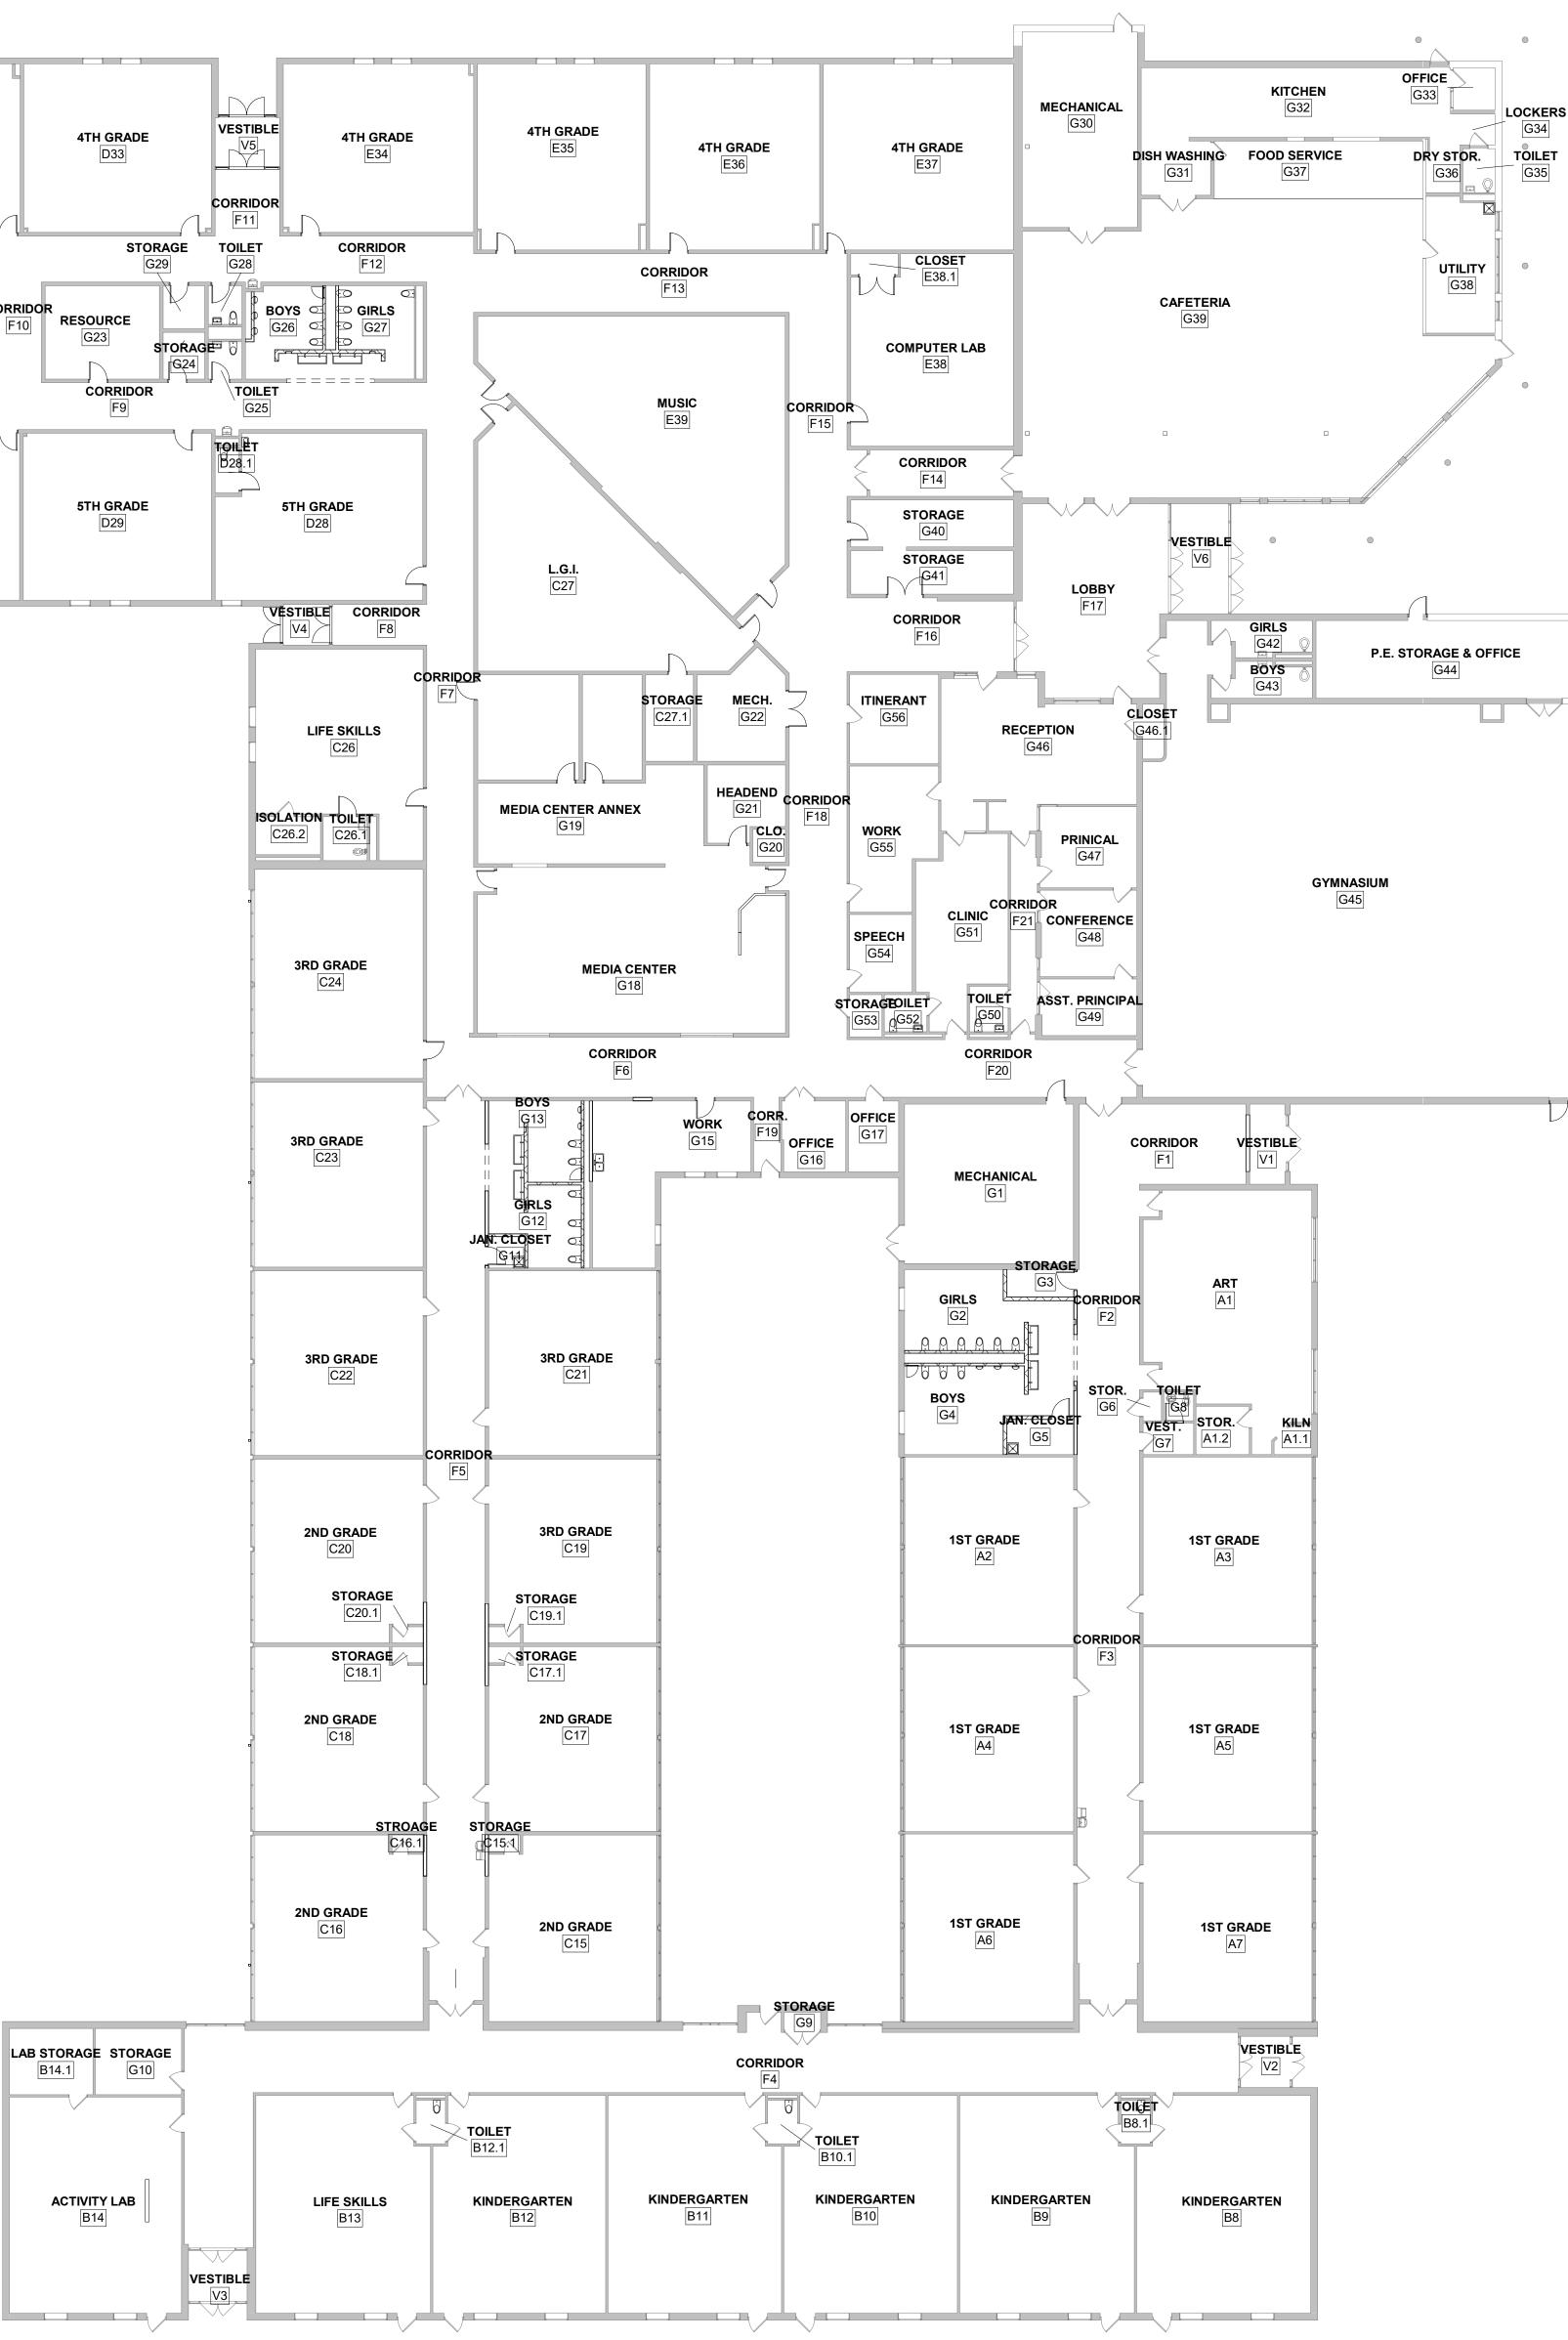

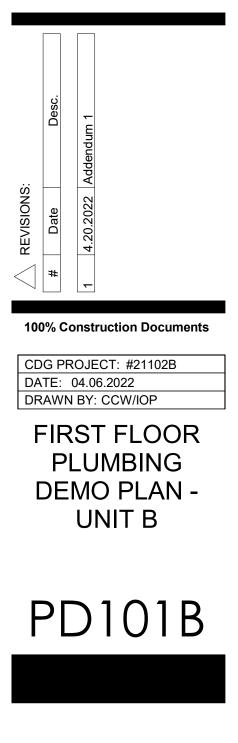
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TRUE NORTH






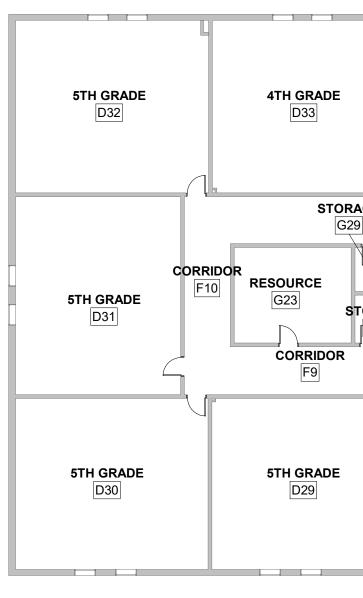


GENERAL NOTES

- 1. PROVIDE CORNER GUARDS AT ALL OUTSIDE CORNERS WITH GYPSUM BOARD FROM 1'-6" AFF TO 4'-0" AFF
- 2. PROVIDE BULL-NOSE FINISH ON ALL OUTSIDE CORNERS OF CMU WALLS 3. SEE A112 FOR ENLARGED PLANS
- 4. VIF ALL DIMENSIONS FOR CASEWORK
- 5. INTERIOR DIMENSIONS ARE TAKEN TO THE FACE OF MASONRY OR STUDS 6. FOR ALL RESTROOM FACILITIES AND JANITOR CLOSETS WITH GYPSUM WALL FINISH REPLACE 5/8" TYPE "X" GYPSUM BOARD WIHT 5/8" MOISTURE RESISTANT
- GYPSUM BOARD, SEE SPECS FOR DETAILS فبالمراميا مراميا مراميا مراميا مراميا مرامي 7. COLUMN LOCATIONS IN CAFETERIA TO BE PAINTED PT-2
- 8. WALLS TO GO UP TO DECK UNLESS OTHERWISE NOTED
- 9. DO NOT PAINT OVER EXISTING VINYL WALL GRAPHICS, LETTERING, AND MURALS

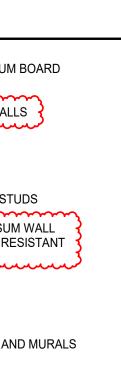




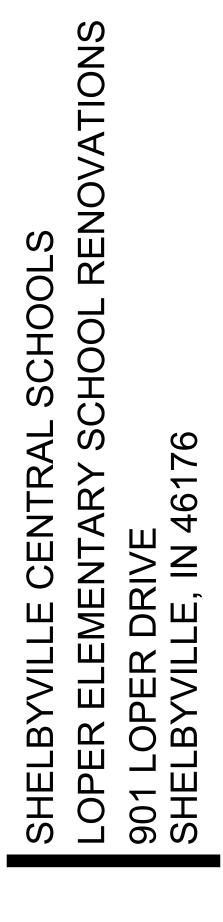





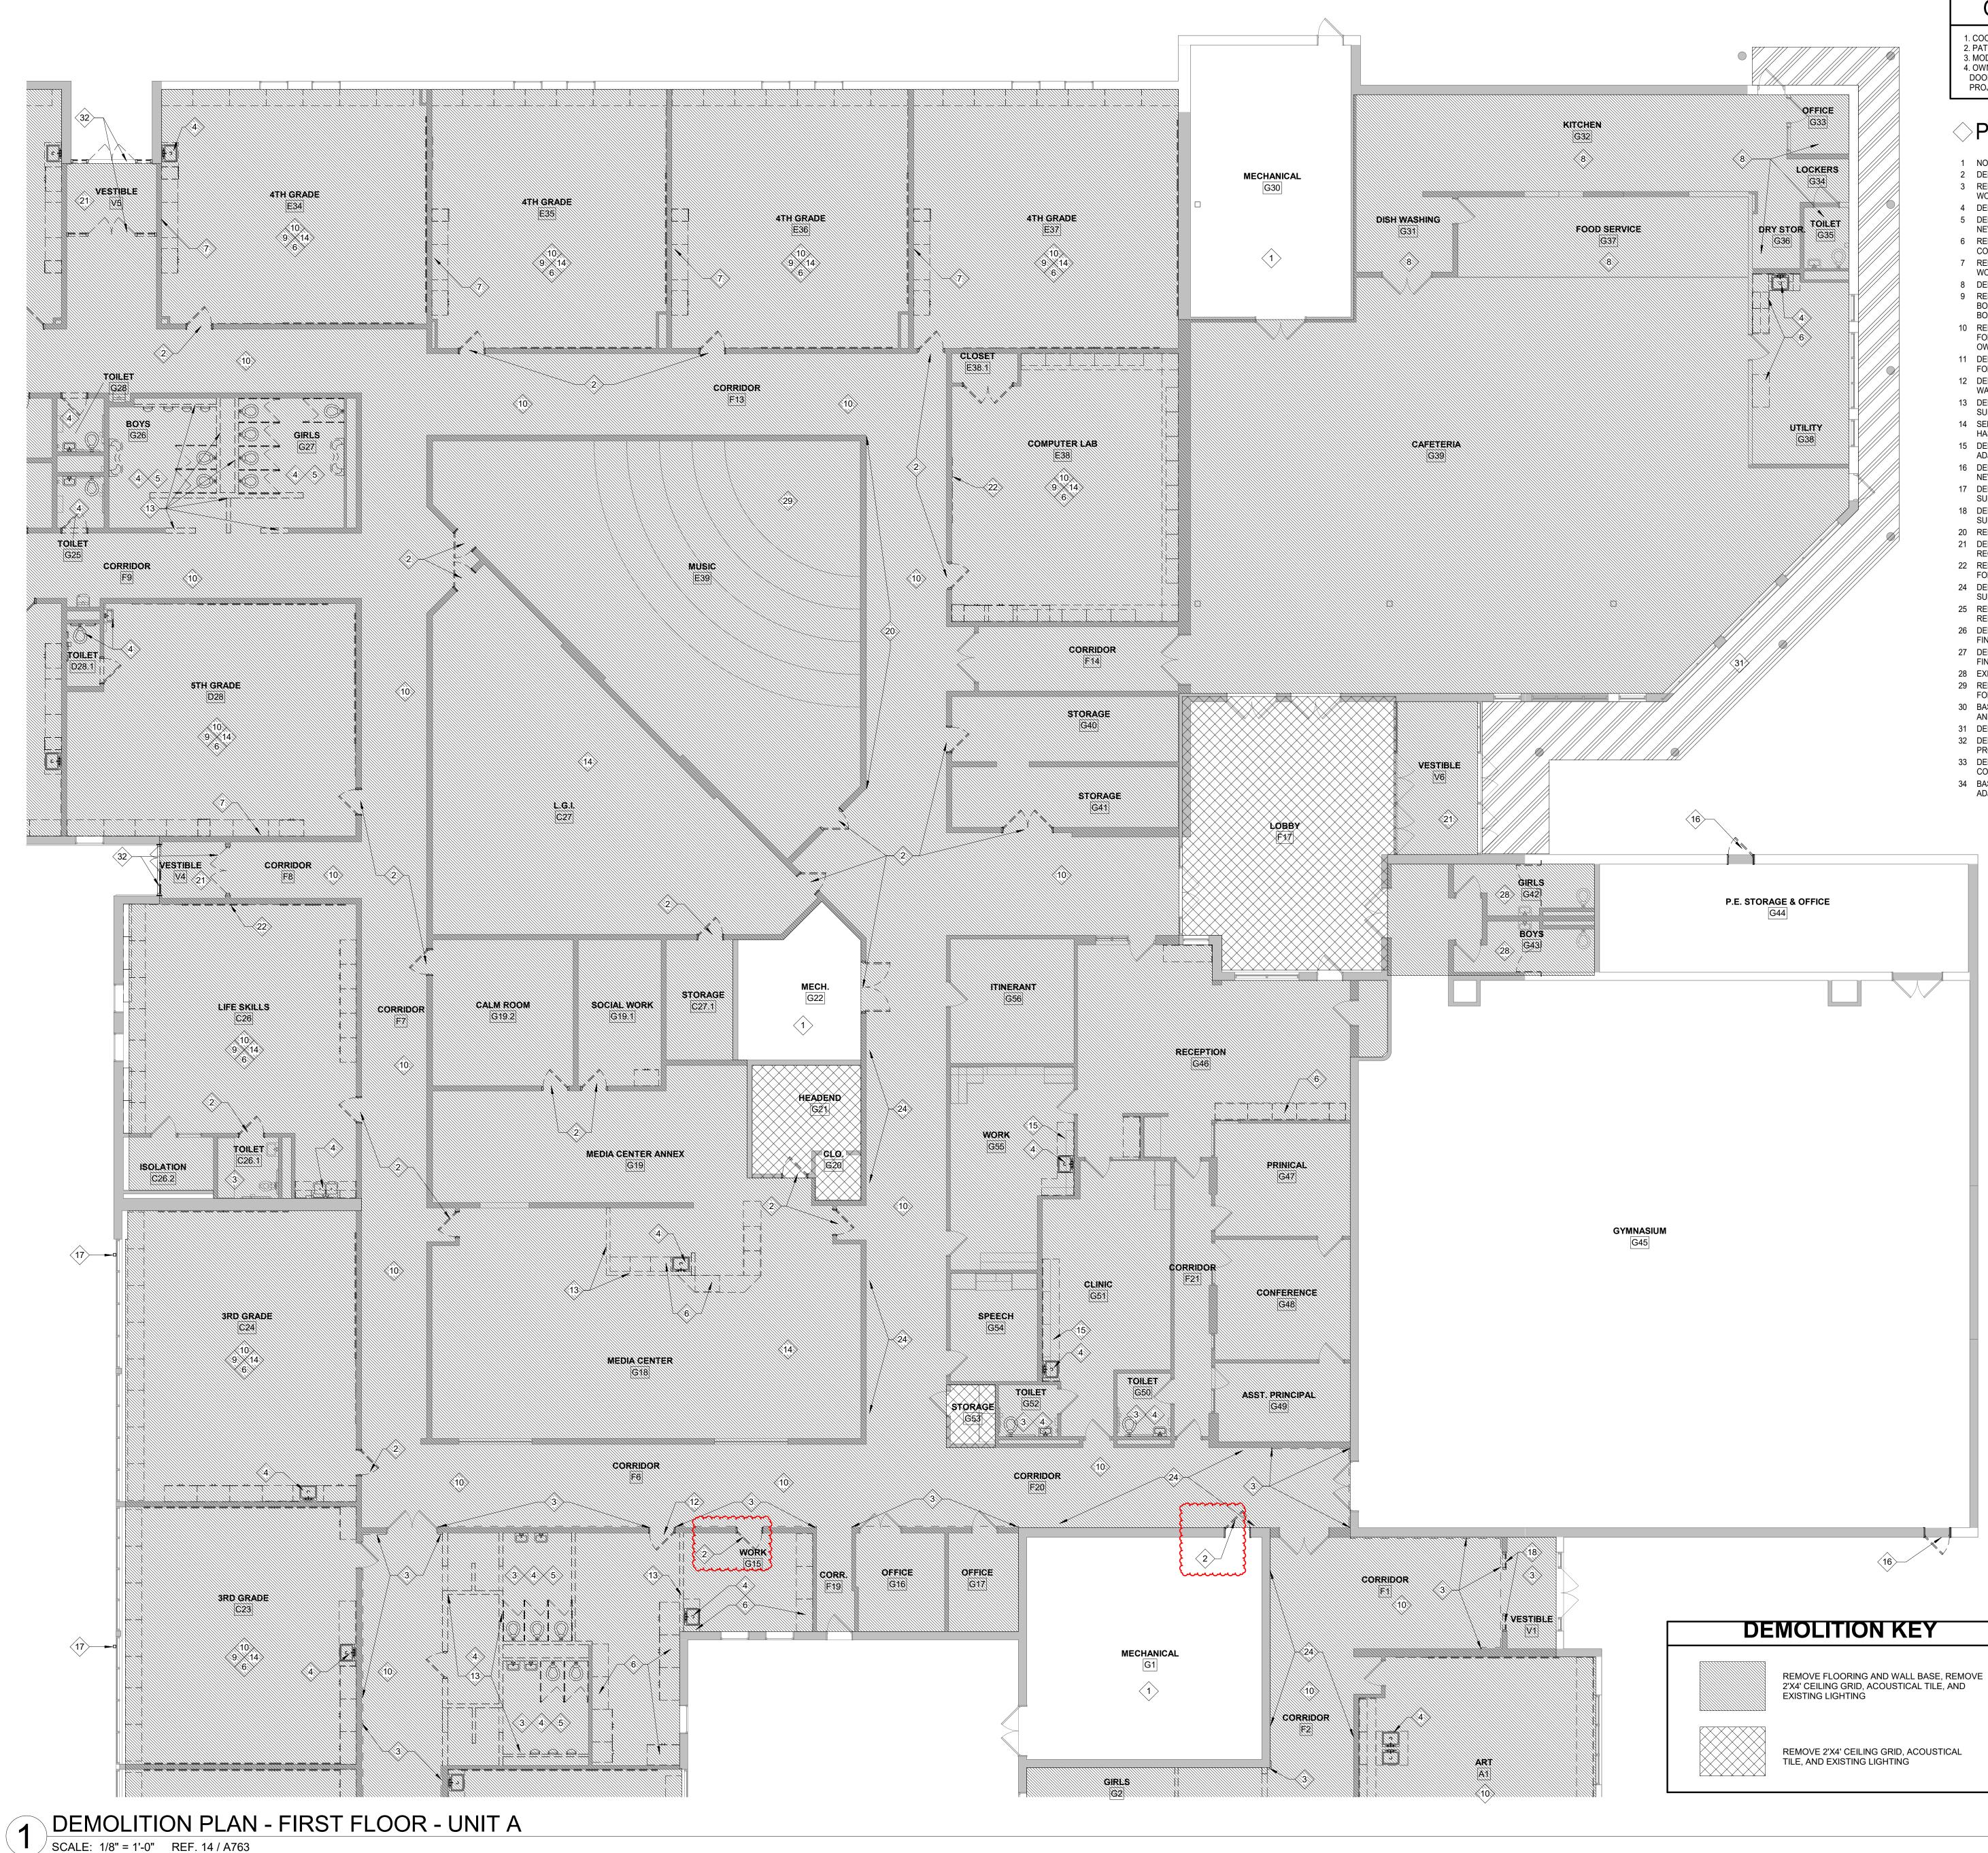


GENERAL NOTES - DEMO 1. COORDINATE DEMOLITION WORK WITH NEW WORK 2. PATCH. CLEAN, AND PREP SURFACES FOR NEW WORK 3. MODIFY EXISTING CELIINGS AS NEEDED TO ACCOMODATE NEW WORK. 4. OWNER SHALL HAVE FIRST RIGHT OF REFUSAL OF ANY DEMOLISHED DOORS, CASEWORK, MARKERBOARDS, CHALKBOARDS, PROJECTORS, PROJECTOR SCREENS, ETC.


PLAN NOTES - DEMOLITION


- 1 NO ARCHITECTURAL WORK IN THIS AREA. 2 DEMO EXISTING DOOR AND DOOR HARDWARE, FRAME TO REMAIN.
- 3 REMOVE EXISTING WALL TILE. CLEAN, PATCH AND PREP SURFACES FOR NEW WORK. AREA TO RECEIVE LEVEL 5 FINISH
- 4 DEMO EXISTING PLUMBING FIXTURES COMPLETE. REFER TO P-SERIES. 5 DEMO EXISTING TOILET PARTITIONS COMPLETE. PREPARE ALL SUFACES FOR NEW WORK.
- 6 REMOVE EXISTING CASEWORK COMPLETE. PREP ALL SURFACES FOR NEW CONSTRUCTION.
- 7 REMOVE EXISTING COAT HOOKS. PATCH AND PREP SURFACES FOR NEW WORK.
- 8 DEMO EXISTING TILE AND TILE BASE. PREPARE SURFACES FOR NEW WORK. 9 REMOVE EXISTING CHALKBOARD OR MARKERBOARD AND TRACK. SALVAGE BOARDS AND TRACKS FOR REUSE/RELOCATION. COORDINATE STORAGE OF BOARDS AND TRACKS WITH OWNER.
- 10 REMOVE EXISTING TACKBOARDS AND TACK STRIPS. SALVAGE TACK BOARDS FOR REUSE/RELOCATION. COORDINATE STORAGE OF TACK BOARDS WITH OWNER.
- 11 DEMO WOODFRAME CHALKBOARDS AND TACKBOARDS. PREPARE SURFACES FOR NEW WORK.
- 12 DEMO EXISTING DOOR AND FRAME. PREPARE OPENING FOR NEW INFILL WALL. PATCH AND REPAIR AS NEEDED.
- 13 DEMO EXISTING WALL TO EXTENTS SHOWN. PATCH AND REPAIR ADJACENT SURFACES FOR NEW WORK.
- 14 SELECTIVELY DEMO EXISTING PROJECTORS, DROPS, AND SCREENS. OWNER HAS FIRST RIGHT OF REFUSAL.
- 15 DEMO EXISTING COUNTER AND BACKSPLASH. PREP SURFACE AND ADJACENT SURFACES FOR NEW SOLID SURFACE COUNTER.
- 16 DEMO EXTERIOR DOOR AND FRAME COMPLETE. PREPARE SURFACES FOR NEW WORK.
- 17 DEMO EXISTING DOWNSPOUT COMPLETE. PATCH, PREP, PREPARE SURFACES FOR NEW WORK.
- 18 DEMO EXISTING STOREFRONT COMPLETE. PATCH, PREP, AND PREPARE SURFACES FOR NEW WORK.
- 20 REMOVE VINYL WALL MURAL AND PAINT BEHIND. STORE AND REINSTALL. 21 DEMO EXISTING INTEGRATED GRID MAT SYSTEM. FILL AND LEVEL FLOOR AS REQUIRED FOR NEW FLOOR FINISH.
- 22 REMOVE EXISTING WALL MOUNTED TV AND BRACKET, SALVAGE AND STORE FOR REINSTALLTION
- 24 DEMO TACKABLE SURFACES FLOOR TO CEILING. CLEAN, PATCH AND PREP SURFACES FOR NEW WORK. AREA TO RECEIVE LEVEL 5 FINISH
- 25 REMOVE ALL WALLCOVERING IN KINDERGARTEN WING. LEVEL, PATCH, AND REPAIR WALLS FOR NEW FINISH.
- 26 DEMO OPEN SHELVING COMPLETE. PATCH AND REPAIR WALL FOR NEW FINISH. 27 DEMO FRP SURROUND COMPLETE. PATCH AND REPAIR WALL FOR NEW FINISH.
- 28 EXISTING GYP CEILING TO REMAIN. PREP SURFACE FOR NEW PAINT.
- 29 REMOVE EXISTING FLOORING SURFACE TO EXTENTS SHOWN. PREP AREA FOR NEW WORK. ONLY APPLICABLE IF ALTERNATE IS ACCEPTED. 30 BASE BID: SELECTIVELY REMOVE EXISTING CASEWORK COMPLETE. PROTECT
- AND STORE FOR RELOCATION AND REINSTALLATION.
- 31 DEMO EXISTING EIFS SOFFIT COMPLETE. PREPARE AREA FOR NEW WORK. 32 DEMO EXTERIOR DOOR AND HARDWARE. EXTERIOR FRAME TO REMAIN AND PROTECT DURING CONSTRUCTION.
- 33 DEMO EXISTING CASEWORK COMPLETE. PREP ALL SURFACES FOR NEW CONSTRUCTION. ONLY APPLICABLE IF ALTERNATE IS ACCEPTED.
- 34 BASE BID: DEMO EXISTING COUNTER AND BACKSPLASH. PREP SURFACE AND ADJACENT SURFACES FOR NEW SOLID SURFACE COUNTER.



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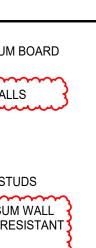


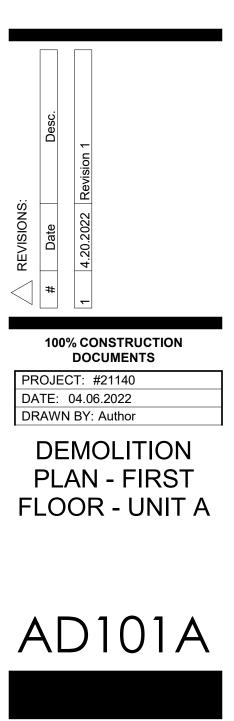

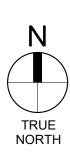

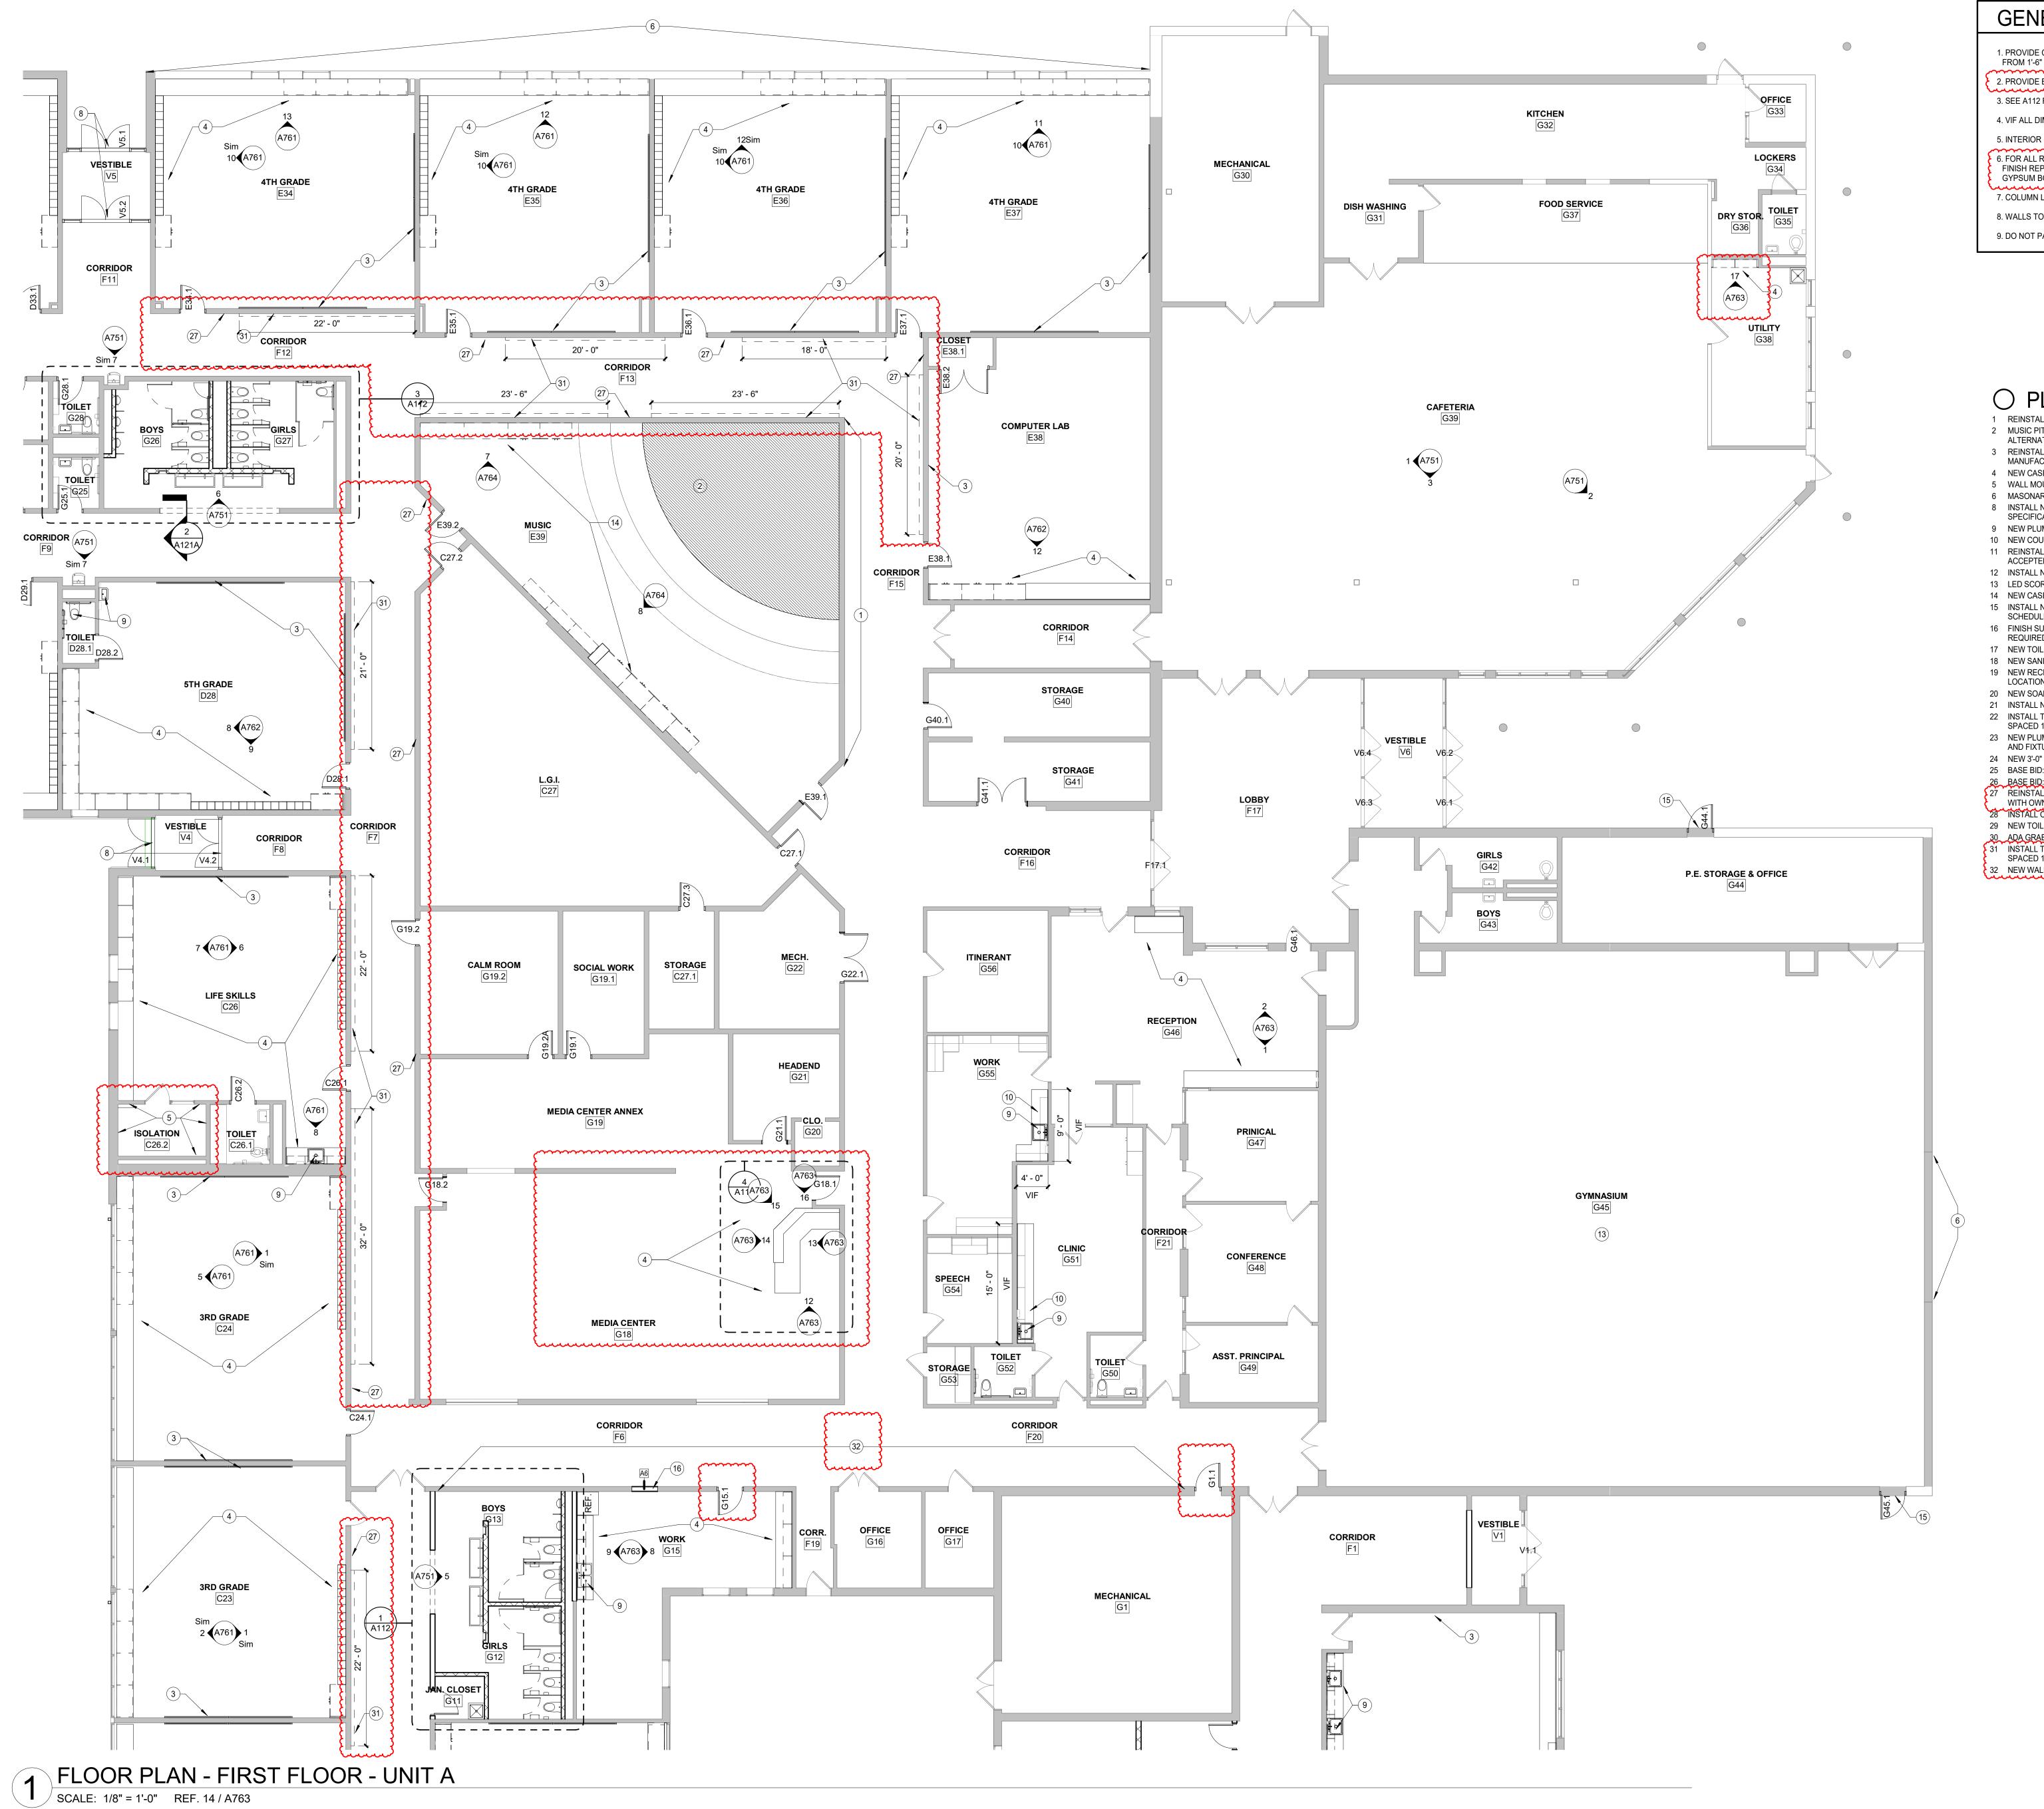11-6" AFF TO 4-0" AFF VIDE BULL-NOSE FINISH ON ALL OUTSIDE CORNERS OF CMU WALLS A112 FOR ENLARGED PLANS ALL DIMENSIONS FOR CASEWORK RIOR DIMENSIONS ARE TAKEN TO THE FACE OF MASONRY OR STU ALL RESTROOM FACILITIES AND JANITOR CLOSETS WITH GYPSUM H REPLACE 5//8" TYPE "X" GYPSUM BOARD WIHT 5/8" MOISTURE RES UM BOARD, SEE SPECS FOR DETAILS JMN LOCATIONS IN CAFETERIA TO BE PAINTED PT-2 LS TO GO UP TO DECK UNLESS OTHERWISE NOTED NOT PAINT OVER EXISTING VINYL WALL GRAPHICS, LETTERING, AND STALL VINYL WALL MURAL. NC PIT INFILL. REFER TO STRUCTURAL DRAWING FOR ADDITIONAL DI ERNATE BID. NSTALL MARKERBOARDS AND TACKBOARDS WITH TRACKS AS REQUI IUFACTURER. MARKERBOARDS AND TACKBOARDS PROVIDED BY OW / CASEWORK, REFER TO CASEWORK ELEVATIONS. L MOUNTED WALL PADDING FLOOR TO CELLING. SONARY RESTORATION WORK. REFER TO S-SERIES DRAWINGS. TALL NEW ALUMINUM EXTERIOR DOORS. REFER TO DOOR SCHEDULE CIFICATIONS. / PLUMBING FIXTURES. REFER TO P-SERIES. / COUNTERTOP OVER EXISITING CABINETS. NOTAL SALVAGED CASEWORK AS BASE BID. OMIT REINSTALLTION IN
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ATIONS. V SOAP DISPENSERS. SEE ELEVATIONS FOR ADDITIONAL LOCATIONS
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V PLUMBING ACCESS PANEL. COORDINATE LOCATION WITH ADJACEN FIXTURES.
V 3'-0" H x 4'-0" W MIRRORS. E BID: NEW 8'-0" COUNTERTOP OVER EXISITNG CABINETS. VIF.
E BID: NEW COUNTERTOP OVER EXISITING CABINETS. VIF.
H OWNER. TALL ONE ROW OF TACKSTRIP AT 5'-0" AFF.
V TOILET/URINAL PARTITIONS. .GRAB BARS.
FALL TWO ROWS OF TACKSTRIPS. TOP TACKSTRIP SHALL BE AT 5'-0"/ CED 1'-8" O.C. V WALL MURAL / VINYL WALL DECAL AT FULL HEIGHT OF AVAILABLE V

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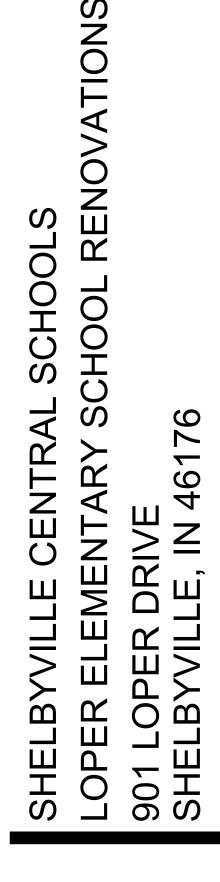
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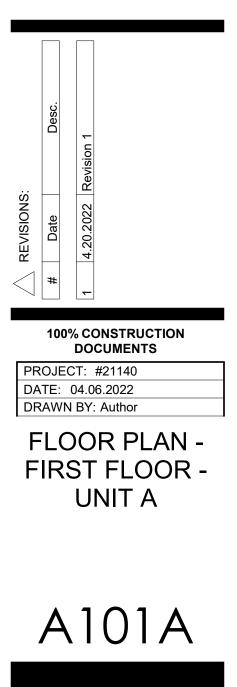
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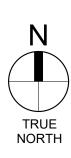
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1 FLOOR PLAN - FIRST FLOOR - UNIT B SCALE: 1/8" = 1'-0" REF. 14 / A763

SERVICE CORNER GUARDS AT ALL OUTSIDE CORNERS WITH GYPSUM BURGED IN 15% AFF TO 4-07 AFF PROVIDE BULL-NOSE FINISH ON ALL OUTSIDE CORNERS OF CMU WALLS SEE A112 FOR ENLARGED PLANS VIF ALL DIMENSIONS FOR CASEWORK SINTERIOR DIMENSIONS ARE TAKEN TO THE FACE OF MASONRY OR STUDE FINISH REPLACE 98% "TYPE "X' GYPSUM BOARD WITH SYM MOSTINE RESS OVESUM BOARD, SEE SPECS FOR DETALS COLUMN LOCATIONS IN CAFETERIA TO BE PAINTED PT-2 WALLS TO GO UP TO DECK UNLESS OTHERWISE NOTED DO NOT PAINT OVER EXISTING VINYL WALL GRAPHICS, LETTERING, AND T DO NOT PAINT OVER EXISTING VINYL WALL GRAPHICS, LETTERING, AND T MANUFACTURER. MARKERBOARDS AND TACKBOARD WITH TRACKS AS REGULE MANUFACTURER. MARKERBOARDS AND TACKBOARDS PROVIDED BY OWN WALL MOUNTED WALL PAINTER TO SEE PROVIDED BY OWN WALL MOUNTED WALL PAINTER TO SERVICIDAL DRAWING FOR ADDITIONAL DET ALTERNATE BID. SIGNARY RESTORATION WORK. REFER TO SASENDS PRAVIDED WALL MOUNTED WALL PAIDING FLOOR TO CELLING. MANUFACTURER. MARKERBOARDS AND TACKBOARDS PROVIDED BY OWN WALL MOUNTED WALL PAIDOING FLOOR TO CELLING. MANUFACTURER. MARKERBOARDS AND TACKBOARDS PROVIDED BY OWN MANUFACTURER.
 FROM 1-8° AFF TO 4-0° AFF PROVIDE BULL-NOSE FINISH ON ALL OUTSIDE CORNERS OF CMU WALLS SEE A112 FOR ENLARGED PLANS VIF ALL DIMENSIONS FOR CASEWORK INTERIOR DIMENSIONS ARE TAKEN TO THE FACE OF MASONRY OR STUD FOR ALL RESTROOM FACILITIES AND JANITOR CLOSETS WITH GYPSUM POR STUD FOR ALL RESTROOM FACILITIES AND JANITOR CLOSETS WITH GYPSUM POR STUD FOR ALL RESTROOM FACILITIES AND JANITOR CLOSETS WITH GYPSUM POR STUD FOR MALL RESTROOM FACILITIES AND JANITOR CLOSETS WITH GYPSUM POR STUD FOR ALL RESTROM FACILITIES AND JANITOR CLOSETS WITH GYPSUM POR STUD OLOWIN LOCATIONS IN CAFETERIA TO BE PAINTED PT-2 WALLS TO GO UP TO DECK UNLESS OTHERWISE NOTED DO NOT PAINT OVER EXISTING VINYL WALL GRAPHICS, LETTERING, AND I MUSIC PIT INFILL REFER TO STRUCTURAL DRAWING FOR ADDITIONAL DET ALTERNATE BID. MUSIC PIT INFILL REFER TO STRUCTURAL DRAWING FOR ADDITIONAL DET ALTERNATE BID. REINSTALL MARKERBOARDS AND TACKBOARDS WITH TRACKS AS REQUIR MARKENDER COLUMNES. WALL MOUNTED WALL PADDING FLOOR TO CELLING. MASONARY RESTORATION WORK, REFER TO SERIES DRAWINGS. INSTALL NEW WALLMINUM EXTERIOR DOORS, REFER TO DOOR SCHEDULE / SPECIFICATIONS. NEW PLUMBING FIXTURES. REFER TO SERIES DRAWINGS. INSTALL NEW WALLIFINISH SURROUND TO 4-0° AFF. REF FINISH LEGEND. INSTALL NEW WALLFINISH SURROUND TO 4-0° AFF. REF FINISH LEGEND. INSTALL NEW WALLFINISH SURROUND TO 4-0° AFF. REF FINISH LEGEND. INSTALL NEW WALL FINISH SURROUND TO 4-0° AFF. REF FINISH LEGEND. INSTALL NEW WALL FINISH SURROUND TO 4-0° AFF. REF FINISH LEGEND. INSTALL NEW WALL FINISH SURROUND TO 4-0° AFF. REF FINISH LEGEND. INSTALL NEW WALL FINISH SURROUND TO 4-0° AFF. REF FINISH LEGEND. INSTALL NEW WALL FINISH SURROUND TO 4-0° AFF. REF FINISH LEGEND. INSTALL NEW WALL FINISH SURROUND TO 4-0° AFF. REF FINISH LEGEND. INSTALL NEW WALK
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30 ADA GRAB BARS. 31 INSTALL TWO ROWS OF TACKSTRIPS. TOP TACKSTRIP SHALL BE AT 5'-0"AF

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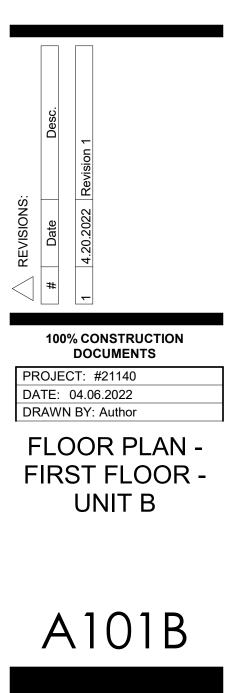
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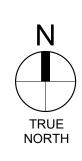
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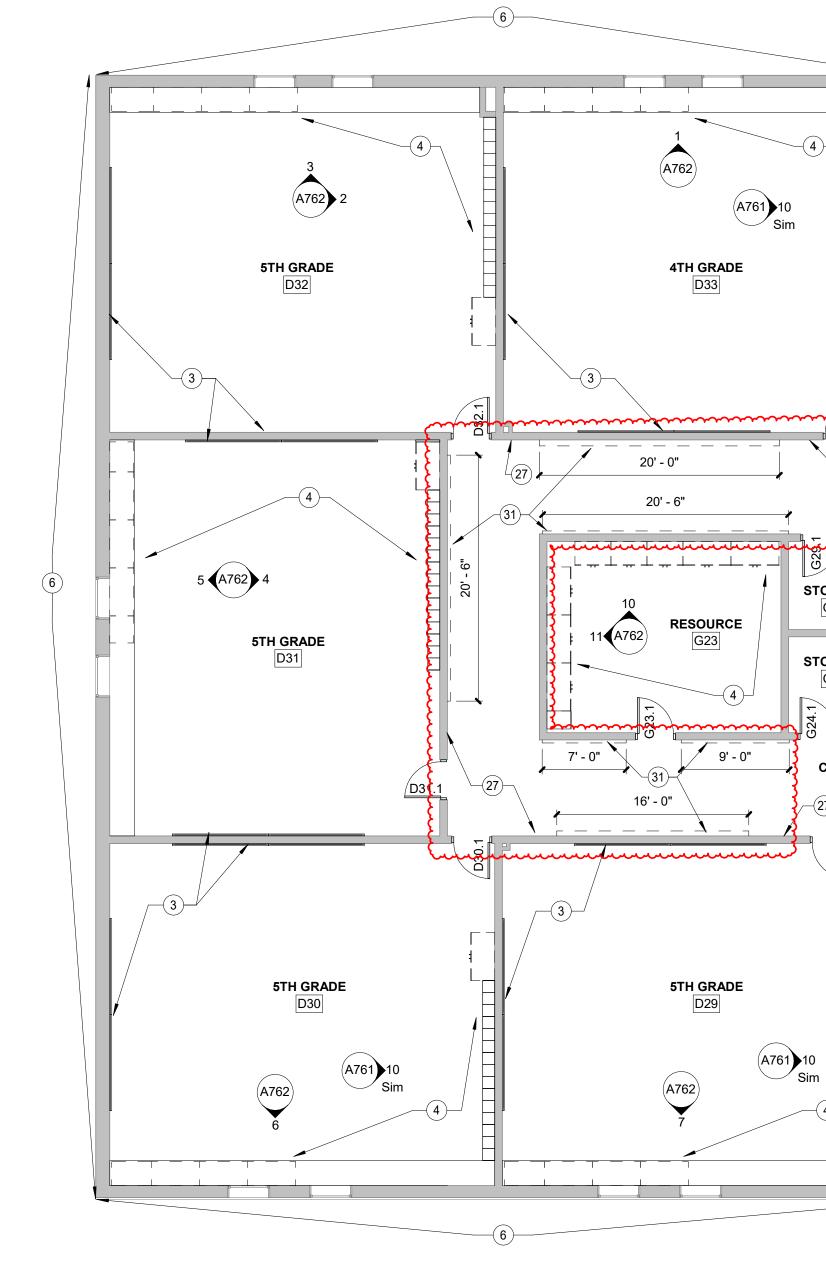
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-0"AFF, AND









FLOOR PLAN - FIRST FLOOR - UNIT C

 SCALE: 1/8" = 1'-0"

 REF. 14 / A763


GENERAL NOTES

- 1. PROVIDE CORNER GUARDS AT ALL OUTSIDE CORNERS WITH GYPSUM BOARD FROM 1'-6" AFF TO 4'-0" AFF 2. PROVIDE BULL-NOSE FINISH ON ALL OUTSIDE CORNERS OF CMU WALLS MANNAMANAMANA
- 3. SEE A112 FOR ENLARGED PLANS
- 4. VIF ALL DIMENSIONS FOR CASEWORK
- 5. INTERIOR DIMENSIONS ARE TAKEN TO THE FACE OF MASONRY OR STUDS 6. FOR ALL RESTROOM FACILITIES AND JANITOR CLOSETS WITH GYPSUM WALL FINISH REPLACE 5/8" TYPE "X" GYPSUM BOARD WIHT 5/8" MOISTURE RESISTANT GYPSUM BOARD, SEE SPECS FOR DETAILS
- 7. COLUMN LOCATIONS IN CAFETERIA TO BE PAINTED PT-2
- 8. WALLS TO GO UP TO DECK UNLESS OTHERWISE NOTED
- 9. DO NOT PAINT OVER EXISTING VINYL WALL GRAPHICS, LETTERING, AND MURALS

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O PLAN NOTES - FLOOR PLAN 1 REINSTALL VINYL WALL MURAL.


- 2 MUSIC PIT INFILL. REFER TO STRUCTURAL DRAWING FOR ADDITIONAL DETAILS. ALTERNATE BID.
- 3 REINSTALL MARKERBOARDS AND TACKBOARDS WITH TRACKS AS REQUIRED BY MANUFACTURER. MARKERBOARDS AND TACKBOARDS PROVIDED BY OWNER.
- 4 NEW CASEWORK, REFER TO CASEWORK ELEVATIONS. 5 WALL MOUNTED WALL PADDING FLOOR TO CEILING.
- 6 MASONARY RESTORATION WORK. REFER TO S-SERIES DRAWINGS. 8 INSTALL NEW ALUMINUM EXTERIOR DOORS. REFER TO DOOR SCHEDULE AND
- SPECIFICATIONS. 9 NEW PLUMBING FIXTURES. REFER TO P-SERIES.
- 10 NEW COUNTERTOP OVER EXISITNG CABINETS. 11 REINSTALL SALVAGED CASEWORK AS BASE BID. OMIT REINSTALLTION IF ALTERNATE IS
- ACCEPTED. 12 INSTALL NEW WALL FINISH SURROUND TO 4'-0" AFF. REF FINISH LEGEND.
- 13 LED SCOREBOARDS AS ALTERNATE. REF E-SERIES.
- 14 NEW CASEWORK AS ALTERNATE. REFER TO CASEWORK ELEVATIONS. 15 INSTALL NEW HOLLOW METAL EXTERIOR DOORS AND FRAMES. REFER TO DOOR SCHEDULE AND SPECIFICATIONS.
- 16 FINISH SURFACE OF WALL TO ALIGN WITH EXISTING WALL PLANES. INSTALL FURRING AS REQUIRED. 17 NEW TOILET PAPER DISPENSERS.
- 18 NEW SANITARY NAPKIN DISPOSAL CONTAINERS.
- 19 NEW RECESSED PAPER TOWEL DISPENSERS. SEE ELEVATIONS FOR ADDITIONAL LOCATIONS.
- 20 NEW SOAP DISPENSERS. SEE ELEVATIONS FOR ADDITIONAL LOCATIONS. 21 INSTALL NEW TACKBOARD, 4'-0"H x 4'-0"W. 22 INSTALL THREE ROWS OF TACKSTRIPS. TOP TACKSTRIP SHALL BE AT 6'-6"AFF, AND
- SPACED 1'-8" O.C. 23 NEW PLUMBING ACCESS PANEL. COORDINATE LOCATION WITH ADJACENT EQUIPMENT AND FIXTURES.
- 24 NEW 3'-0" H x 4'-0" W MIRRORS. 25 BASE BID: NEW 8'-0" COUNTERTOP OVER EXISITNG CABINETS. VIF.
- 26 BASE BID: NEW COUNTERTOP OVER EXISITING CABINETS, VIF. 27 REINSTALL EXISTING TACKBOARDS, CONFIRM FINAL INSTALL HEIGHT AND PLACEMENT
- WITH OWNER.
- 28 INSTALL ONE ROW OF TACKSTRIP AT 5'-0" AFF. 29 NEW TOILET/URINAL PARTITIONS.
- 30 ADA GRAB BARS. 31 INSTALL TWO ROWS OF TACKSTRIPS. TOP TACKSTRIP SHALL BE AT 5'-0"AFF, AND SPACED 1'-8" O.C. 32 NEW WALL MURAL / VINYL WALL DECAL AT FULL HEIGHT OF AVAILABLE WALL.




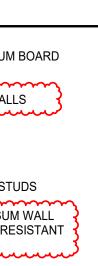


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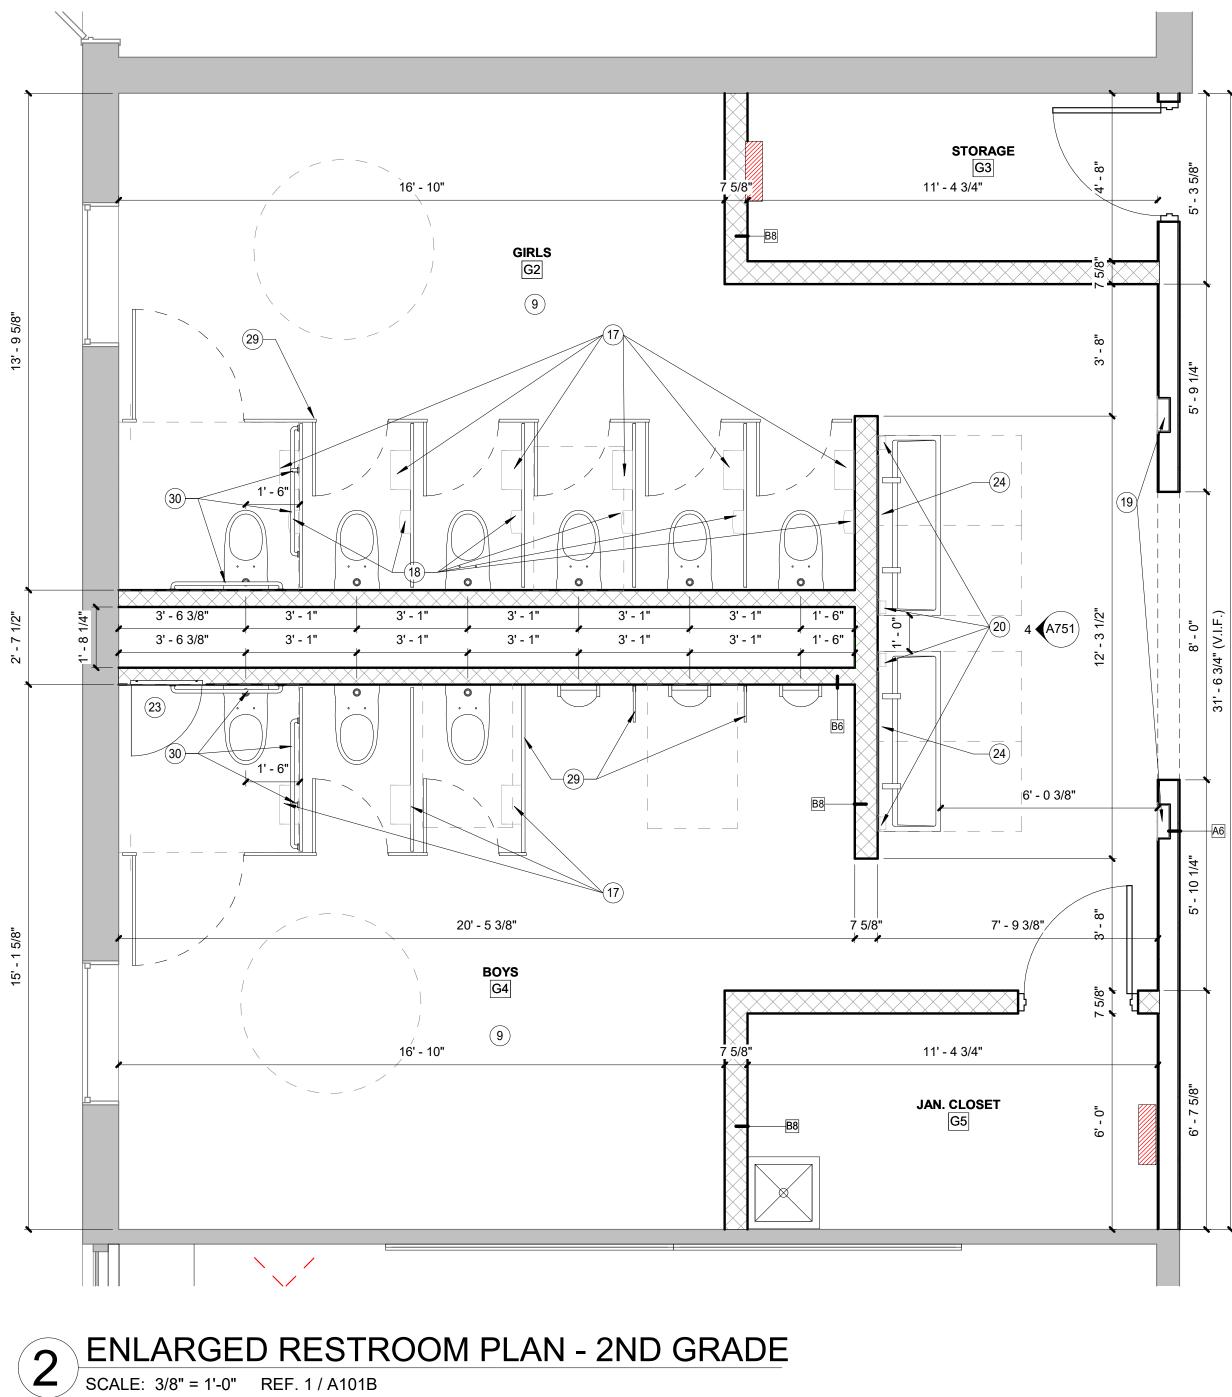
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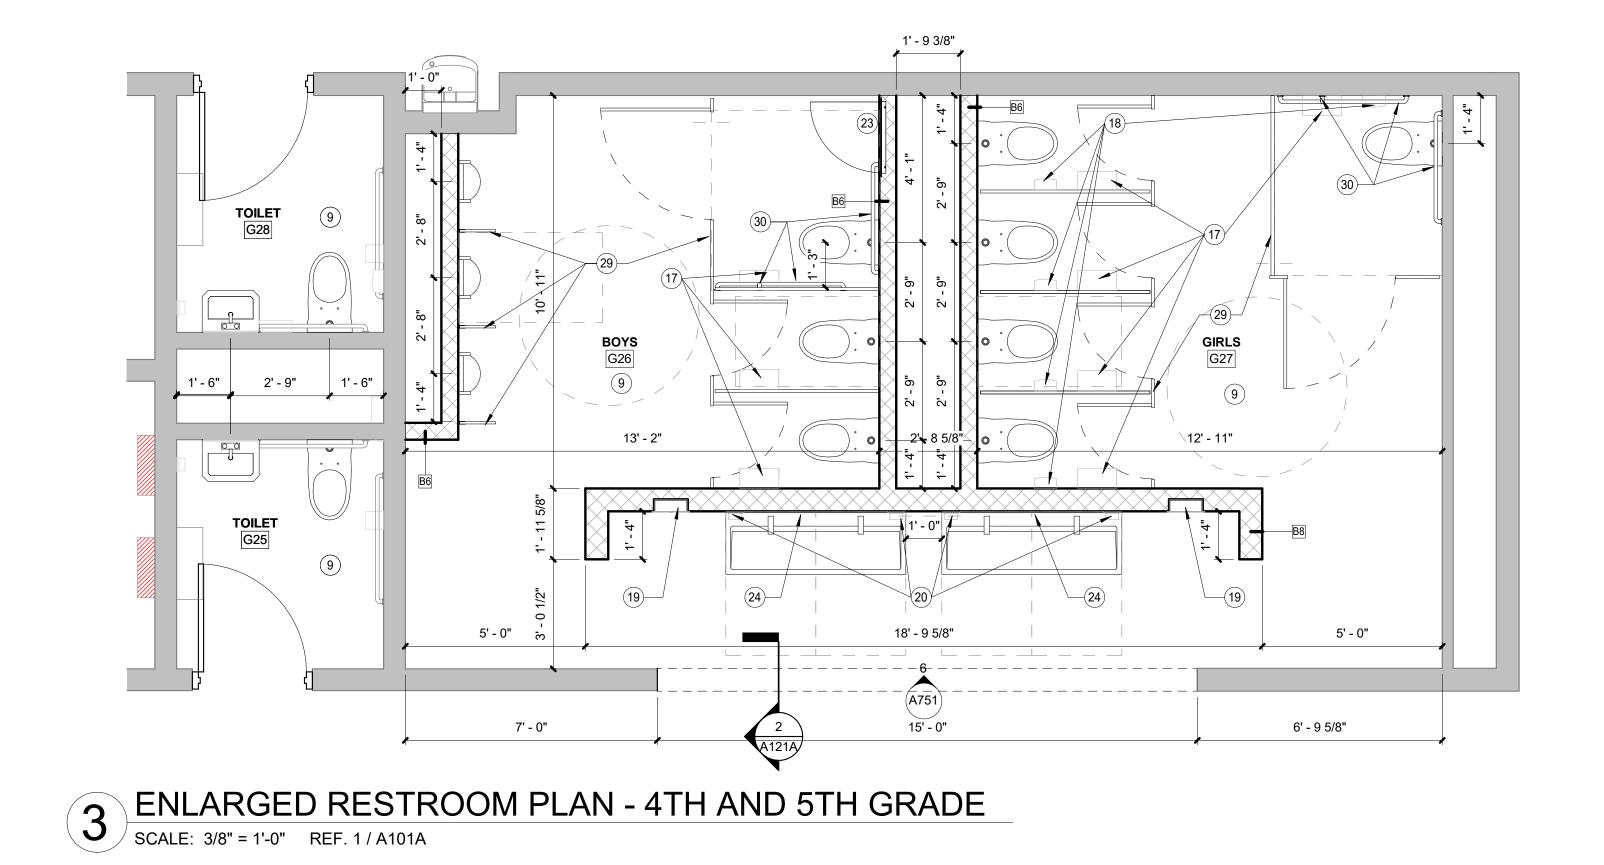


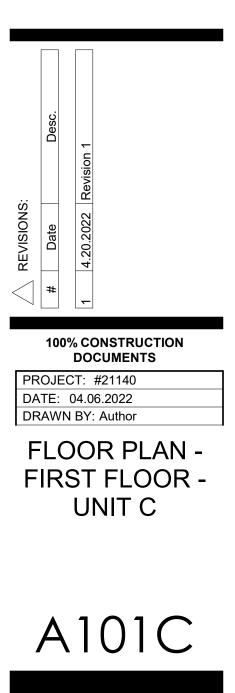


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- 1. PROVIDE HOOKS ON ALL PARTITION DOORS
- 2. PROVIDE HOOKS ON ALL DOORS INTO SINGLE OCCUPANCY RESTROOMS 3. MOUNT HOOKS AT 48" AFF MAX IN ALL ACCESSIBLE RESTROOMS

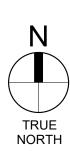
O PLAN NOTES - FLOOR PLAN

- 1 REINSTALL VINYL WALL MURAL. 2 MUSIC PIT INFILL. REFER TO STRUCTURAL DRAWING FOR ADDITIONAL DETAILS. ALTERNATE BID.
- 3 REINSTALL MARKERBOARDS AND TACKBOARDS WITH TRACKS AS REQUIRED BY MANUFACTURER. MARKERBOARDS AND TACKBOARDS PROVIDED BY OWNER.
- 4 NEW CASEWORK, REFER TO CASEWORK ELEVATIONS. 5 WALL MOUNTED WALL PADDING FLOOR TO CEILING.
- 6 MASONARY RESTORATION WORK. REFER TO S-SERIES DRAWINGS. 8 INSTALL NEW ALUMINUM EXTERIOR DOORS. REFER TO DOOR SCHEDULE AND
- SPECIFICATIONS. 9 NEW PLUMBING FIXTURES. REFER TO P-SERIES.
- 10 NEW COUNTERTOP OVER EXISITNG CABINETS.
- 11 REINSTALL SALVAGED CASEWORK AS BASE BID. OMIT REINSTALLTION IF ALTERNATE IS ACCEPTED.
- 12 INSTALL NEW WALL FINISH SURROUND TO 4'-0" AFF. REF FINISH LEGEND. 13 LED SCOREBOARDS AS ALTERNATE. REF E-SERIES.
- 14 NEW CASEWORK AS ALTERNATE. REFER TO CASEWORK ELEVATIONS. 15 INSTALL NEW HOLLOW METAL EXTERIOR DOORS AND FRAMES. REFER TO DOOR
- SCHEDULE AND SPECIFICATIONS. 16 FINISH SURFACE OF WALL TO ALIGN WITH EXISTING WALL PLANES. INSTALL FURRING AS REQUIRED.
- 17 NEW TOILET PAPER DISPENSERS.
- 18 NEW SANITARY NAPKIN DISPOSAL CONTAINERS.
- 19 NEW RECESSED PAPER TOWEL DISPENSERS. SEE ELEVATIONS FOR ADDITIONAL LOCATIONS. 20 NEW SOAP DISPENSERS. SEE ELEVATIONS FOR ADDITIONAL LOCATIONS.
- 21 INSTALL NEW TACKBOARD, 4'-0"H x 4'-0"W. 22 INSTALL THREE ROWS OF TACKSTRIPS. TOP TACKSTRIP SHALL BE AT 6'-6"AFF, AND
- SPACED 1'-8" O.C. 23 NEW PLUMBING ACCESS PANEL. COORDINATE LOCATION WITH ADJACENT EQUIPMENT AND FIXTURES.
- 24 NEW 3'-0" H x 4'-0" W MIRRORS.
- 25 BASE BID: NEW 8'-0" COUNTERTOP OVER EXISITNG CABINETS. VIF.
- 26 BASE BID: NEW COUNTERTOP OVER EXISITING CABINETS. VIF. 27 REINSTALL EXISTING TACKBOARDS. CONFIRM FINAL INSTALL HEIGHT AND PLACEMENT
- WITH OWNER.
- 28 INSTALL ONE ROW OF TACKSTRIP AT 5'-0" AFF. 29 NEW TOILET/URINAL PARTITIONS.
- 30 ADA GRAB BARS.
- 31 INSTALL TWO ROWS OF TACKSTRIPS. TOP TACKSTRIP SHALL BE AT 5'-0"AFF, AND SPACED 1'-8" O.C. 32 NEW WALL MURAL / VINYL WALL DECAL AT FULL HEIGHT OF AVAILABLE WALL.
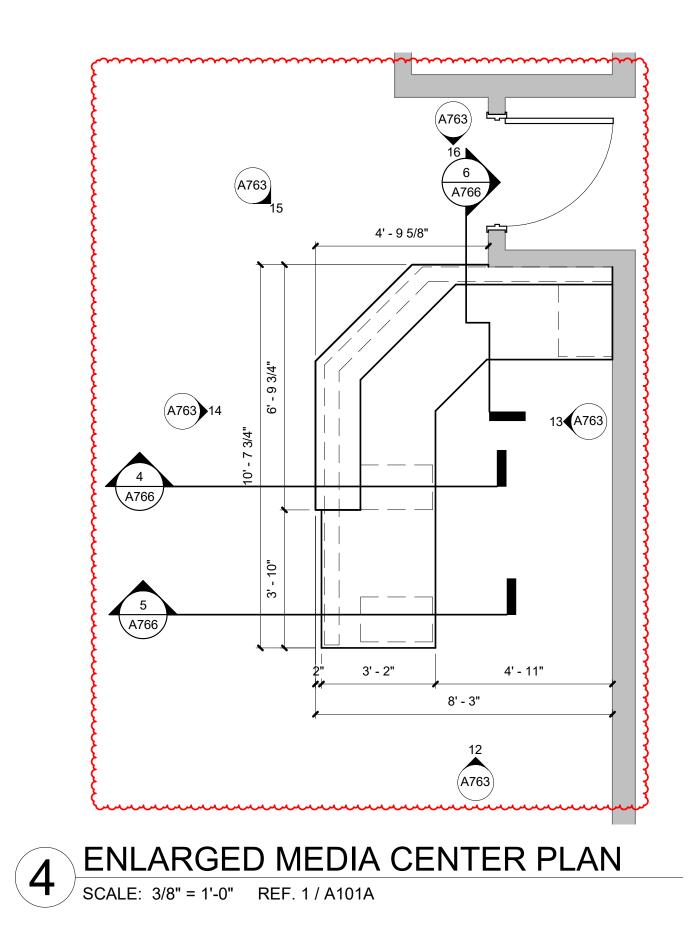
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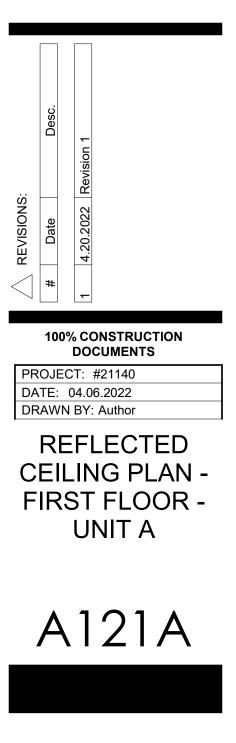
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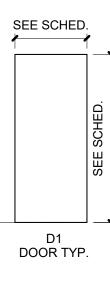
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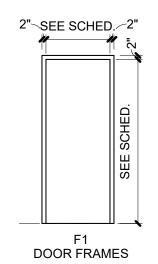
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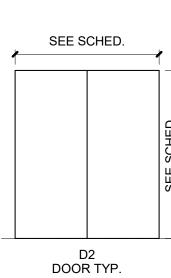
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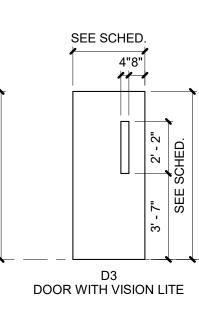


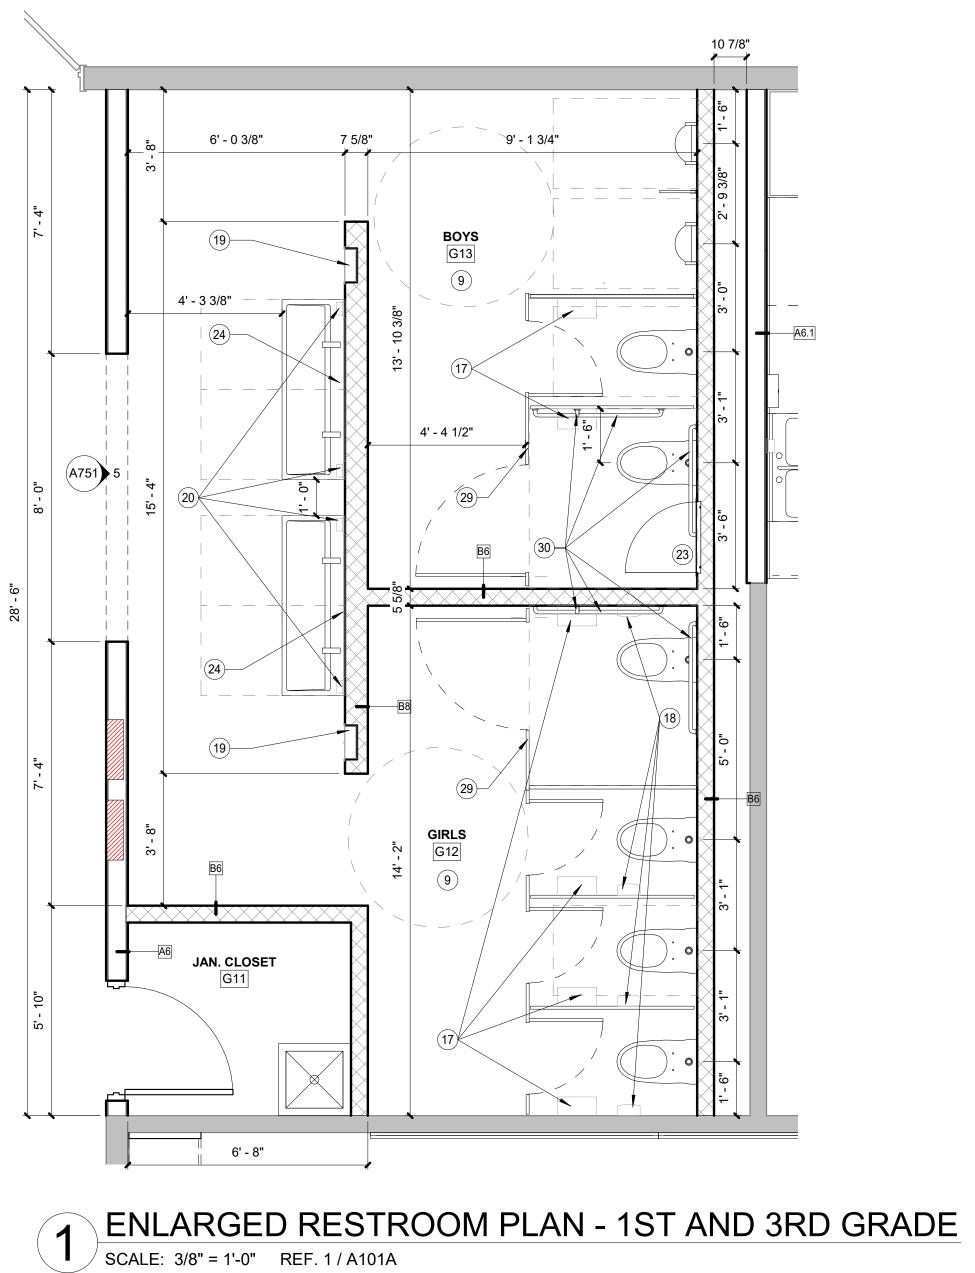


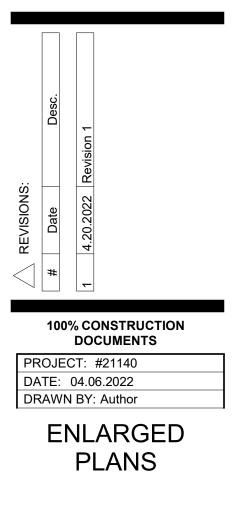

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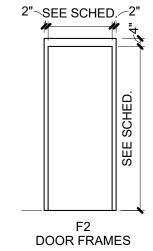





D4 DOOR WITH FULL LITE

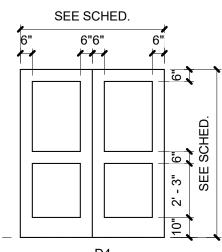								DOON	1				
DR #	ROOM NAME	ROOM #	OVT Hardware Set	HEIGHT	WIDTH		OR MATERIAL	SIZE		MATERIAL	GLAZING	FIRE RATING	NOTES
24.1	3RD GRADE		08	7' - 0"	3' - 0"	D3			EX	HM		20 MIN	
<u>-</u> 26.1	LIFE SKILLS		07	7' - 0"	3' - 0"	D3			EX	HM		20 MIN	
26.2	TOILET		03	7' - 0"	3' - 0"	D1			EX	HM	-	-	
27.1	L.G.I.		19	7' - 0"	3' - 0"	D3			EX	HM	TEMP	20 MIN	
27.2	L.G.I.		18	7' - 0"	3' - 0"	D3			EX	HM	-	20 MIN	
227.3	STORAGE		09	7' - 0"	3' - 0"	D1			EX	HM	-	-	
D28.1	5TH GRADE		07	7' - 0"	3' - 0"	D1			EX	НМ	-	20 MIN	
D28.2	TOILET		03	7' - 0"	3' - 0"	D1			EX	НМ	-	-	
D29.1	5TH GRADE	D29	07	7' - 0"	3' - 0"	D3	WOOD	36" x 84"	EX	НМ	TEMP	20 MIN	
D30.1	5TH GRADE	D30	08	7' - 0"	3' - 0"	D3	WOOD	36" x 84"	EX	НМ	TEMP	20 MIN	
D31.1	5TH GRADE	D31	07	7' - 0"	3' - 0"	D3	WOOD	36" x 84"	EX	НМ	TEMP	20 MIN	
D32.1	5TH GRADE	D32	08	7' - 0"	3' - 0"	D3	WOOD	36" x 84"	EX	HM	TEMP	20 MIN	
D33.1	4TH GRADE	D33	07	7' - 0"	3' - 0"	D3	WOOD	36" x 84"	EX	НМ	TEMP	20 MIN	
E34.1	4TH GRADE	E34	07	7' - 0"	3' - 0"	D3	WOOD	36" x 84"	EX	HM	TEMP	20 MIN	
E35.1	4TH GRADE		07	7' - 0"	3' - 0"	D3			EX	HM	TEMP	20 MIN	
E36.1	4TH GRADE		07	7' - 0"	3' - 0"	D3			EX	HM		20 MIN	
E37.1	4TH GRADE		08	7' - 0"	3' - 0"	D3			EX	HM	TEMP	20 MIN	
E38.1	COMPUTER LAB		07	7' - 0"	3' - 0"	D3			EX	НМ	TEMP	20 MIN	
E38.2	CLOSET		14	7' - 0"	6' - 0"	D2			EX	HM	-	-	
E39.1	MUSIC		19	7' - 0"	3' - 0"	D3			EX	НМ		20 MIN	
E39.2	MUSIC		19	7' - 0"	3' - 0"	D3			EX	НМ		20 MIN	
E17.1	GORRIDOR		17	~Z'~P"~~~~	~ 6'~ ~"~~	ETR			EX	ALUM	EXT		- EXISTING DOOR WITH NEW ACCESS CONTROL SEE ELECTRICAL FOR DETAILS
	MECHANICAL	G1		7' - 0"	3' - 0"	D1			EX	НМ			
					- gu gu u	المراجع المرافع المر	woopun	Senxequin	Fun		- many	20 MIN MAN	upana and a second and a second and a second and a second s
<u> 03.1111</u>	CORRIDOR	1 F2m				Bur						-	
G3.1 G5.1	JAN. CLOSET	G5	12	7' - 0"	3' - 0"	D1	WOOD	36" x 84"	F1	НМ	-	-	
G1.1 G3.1 G5.1 G8.1	JAN. CLOSET TOILET	G5 G8	12 04	7' - 0" 7' - 0"	3' - 0" 3' - 0"	D1 D1	WOOD WOOD	36" x 84" 36" x 84"	F1 EX	HM HM	-	-	
63.1 65.1 68.1 611.1	JAN. CLOSET TOILET	G5 G8 G11	12	7' - 0" 7' - 0"	3' - 0" 3' - 0" 3' - 0"	D1 D1 D1	WOOD WOOD WOOD	36" x 84" 36" x 84" 36" x 84 "	F1 EX	HM HM ₩₩	- -		
G5.1 G8.1 G11.1 G15.1	JAN. CLOSET TOILET JAN-CLOSET WORK	G5 G8 G11 G15	12 04 11	7' - 0" 7' - 0" 7' - 0" 7' - 0"	3' - 0" 3' - 0" 3' - 0" 3' - 0"	D1 D1 D1 D3	WOOD WOOD WOOD WOOD	36" x 84" 36" x 84" <mark>36" x 84" 36" x 84"</mark> 36" x 84"	F1 EX F1 EX	HM HM HM HM	- - -	20 MIN	
63.1 G5.1 G8.1 G11.1 G15.1 G18.1	JAN. CLOSET TOILET JAN-CLOSET WORK WORK	G5 G8 G15 G15 G18	12 04 11 18	7' - 0" 7' - 0" 7' - 0" 7' - 0" 7' - 0"	3' - 0" 3' - 0" 3' - 0" 3' - 0" 3' - 0"	D1 D1 D1 D3 D3	WOOD WOOD WOOD WOOD	36" x 84" 36" x 84" 36" x 84" 36" x 84" 36" x 84"	F1 EX F1 EX EX	HM HM HM HM	- - - - TEMP	20 MIN 20 MIN	
63.1 68.1 68.1 611.1 615.1 618.1 618.2	JAN. CLOSET TOILET JAN. CLOSET WORK MEDIA CENTER MEDIA CENTER	G5 G8 G11 G15 G18 G18 G18	12 04 11 18 18	7' - 0" 7' - 0" 7' - 0" 7' - 0" 7' - 0" 7' - 0" 7' - 0"	3' - 0" 3' - 0" 3' - 0" 3' - 0" 3' - 0" 3' - 0"	D1 D1 D3 D3 D3 D3	WOOD WOOD WOOD WOOD WOOD	36" x 84" 36" x 84" 36" x 84" 36" x 84" 36" x 84" 36" x 84"	F1 EX F1 EX EX EX	HM HM HM HM HM	- - - - TEMP TEMP	20 MIN	
65.1 68.1 611.1 615.1 618.1 618.2 619.1	JAN. CLOSET TOILET JAN-CLOSET WORK MEDIA CENTER MEDIA CENTER SOCIAL WORK	G5 G8 G11 G15 G18 G18 G18 G19.1	12 04 11 18 05	7' - 0" 7' - 0" 7' - 0" 7' - 0" 7' - 0" 7' - 0" 7' - 0" 7' - 0"	3' - 0" 3' - 0" 3' - 0" 3' - 0" 3' - 0" 3' - 0" 3' - 0"	D1 D1 D3 D3 D3 D3 D3 D3	WOOD WOOD WOOD WOOD WOOD WOOD	36" x 84" 36" x 84" 36" x 84" 36" x 84" 36" x 84" 36" x 84" 36" x 84"	F1 EX EX EX EX EX EX	HM HM HM HM HM HM HM	- - - - TEMP TEMP TEMP	20 MIN 20 MIN 20 MIN -	
63.1 65.1 68.1 611.1 615.1 618.1 618.2 619.1 619.2	JAN. CLOSET TOILET JAN-CLOSET WORK MEDIA CENTER MEDIA CENTER SOCIAL WORK CORRIDOR	G5 G8 G15 G15 G18 G18 G19.1 F7	12 04 11 18 05 08	7' - 0" 7' - 0" 7' - 0" 7' - 0" 7' - 0" 7' - 0" 7' - 0" 7' - 0" 7' - 0" 7' - 0"	3' - 0" 3' - 0"	D1 D1 D3 D3 D3 D3 D3 D3 D3 D3 D3	WOOD WOOD WOOD WOOD WOOD WOOD WOOD	36" x 84" 36" x 84"	F1 EX EX EX EX EX EX EX	НМ НМ НМ НМ НМ НМ НМ НМ НМ	- - - - TEMP TEMP TEMP TEMP	20 MIN 20 MIN	
63.1 65.1 68.1 615.1 615.1 618.2 619.1 619.2 619.2A	JAN. CLOSET TOILET JAN. CLOSET WORK WEDIA CENTER MEDIA CENTER SOCIAL WORK CORRIDOR CALM ROOM	G5 G8 G11 G15 G18 G18 G18 G19.1 F7 G19.2	12 04 11 18 05 08 06	7' - 0" 7' - 0" 7' - 0" 7' - 0" 7' - 0" 7' - 0" 7' - 0" 7' - 0" 7' - 0" 7' - 0" 7' - 0" 7' - 0" 7' - 0" 7' - 0"	3' - 0" 3' - 0"	D1 D1 D3 D3 D3 D3 D3 D3 D3 D3 D3 D3 D3	WOOD WOOD WOOD WOOD WOOD WOOD WOOD WOOD	36" x 84" 36" x 84"	F1 EX F1 EX EX EX EX EX EX EX EX	HM HM HM HM HM HM HM HM HM HM	- - - - TEMP TEMP TEMP	20 MIN 20 MIN 20 MIN -	
G3.1 G5.1 G8.1 G15.1 G15.1 G18.1 G18.2 G19.1 G19.2 G19.2A G21.1	JAN. CLOSET TOILET JAN. CLOSET WORK MEDIA CENTER MEDIA CENTER SOCIAL WORK CORRIDOR CALM ROOM HEADEND	G5 G8 G11 G15 G18 G18 G18 G19.1 F7 G19.2 G21	12 04 11 18 05 08 06 05	7' - 0" 7' - 0" 7' - 0" 7' - 0" 7' - 0" 7' - 0" 7' - 0" 7' - 0" 7' - 0" 7' - 0" 7' - 0" 7' - 0" 7' - 0" 7' - 0" 7' - 0" 7' - 0" 7' - 0" 7' - 0"	3' - 0" 3' - 0"	D1 D1 D3 D3 D3 D3 D3 D3 D3 D3 D3 D3 D3 D3 D1	WOOD WOOD WOOD WOOD WOOD WOOD WOOD WOOD	36" x 84" 36" x 84"	F1 EX F1 EX EX EX EX EX EX EX EX EX	HM HM HM HM HM HM HM HM HM HM HM	- - TEMP TEMP TEMP TEMP TEMP TEMP	20 MIN 20 MIN 20 MIN - 20 MIN - -	
G3.1 G5.1 G8.1 G15.1 G18.2 G19.1 G19.2 G19.2A G21.1 G22.1	JAN. CLOSET TOILET JAN-CLOSET WORK MEDIA CENTER MEDIA CENTER SOCIAL WORK CORRIDOR CALM ROOM HEADEND MECH.	G5 G8 G15 G15 G18 G18 G18 G19.1 F7 G19.2 G21 G22	12 04 11 18 05 08 06 05 16	7' - 0" 7' - 0" 7' - 0" 7' - 0" 7' - 0" 7' - 0" 7' - 0" 7' - 0" 7' - 0" 7' - 0" 7' - 0" 7' - 0" 7' - 0" 7' - 0" 7' - 0" 7' - 0" 7' - 0" 7' - 0" 7' - 0" 7' - 0"	3' - 0" 3' - 0" 6' - 0"	D1 D1 D3 D3 D3 D3 D3 D3 D3 D3 D3 D3 D3 D1 D2	WOOD WOOD WOOD WOOD WOOD WOOD WOOD WOOD	36" x 84" 36" x 84"	F1 EX F1 EX EX EX EX EX EX EX EX EX EX	HM HM HM HM HM HM HM HM HM HM HM	- - - - TEMP TEMP TEMP TEMP TEMP - -	20 MIN 20 MIN 20 MIN - 20 MIN - 20 MIN	
G3.1 G5.1 G8.1 G11.1 G15.1 G18.2 G19.1 G19.2 G19.2A G21.1 G22.1 G23.1	JAN. CLOSET TOILET JAN. CLOSET WORK WEDIA CENTER MEDIA CENTER SOCIAL WORK CORRIDOR CALM ROOM HEADEND MECH. RESOURCE	G5 G8 G15 G18 G19.1 F7 G19.2 G21 G22 G23	12 04 11 18 05 08 06 05 16 07	7' - 0" 7' - 0"	3' - 0" 3' - 0"	D1 D1 D3 D3 D3 D3 D3 D3 D3 D3 D3 D3 D1 D2 D3 D3 D1 D2 D3	WOOD WOOD WOOD WOOD WOOD WOOD WOOD WOOD	36" x 84"	F1 EX F1 EX EX EX EX EX EX EX EX EX EX EX	HM HM HM HM HM HM HM HM HM HM HM HM HM	- - - TEMP TEMP TEMP TEMP TEMP - - - - TEMP	20 MIN 20 MIN 20 MIN - 20 MIN - 20 MIN 20 MIN	
G3.1 G5.1 G8.1 G11.1 G15.1 G18.2 G19.1 G19.2 G19.2 G19.2A G21.1 G22.1 G23.1 G24.1	JAN. CLOSET TOILET JAN. CLOSET WORK MEDIA CENTER MEDIA CENTER SOCIAL WORK CORRIDOR CALM ROOM HEADEND MECH. RESOURCE STORAGE	G5 G8 G15 G18 G19.1 F7 G19.2 G21 G22 G23 G24	12 04 11 18 05 08 06 05 16 07 11	7' - 0" 7' - 0"	3' - 0" 3' - 0"	D1 D1 D3 D3 D3 D3 D3 D3 D3 D3 D3 D3 D1 D2 D3 D1 D1 D1	WOOD WOOD WOOD WOOD WOOD WOOD WOOD WOOD	36" x 84" 36" x 84"	F1 EX F1 EX EX EX EX EX EX EX EX EX EX EX EX	HM HM HM HM HM HM HM HM HM HM HM HM HM H	- - - TEMP TEMP TEMP TEMP TEMP - - - - TEMP -	20 MIN 20 MIN 20 MIN - 20 MIN - - 20 MIN 20 MIN 20 MIN	
S3.1 G5.1 G8.1 G15.1 G15.1 G15.1 G15.1 G15.1 G19.2 G19.2 G19.2A G21.1 G22.1 G23.1 G23.1 G25.1	JAN. CLOSET TOILET JAN. CLOSET WORK MEDIA CENTER MEDIA CENTER SOCIAL WORK CORRIDOR CALM ROOM HEADEND MECH. RESOURCE STORAGE TOILET	G5 G8 G15 G18 G19.1 F7 G19.2 G21 G22 G23 G24 G25	12 04 11 18 18 05 08 06 05 16 07 11 04	$\begin{array}{c} 7' - 0" \\$	$\begin{array}{c} 3' - 0'' \\ 3' - 0'' \\ 3' - 0'' \\ 3' - 0'' \\ 3' - 0'' \\ 3' - 0'' \\ 3' - 0'' \\ 3' - 0'' \\ 3' - 0'' \\ 3' - 0'' \\ 3' - 0'' \\ 3' - 0'' \\ 3' - 0'' \\ 3' - 0'' \\ 3' - 0'' \\ 3' - 0'' \\ 3' - 0'' \\ 3' - 0'' \end{array}$	D1 D1 D3 D3 D3 D3 D3 D3 D3 D3 D3 D3 D1 D2 D3 D1 D2 D3 D1 D1 D1	WOOD WOOD WOOD WOOD WOOD WOOD WOOD WOOD	36" x 84" 36" x 84"	F1 EX F1 EX EX EX EX EX EX EX EX EX EX EX EX EX	HM HM HM HM HM HM HM HM HM HM HM HM HM H	- - - TEMP TEMP TEMP TEMP - - - - TEMP - - - -	20 MIN 20 MIN 20 MIN - 20 MIN - - 20 MIN 20 MIN 20 MIN 20 MIN	
93.1 95.1 95.1 98.1 911.1 911.1 918.2 919.1 919.2 919.2 921.1 922.1 923.1 924.1 925.1 928.1	JAN. CLOSET TOILET JAN-CLOSET WORK MEDIA CENTER MEDIA CENTER SOCIAL WORK CORRIDOR CALM ROOM HEADEND MECH. RESOURCE STORAGE TOILET TOILET	G5 G8 G11 G15 G18 G19.1 F7 G19.2 G21 G22 G23 G24 G25 G28	12 04 11 18 05 08 06 05 16 07 11 04 04	$\begin{array}{c} 7' - 0" \\$	3' - 0" 3' - 0"	D1 D1 D3 D3 D3 D3 D3 D3 D3 D3 D3 D3 D1 D2 D3 D1 D2 D3 D1 D1 D1 D1	WOOD WOOD WOOD WOOD WOOD WOOD WOOD WOOD	36" x 84" 36" x 84"	F1 EX F1 EX EX EX EX EX EX EX EX EX EX EX EX EX	HM HM HM HM HM HM HM HM HM HM HM HM HM H	- - - TEMP TEMP TEMP TEMP - - - TEMP - - - TEMP - - - - -	20 MIN 20 MIN 20 MIN - 20 MIN - 20 MIN 20 MIN 20 MIN 20 MIN 20 MIN 20 MIN	
93.1 G5.1 G8.1 G11.1 G15.1 G18.2 G19.1 G19.2 G19.2A G21.1 G22.1 G23.1 G25.1 G25.1 G25.1 G29.1	JAN. CLOSET TOILET JAN. CLOSET WORK WEDIA CENTER MEDIA CENTER SOCIAL WORK CORRIDOR CALM ROOM HEADEND MECH. RESOURCE STORAGE TOILET TOILET STORAGE	G5 G8 G11 G15 G18 G19.1 F7 G19.2 G21 G22 G23 G24 G25 G28 G29	12 04 11 18 18 05 08 06 05 16 07 11 04 04 04 11	$\begin{array}{c ccccccccccccccccccccccccccccccccccc$	3' - 0" 3' - 0"	D1 D1 D3 D3 D3 D3 D3 D3 D3 D3 D3 D3 D3 D1 D2 D3 D1 D2 D3 D1 D1 D1 D1 D1 D1	WOOD WOOD WOOD WOOD WOOD WOOD WOOD WOOD	36" x 84" 36" x 84"	F1 EX F1 EX EX EX EX EX EX EX EX EX EX EX EX EX	HM HM HM HM HM HM HM HM HM HM HM HM HM H	- - - TEMP TEMP TEMP TEMP - - - - TEMP - - - - - - - - - - - - - - - - - - -	20 MIN 20 MIN 20 MIN - 20 MIN - - 20 MIN 20 MIN 20 MIN 20 MIN 20 MIN 20 MIN	
G3.1 G5.1 G8.1 G11.1 G15.1 G18.2 G19.1 G19.2 G19.2 G21.1 G22.1 G23.1 G25.1 G28.1 G29.1 G40.1	JAN. CLOSET TOILET JAN. CLOSET WORK MEDIA CENTER MEDIA CENTER SOCIAL WORK CORRIDOR CALM ROOM HEADEND MECH. RESOURCE STORAGE TOILET TOILET STORAGE STORAGE	G5 G8 G11 G15 G18 G19.1 F7 G19.2 G21 G22 G23 G24 G25 G28 G29 G40	12 04 11 18 18 05 05 08 06 05 16 07 11 04 04 04 11 11	$\begin{array}{c ccccccccccccccccccccccccccccccccccc$	$\begin{array}{c} 3' - 0'' \\ 3' - 0'' \end{array}$	D1 D1 D3 D3 D3 D3 D3 D3 D3 D3 D3 D3 D1 D2 D3 D1 D2 D3 D1 D1 D1 D1 D1 D1 D1 D1 D1 D1 D1 D1 D1	WOOD WOOD WOOD WOOD WOOD WOOD WOOD WOOD	36" x 84" 36" x 84"	F1 EX F1 EX EX EX EX EX EX EX EX EX EX EX EX EX	HM HM HM HM HM HM HM HM HM HM HM HM HM H	- - - TEMP TEMP TEMP TEMP - - - - - - - - - - - - - - - - - - -	20 MIN 20 MIN 20 MIN - 20 MIN - - 20 MIN 20 MIN 20 MIN 20 MIN 20 MIN 20 MIN 20 MIN 20 MIN	
G3.1 G5.1 G8.1 G15.1 G15.1 G18.2 G19.1 G19.2A G21.1 G22.1 G23.1 G25.1 G25.1 G29.1 G29.1 G40.1 G41.1	JAN. CLOSET TOILET JAN. CLOSET WORK MEDIA CENTER MEDIA CENTER SOCIAL WORK CORRIDOR CALM ROOM HEADEND MECH. RESOURCE STORAGE TOILET TOILET STORAGE STORAGE STORAGE	G5 G8 G11 G15 G18 G19.1 F7 G19.2 G21 G22 G23 G24 G25 G28 G29 G40 G41	12 04 11 18 18 05 08 06 05 16 07 11 04 04 04 11 11 15	$\begin{array}{c} 7' - 0" \\$	$\begin{array}{c} 3' - 0'' \\ 6' - 0'' \end{array}$	D1 D1 D3 D3 D3 D3 D3 D3 D3 D3 D3 D3 D1 D2 D3 D1 D1 D1 D1 D1 D1 D1 D1 D1 D1 D1 D1 D1	WOOD WOOD WOOD WOOD WOOD WOOD WOOD WOOD	36" x 84" 36" x 84" 372" x 84"	F1 EX F1 EX EX EX EX EX EX EX EX EX EX EX EX EX	HM HM HM HM HM HM HM HM HM HM HM HM HM H	- - - TEMP TEMP TEMP TEMP - - - - - - - - - - - - - - - - - - -	20 MIN 20 MIN 20 MIN - 20 MIN - - 20 MIN 20 MIN 20 MIN 20 MIN 20 MIN 20 MIN	
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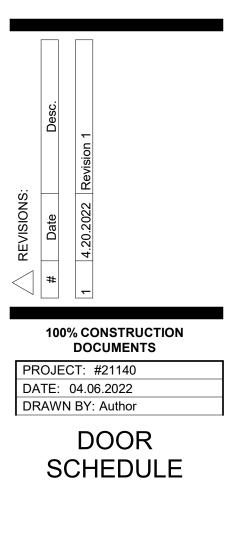
DOOR SCHEDULE




1 CMU/BRICK EXISTING WALL NEW FRAME HEAD SCALE: 3" = 1'-0"




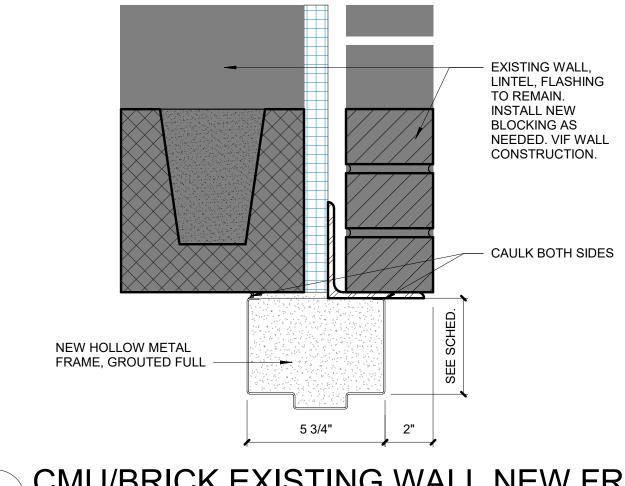



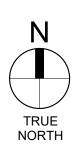



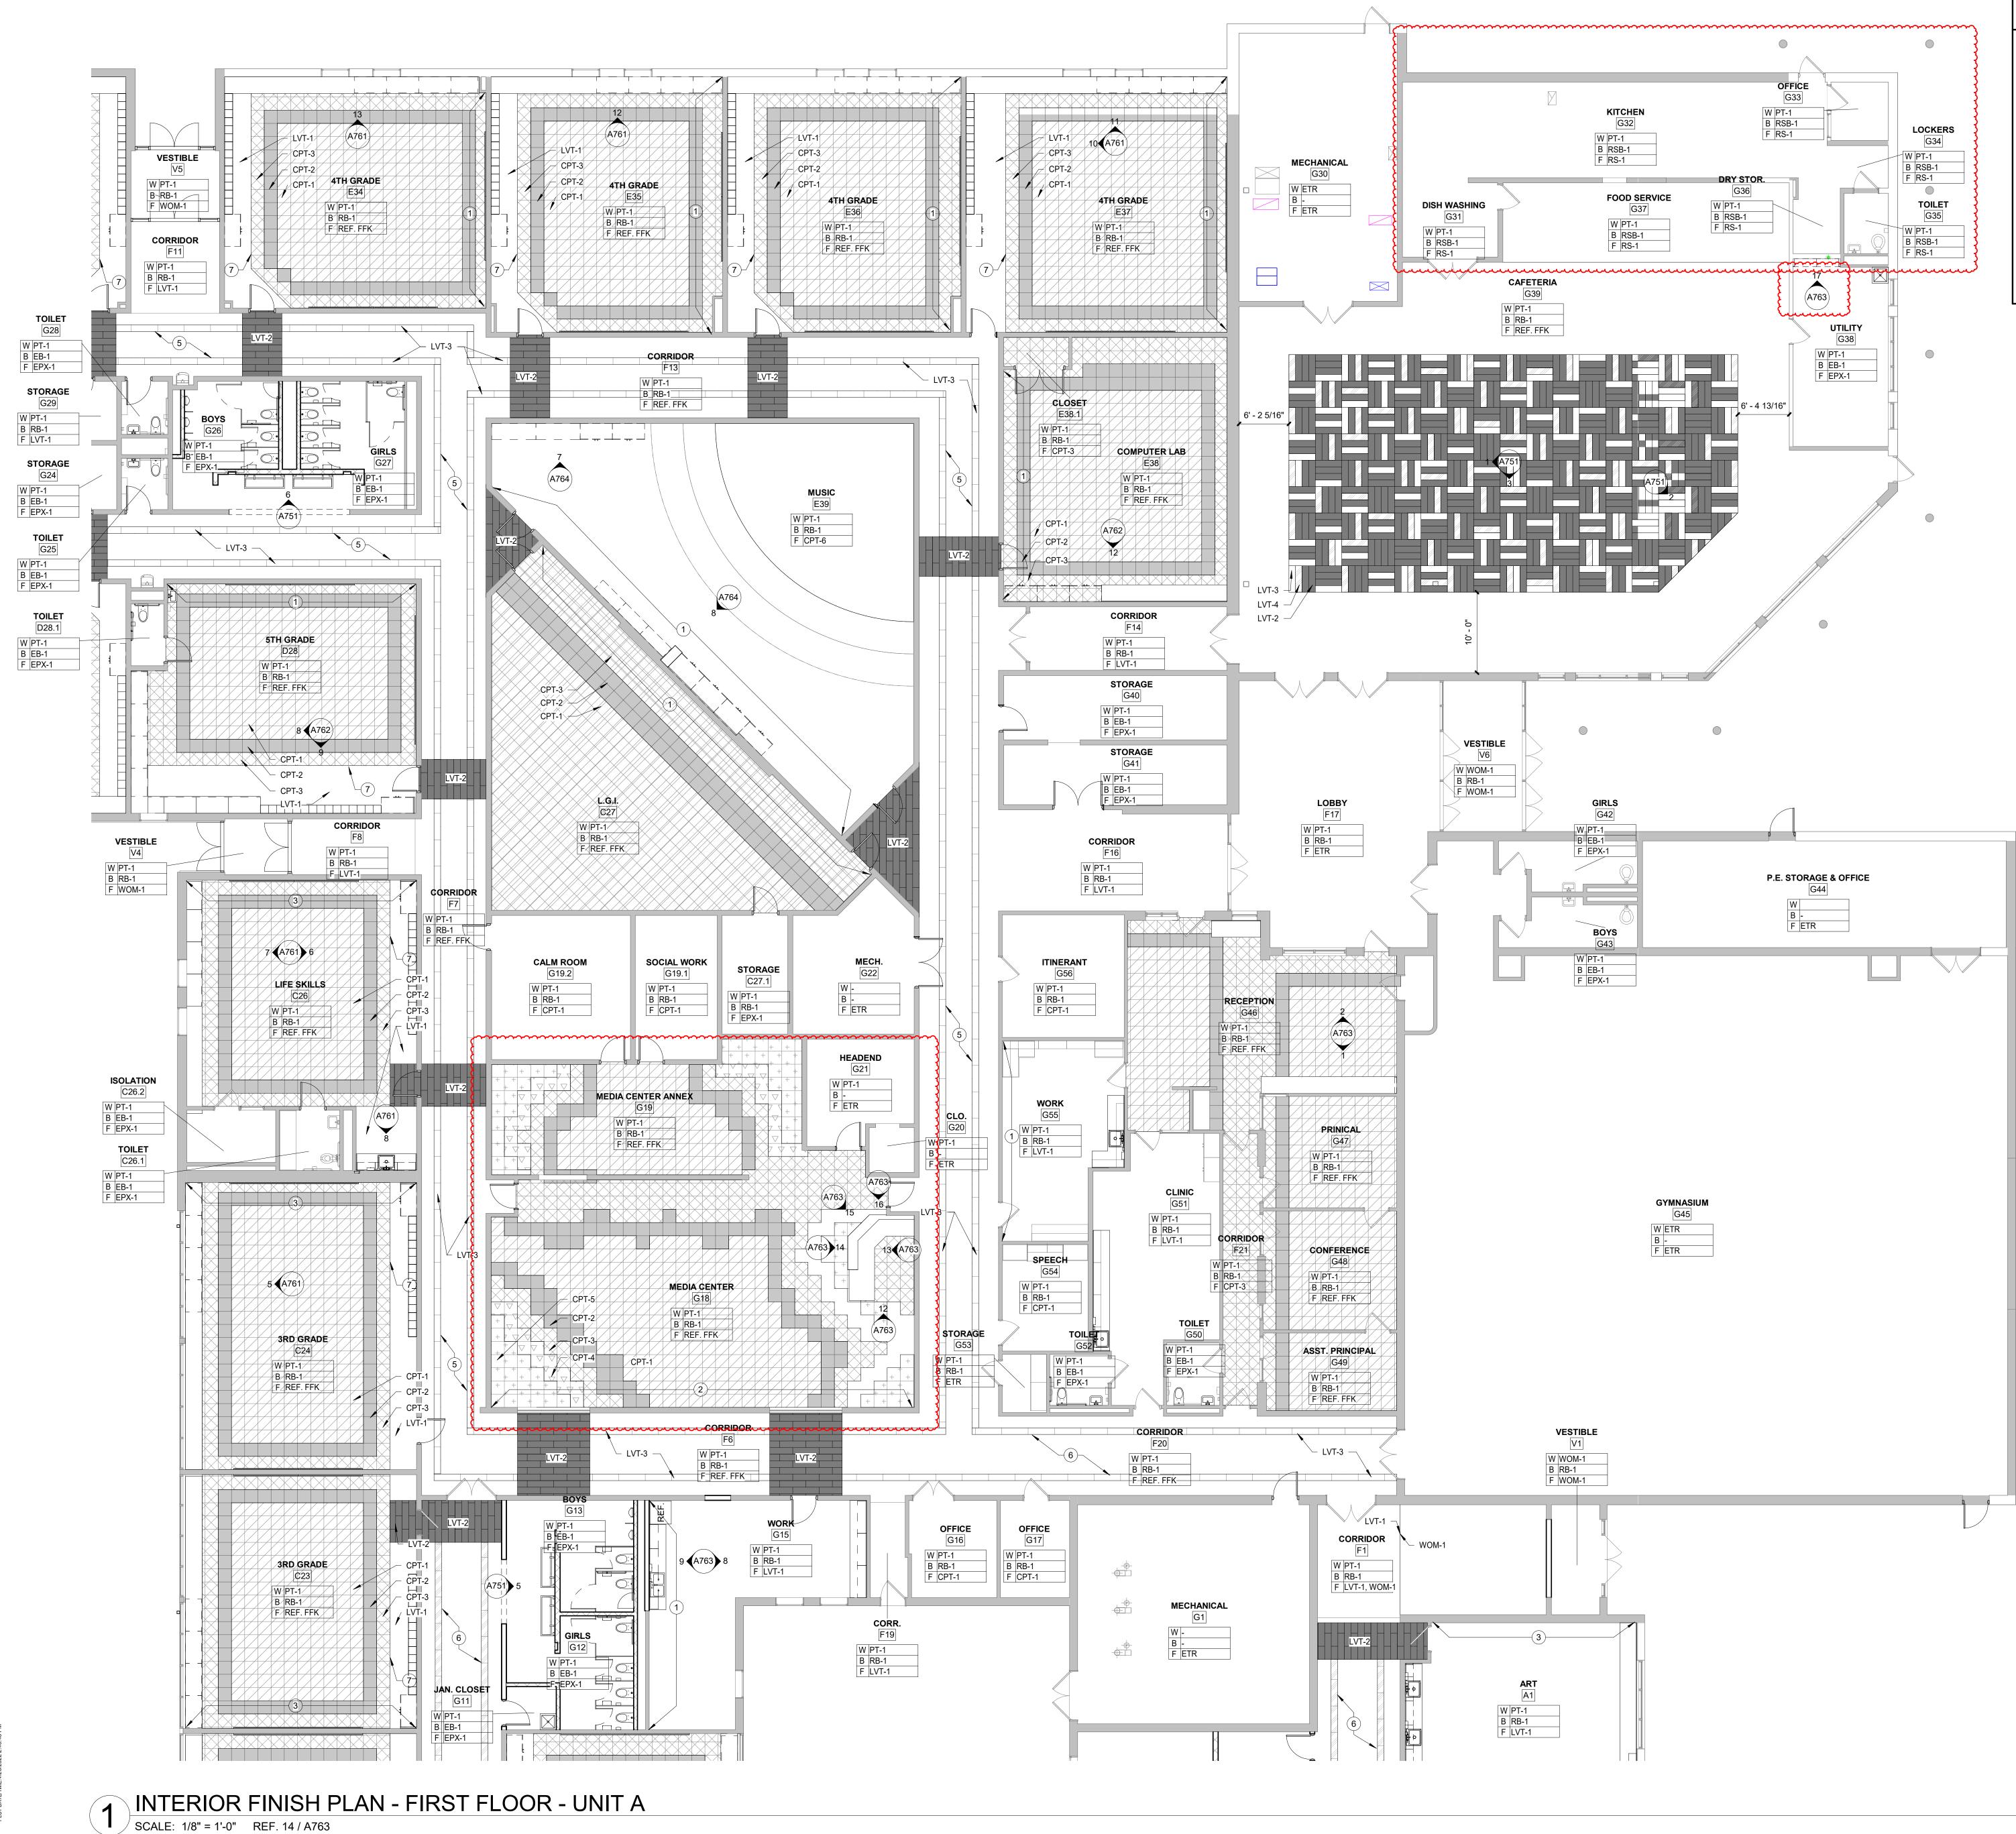


GENERAL NOTES

- 1. PROVIDE DRYWALL REVEAL JOINT WHERE DRYWALL MEETS DISSIMILAR MATERIALS
- 2. PROVIDE SCHLUTER EDGE WHERE TILE MEETS DISSIMILAR MATERIALS 3. DO NOT INSTALL RUBBER WALL BASE IN FRONT OF THE TILE
- 4. DO NOT INSTALL GYPSUM BOARD BEHIND TILE BACKER BOARD
- 5. WHERE ONLY PAINT IS INDICATED AS A FINISH, REFER TO PLANS FOR SUBSTRATE
- 6. PAINT EXPOSED STEEL COLUMNS IN CAFETERIA PT-2
- 7. PAINT HM WINDOW FRAMES AND EXTERIOR HM DOORS PT-2
- 8. PAINT INTERIOR HM DOORS PT-2
- 9. GRIND DOWN THE EDGE OF TERRAZZO WHERE IT MEETS DISSIMILAR FLOORING 10. ALL PAINT INSIDE RESTROOMS, CORRIDORS, AND KITCHEN TO BE EPOXY BASED PAINT 11. PAINT PLAIN GYPSUM BOARD CEILING PT-1 UNLESS OTHERWISE INDICATED ON FINISH
- PLANS AND REFLECTED CEILING PLANS 12. IF A ROOM HAS NO FLOORING HATCH PATTERN, SEE ROOM TAG FOR FLOORING.
- 13. PROVIDE SCHLUTER EDGE TRIM WHERE TILE EDGE IS EXPOSED

PLAN NOTES - FINISH PLAN \bigcirc


- 1 PROVIDE ACCENT PAINT (PT-3) WALL AT THIS LOCATION. REF FINISH LEGEND. 2 PROVIDE ACCENT PAINT (PT-4) WALL AT THIS LOCATION. REF FINISH LEGEND.
- 3 PROVIDE ACCENT PAINT (PT-5) WALL AT THIS LOCATION. REF FINISH LEGEND.
- 4 FRP (WP-1) AT THIS LOCATION. REF FINISH LEGEND 5 USE TWO FULL TILES OF LVT-1 CENTERED IN CORRIDOR.
- 6 USE THREE FULL TILES OF LVT-1 CENTERED IN CORRIDOR. 7 START FULL FLOORING TILE HERE.

FINISH FLOOR KEY (FFK)

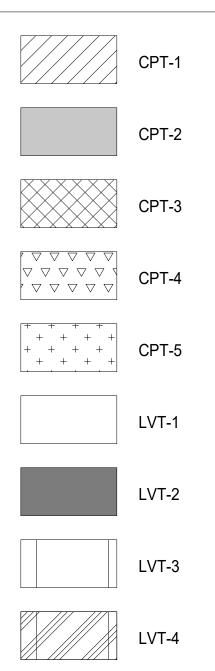



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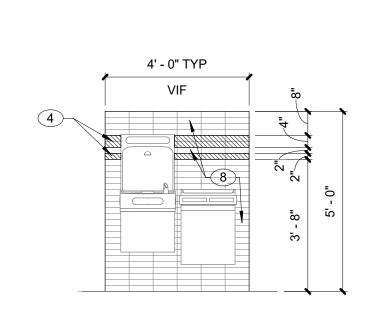
TRUE NORTH



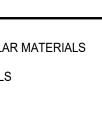




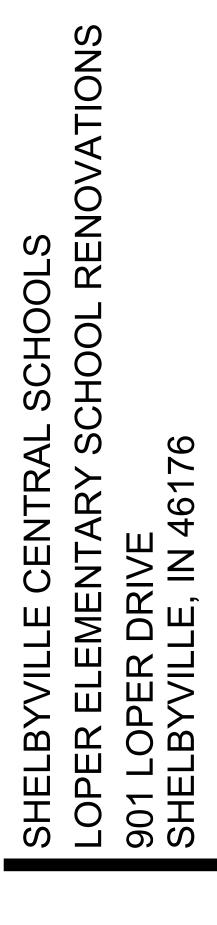

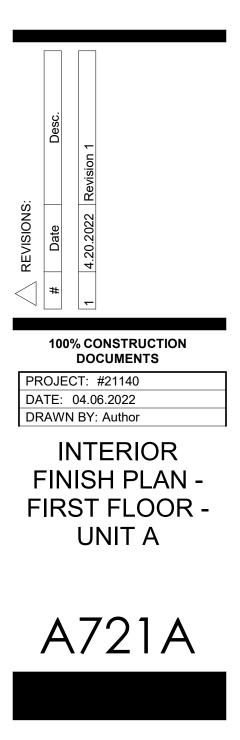



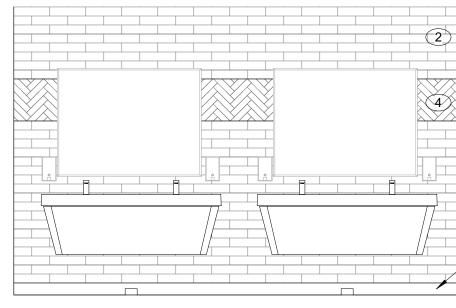





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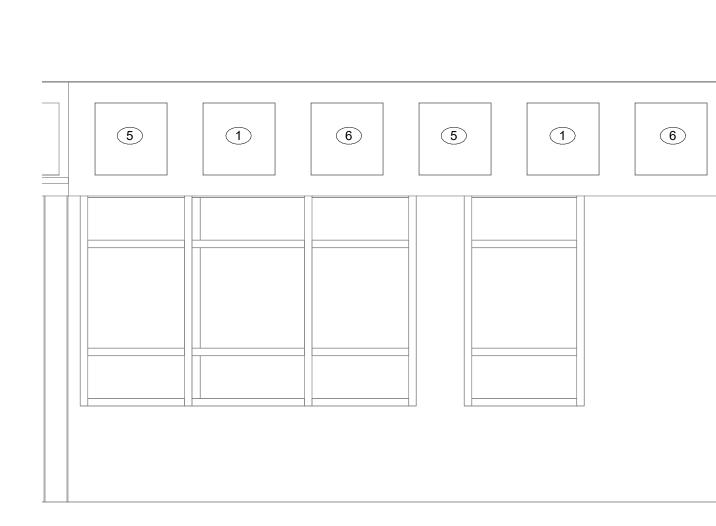
2 CAFETERIA ELEVATION - SOUTHEAST SCALE: 3/8" = 1'-0" REF. 1 / A101A








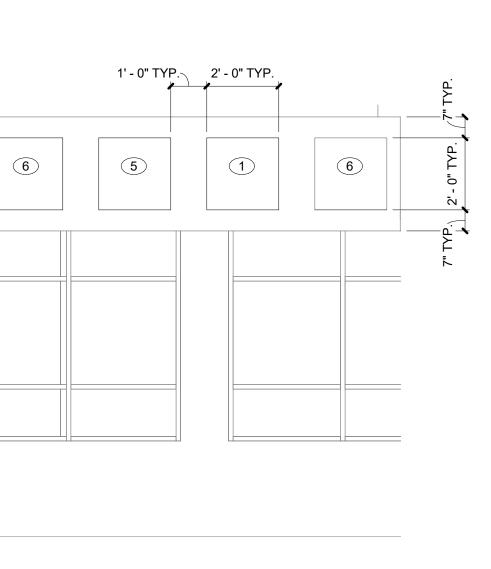

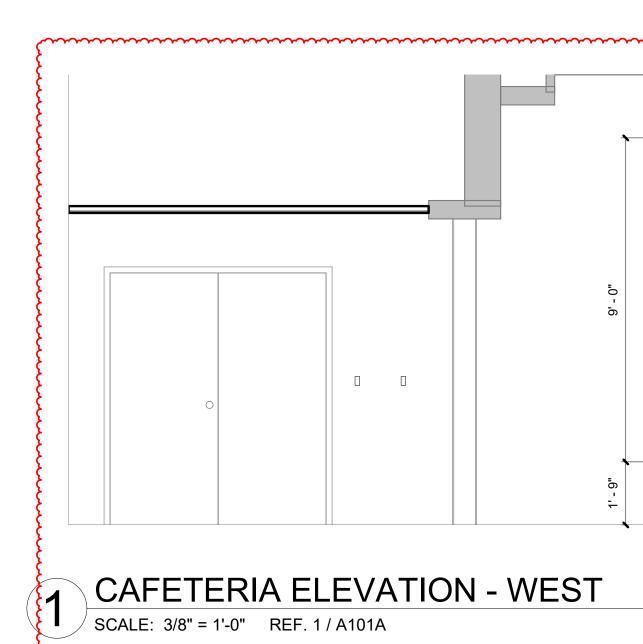

6 G26 & G27 RESTROOM ELEVATION SCALE: 3/8" = 1'-0" REF. 1 / A101A

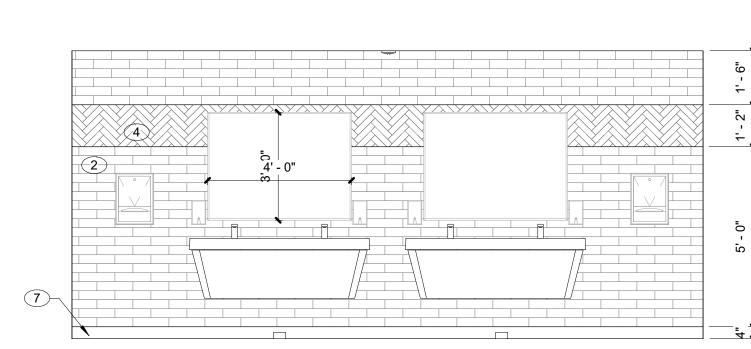


GENERAL NOTES


1. PROVIDE SCHLUTER TRIM WHERE TILE MEETS DISSIMILAR MATERIALS 2. DO NOT INSTALL GYPSUM BOARD BEHIND BACKER BOARD WHERE TILE FINISH IS INDICATED 3. VERIFY ALL WATER FOUNTAIN LOCATIONS IN FEILD


ELEVATION NOTES - INTERIOR


- 1 ACOUSTICAL PANELS (AP-1). REF FINISH LEGEND 2 WALL TILE 1 (WT-1). REF FINISH LEGEND
- 3 UPPER CABINETS ABOVE CUBBIES AS ALTERNATE. 4 WALL TILE 2 (WT-2). REF FINISH LEGEND
- 5 ACOUSTICAL PANELS (AP-2). REF FINISH LEGEND
- 6 ACOUSTICAL PANELS (AP-3). REF FINISH LEGEND 7 4" EPOXY BASE (EB-1). USE SCHLUTER JOLLY WHERE TILE AND EPOXY BASE MEET. REF FINISH LEGEND 8 WALL TILE (WT-3). REF FINISH LEGEND
- 9 HEAVY DUTY SHELVING WITH ADJUSTABLE BRACKETS ON TRACK SYSTEM. REF SPECS. 10 ACOUSTICAL PANELS (AP-4). REF FINISH LEGEND.
- 11 WATERFALL SOLID SURFACE SS-1. REF FINISH LEGEND. 12 PROVIDE ACCENT PAINT (PT-2) AND RB-1 AT THIS LOCATION. REF FINISH LEGEND 13 PROVIDE PL-1 AT THIS LOCATION. REF FINISH LEGEND.
- mmm

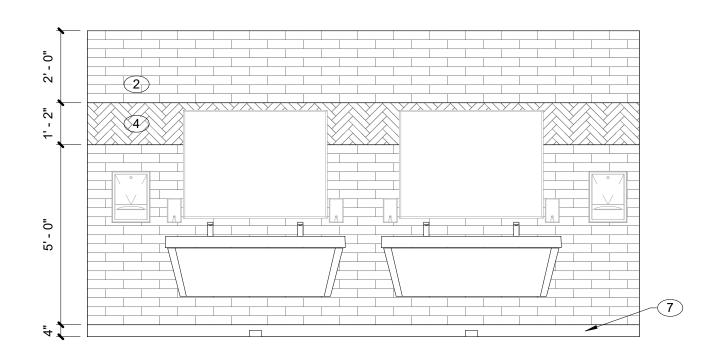


5 G12 & G13 RESTROOM ELEVATION SCALE: 3/8" = 1'-0" REF. 1 / A101A

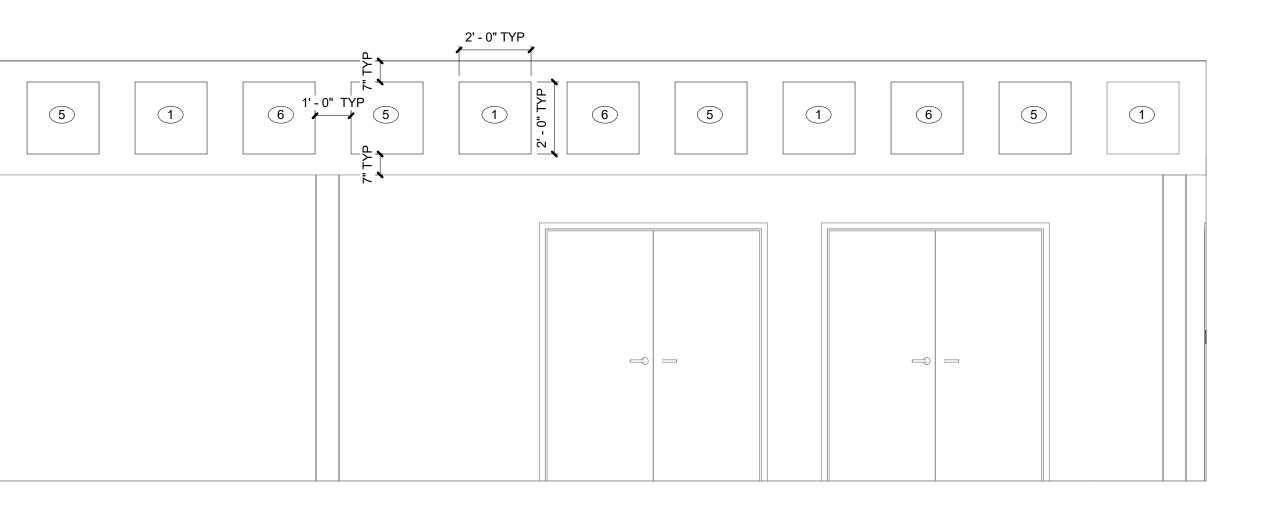


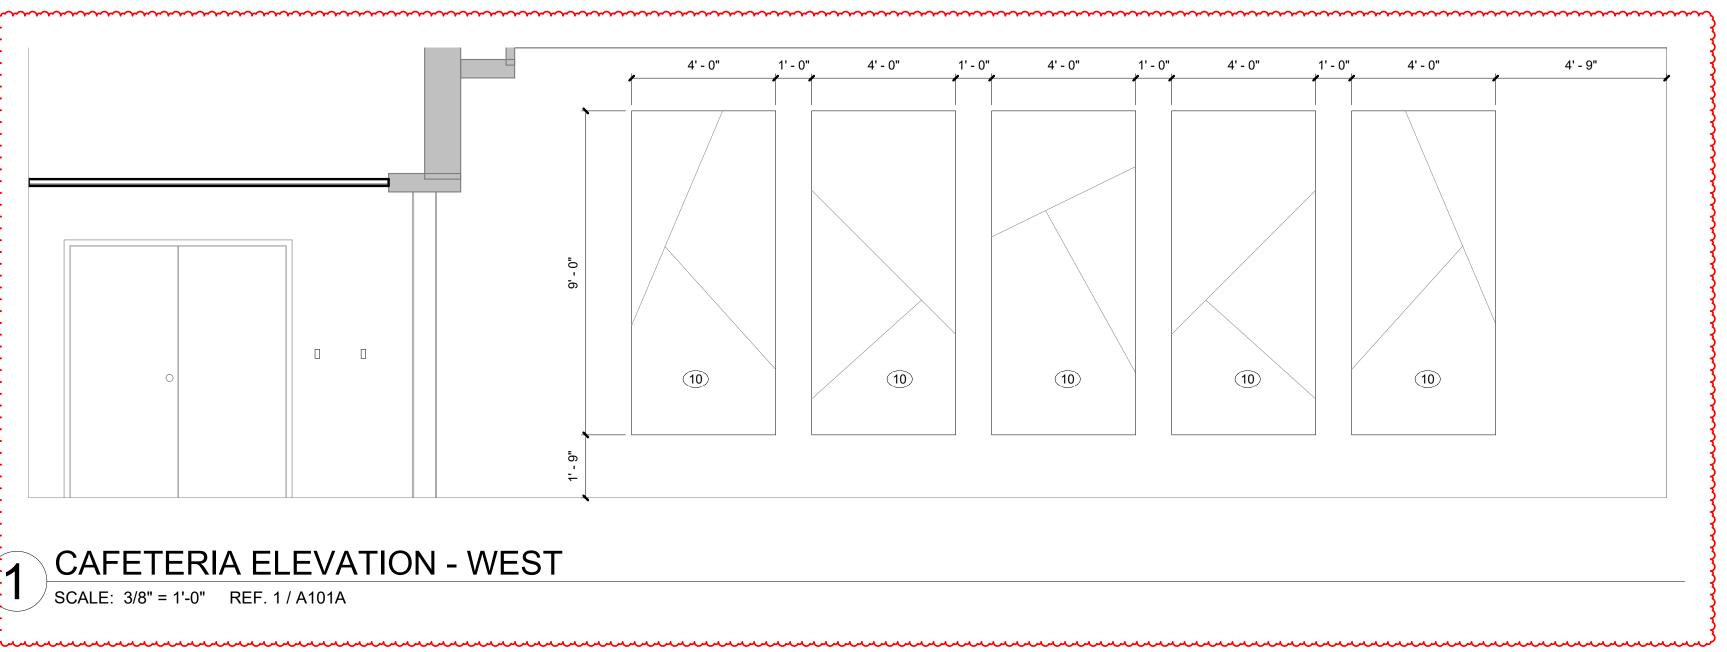


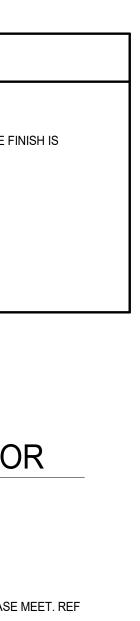




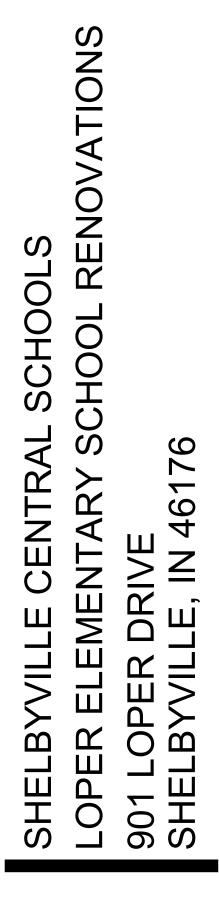

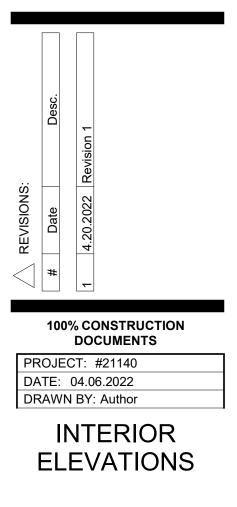

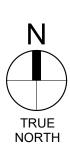



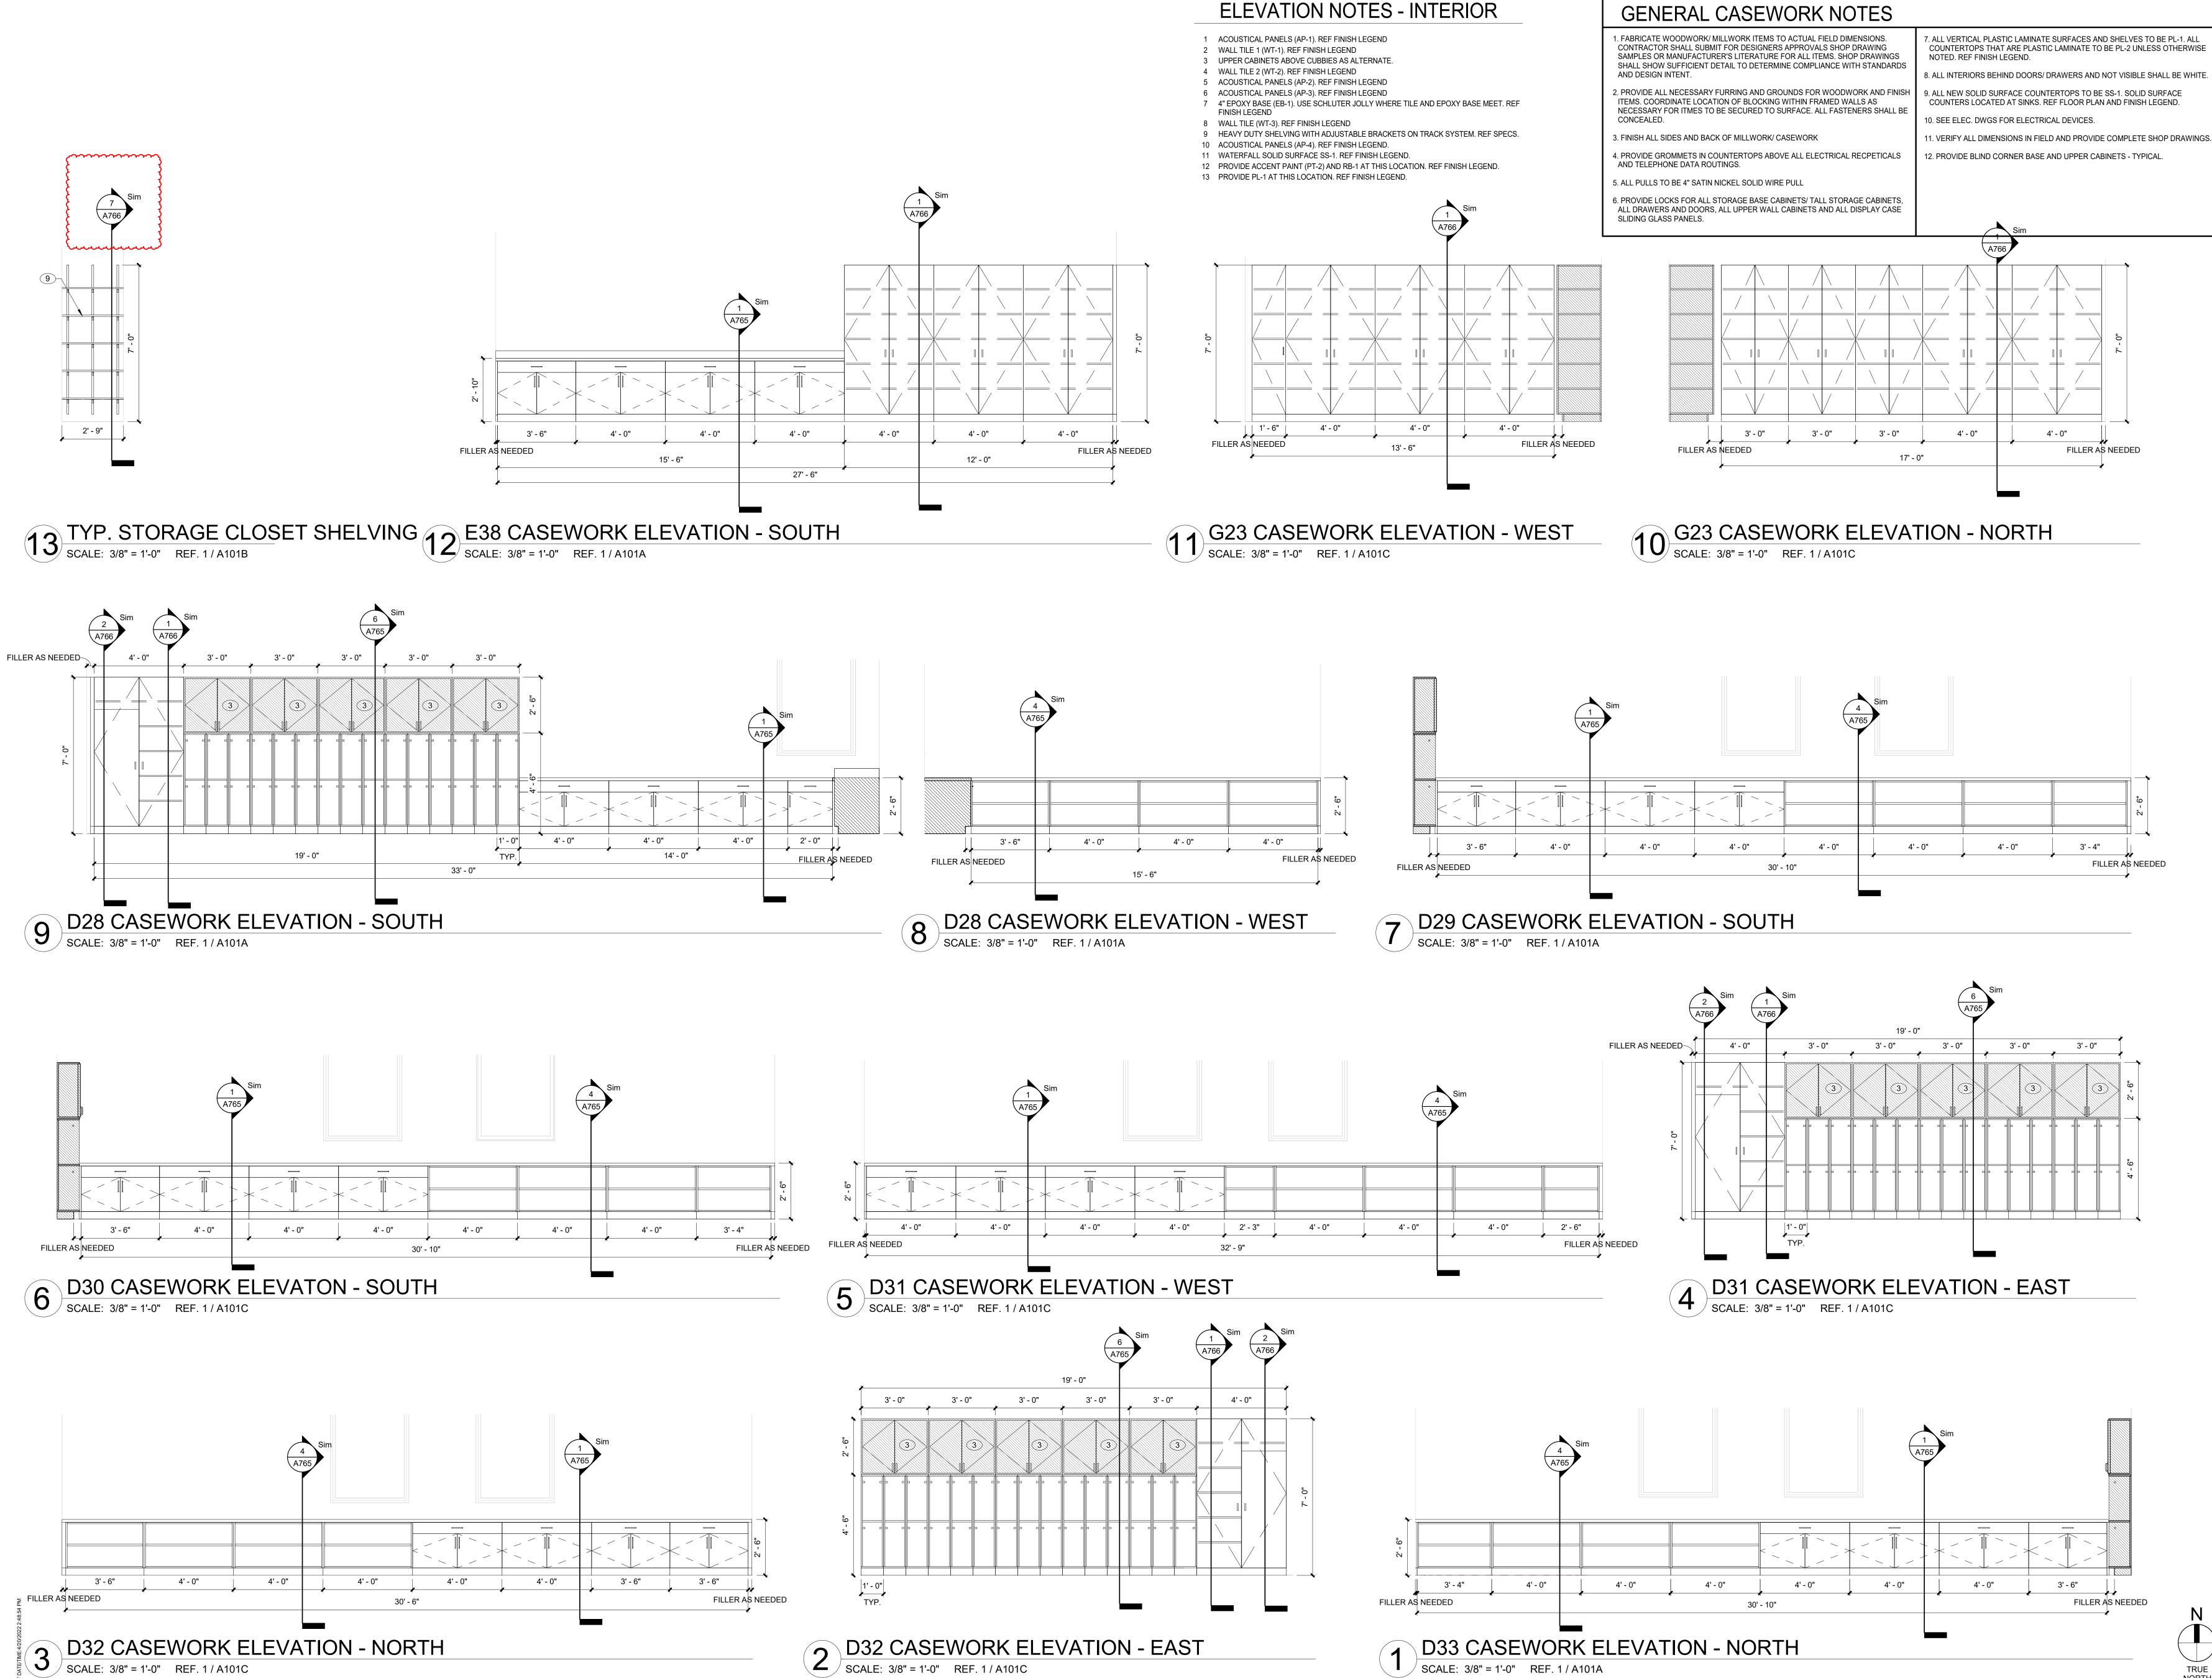



SCALE: 3/8" = 1'-0" REF. 1 / A101C



SCALE: 3/8" = 1'-0" REF. 1 / A101A




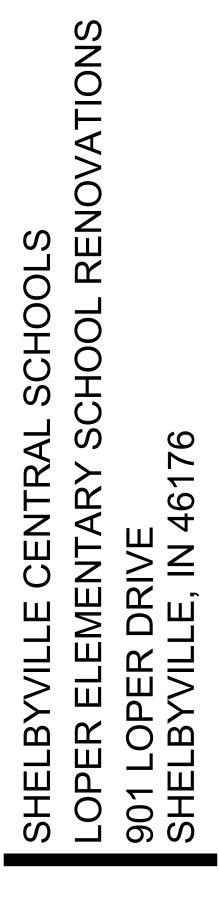


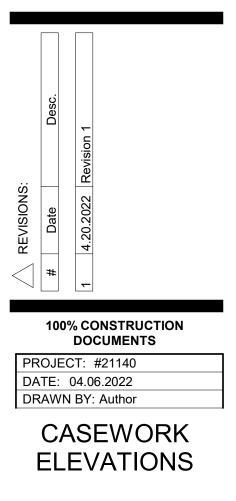







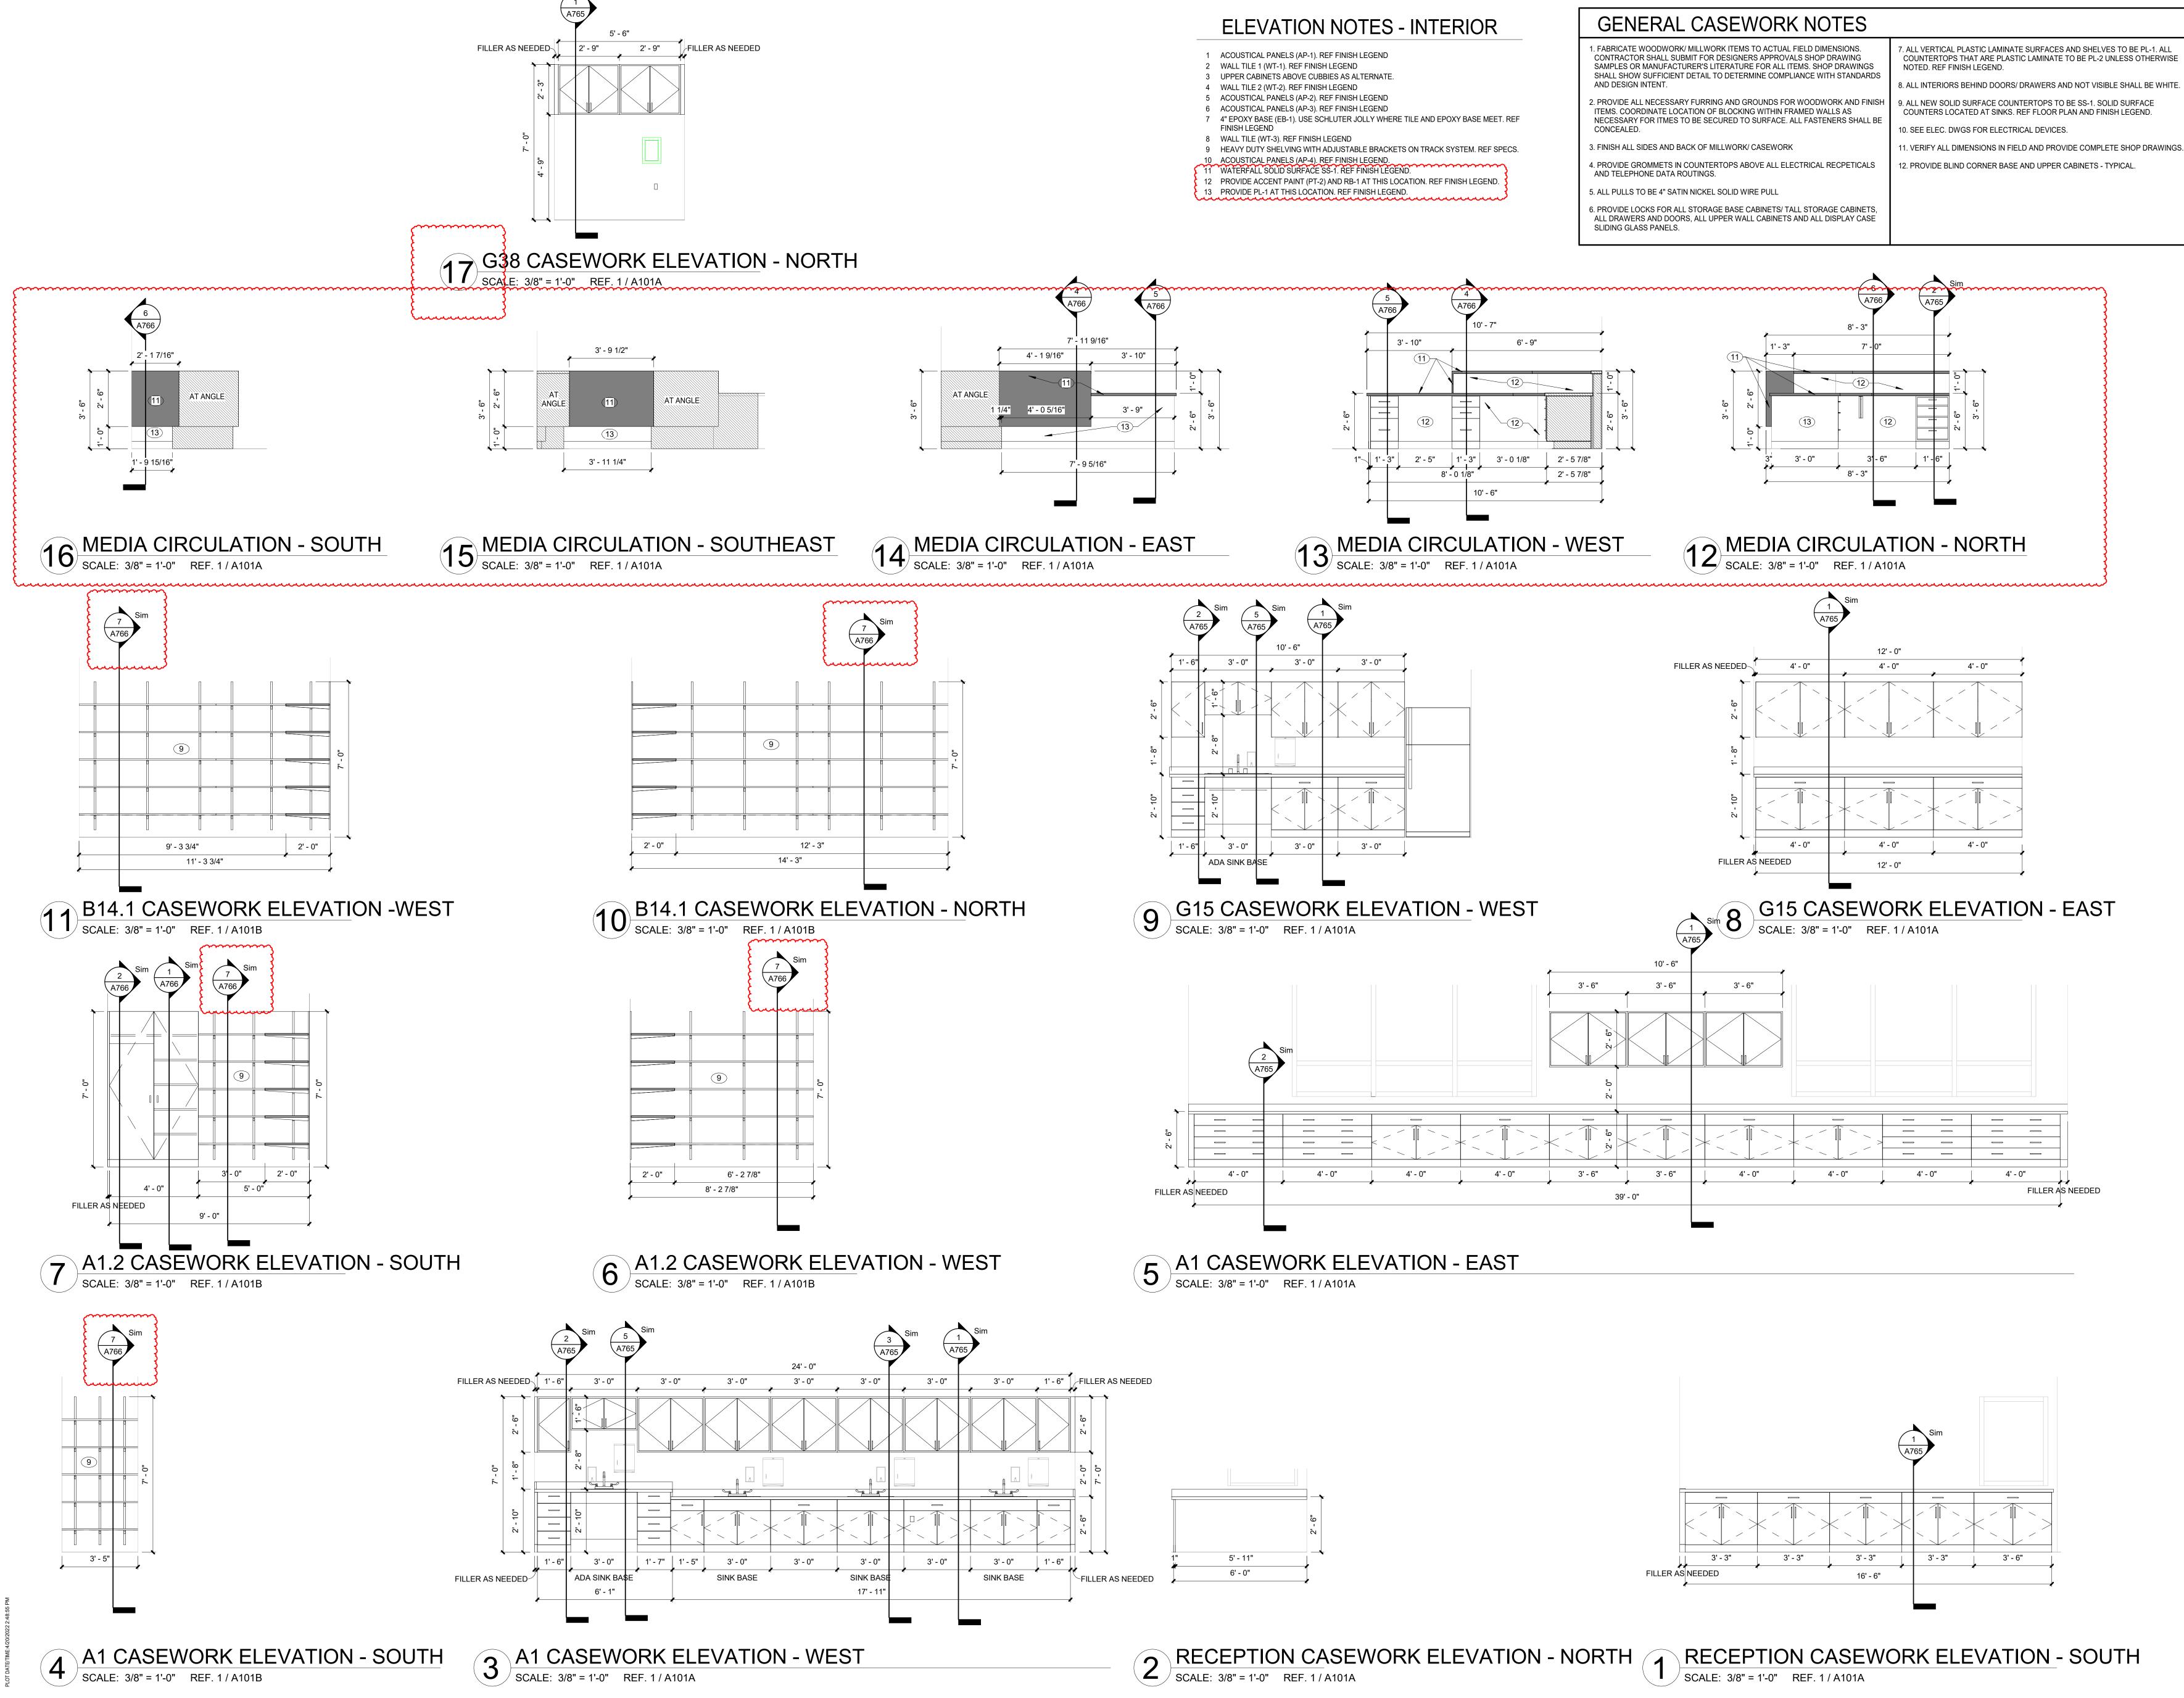

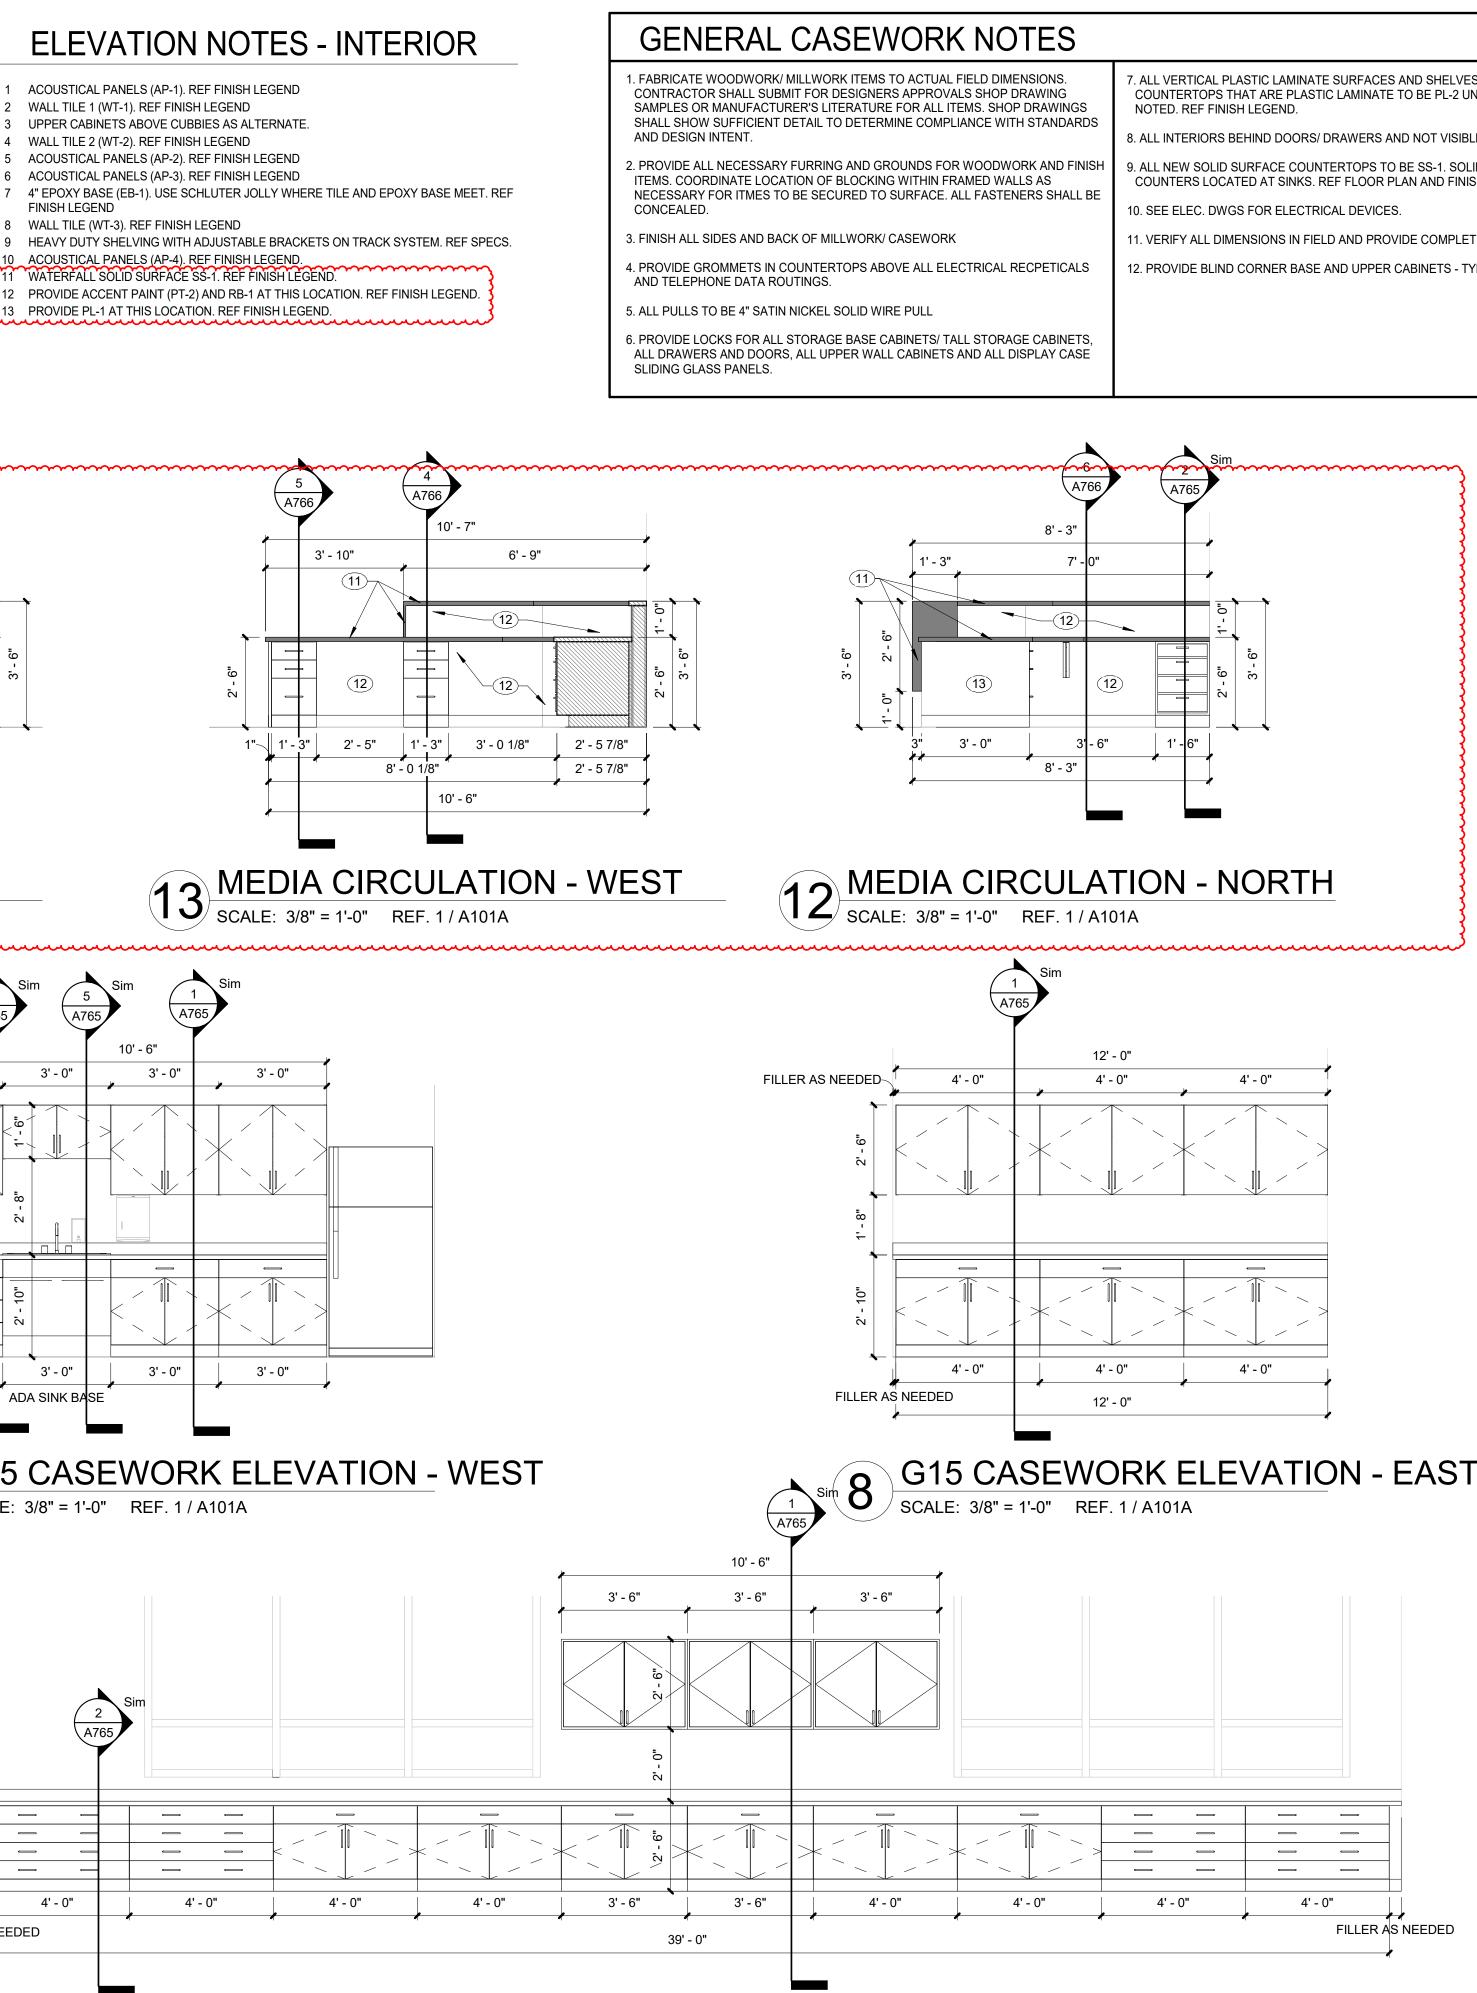



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ELEVATION NOTES - INTERIOR

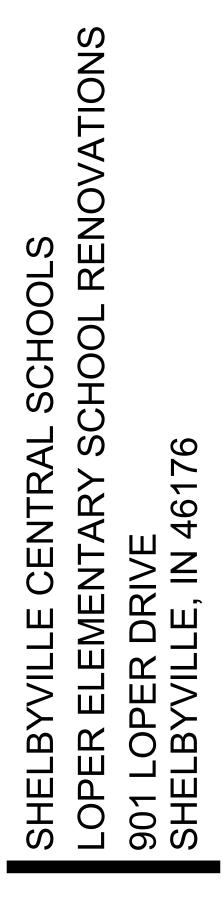1 ACOUSTICAL PANELS (AP-1). REF FINISH LEGEND 2 WALL TILE 1 (WT-1). REF FINISH LEGEND 3 UPPER CABINETS ABOVE CUBBIES AS ALTERNATE. 4 WALL TILE 2 (WT-2). REF FINISH LEGEND 5 ACOUSTICAL PANELS (AP-2). REF FINISH LEGEND 6 ACOUSTICAL PANELS (AP-3). REF FINISH LEGEND 7 4" EPOXY BASE (EB-1). USE SCHLUTER JOLLY WHERE TILE AND EPOXY BASE MEET. REF FINISH LEGEND 8 WALL TILE (WT-3). REF FINISH LEGEND 9 HEAVY DUTY SHELVING WITH ADJUSTABLE BRACKETS ON TRACK SYSTEM. REF SPECS. 10 ACOUSTICAL PANELS (AP-4). REF FINISH LEGEND.

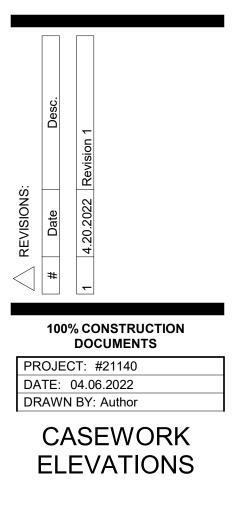
11 WATERFALL SOLID SURFACE SS-1. REF FINISH LEGEND. 12 PROVIDE ACCENT PAINT (PT-2) AND RB-1 AT THIS LOCATION. REF FINISH LEGEND. 13 PROVIDE PL-1 AT THIS LOCATION. REF FINISH LEGEND.

GENERAL CASEWORK NOTES

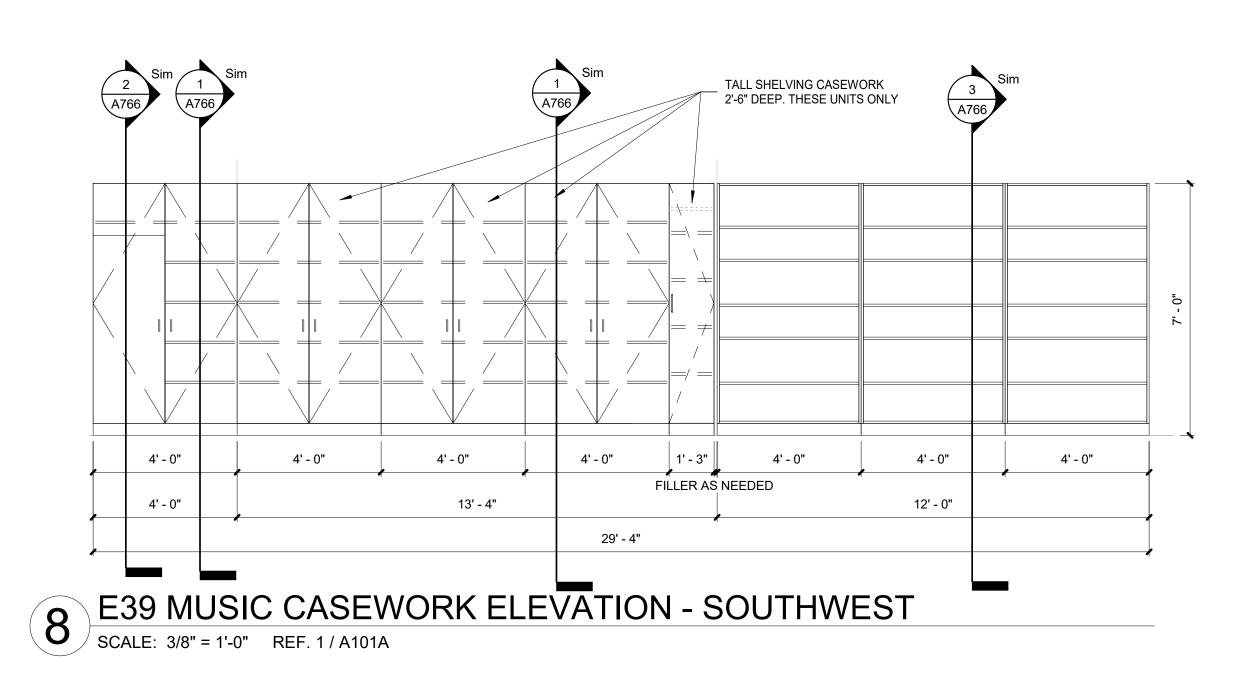- 1. FABRICATE WOODWORK/ MILLWORK ITEMS TO ACTUAL FIELD DIMENSIONS. CONTRACTOR SHALL SUBMIT FOR DESIGNERS APPROVALS SHOP DRAWING SAMPLES OR MANUFACTURER'S LITERATURE FOR ALL ITEMS. SHOP DRAWINGS SHALL SHOW SUFFICIENT DETAIL TO DETERMINE COMPLIANCE WITH STANDARDS AND DESIGN INTENT.
- 2. PROVIDE ALL NECESSARY FURRING AND GROUNDS FOR WOODWORK AND FINISH ITEMS. COORDINATE LOCATION OF BLOCKING WITHIN FRAMED WALLS AS NECESSARY FOR ITMES TO BE SECURED TO SURFACE. ALL FASTENERS SHALL BE CONCEALED.
- 3. FINISH ALL SIDES AND BACK OF MILLWORK/ CASEWORK 4. PROVIDE GROMMETS IN COUNTERTOPS ABOVE ALL ELECTRICAL RECPETICALS
- AND TELEPHONE DATA ROUTINGS.

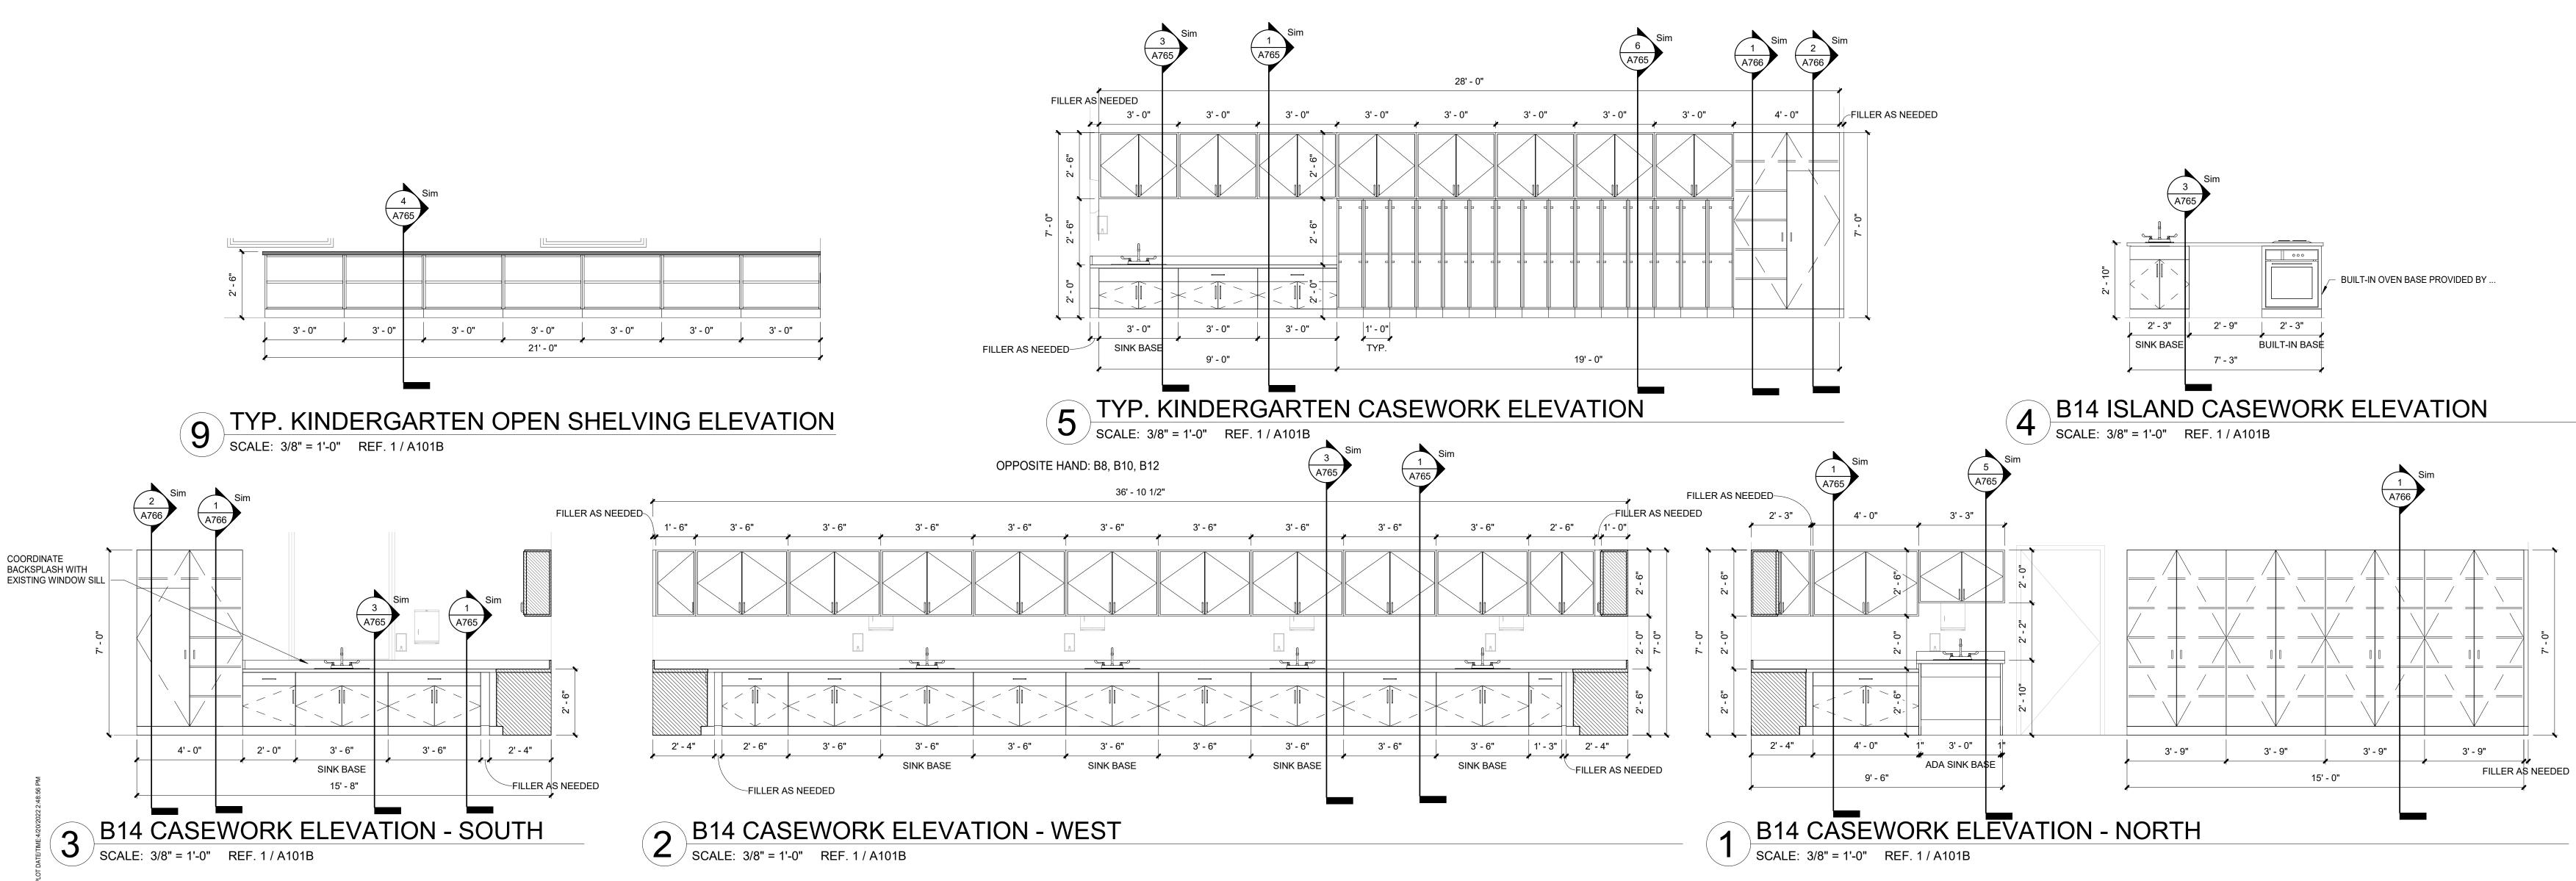SLIDING GLASS PANELS.

- 5. ALL PULLS TO BE 4" SATIN NICKEL SOLID WIRE PULL 6. PROVIDE LOCKS FOR ALL STORAGE BASE CABINETS/ TALL STORAGE CABINETS, ALL DRAWERS AND DOORS, ALL UPPER WALL CABINETS AND ALL DISPLAY CASE
- NOTED. REF FINISH LEGEND. 3. ALL INTERIORS BEHIND DOORS/ DRAWERS AND NOT VISIBLE SHALL BE WHITE. 9. ALL NEW SOLID SURFACE COUNTERTOPS TO BE SS-1. SOLID SURFACE COUNTERS LOCATED AT SINKS. REF FLOOR PLAN AND FINISH LEGEND. 10. SEE ELEC. DWGS FOR ELECTRICAL DEVICES. 11. VERIFY ALL DIMENSIONS IN FIELD AND PROVIDE COMPLETE SHOP DRAWINGS.
- 12. PROVIDE BLIND CORNER BASE AND UPPER CABINETS TYPICAL.

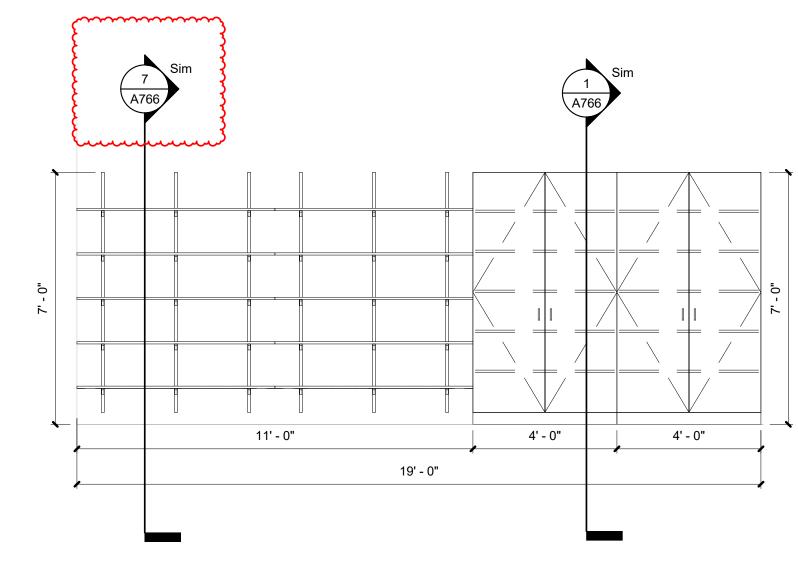

7 E39 MUSIC CASEWORK ELEVATION - NORTH SCALE: 3/8" = 1'-0" REF. 1 / A101A

7. ALL VERTICAL PLASTIC LAMINATE SURFACES AND SHELVES TO BE PL-1. ALL COUNTERTOPS THAT ARE PLASTIC LAMINATE TO BE PL-2 UNLESS OTHERWISE

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