

ADDENDUM NO. 01

April 21, 2022

LOPER ELEMENTARY SCHOOL RENOVATION

**901 Loper Drive
Shelbyville, IN 46176**

TO: ALL BIDDERS OF RECORD

This Addendum forms a part of and modifies the Bidding Requirements, Contract Forms, Contract Conditions, the Specifications, and the Drawings dated April 6, 2022, by Lancer+Beebe, LLC. Acknowledge receipt of the Addendum in the space provided on the Bid Form. Failure to do so may subject the Bidder to disqualification.

This Addendum consists of Pages ADD 1-1 through ADD 1-2, Interior Phasing Plan, Site Logistics Plan, Guideline Schedule, and attached Lancer+Beebe Addendum No. 1, dated April 20, 2022, consisting of 6 pages, Specification Sections 12 32 16 – Plastic Laminate Casework, and Drawing Sheets: C201, C301, A011, A101A, A101B, A101C, A112, A121A, A141, A601, A720, A721A, A751, A762, A763, A764, A766, P-101B, PD101B:

A. SPECIFICATION SECTION 00 20 00 – INFORMATION AVAILABLE TO BIDDERS

Add Paragraph B.

B. Site Logistics Plan Dated April 20, 2022 has been included in Addendum 1 for Contractor reference.

B. SPECIFICATION SECTION 01 12 00 – MULTIPLE CONTRACT SUMMARY

1. Paragraph 3.02 General Requirements

C. Provided by designated contractors - Clarifications

Revise the following General Clarification

3. All contractors are responsible to protect adjacent finishes from damage during construction activities.

2. Paragraph 3.03 Bid Categories

A. Bid Category No. 1 – General Trades

Revise the following Project Specific Clarification

8. General Trades Contractor to provide downspout boots or adapters and all associated storm sewer piping at and below grade. General Trades Contractor to ensure existing downspouts are protected in place and tied into new downspout boots or adapters.

B. Bid Category No. 2 – Roofing.

Delete the following Bid Category

- BC02 – Remove roofing scope of work from this project. Roofing scope of work for this project is to be included in separate project.

G. Bid Category No. 7 – Plumbing & Mechanical

Revise the following Project Specific Clarification

3. Regarding rooftop mechanical equipment demolition and installation, it is the responsibility of the Plumbing & Mechanical Contractor to remove any equipment scheduled for removal or demolition. The Plumbing & Mechanical Contractor is then responsible for all roof patching of openings and penetrations to create a weather tight roof system.

C. **SPECIFICATION SECTION 01 32 00 – SCHEDULES AND REPORTS**

1. 1.03 Guideline Schedule

Add Paragraph A.3

- A.3. Loper Elementary School Renovation – Guideline Schedule Dated June 1, 2022 has been issued as part of Addendum 1 for Contractor reference.

Add Paragraph B.1

- B.1. Interior Phasing Plan Dated April 20, 2022 has been issued as part of Addendum 1 for Contractor reference.

PHASE 4

PHASE 3

PHASE 2

PHASE 1

PHASE 6

PHASE 5


GENERAL PHASING NOTES:

1. All Contractors are to refer to Guideline Schedule for anticipated working durations in each phase.
2. General Trades Contractor is responsible for installation and maintenance of temporary partitions to separate construction work area from Owner occupied space. It is anticipated that each of these partitions must carry a 1-hour fire rating. The intent is for these partitions to be placed at/near the phase transition lines depicted here at corridors, doorways, passthroughs, etc. All partitions are to be full height and width of the opening.
3. Temporary partitions should have temporary hardware to accommodate security of construction area and/or emergency egress, if required.

Temp
TEMPORARY
CLASSROOMS

Interior Phasing Plan

Drawing Date:
April 20, 2022

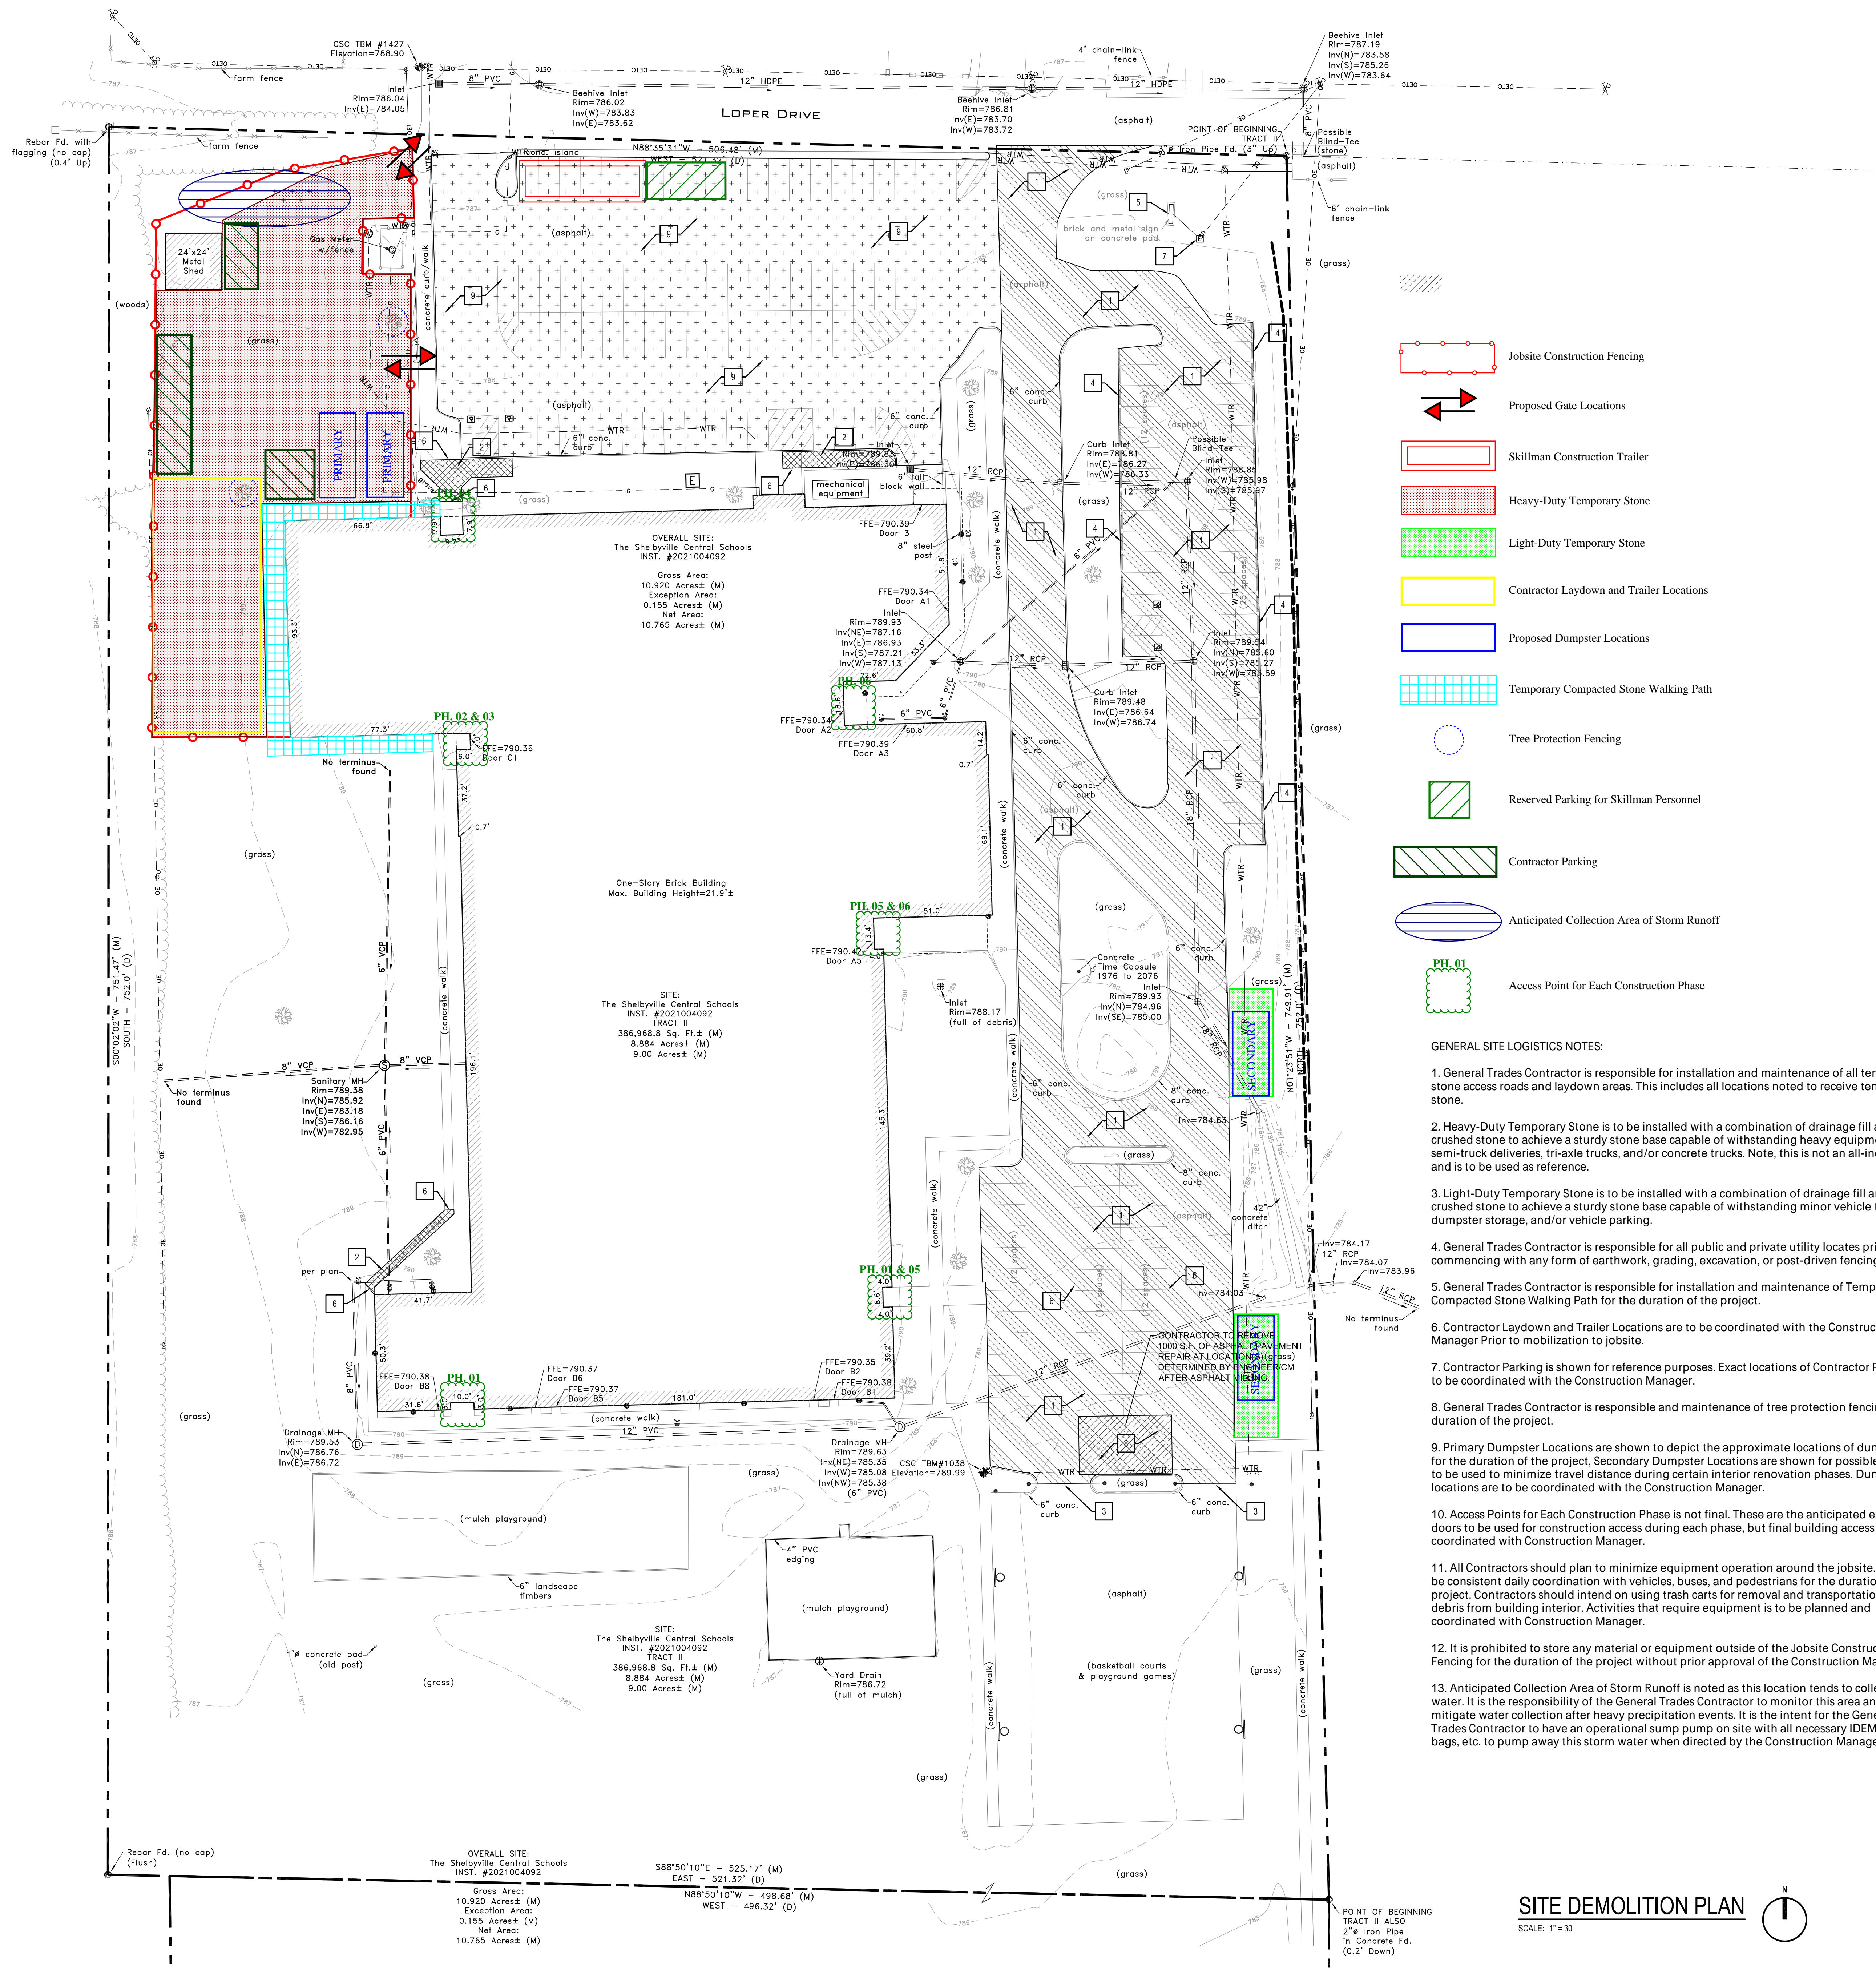

DEMOLITION NOTES

- CONTRACTOR SHALL BE RESPONSIBLE FOR OBTAINING OR VERIFYING THAT PERMITS AND APPROVALS ARE OBTAINED FROM THE RESPECTIVE CITY, COUNTY OR STATE AGENCIES PRIOR TO STARTING ANY CONSTRUCTION. ALL WORK SHALL BE DONE IN ACCORDANCE WITH THE LOCAL AUTHORITIES STANDARDS AND SPECIFICATIONS.
- CONTRACTOR SHALL COORDINATE WORK WITH OTHER CONTRACTORS ON SITE. CONTRACTOR SHALL BE RESPONSIBLE FOR NOTIFICATION AND COORDINATION OF ALL CONSTRUCTION WITH THE RESPECTIVE UTILITY PROVIDERS PRIOR TO STARTING ANY CONSTRUCTION.
- PROVIDE BARRIERS OR OTHER PROTECTION TO KEEP VEHICULAR AND PEDESTRIAN TRAFFIC FROM CONSTRUCTION AREA.
- REMOVE ALL STRUCTURES, SUPPORT COLUMNS, FOOTINGS, ASPHALT PAVING, CONCRETE CURBS, SIDEWALKS, CONCRETE PADS, TREES, STUMPS, HEDGES, UTILITIES, AND OTHER EXISTING SITE FEATURES WITHIN LIMITS OF DEMOLITION. ALL DEMOLITION MATERIALS SHALL BE REMOVED FROM THE SITE UNLESS OTHERWISE NOTED AND DISPOSED OF IN A MANNER ACCEPTABLE TO THE LOCAL AUTHORITY HAVING JURISDICTION.
- CALL "811" OR 1-800-382-6544, 72 HOURS PRIOR TO THE START OF ANY EXCAVATION. CONTRACTOR SHALL BE RESPONSIBLE FOR MARKING & LOCATING PRIVATE UTILITIES INSIDE AREA OF NEW CONSTRUCTION IF THOSE UTILITIES ARE NOT MARKED OR LOCATED BY "HOLEY MOLEY".
- CONTRACTOR SHALL PROTECT ALL EXISTING AND NEW CONSTRUCTION FROM DAMAGE. SHOULD ANY DAMAGE OCCUR, CONTRACTOR SHALL MAKE ALL NECESSARY REPAIRS AT NO COST TO THE OWNER.
- EXISTING UNDERGROUND UTILITIES ARE PLOTTED FROM ORIGINAL SITE DRAWINGS AND TOPOGRAPHIC SURVEY. EVERY ATTEMPT HAS BEEN MADE TO SHOW ALL UTILITY LINES WHERE THEY EXIST. CONTRACTOR SHALL TAKE EVERY PRECAUTION IN EXCAVATING FOR NEW UTILITIES SINCE ACTUAL UNDERGROUND UTILITIES MAY NOT BE AS SHOWN. CONTRACTOR SHALL MAKE HIMSELF THOROUGHLY FAMILIAR WITH ALL UNDERGROUND UTILITY LOCATIONS PRIOR TO ANY EXCAVATION AND VERIFY LOCATIONS AND DEPTHS OF ALL UTILITIES.
- CONTRACTOR SHALL MAINTAIN UTILITY SERVICES TO ADJACENT PROPERTIES AT ALL TIMES. ANY INTERRUPTION IN SERVICES MUST BE SCHEDULED WITH THE OWNER 48 HOURS PRIOR TO THE INTERRUPTION.
- EXCEPT FOR THOSE UTILITIES NOTED TO BE PLUGGED OR REMOVED, RECONNECT ALL LINES ENCOUNTERED DURING CONSTRUCTION.
- ALL CATCH BASIN AND MANHOLE FRAMES AND COVERS SPECIFIED TO BE REMOVED SHALL BE SALVAGED, CLEANED AND INSPECTED. IF THEY ARE DEEMED SOUND, THEY MAY BE REUSED AT LOCATIONS APPROVED BY ENGINEER.
- PROTECT ALL TREES AND SHRUBS NOT SCHEDULED FOR REMOVAL. DO NOT OPERATE EQUIPMENT, STORE, STOCKPILE, OR PARK WITHIN DRIP LINE OF PLANTS. HOLD NECESSARY DISTURBANCE TO A MINIMUM.
- REMOVAL ITEMS SHOWN ARE BASED ON BEST AVAILABLE INFORMATION AND ARE SHOWN SCHEMATICALLY. THE CONTRACTOR SHALL VISIT THE SITE PRIOR TO BID TO BE FULLY FAMILIAR WITH THE EXTENT OF REMOVAL ITEMS. THE CONTRACTOR IS RESPONSIBLE FOR ALL REMOVALS NECESSARY TO COMPLETE CONSTRUCTION. QUESTIONS REGARDING ITEMS TO BE REMOVED SHALL BE DIRECTED TO THE ENGINEER PRIOR TO CONSTRUCTION.

DEMO LEGEND

- INDICATES REMOVAL OF CONCRETE PAVEMENT
- INDICATES 1" MILLING OF ASPHALT PAVEMENT
- INDICATES REMOVAL OF ASPHALT PAVEMENT
- INDICATES CLEANING OF ASPHALT PAVEMENT


KEY NOTES

- MILL ASPHALT PAVEMENT
- REMOVE CONCRETE PAVEMENT
- REMOVE EXISTING GATE
- REMOVE/RE-INSTALL EX. PARKING BUMPERS
- REMOVE EXISTING SIGN/REPLACE WITH NEW (SEE ELECTRICAL SITE PLAN)
- SAW CUT PAVEMENT
- REMOVE/RELOCATE EX. ELECTRICAL BOX (SEE ELECTRICAL SITE PLAN)
- REMOVE ASPHALT PAVEMENT
- CLEAN ASPHALT PAVEMENT PRIOR TO CLEAR COATINGS

GENERAL SITE LOGISTICS NOTES:

- General Trades Contractor is responsible for installation and maintenance of all temporary stone access roads and laydown areas. This includes all locations noted to receive temporary stone.
- Heavy-Duty Temporary Stone is to be installed with a combination of drainage fill and crushed stone to achieve a sturdy stone base capable of withstanding heavy equipment use, semi-truck deliveries, tri-axle trucks, and/or concrete trucks. Note, this is not an all-inclusive list and is to be used as reference.
- Light-Duty Temporary Stone is to be installed with a combination of drainage fill and crushed stone to achieve a sturdy stone base capable of withstanding minor vehicle traffic, dumpster storage, and/or vehicle parking.
- General Trades Contractor is responsible for all public and private utility locates prior to commencing with any form of earthwork, grading, excavation, or post-driven fencing.
- General Trades Contractor is responsible for installation and maintenance of Temporary Compacted Stone Walking Path for the duration of the project.
- Contractor Laydown and Trailer Locations are to be coordinated with the Construction Manager Prior to mobilization to jobsite.
- Contractor Parking is shown for reference purposes. Exact locations of Contractor Parking is to be coordinated with the Construction Manager.
- General Trades Contractor is responsible and maintenance of tree protection fencing for the duration of the project.
- Primary Dumpster Locations are shown to depict the approximate locations of dumpsters for the duration of the project. Secondary Dumpster Locations are shown for possible locations to be used to minimize travel distance during certain interior renovation phases. Dumpster locations are to be coordinated with the Construction Manager.
- Access Points for Each Construction Phase is not final. These are the anticipated exterior doors to be used for construction access during each phase, but final building access is to be coordinated with Construction Manager.
- All Contractors should plan to minimize equipment operation around the jobsite. There will be consistent daily coordination with vehicles, buses, and pedestrians for the duration of the project. Contractors should intend on using trash carts for removal and transportation of debris from building interior. Activities that require equipment is to be planned and coordinated with Construction Manager.
- It is prohibited to store any material or equipment outside of the Jobsite Construction Fencing for the duration of the project without prior approval of the Construction Manager.
- Anticipated Collection Area of Storm Runoff is noted as this location tends to collect storm water. It is the responsibility of the General Trades Contractor to monitor this area and mitigate water collection after heavy precipitation events. It is the intent for the General Trades Contractor to have an operational sump pump on site with all necessary IDEM filters, bags, etc. to pump away this storm water when directed by the Construction Manager.

LEGEND:	
SYMBOL	DESCRIPTION
[Symbol]	SIGN / TWO POST SIGN
[Symbol]	WATER VALVE/ERC HYD/METER
[Symbol]	TELE / GAS MARKER
[Symbol]	GAS METER / VALVE
[Symbol]	CLEAN-OUT
[Symbol]	ELEC. METER BOX/TRANSFORMER
[Symbol]	ELEC. / TELEPHONE PEDESTAL
[Symbol]	GUARD POST/POST WITH LIGHT
[Symbol]	AIR CONDITIONER / GENERATOR
[Symbol]	MAGNAIL SET/FOUND
[Symbol]	REBAR SET/FOUND
[Symbol]	SQUARE / ROUND / CURB INLET
[Symbol]	TRAFFIC/COMBO/ POWER POLE
[Symbol]	LIGHT POLE - SQUARE / ROUND
[Symbol]	CONIFEROUS TREE & SIZE
[Symbol]	DECIDUOUS TREE & SIZE
[Symbol]	DRAINAGE / SANITARY MANHOLE
[Symbol]	COMBINATION/MISC. LID MANHOLE
[Symbol]	BEEHIVE ROUND/SQUARE INLET
[Symbol]	GUY WIRE / GROUND LIGHT
[Symbol]	UNDS. WATER LINE
[Symbol]	UNDS. GAS LINE
[Symbol]	UNDS. TELEPHONE LINE
[Symbol]	UNDS. ELECTRIC LINE
[Symbol]	OVERHEAD ELEC. TEL. & TEL.
[Symbol]	OVERHEAD ELEC. TEL. & CAB
[Symbol]	OVERHEAD ELECTRIC
[Symbol]	vitrified clay pipe
[Symbol]	reinforced concrete pipe
[Symbol]	PVC
[Symbol]	high-density polyethylene pipe
[Symbol]	ductile iron pipe

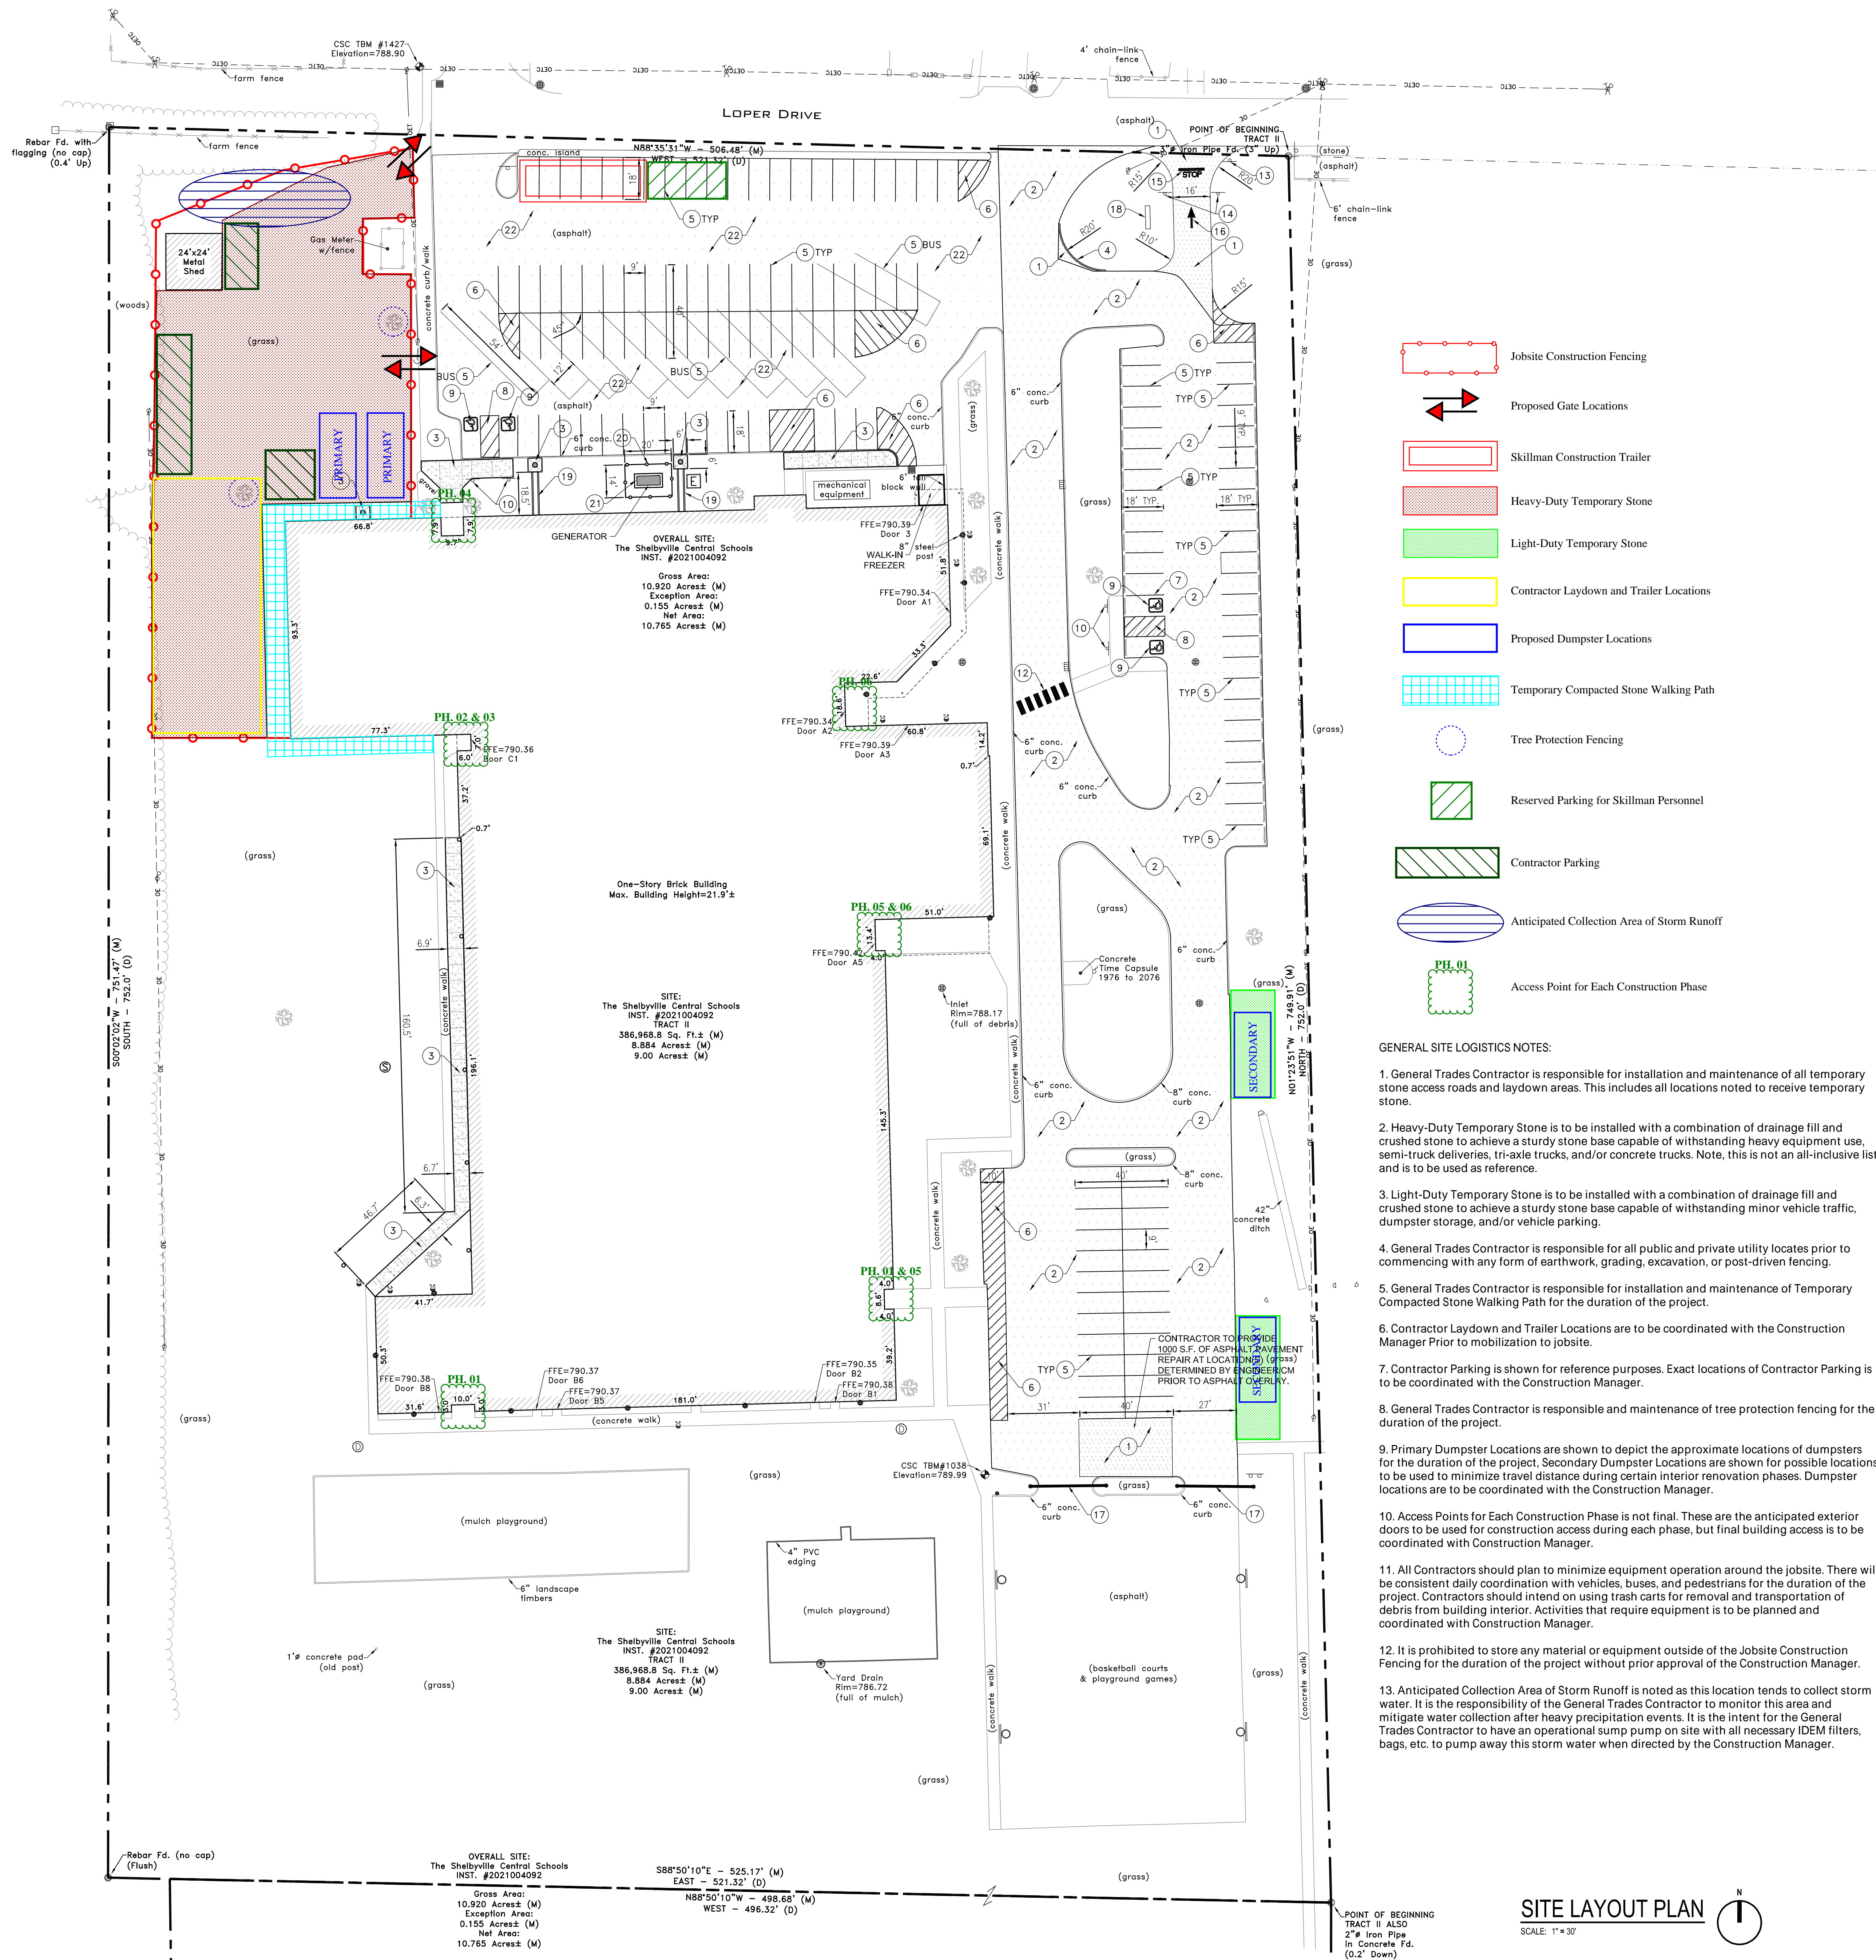

1. ALL DIMENSIONS IN CURBED AREAS ARE FACE TO FACE OF CURB. ALL DIMENSIONS IN AREAS WITHOUT CURB SHALL BE TO EDGE OF PAVEMENT.
2. ALL EXISTING PAVEMENT SHALL BE SAW CUT TO A CLEAN EDGE WHERE NEW PAVEMENT IS TO BE INSTALLED ADJACENT TO EXISTING PAVEMENT.
3. THE CONTRACTOR SHALL VERIFY ALL DIMENSIONS IN FIELD BEFORE STARTING CONSTRUCTION. THE CONTRACTOR SHALL BE RESPONSIBLE FOR ALL FIELD DIMENSIONS. IF ANY DISCREPANCIES ARE FOUND IN THESE PLANS FROM ACTUAL FIELD CONDITION, THE CONTRACTOR SHALL CONTACT A/E IMMEDIATELY.
4. SEE DETAIL SHEETS FOR TYPICAL CONSTRUCTION DETAILS.
5. ALL AREAS WHERE THE EXISTING PAVEMENT OR PAVEMENTS ARE DAMAGED DURING CONSTRUCTION FROM TRAFFIC BY THE GENERAL CONTRACTOR, SUBCONTRACTORS, OR SUPPLIERS SHALL BE RESURFACED OR RECONSTRUCTED AT LEAST TO THEIR ORIGINAL CONDITION AFTER CONSTRUCTION WORK IS COMPLETED.
6. ALL RADI INDICATED SHALL BE FORMED AS CIRCULAR ARCS.
7. ALL DIMENSIONS ARE PARALLEL AND PERPENDICULAR TO RIGHT-OF-WAY LINES OR PROPERTY LINES, UNLESS OTHERWISE NOTED.
8. DISABLED RAMPS SHALL BE IN ACCORDANCE WITH FEDERAL, STATE, COUNTY, CITY AND LOCAL CODES. SEE PLAN FOR LOCATION AND DETAIL SHEETS FOR SPECIFICATIONS.
9. SEE DETAIL SHEETS FOR TYPICAL PAVEMENT SECTIONS AND CURB DETAILS.
10. ENDS OF ALL CURBS SHALL BE CHAMFERED.
11. THE CONTRACTOR SHALL BE RESPONSIBLE TO PROVIDE AT HIS EXPENSE ALL AUTOMOBILE AND PEDESTRIAN TRAFFIC CONTROL DEVICES REQUIRED BY FEDERAL, STATE, COUNTY, CITY OR LOCAL AGENCY. THE AMOUNT, LOCATION AND SIZE SHALL BE PER DIRECTION OF AGENCY.
12. IT IS THE RESPONSIBILITY OF THE CONTRACTOR TO REMOVE ALL MUD, DIRT, GRAVEL, AND ANY OTHER MATERIALS TRACKED ONTO ANY PUBLIC OR PRIVATE STREETS OR SIDEWALKS. THE CONTRACTOR MUST CLEAN THESE DAILY IF NECESSARY. THE CONTRACTOR MUST USE WATER OR OTHER METHODS TO KEEP AIRBORNE DUST TO A REQUIRED MINIMUM.
13. ALL AREAS WHERE PROPOSED ASPHALT PAVEMENT MEETS THE EXISTING PAVEMENT THE EXISTING PAVEMENT EDGE SHALL BE PROPERLY SEALED WITH A TACK COAT MATERIAL.
14. ALL CURB RADIUS TO BE A MINIMUM OF 2'-0" UNLESS NOTED OTHERWISE.

SITE LEGEND

- STANDARD DUTY ASPHALT = [Symbol]
ASPHALT OVERLAY = [Symbol]
BITUMINOUS SEAL COAT = [Symbol]
CONCRETE SIDEWALK = [Symbol]

KEY NOTES


1. ASPHALT PAVEMENT (SEE DETAIL ON C801)
2. ASPHALT OVERLAY (SEE DETAIL ON C801)
3. 4" CONCRETE SIDEWALK (SEE DETAIL ON C801)
4. 6" CONCRETE CURB (SEE DETAIL ON C801)
5. 4" PAINTED STRIPE, WHITE
6. 4" STRIPING, 45°, YELLOW, 3' O.C.
7. 4" PAINTED STRIPE, BLUE
8. 4" STRIPING, 45°, BLUE, 3' O.C.
9. DISABLED PARKING SYMBOL, BLUE PAINTED (SEE DETAIL ON C801)
10. DISABLED PARKING SIGN (SEE DETAIL ON C801)
11. EXISTING CONCRETE WHEEL STOP (REMOVE AND REPLACE AFTER SEALING)
12. PEDESTRIAN CROSSING (SEE DETAIL ON C801)
13. STOP SIGN (SEE DETAIL ON C801)
14. ONE WAY - NOT ENTER SIGN
15. PAINTED STOP BAR (SEE DETAIL ON C801)
16. PAINTED ARROW, WHITE (SEE DETAIL ON C801)
17. NEW VEHICLE GATE (SEE DETAIL ON C801)
18. LED MONUMENT SIGN (SEE ELECTRICAL PLANS)
19. CONCRETE VALLEY CURB (SEE DETAIL ON C801)
20. GENERATOR ENCLOSURE (SEE ARCHITECTURAL PLANS)
21. 6" CONCRETE GENERATOR PAD
22. BITUMINOUS SEAL COAT

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SITE LAYOUT PLAN

SCALE: 1" = 30'



SITE LOGISTICS PLAN

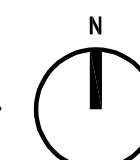April 20, 2022

Page 2 of 2



Activity Name		Original Duration	Start	Finish	2022												2023												2024												2025																																																																																																																																																																																																																																																																																																																																																																																																																																																																																																																																																																																																																																																																																																																																																																																																																																																																																																																																																																																																																																																																																																																																																																																																																																																																																								
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Actual Work
- ▲▼

Summary
- ▲▼

Remaining Work
- ▲▼

Critical Remaining Work
- ◆

Milestone

Loper Elementary School Renovation

Guideline Schedule 01-Jun-22



Activity Name			Original Duration	Start	Finish	2022												2023												2024												2025																																																																																																																																																																																																																																																																																																																																																																																																																																																																																																																																																																																																																																																																																																																																																																																																																																																																																																																																																																																																																																																																																																																																																																																																																																																																																																													
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LANCER + BEEBE, LLC

Project # 21140

ADDENDUM NO. ONE

PROJECT: Shelbyville Central Schools – 2022 Loper Elementary Renovation

PROJECT NUMBER: 21140

DATE OF ADDENDUM: April 20, 2022



THIS ADDENDUM FORMS A PART OF THE CONTRACT DOCUMENTS AND IS ISSUED IN ACCORDANCE WITH THE INSTRUCTIONS TO BIDDERS. ACKNOWLEDGE RECEIPT OF THIS ADDENDUM BY SIGNING THE ADDENDUM ACKNOWLEDGMENT SECTION OF THE BID FORM.

SPECIFICATIONS:

1. Spec Section: 12 32 16
Spec Title: PLASTIC LAMINATE CASEWORK

Change:

PART 2 - PRODUCTS

- 2.1 MANUFACTURERS
 - F. Advanced Cabinet Systems

DRAWINGS:

LANCER + BEEBE, LLC

Project # 21140

1. Drawing Sheet Number: C201
Drawing Sheet Title: Site Layout Plan
Change:
 - Site Layout General Notes: Delete blank note 6 and renumber notes.
2. Drawing Sheet Number: C301
Drawing Sheet Title: Grading & Drainage Plan
Change:
 - Grading General Notes: Add note 8.
3. Drawing Sheet Number: A011
Drawings Sheet Title: Floor Plan – First Floor Overall
Change:
 - Fix typo of “Bull-nose” in General Note 2
 - Change General Note 6 to include janitor closets
4. Drawing Sheet Number: A101A
Drawings Sheet Title: Floor Plan – First Floor – Unit A
Change:
 - Fix typo of “Bull-nose” in General Note 2
 - Change General Note 6 to include janitor closets
 - Add “Confirm final install height and placement with owner” to Keynote 27
 - Add Keynote 31: Install two rows of tack strips. Top tack strip shall be at 5'-0" AFF, and spaced 1'-8" O.C.
 - Add/adjust keynote 27 on the plan
 - Add keynote 31 with dimensions of tacks trips on plan
 - Relocation of circulation desk in room G18
 - Clarify locations of keynote 5 in room C26.2

LANCER + BEEBE, LLC

Project # 21140

- Add Keynote 32: New wall mural / vinyl wall decal at full height of available wall
- New doors G15.1 and G1.1
- Casework elevation reference in G38 changed from 16/A763 to 17/A763

5. Drawing Sheet Number: A101B

Drawings Sheet Title: Floor Plan – First Floor – Unit B

Change:

- Fix typo of “Bull-nose” in General Note 2
- Change General Note 6 to include janitor closets
- Add “Confirm final install height and placement with owner” to Keynote 27
- Add Keynote 31: Install two rows of tack strips. Top tack strip shall be at 5'-0" AFF, and spaced 1'-8" O.C.
- Add/adjust keynote 27 on the plan
- Add keynote 31 with dimensions of tacks trips on plan

6. Drawing Sheet Number: A101C

Drawings Sheet Title: Floor Plan – First Floor – Unit C

Change:

- Fix typo of “Bull-nose” in General Note 2
- Change General Note 6 to include janitor closets
- Add “Confirm final install height and placement with owner” to Keynote 27
- Add Keynote 31: Install two rows of tack strips. Top tack strip shall be at 5'-0" AFF, and spaced 1'-8" O.C.
- Add/adjust keynote 27 on the plan
- Add keynote 31 with dimensions of tacks trips on plan

LANCER + BEEBE, LLC

Project # 21140

7. Drawing Sheet Number: A112
Drawings Sheet Title: Enlarged Plans
Change:
 - New Enlarged Media Center Plan
8. Drawing Sheet Number: A121A
Drawings Sheet Title: Reflected Ceiling Plan – First Floor – Unit A
Change:
 - Add General Note 2: 2-hour fire rated gypsum board ceiling construction.
 - Add Note 4 to Cafeteria G39 Bulkhead: Existing bulkhead to remain. Paint PT-1. Ref Finish Legend.
9. Drawing Sheet Number: A141
Drawings Sheet Title: Roof Plan
Change:
 - Remove sheet
10. Drawing Sheet Number: A601
Drawings Sheet Title: Door Schedule
Change:
 - Add doors G1.1 and G15.1
11. Drawing Sheet Number: A720
Drawings Sheet Title: Interior Finish Legend
Change:
 - Add RS-1, RSB-1, AP-4 (PL-3??)
12. Drawing Sheet Number: A721A
Drawings Sheet Title: Interior Finish Plan – First Floor – Unit A
Change:
 - Change Flooring material to RS-1 and Wall Base material to RSB-1 in the following rooms: G31, G32, G33, G34, G35, G36, and G37

LANCER + BEEBE, LLC

Project # 21140

- Update flooring pattern install in Media Center G18
- Casework elevation reference in G38 will now show 7/A763

13. Drawing Sheet Number: A751

Drawings Sheet Title: Interior Elevations

Change:

- Add keynote 10: Acoustical Panels (AP-4). Ref finish Legend.
- Change all keynotes on 1/A751 to keynote 10

14. Drawing Sheet Number: A762

Drawings Sheet Title: Casework Elevations

Change:

- Casework Typ. Section referenced in 13/A762 changed to 7/A766

15. Drawing Sheet Number: A763

Drawings Sheet Title: Casework Elevations

Change:

- Casework Elevation 16/A763 changed to 17/A763
- Update elevations for new circulation desk
- Add keynote 11, 12, and 13 to clarify finishes at new circulation desk
- Casework Typ. Section referenced in 4,6,710,11/A763, changed from 4/A766 to 7/A766

16. Drawing Sheet Number: A764

Drawings Sheet Title: Casework Elevations - Alternates

Change:

- Casework Typ. Section referenced in 7/A764, changed from 4/A766 to 7/A766

17. Drawing Sheet Number: A766

Drawings Sheet Title: Casework Details

Change:

LANCER + BEEBE, LLC

Project # 21140

- Update sections for new circulation desk.
- Detail Section 4/A766 changed to 7/A766.

18. Drawing Sheet Number: P-101B

Drawings Sheet Title: FIRST FLOOR PLUMBING PLAN – UNIT B

Change:

- UPDATED PLAN NOTE 5

19. Drawing Sheet Number: PD101B

Drawings Sheet Title: FIRST FLOOR PLUMBING DEMO PLAN – UNIT B

Change:

- UPDATED PLAN NOTE 16


Attachments:

END OF ADDENDUM NO. ONE



- ① ASPHALT PAVEMENT
(SEE DETAIL ON C801)
- ② ASPHALT OVERLAY
(SEE DETAIL ON C801)
- ③ 4" CONCRETE SIDEWALK
(SEE DETAIL ON C801)
- ④ 6" CONCRETE CURB
(SEE DETAIL ON C801)
- ⑤ 4" PAINTED STRIPE, WHITE
- ⑥ 4" STRIPING, 45°, YELLOW, 3" O.C.
- ⑦ 4" PAINTED STRIPE, BLUE
- ⑧ 4" STRIPINGS, 45°, BLUE, 3" O.C.
- ⑨ DISABLED PARKING SYMBOL, BLUE PAINTED
(SEE DETAIL ON C801)
- ⑩ DISABLED PARKING SIGN
(SEE DETAIL ON C801)
- ⑪ EXISTING CONCRETE WHEEL STOP
REMOVE AND REPLACE AFTER SEALING)
- ⑫ PEDESTRIAN CROSSING
(SEE DETAIL ON C801)
- ⑬ STOP SIGN
(SEE DETAIL ON C801)
- ⑭ ONE WAY - NOT ENTER SIGN
- ⑮ PAINTED STOP BAR
(SEE DETAIL ON C801)
- ⑯ PAINTED PARALLEL WHITE
(SEE DETAIL ON C801)
- ⑰ NEW VEHICLE GATE
(SEE DETAIL ON C801)
- ⑱ LED MONUMENT SIGN
(SEE ELECTRICAL PLANS)
- ⑲ CONCRETE VALLEY CURB
(SEE DETAIL ON C801)
- ⑳ GENERATOR ENCLOSURE
(SEE ARCHITECTURAL PLANS)
- ㉑ 6" CONCRETE GENERATOR PAD
- ㉒ BITUMINOUS SEAL COAT

SHELBYVILLE CENTRAL SCHOOLS
LOPER ELEMENTARY RENOVATION
901 LOPER DRIVE
SHELBYVILLE, IN 46176

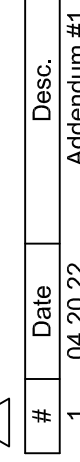


PROJECT: #21139
DATE: 04.06.22
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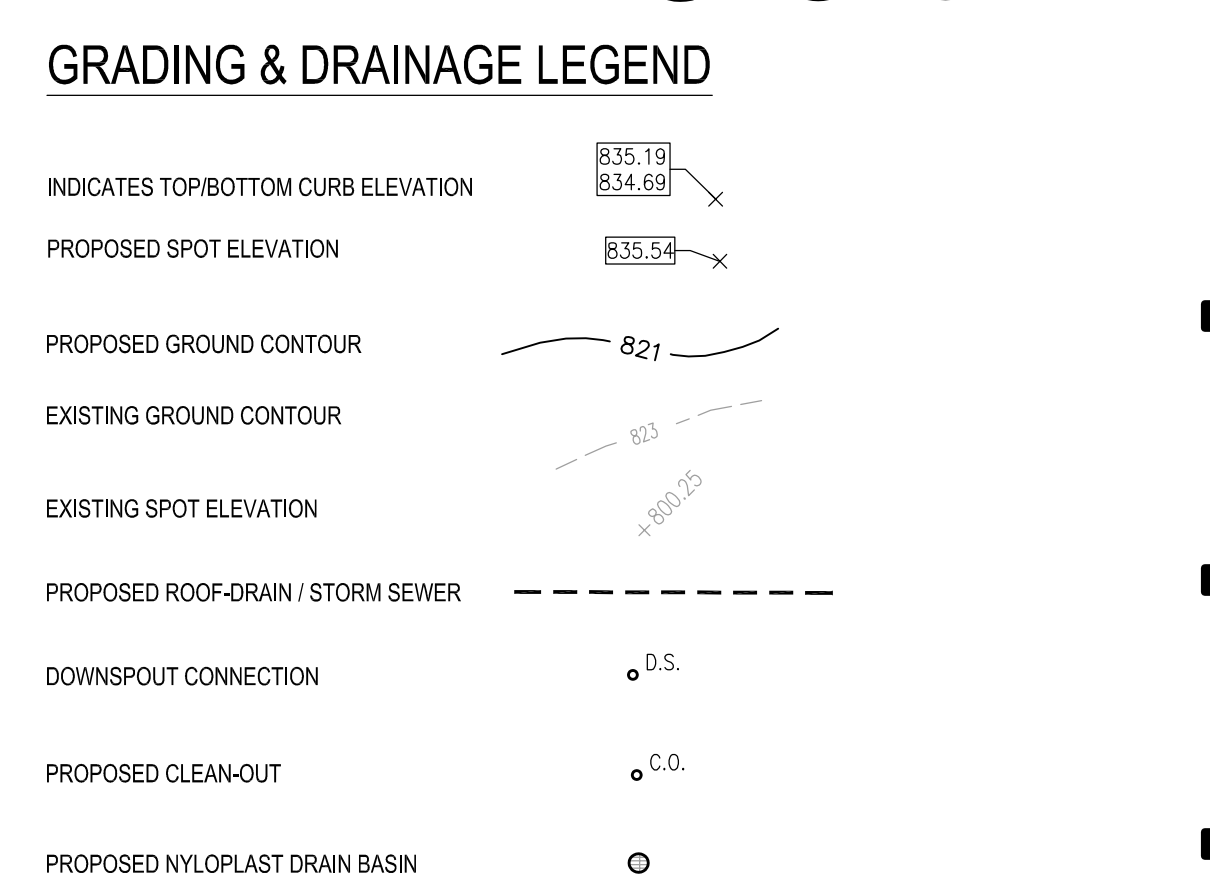
SITE LAYOUT PLAN



C201

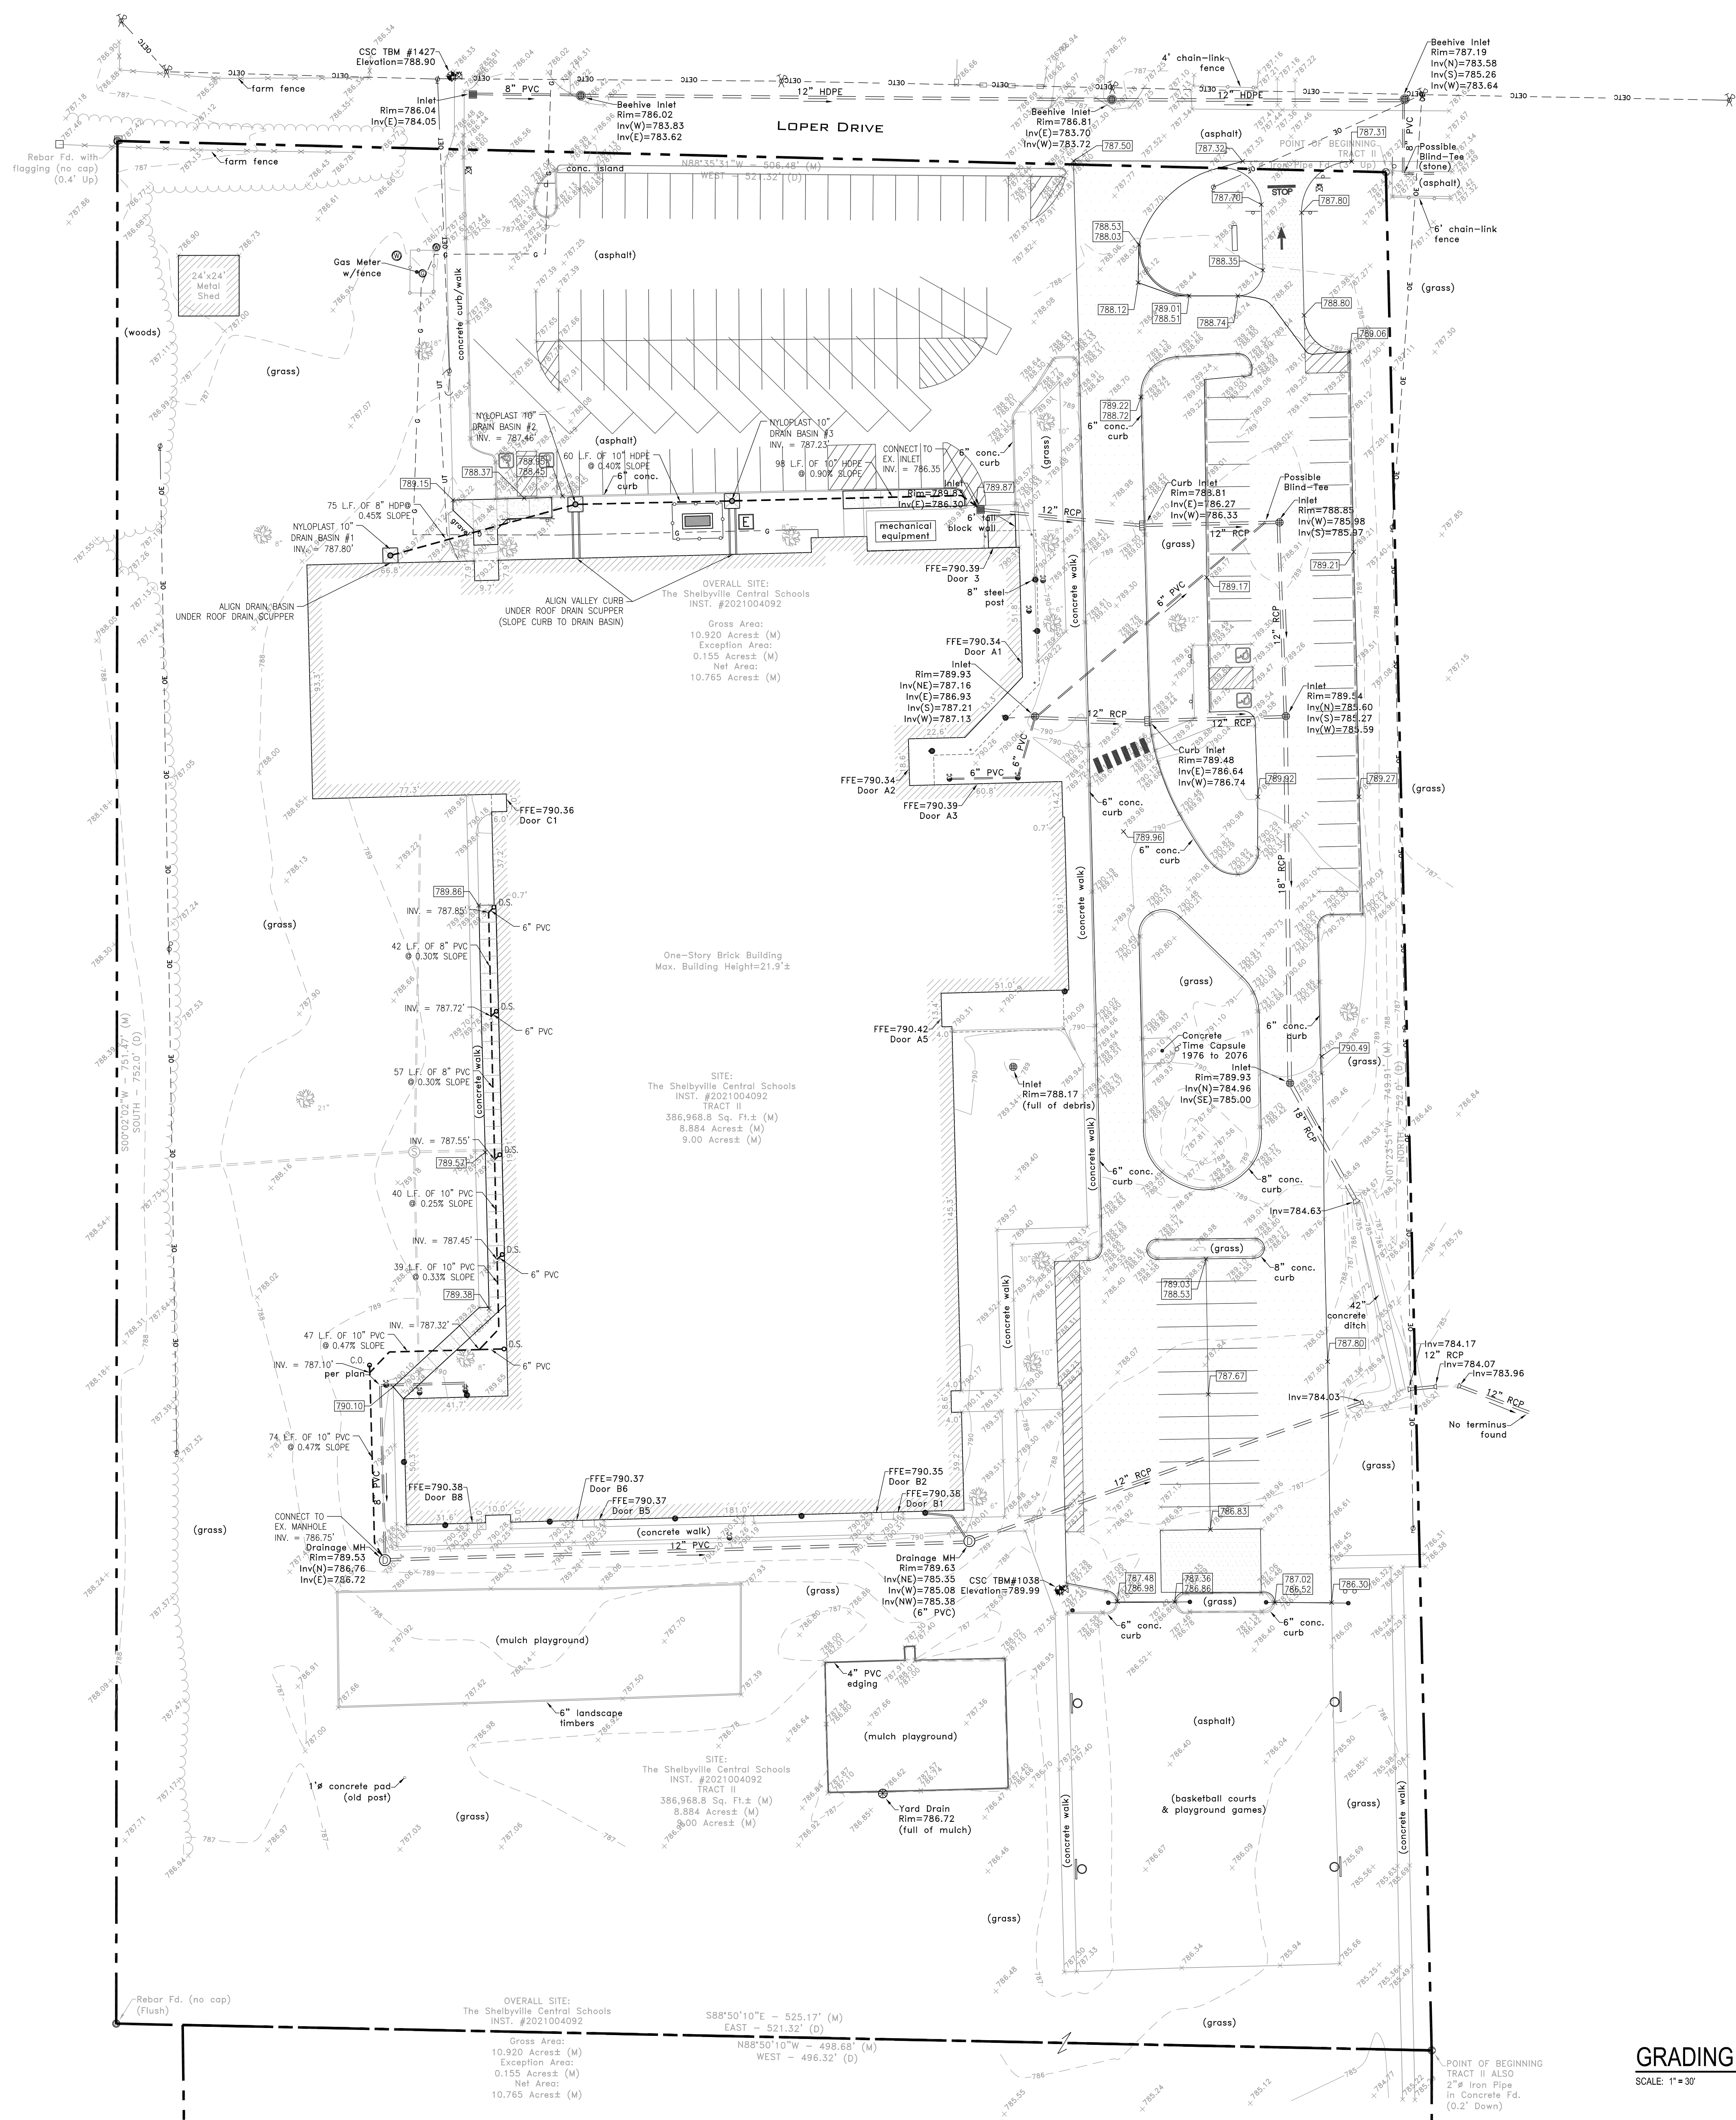

- ### GRADING GENERAL NOTES
1. PROVIDE POSITIVE DRAINAGE IN ALL AREAS. PAVING CONTRACTOR SHALL TEST FOR ANY PONDING CONDITIONS AFTER INSTALLATION AND CORRECT.
 2. PROVIDE SMOOTH TRANSITION FROM NEW AREAS TO EXISTING FEATURES AS NECESSARY.
 3. ALL AREAS WHERE PROPOSED ASPHALT PAVEMENT MEETS THE EXISTING PAVEMENT THE EXISTING PAVEMENT EDGE SHALL BE PROPERLY SEALED WITH A TACK COAT MATERIAL.
 4. THE EXCAVATING CONTRACTOR MUST TAKE PARTICULAR CARE WHILE EXCAVATING AROUND EXISTING TREES SO NOT TO DISTURB AND TO MINIMIZE OR ELIMINATE DAMAGE TO ROOT SYSTEM.
 5. THE EXCAVATING CONTRACTOR MUST TAKE PARTICULAR CARE WHEN EXCAVATING IN AND AROUND EXISTING UTILITY LINES AND EQUIPMENT. VERIFY COVER REQUIREMENTS BY UTILITY CONTRACTORS AND/OR UTILITY COMPANIES SO NOT TO CAUSE DAMAGE.
 6. THE EXCAVATING CONTRACTOR OR LANDSCAPING CONTRACTOR SHALL INSTALL THE FINISH GRADE AT 1/2" BELOW PAVEMENTS WHEN SHEET DRAINAGE IS PROPOSED ACROSS THAT SEEDED AREA.
 7. ALL AREAS WHERE THE EXISTING PAVEMENT OR PAVEMENTS ARE DAMAGED DURING CONSTRUCTION FROM TRAFFIC BY THE GENERAL CONTRACTOR, SUBCONTRACTORS OR SUPPLIERS, SHALL BE RESURFACED OR RECONSTRUCTED AT LEAST TO THEIR ORIGINAL CONDITION AFTER THE CONSTRUCTION WORK IS COMPLETED.
 8. ALL ROOF DRAIN AND STORM SEWER PIPING, STRUCTURES, CASTINGS, DOWN SPOUT ADAPTERS, AND OTHER ACCESSORIES TO BE PROVIDED BY GENERAL TRADES. LOCATION OF DOWN SPOUT BOOTS TO BE COORDINATED WITH ROOFING CONTRACTOR.



VERTICAL DATUM:

C&G S 269 1947 ELEVATION 798.17 (NAVD 88)

A DISK SET ABOUT 0.4 FEET BELOW THE RAILROAD TRACK ABOUT 2.05 MILES SOUTHEAST ALONG THE NEW YORK CENTRAL RAILROAD FROM THE STATION AT SHELBYVILLE, SET IN THE TOP OF THE SOUTHEAST END OF THE NORTHEAST HEAD WALL OF CONCRETE ARCH RAILROAD OVER PASS NO. 398A OVER MCKAY ROAD, ABOUT 30 YARDS NORTHWEST OF LIGHT SIGNAL NO. 802, AND 6 FEET NORTHWEST OF THE NORTHEAST RAIL.

CSC TBM #1427 ELEVATION 788.90

CUT "X" ON THE NORTH MOST BONNET BOLT OF A FIRE HYDRANT LOCATED AT THE NORTHWEST CORNER OF LOPER DRIVE AND DRAKE DRIVE, APPROXIMATELY 34 FEET NORTHWEST OF THE INTERSECTION.

CSC TBM #1038 ELEVATION 789.99


CUT "X" ON THE NORTH NORTHWEST BONNET BOLT OF A FIRE HYDRANT LOCATED 31.9 FEET SOUTH AND 38.1 FEET EAST OF THE SOUTHEASTERN CORNER OF THE BRICK BUILDING KNOWN CURRENTLY AS WILLIAM F LOPER ELEMENTARY SCHOOL.

GRADING & DRAINAGE PLAN

SCALE: 1"=30'



SHELBYVILLE CENTRAL SCHOOLS
LOPER ELEMENTARY RENOVATION
901 LOPER DRIVE
SHELBYVILLE, IN 46176

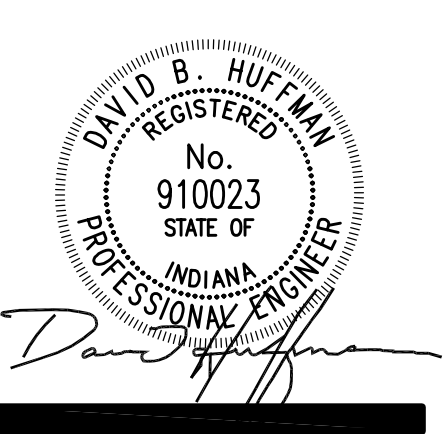

REVISIONS:	
1	DATE: 04.20.22
2	DATE: 04.20.22
3	DATE: 04.20.22
4	DATE: 04.20.22
CONSTRUCTION DOCUMENTS	
PROJECT: #21139	
DATE: 04.06.22	
DRAWN BY: DBH	

GRADING & DRAINAGE
PLAN



C301

GENERAL PLUMBING NOTES:

A. REFERENCE SHEET M-000 FOR PLUMBING SYMBOLS, LEGENDS, ABBREVIATIONS AND ADDITIONAL GENERAL NOTES.

SHEET PLAN NOTES

1. CONNECT NEW PLUMBING FIXTURE TO EXISTING WATER, WASTE, AND VENT PIPING.
2. 2 1/2" CW DOWN IN CHASE. ROUTE 2 1/2" CW LINE FULL SIZE. PROVIDE WHA 'D'.
3. 1/2" CW AND 1/2" HW DROP. 1 1/2" V RISE. 2" W DOWN.
4. CONNECT NEW SINK TO EXISTING WASTE, WATER, AND VENT.
5. CONNECT NEW PLUMBING FIXTURE TO EXISTING WATER, WASTE, AND VENT PIPING. PROVIDE SHUT OFF VALVE ON COLD WATER LINE.

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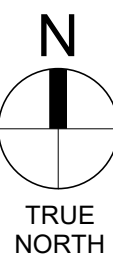
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1	4/22/2022	Addendum 1

100% Construction Documents


CDG PROJECT: #211028
DATE: 04/06/2022
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FIRST FLOOR
PLUMBING
PLAN - UNIT B

P-101B



1 FIRST FLOOR PLUMBING PLAN - UNIT B
1/8" = 1'-0"

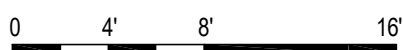

GENERAL DEMOLITION NOTES:

- A. REFERENCE SHEET M-000 FOR PLUMBING SYMBOLS, LEGENDS, ABBREVIATIONS AND ADDITIONAL GENERAL NOTES.
B. FIELD VERIFY LOCATION AND SIZES OF EXISTING WASTE, VENT, CW, AND HW PIPING PRIOR TO ANY WORK.

SHEET DEMO PLAN NOTES

- EXISTING WATER CLOSET TO BE REMOVED COMPLETE. PREPARE ROUGH-IN FOR NEW FIXTURE.
- EXISTING LAVATORY TO BE REMOVED COMPLETE. PREPARE ROUGH-IN FOR NEW FIXTURE.
- EXISTING WATER CLOSET TO BE REMOVED COMPLETE. REMOVE FIXTURE SUPPORT, ALL ASSOCIATED WATER, WASTE, AND VENT PIPING.
- EXISTING URINAL TO BE REMOVED COMPLETE. REMOVE FIXTURE SUPPORT, ALL ASSOCIATED WATER, WASTE, AND VENT PIPING.
- EXISTING WASHFOUNTAIN TO BE REMOVED COMPLETE. REMOVE ALL ASSOCIATED WATER, WASTE, AND VENT PIPING. PATCH WALL SURFACE AT ROUGH-INS.
- EXISTING FLOOR DRAIN TO BE REMOVED COMPLETE. CAP/ABANDON WASTE PIPE. PATCH FLOOR TO MATCH ADJACENT FLOOR ELEVATION/FINISH.
- EXISTING WATER COOLER ROUGH-IN. WASTE/VENT ROUGH-IN TO REMAIN. WATER ROUGH-IN TO BE REMOVED.
- DISCONNECT EXISTING COLD WATER BRANCH PIPING FROM MAIN AND PREPARE BRANCH FOR NEW CONNECTION. CAP BRANCH AT MAIN.
- EXISTING SINK TO BE REMOVED COMPLETE. REMOVE ALL ASSOCIATED WATER, WASTE, AND VENT PIPING. CAP WASTE ROUGH-IN BEYOND FINISHED SURFACE. CAP WATER PIPE AT CONNECTION TO MAIN.
- EXISTING SINK TO BE REMOVED COMPLETE. PREPARE ROUGH-INS FOR NEW FIXTURE.
- EXISTING WATER COOLER TO BE REMOVED COMPLETE. PREPARE ROUGH-INS FOR NEW FIXTURE.
- EXISTING SINK TO BE REMOVED COMPLETE. REMOVE, CAP WATER AND WASTE ROUGH-IN BEYOND FINISHED SURFACE.
- EXISTING LAVATORY TO BE REMOVED COMPLETE. REMOVE FIXTURE SUPPORT, ALL ASSOCIATED WATER, WASTE, AND VENT PIPING.
- EXISTING WASHER BOX TO BE REMOVED COMPLETE. REMOVE FIXTURE SUPPORT, ALL ASSOCIATED WATER, WASTE, AND VENT PIPING. CAP WASTE PIPE BELOW FINISHED FLOOR, CAP WATER, WASTE, AND VENT PIPING AT MAIN.
- EXISTING SINK TO BE REMOVED COMPLETE. REMOVE ALL ASSOCIATED WATER, WASTE, AND VENT PIPING. CAP WASTE PIPE BELOW FINISHED FLOOR, CAP WATER, WASTE, AND VENT PIPING AT MAIN.
- EXISTING SINK TO BE REMOVED COMPLETE. PREPARE ROUGH-INS FOR NEW CONNECTION.
- REMOVE EXISTING WATER SOFTENER AND BRINE TANK.

REVISIONS:



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1	4.22.2022	Addendum 1

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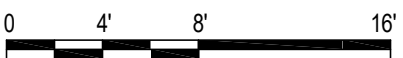
CDG PROJECT: #21102B
DATE: 04.06.2022
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FIRST FLOOR
PLUMBING
DEMO PLAN -
UNIT B

PD101B




1 FIRST FLOOR PLUMBING DEMO PLAN - UNIT B
1/8" = 1'-0"

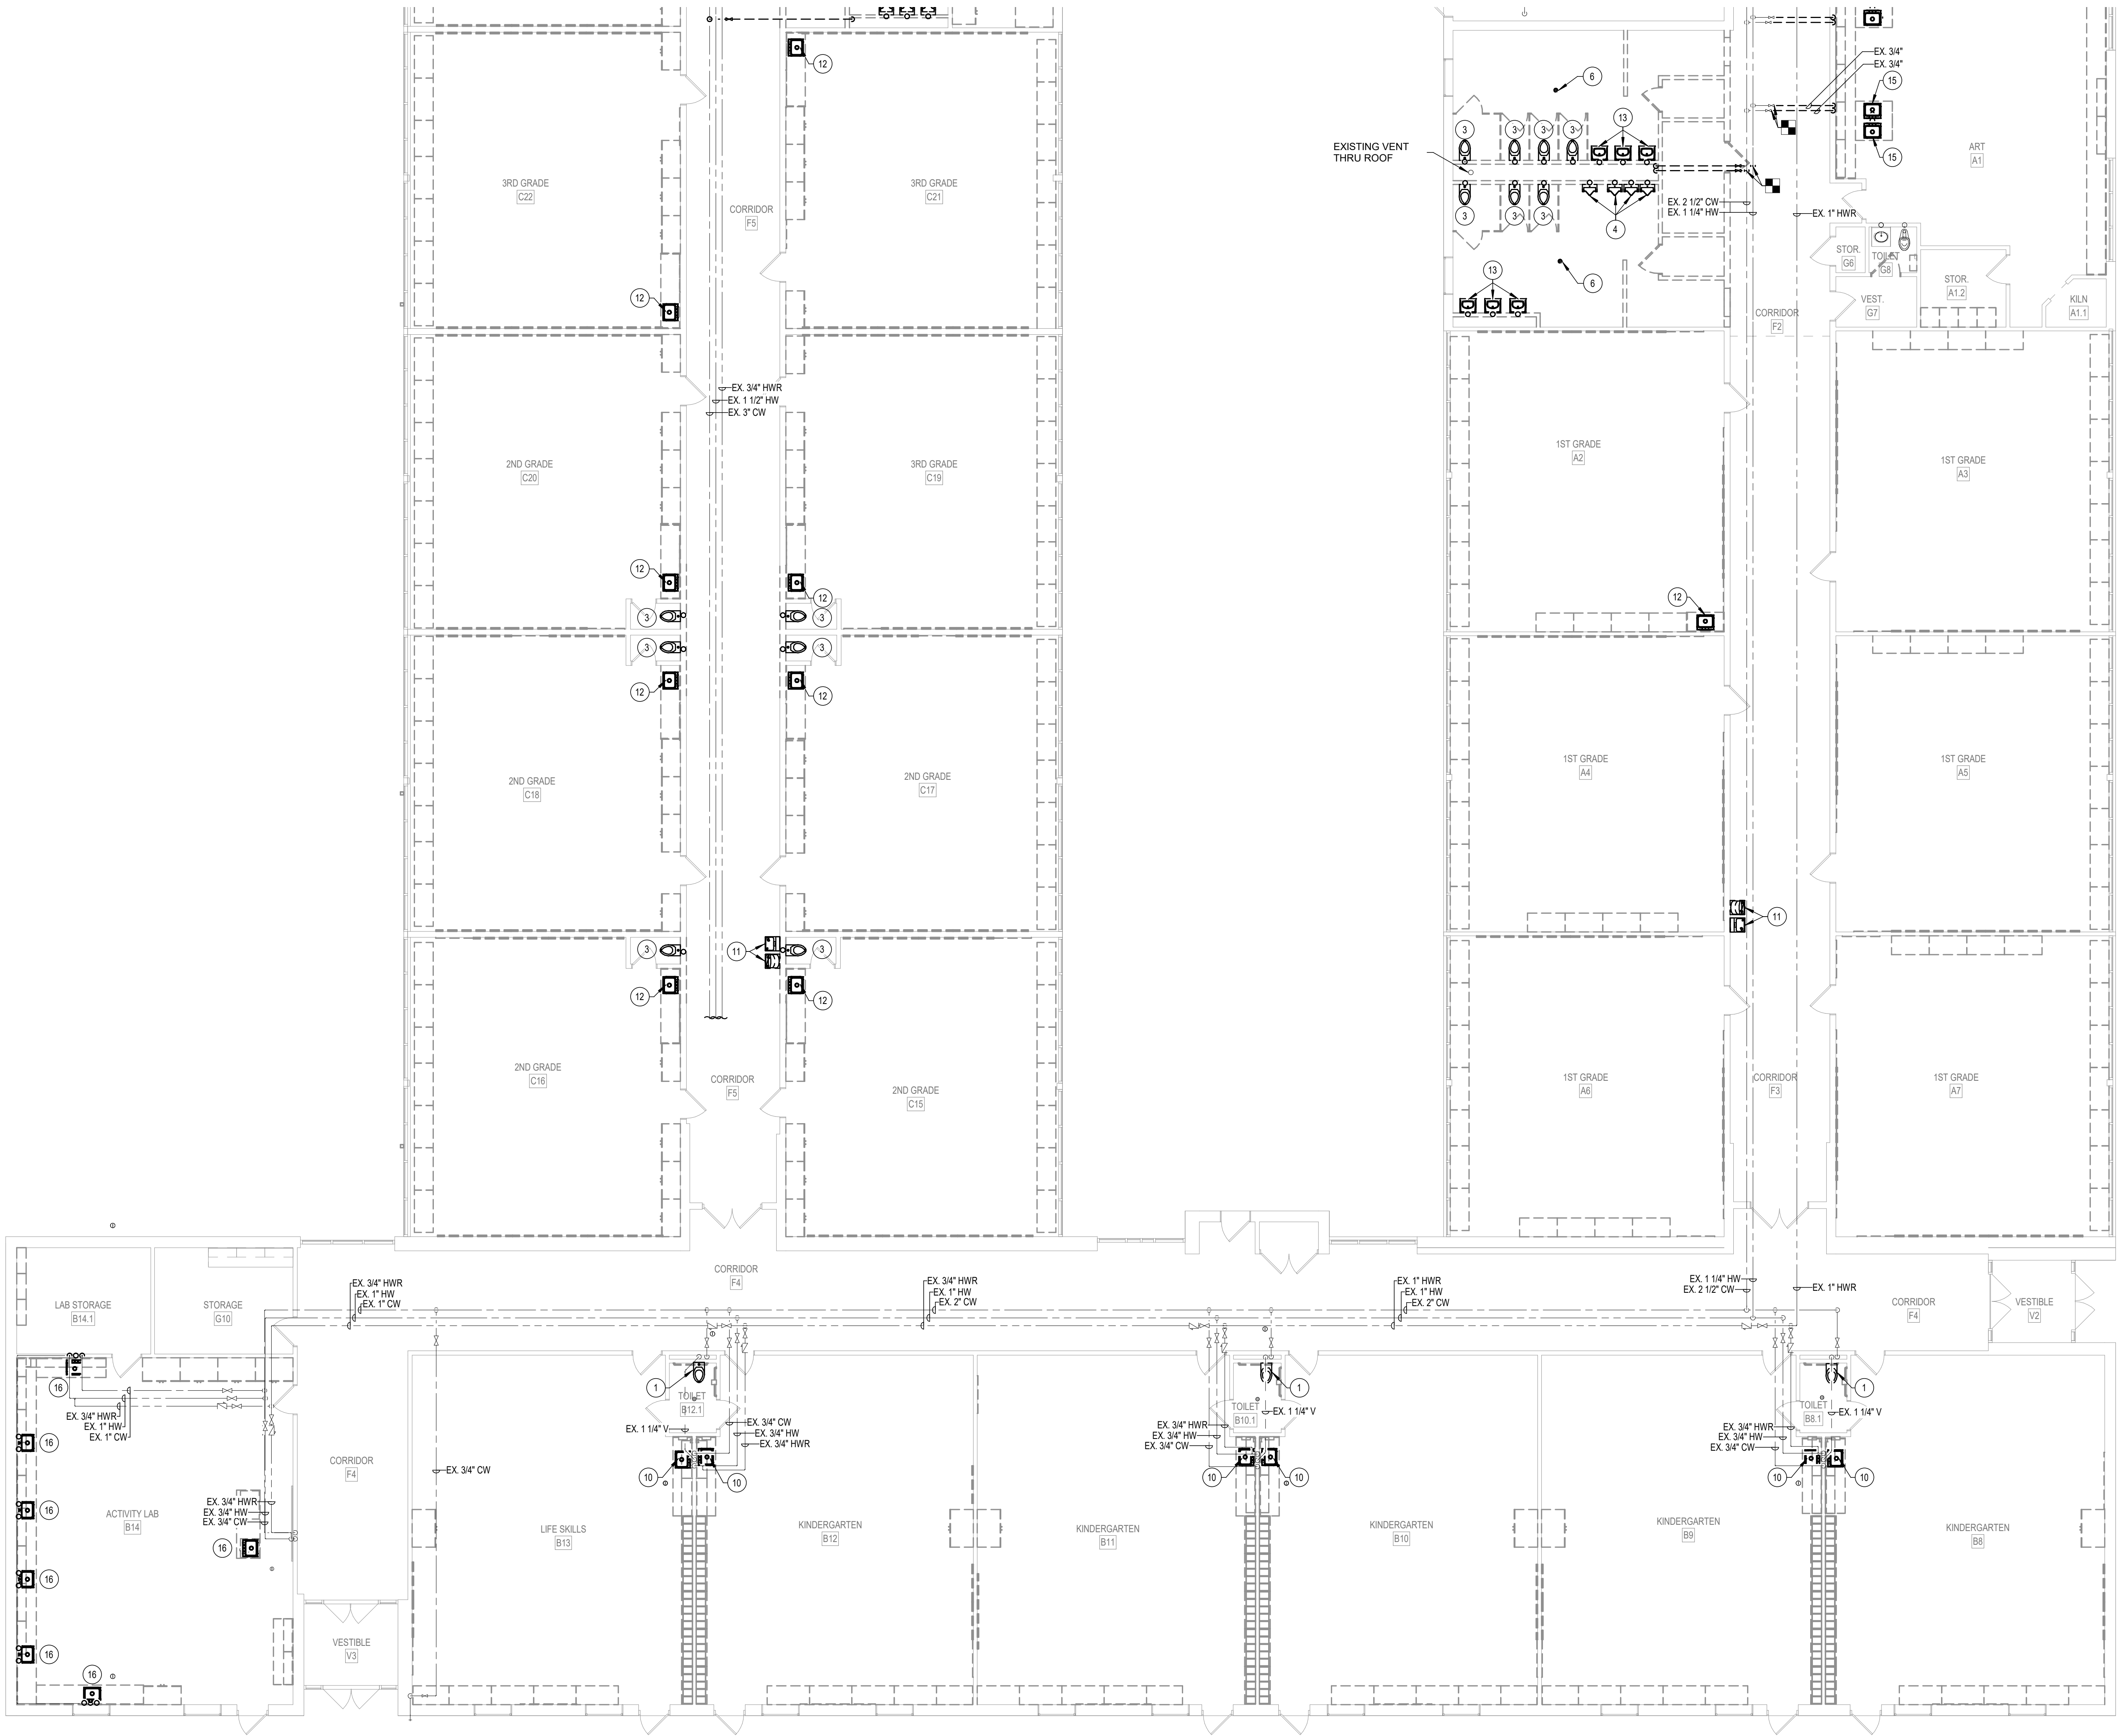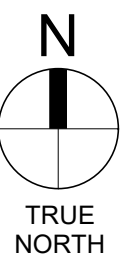

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1 FLOOR PLAN - FIRST FLOOR - OVERALL

SCALE: 1/16" = 1'-0" REF. 14 / A763

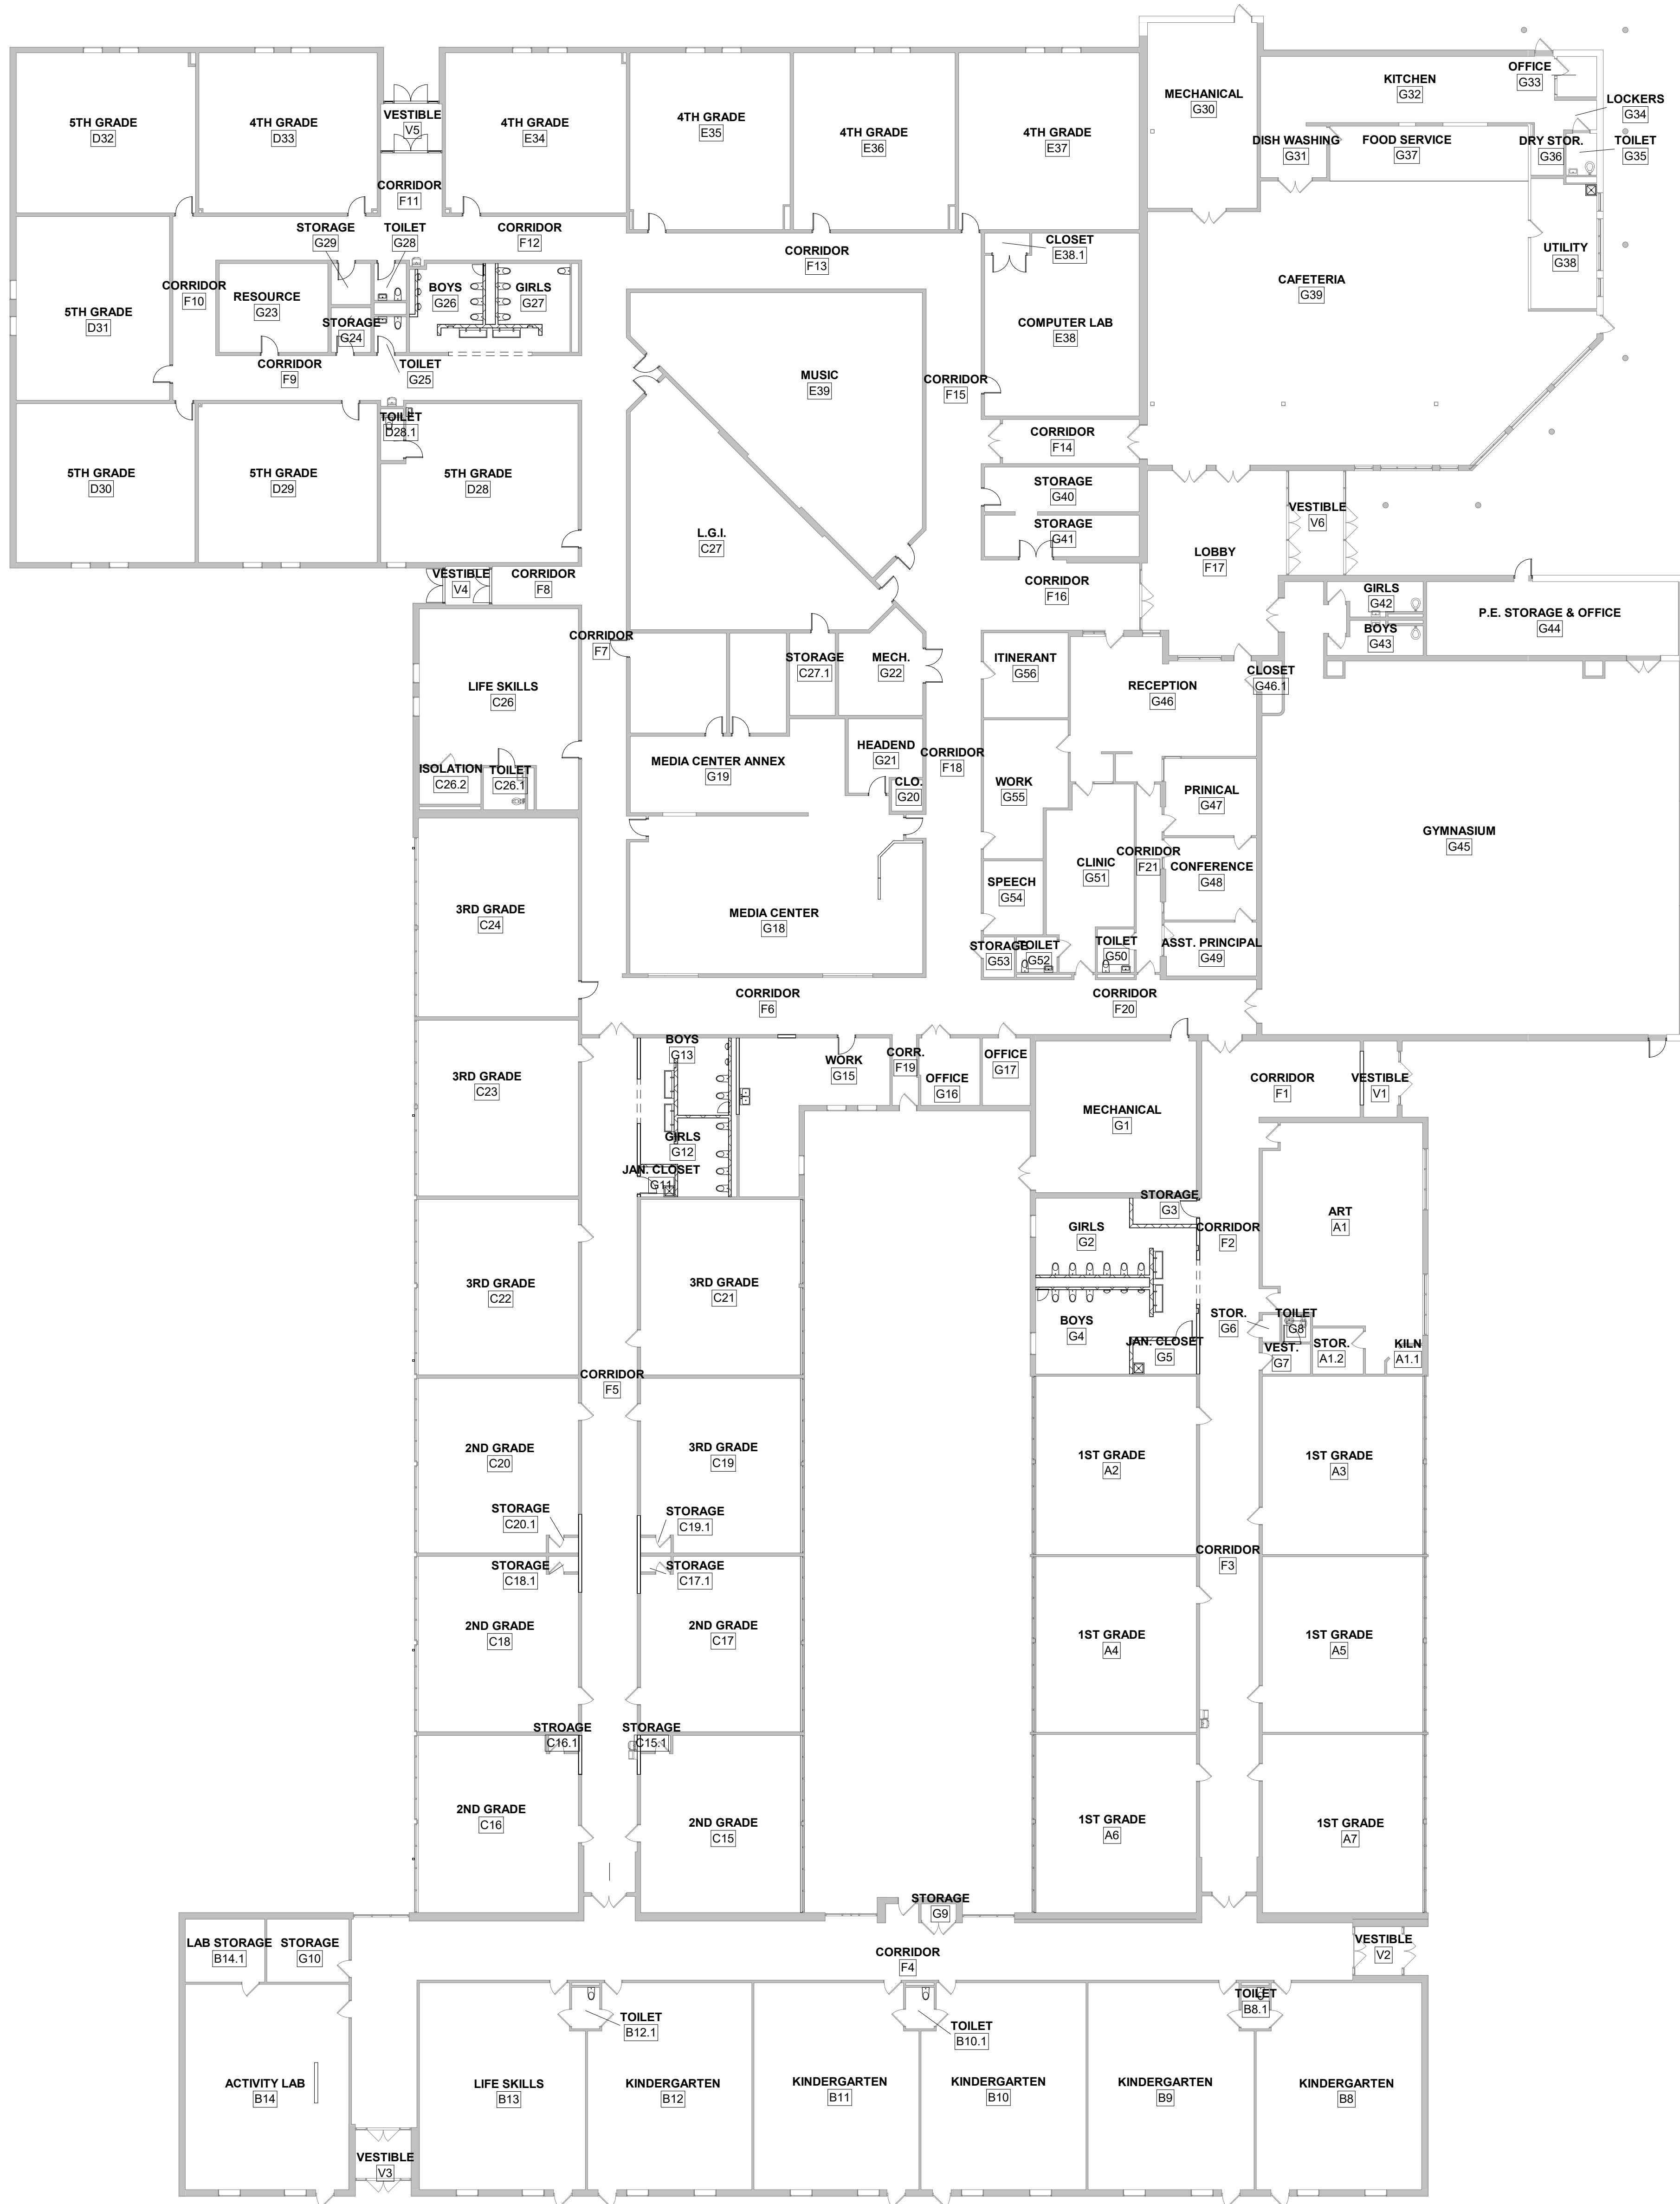

GENERAL NOTES

1. PROVIDE CORNER GUARDS AT ALL OUTSIDE CORNERS WITH GYPSUM BOARD FROM 1'-6" AFF TO 4'-0" AFF
2. PROVIDE BULL-NOSE FINISH ON ALL OUTSIDE CORNERS OF CMU WALLS
3. SEE A112 FOR ENLARGED PLANS
4. VIF ALL DIMENSIONS FOR CASEWORK
5. INTERIOR DIMENSIONS ARE TAKEN TO THE FACE OF MASONRY OR STUDS
6. FOR ALL RESTROOM FACILITIES AND JANITOR CLOSETS WITH GYPSUM WALL FINISH REPLACE 5/8" TYPE "X" GYPSUM BOARD WIHT 5/8" MOISTURE RESISTANT GYPSUM BOARD. SEE SPECS FOR DETAILS
7. COLUMN LOCATIONS IN CAFETERIA TO BE PAINTED PT-2
8. WALLS TO GO UP TO DECK UNLESS OTHERWISE NOTED
9. DO NOT PAINT OVER EXISTING VINYL WALL GRAPHICS, LETTERING, AND MURALS

SHELBYVILLE CENTRAL SCHOOLS
LOPER ELEMENTARY SCHOOL RENOVATIONS
901 LOPER DRIVE
SHELBYVILLE, IN 46176


LANCER+BEEBE, LLC
ARCHITECTURE | PLANNING | INTERIORS
220 N. COLLEGE AVE
INDIANAPOLIS, IN 46202

REVISIONS:		
#	Date	Desc.
1	4/20/2022	Revision 1

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PROJECT: #21140
DATE: 04/08/2022
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FLOOR PLAN -
FIRST FLOOR -
OVERALL



A011

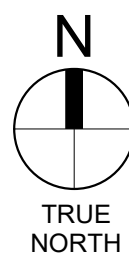PLT DATE/TIME: 4/20/2022 2:40:09 PM

1 DEMOLITION PLAN - FIRST FLOOR - UNIT A

SCALE: 1/8" = 1'-0" REF. 14 / A763



GENERAL NOTES - DEMO


1. COORDINATE DEMOLITION WORK WITH NEW WORK
2. PATCH, CLEAN, AND PREP SURFACES FOR NEW WORK
3. MODIFY EXISTING CEILING AS NEEDED TO ACCOMMODATE NEW WORK
4. OWNER SHALL HAVE FIRST RIGHT OF REFUSAL OF ANY DEMOLISHED DOORS, CASEWORK, MARKERBOARDS, CHALKBOARDS, PROJECTORS, PROJECTOR SCREENS, ETC.

PLAN NOTES - DEMOLITION

1. NO ARCHITECTURAL WORK IN THIS AREA
2. DEMO EXISTING DOOR AND DOOR HARDWARE. FRAME TO REMAIN.
3. REMOVE EXISTING WALL, TILE, CLEAN, PATCH AND PREP SURFACES FOR NEW WORK. AREA TO RECEIVE LEVEL 5 FINISH
4. DEMO EXISTING PLUMBING FIXTURES COMPLETE. REFER TO P-SERIES.
5. DEMO EXISTING TOILET PARTITIONS COMPLETE. PREPARE ALL SUFACES FOR NEW WORK.
6. REMOVE EXISTING CASEWORK COMPLETE. PREP ALL SURFACES FOR NEW CONSTRUCTION.
7. REMOVE EXISTING COAT HOOKS. PATCH AND PREP SURFACES FOR NEW WORK.
8. DEMO EXISTING TILE AND TILE BASE. PREPARE SURFACES FOR NEW WORK.
9. REMOVE EXISTING CHALKBOARD OR MARKERBOARD AND TRACK. SALVAGE BOARDS AND TRACKS FOR REUSE/RELOCATION. COORDINATE STORAGE OF BOARDS AND TRACKS WITH OWNER.
10. REMOVE EXISTING TACKBOARDS AND TACK STRIPS. SALVAGE TACK BOARDS FOR REUSE/RELOCATION. COORDINATE STORAGE OF TACK BOARDS WITH OWNER.
11. DEMO WOODFRAME CHALKBOARDS AND TACKBOARDS. PREPARE SURFACES FOR NEW WORK.
12. DEMO EXISTING DOOR AND FRAME. PREPARE OPENING FOR NEW INFILL WALL. PATCH AND REPAIR AS NEEDED.
13. DEMO EXISTING WALL TO EXTENTS SHOWN. PATCH AND REPAIR ADJACENT SURFACES FOR NEW WORK.
14. SELECTIVELY DEMO EXISTING PROJECTORS, DROPS, AND SCREENS. OWNER HAS FIRST RIGHT OF REFUSAL.
15. DEMO EXISTING COUNTER AND BACKSPLASH. PREP SURFACE AND ADJACENT SURFACES FOR NEW SOLID SURFACE COUNTER.
16. DEMO EXTERIOR DOOR AND FRAME COMPLETE. PREPARE SURFACES FOR NEW WORK.
17. DEMO EXISTING DOWNSPOUT COMPLETE. PATCH, PREP, PREPARE SURFACES FOR NEW WORK.
18. DEMO EXISTING STOREFRONT COMPLETE. PATCH, PREP, AND PREPARE SURFACES FOR NEW WORK.
20. REMOVE VINYL WALL MURAL AND PAINT BEHIND. STORE AND REINSTALL.
21. DEMO EXISTING INTEGRATED GRID MAT SYSTEM. FILL AND LEVEL FLOOR AS REQUIRED FOR NEW FLOOR FINISH.
22. REMOVE EXISTING WALL MOUNTED TV AND BRACKET. SALVAGE AND STORE FOR REINSTALLATION.
24. DEMO TACKABLE SURFACES FLOOR TO CEILING. CLEAN, PATCH AND PREP SURFACES FOR NEW WORK. AREA TO RECEIVE LEVEL 5 FINISH
25. REMOVE ALL WALLCOVERING IN KINDERGARTEN WING. LEVEL, PATCH, AND REPAIR WALLS FOR NEW FINISH.
26. DEMO OPEN SHELVING COMPLETE. PATCH AND REPAIR WALL FOR NEW FINISH.
27. DEMO FRP SURROUND COMPLETE. PATCH AND REPAIR WALL FOR NEW FINISH.
28. EXISTING GYP CEILING TO REMAIN. PREP SURFACE FOR NEW PAINT.
29. REMOVE EXISTING FLOORING SURFACE TO EXTENTS SHOWN. PREP AREA FOR NEW WORK. ONLY APPLICABLE IF ALTERNATE IS ACCEPTED.
30. BASE BID: SELECTIVELY REMOVE EXISTING CASEWORK COMPLETE. PROTECT AND STORE FOR RELOCATION AND REINSTALLATION.
31. DEMO EXISTING EIFS SOFFIT COMPLETE. PREPARE AREA FOR NEW WORK.
32. DEMO EXTERIOR DOOR AND HARDWARE. EXTERIOR FRAME TO REMAIN AND PROTECT DURING CONSTRUCTION.
33. DEMO EXISTING CASEWORK COMPLETE. PREP ALL SURFACES FOR NEW CONSTRUCTION. ONLY APPLICABLE IF ALTERNATE IS ACCEPTED.
34. BASE BID: DEMO EXISTING COUNTER AND BACKSPLASH. PREP SURFACE AND ADJACENT SURFACES FOR NEW SOLID SURFACE COUNTER.

DEMOLITION KEY

- REMOVE FLOORING AND WALL BASE. REMOVE 2'x4' CEILING GRID, ACOUSTICAL TILE, AND EXISTING LIGHTING
- REMOVE 2'x4' CEILING GRID, ACOUSTICAL TILE, AND EXISTING LIGHTING

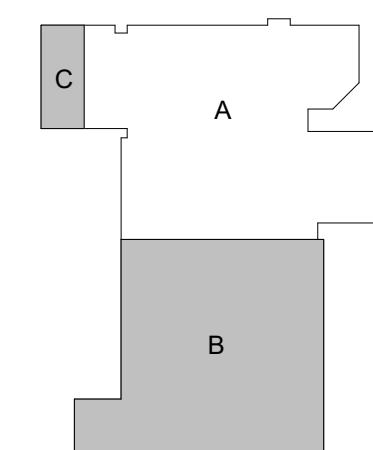

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SHELBYVILLE, IN 46176

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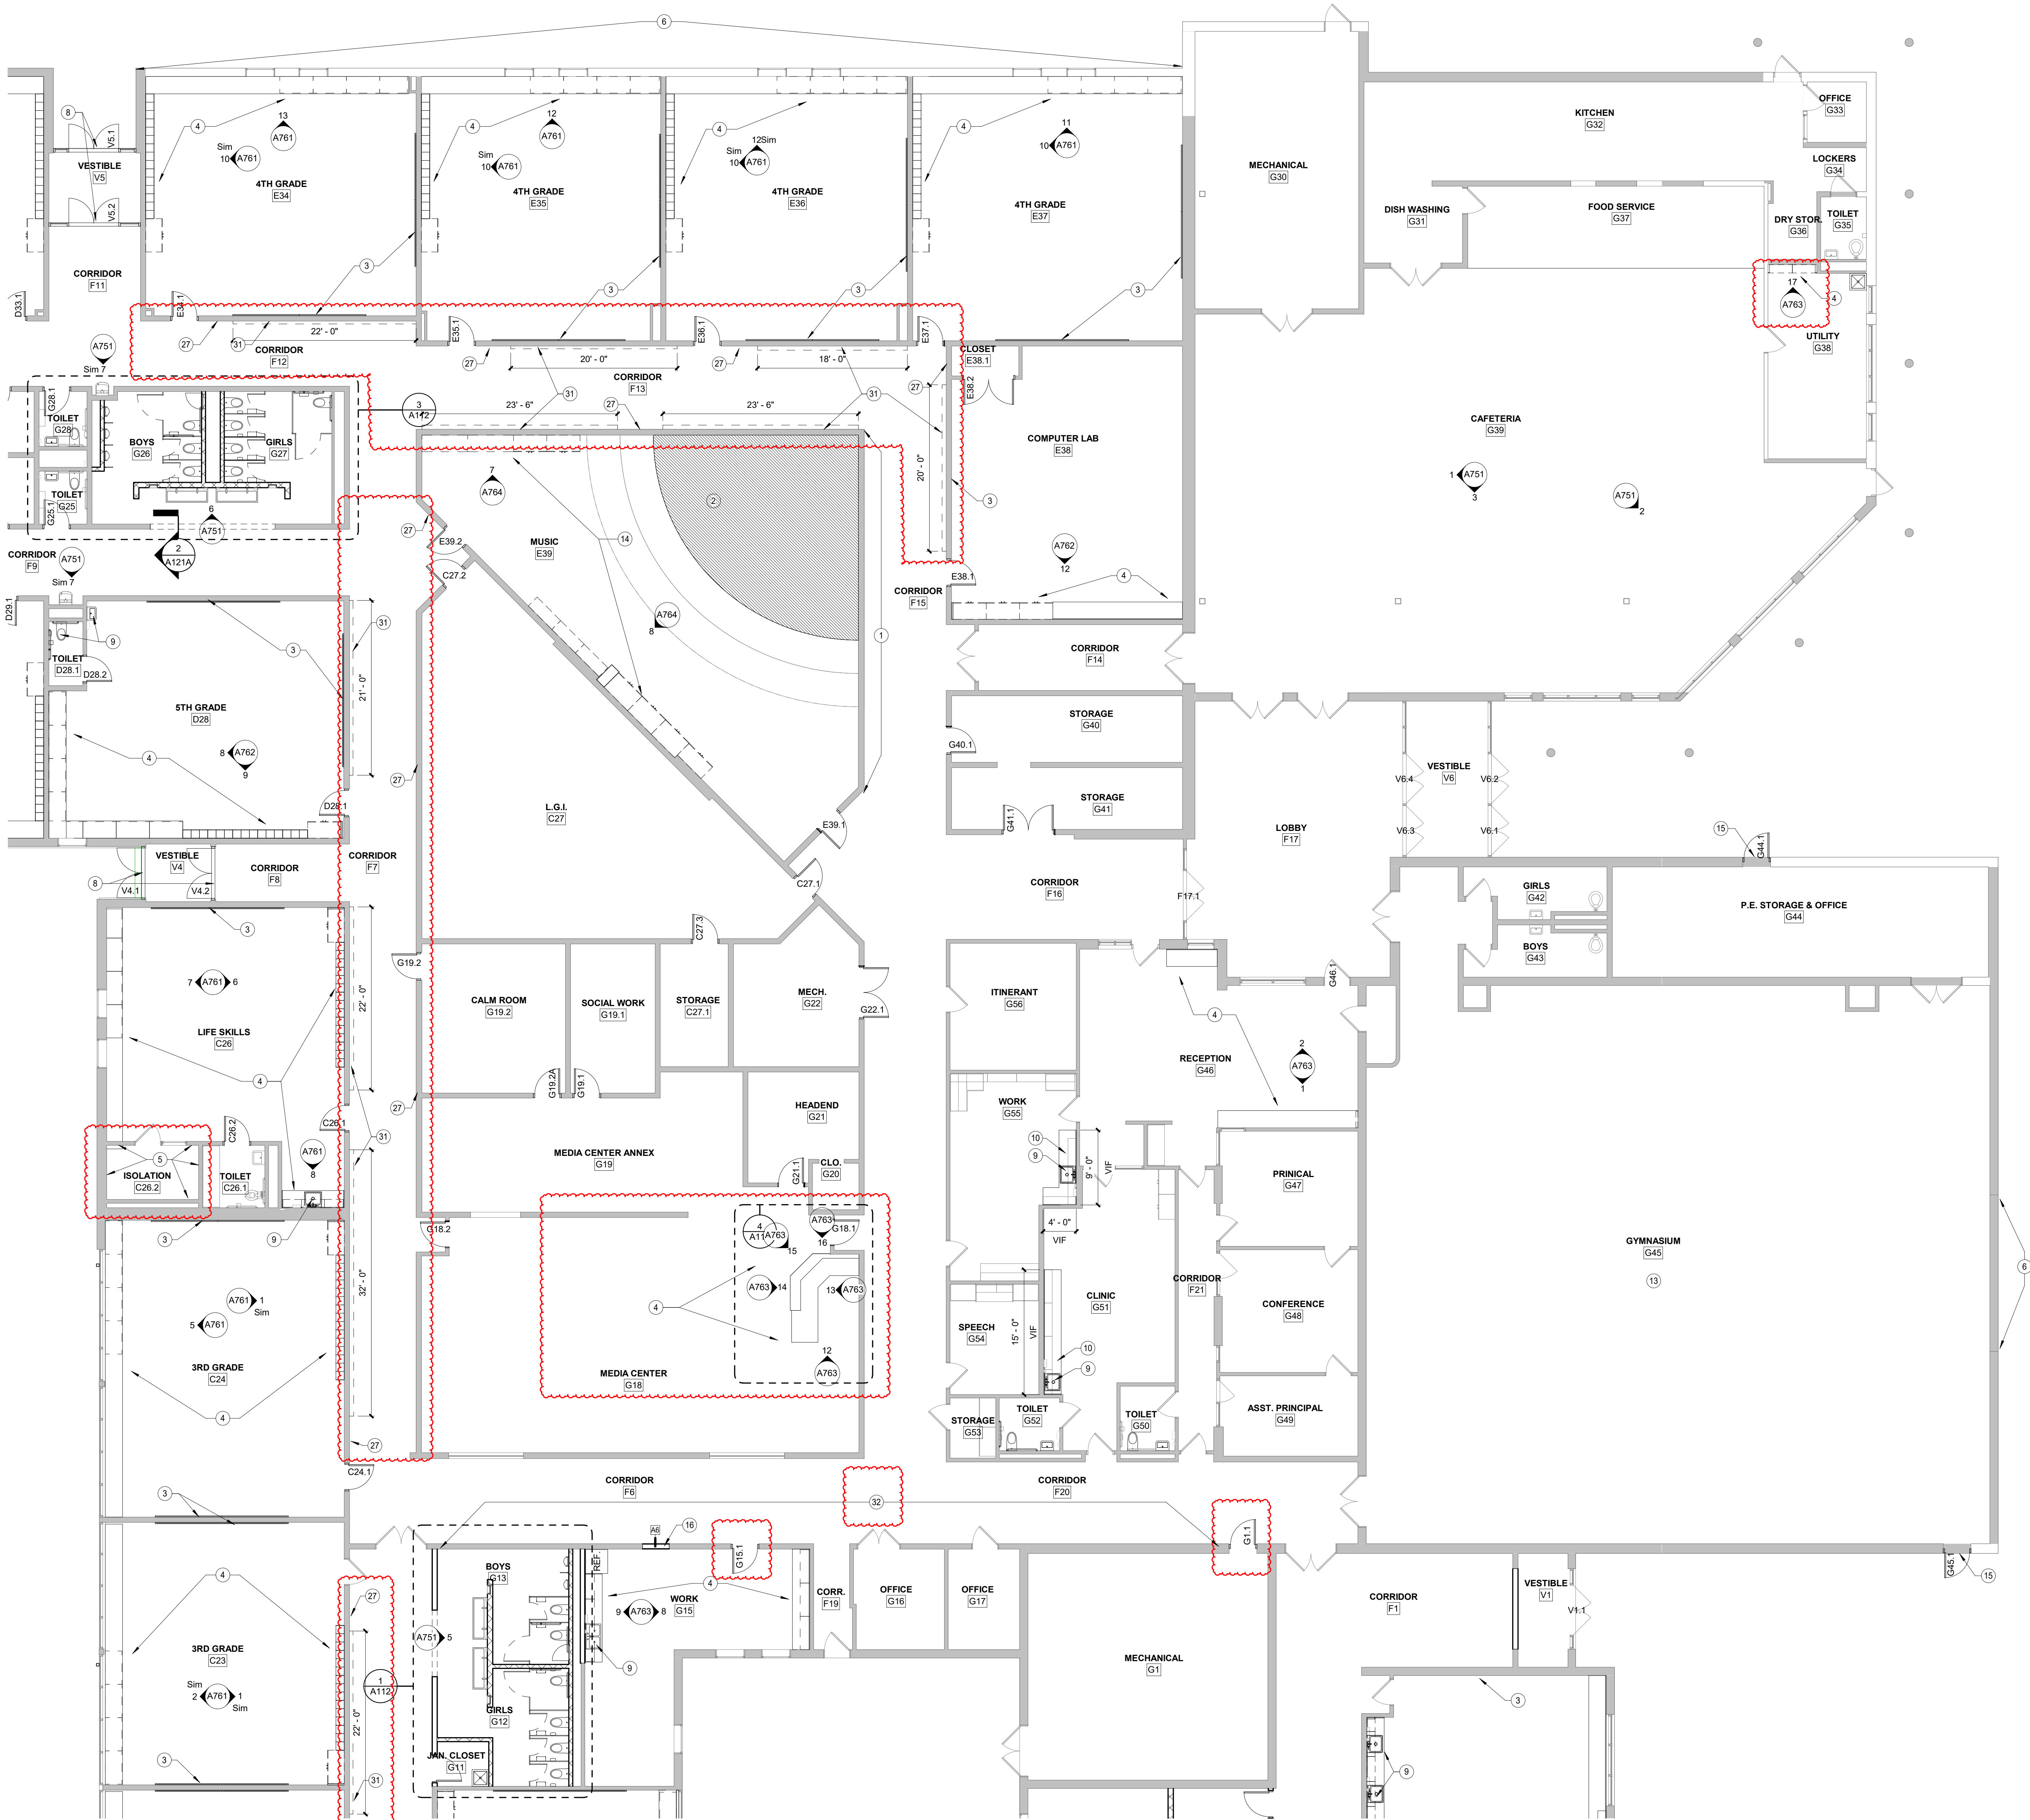
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1	4/20/2022	Revision 1

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PROJECT: #21140
DATE: 04/06/2022
DRAWN BY: Author

DEMOLITION
PLAN - FIRST
FLOOR - UNIT A

AD101A



GENERAL NOTES

1. PROVIDE CORNER GUARDS AT ALL OUTSIDE CORNERS WITH GYPSUM BOARD FROM 1'-6" AFF TO 4'-0" AFF.
2. PROVIDE BULL-NOSE FINISH ON ALL OUTSIDE CORNERS OF CMU WALLS.
3. SEE A112 FOR ENLARGED PLANS.
4. VIF ALL DIMENSIONS FOR CASEWORK.
5. INTERIOR DIMENSIONS ARE TAKEN TO THE FACE OF MASONRY OR STUDS.
6. FOR ALL RESTROOM FACILITIES AND JANITOR CLOSETS WITH GYPSUM WALL FINISH REPLACE 5/8" TYPE "X" GYPSUM BOARD WITH 5/8" MOISTURE RESISTANT GYPSUM BOARD. SEE SPECS FOR DETAILS.
7. COLUMN LOCATIONS IN CAFETERIA TO BE PAINTED PT-2.
8. WALLS TO GO UP TO DECK UNLESS OTHERWISE NOTED.
9. DO NOT PAINT OVER EXISTING VINYL WALL GRAPHICS, LETTERING, AND MURALS.

PLAN NOTES - FLOOR PLAN

1. REINSTALL VINYL WALL MURAL.
2. MUSIC PIT INFILL. REFER TO STRUCTURAL DRAWING FOR ADDITIONAL DETAILS. ALTERNATE BID.
3. REINSTALL MARKERBOARDS AND TACKBOARDS WITH TRACKS AS REQUIRED BY MANUFACTURER. MARKERBOARDS AND TACKBOARDS PROVIDED BY OWNER.
4. NEW CASEWORK. REFER TO CASEWORK ELEVATIONS.
5. WALL MOUNTED WALL PADDING FLOOR TO CEILING.
6. MASONRY RESTORATION WORK. REFER TO S-SERIES DRAWINGS.
8. INSTALL NEW ALUMINUM EXTERIOR DOORS. REFER TO DOOR SCHEDULE AND SPECIFICATIONS.
9. NEW PLUMBING FIXTURES. REFER TO P-SERIES.
10. NEW COUNTERTOP OVER EXISTING CABINETS.
11. REINSTALL SALVAGED CASEWORK AS BASE BID. OMIT REINSTALLTION IF ALTERNATE IS ACCEPTED.
12. INSTALL NEW WALL FINISH SURROUND TO 4'-0" AFF. REF FINISH LEGEND.
13. LED SCOREBOARDS AS ALTERNATE. REF E-SERIES.
14. NEW CASEWORK AS ALTERNATE. REFER TO CASEWORK ELEVATIONS.
15. INSTALL NEW HOLLOW METAL EXTERIOR DOORS AND FRAMES. REFER TO DOOR SCHEDULE AND SPECIFICATIONS.
16. FINISH SURFACE OF WALL TO ALIGN WITH EXISTING WALL PLANES. INSTALL FURRING AS REQUIRED.
17. NEW TOILET PAPER DISPENSERS.
18. NEW SANITARY NAPKIN DISPOSAL CONTAINERS.
19. NEW RECESSED PAPER TOWEL DISPENSERS. SEE ELEVATIONS FOR ADDITIONAL LOCATIONS.
20. NEW SOAP DISPENSERS. SEE ELEVATIONS FOR ADDITIONAL LOCATIONS.
21. INSTALL NEW TACKBOARD, 4'-0" H x 4'-0" W.
22. INSTALL THREE ROWS OF TACKSTRIPS. TOP TACKSTRIP SHALL BE AT 6'-6" AFF, AND SPACED 1'-8" O.C.
23. NEW PLUMBING ACCESS PANEL. COORDINATE LOCATION WITH ADJACENT EQUIPMENT AND FIXTURES.
24. NEW 3'-0" H x 4'-0" W MIRRORS.
25. BASE BID: NEW 8'-0" COUNTERTOP OVER EXISTING CABINETS. VIF.
26. BASE BID: NEW COUNTERTOP OVER EXISTING CABINETS. VIF.
27. REINSTALL EXISTING TACKBOARDS. CONFIRM FINAL INSTALL HEIGHT AND PLACEMENT WITH OWNER.
28. INSTALL ONE ROW OF TACKSTRIP AT 5'-0" AFF.
29. NEW TOILET/JURNAL PARTITIONS.
30. ADA GRAB BARS.
31. INSTALL TWO ROWS OF TACKSTRIPS. TOP TACKSTRIP SHALL BE AT 5'-0" AFF, AND SPACED 1'-8" O.C.
32. NEW WALL MURAL / VINYL WALL DECAL AT FULL HEIGHT OF AVAILABLE WALL.

1 FLOOR PLAN - FIRST FLOOR - UNIT A

SCALE: 1/8" = 1'-0" REF. 14 / A763

#	Date	Desc.
1	4.20.2022	Revision 1

GENERAL NOTES

1. PROVIDE CORNER GUARDS AT ALL OUTSIDE CORNERS WITH GYPSUM BOARD FROM 1'-6" AFF TO 4'-0" AFF
2. PROVIDE BULL-NOSE FINISH ON ALL OUTSIDE CORNERS OF CMU WALLS
3. SEE A112 FOR ENLARGED PLANS
4. VIF ALL DIMENSIONS FOR CASEWORK
5. INTERIOR DIMENSIONS ARE TAKEN TO THE FACE OF MASONRY OR STUDS
6. FOR ALL RESTROOM FACILITIES AND JANITOR CLOSETS WITH GYPSUM WALL FINISH REPLACE 5/8" TYPE "X" GYPSUM BOARD WITH 5/8" MOISTURE RESISTANT GYPSUM BOARD. SEE SPECS FOR DETAILS
7. COLUMN LOCATIONS IN CAFETERIA TO BE PAINTED PT-2
8. WALLS TO GO UP TO DECK UNLESS OTHERWISE NOTED
9. DO NOT PAINT OVER EXISTING VINYL WALL GRAPHICS, LETTERING, AND MURALS

PLAN NOTES - FLOOR PLAN

1. REINSTALL VINYL WALL MURAL
2. MUSIC PIT INFILL. REFER TO STRUCTURAL DRAWING FOR ADDITIONAL DETAILS. ALTERNATE BID.
3. REINSTALL MARKERBOARDS AND TACKBOARDS WITH TRACKS AS REQUIRED BY MANUFACTURER. MARKERBOARDS AND TACKBOARDS PROVIDED BY OWNER.
4. NEW CASEWORK. REFER TO CASEWORK ELEVATIONS.
5. WALL MOUNTED WALL PADDING FLOOR TO CEILING.
6. MASONARY RESTORATION WORK. REFER TO S-SERIES DRAWINGS.
7. INSTALL NEW ALUMINUM EXTERIOR DOORS. REFER TO DOOR SCHEDULE AND SPECIFICATIONS.
8. NEW PLUMBING FIXTURES. REFER TO P-SERIES.
9. NEW COUNTERTOP OVER EXISTING CABINETS.
10. REINSTALL SALVAGED CASEWORK AS BASE BID. OMIT REINSTALLATION IF ALTERNATE IS ACCEPTED.
11. INSTALL NEW WALL FINISH SURROUND TO 4'-0" AFF. REF FINISH LEGEND.
12. LED SCOREBOARDS AS ALTERNATE. REF E-SERIES.
13. NEW CASEWORK AS ALTERNATE. REFER TO CASEWORK ELEVATIONS.
14. INSTALL NEW HOLLOW METAL EXTERIOR DOORS AND FRAMES. REFER TO DOOR SCHEDULE AND SPECIFICATIONS.
15. FINISH SURFACE OF WALL TO ALIGN WITH EXISTING WALL PLANES. INSTALL FURRING AS REQUIRED.
16. NEW TOILET PAPER DISPENSERS.
17. NEW SANITARY NAPKIN DISPOSAL CONTAINERS.
18. NEW RECESSED PAPER TOWEL DISPENSERS. SEE ELEVATIONS FOR ADDITIONAL LOCATIONS.
19. NEW SOAP DISPENSERS. SEE ELEVATIONS FOR ADDITIONAL LOCATIONS.
20. INSTALL NEW TACKBOARD, 4'-0" H x 4'-0" W.
21. INSTALL THREE ROWS OF TACKSTRIPS. TOP TACKSTRIP SHALL BE AT 6'-6" AFF, AND SPACED 1'-8" O.C.
22. NEW PLUMBING ACCESS PANEL. COORDINATE LOCATION WITH ADJACENT EQUIPMENT AND FIXTURES.
23. NEW 3'-0" H x 4'-0" W MIRRORS.
24. BASE BID: NEW 8'-0" COUNTERTOP OVER EXISTING CABINETS. VIF.
25. BASE BID: NEW 8'-0" COUNTERTOP OVER EXISTING CABINETS. VIF.
26. REINSTALL EXISTING TACKBOARDS. CONFIRM FINAL INSTALL HEIGHT AND PLACEMENT WITH OWNER.
27. INSTALL ONE ROW OF TACKSTRIP AT 5'-0" AFF.
28. NEW TOILET/URINAL PARTITIONS.
29. ADA GRAB BARS.
30. INSTALL TWO ROWS OF TACKSTRIPS. TOP TACKSTRIP SHALL BE AT 5'-0" AFF, AND SPACED 1'-8" O.C.
31. NEW WALL MURAL/VINYL WALL DECAL AT FULL HEIGHT OF AVAILABLE WALL.



1 FLOOR PLAN - FIRST FLOOR - UNIT B

SCALE: 1/8" = 1'-0" REF. 14 / A763


REVISIONS:			
#	Date	Desc.	
1	4.20.2022	Revision 1	

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PROJECT:	#21140		
DATE:	04.06.2022		
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FLOOR PLAN -
FIRST FLOOR -
UNIT B

A101B

1 FLOOR PLAN - FIRST FLOOR - UNIT C
SCALE: 1/8" = 1'-0" REF. 14 / A763

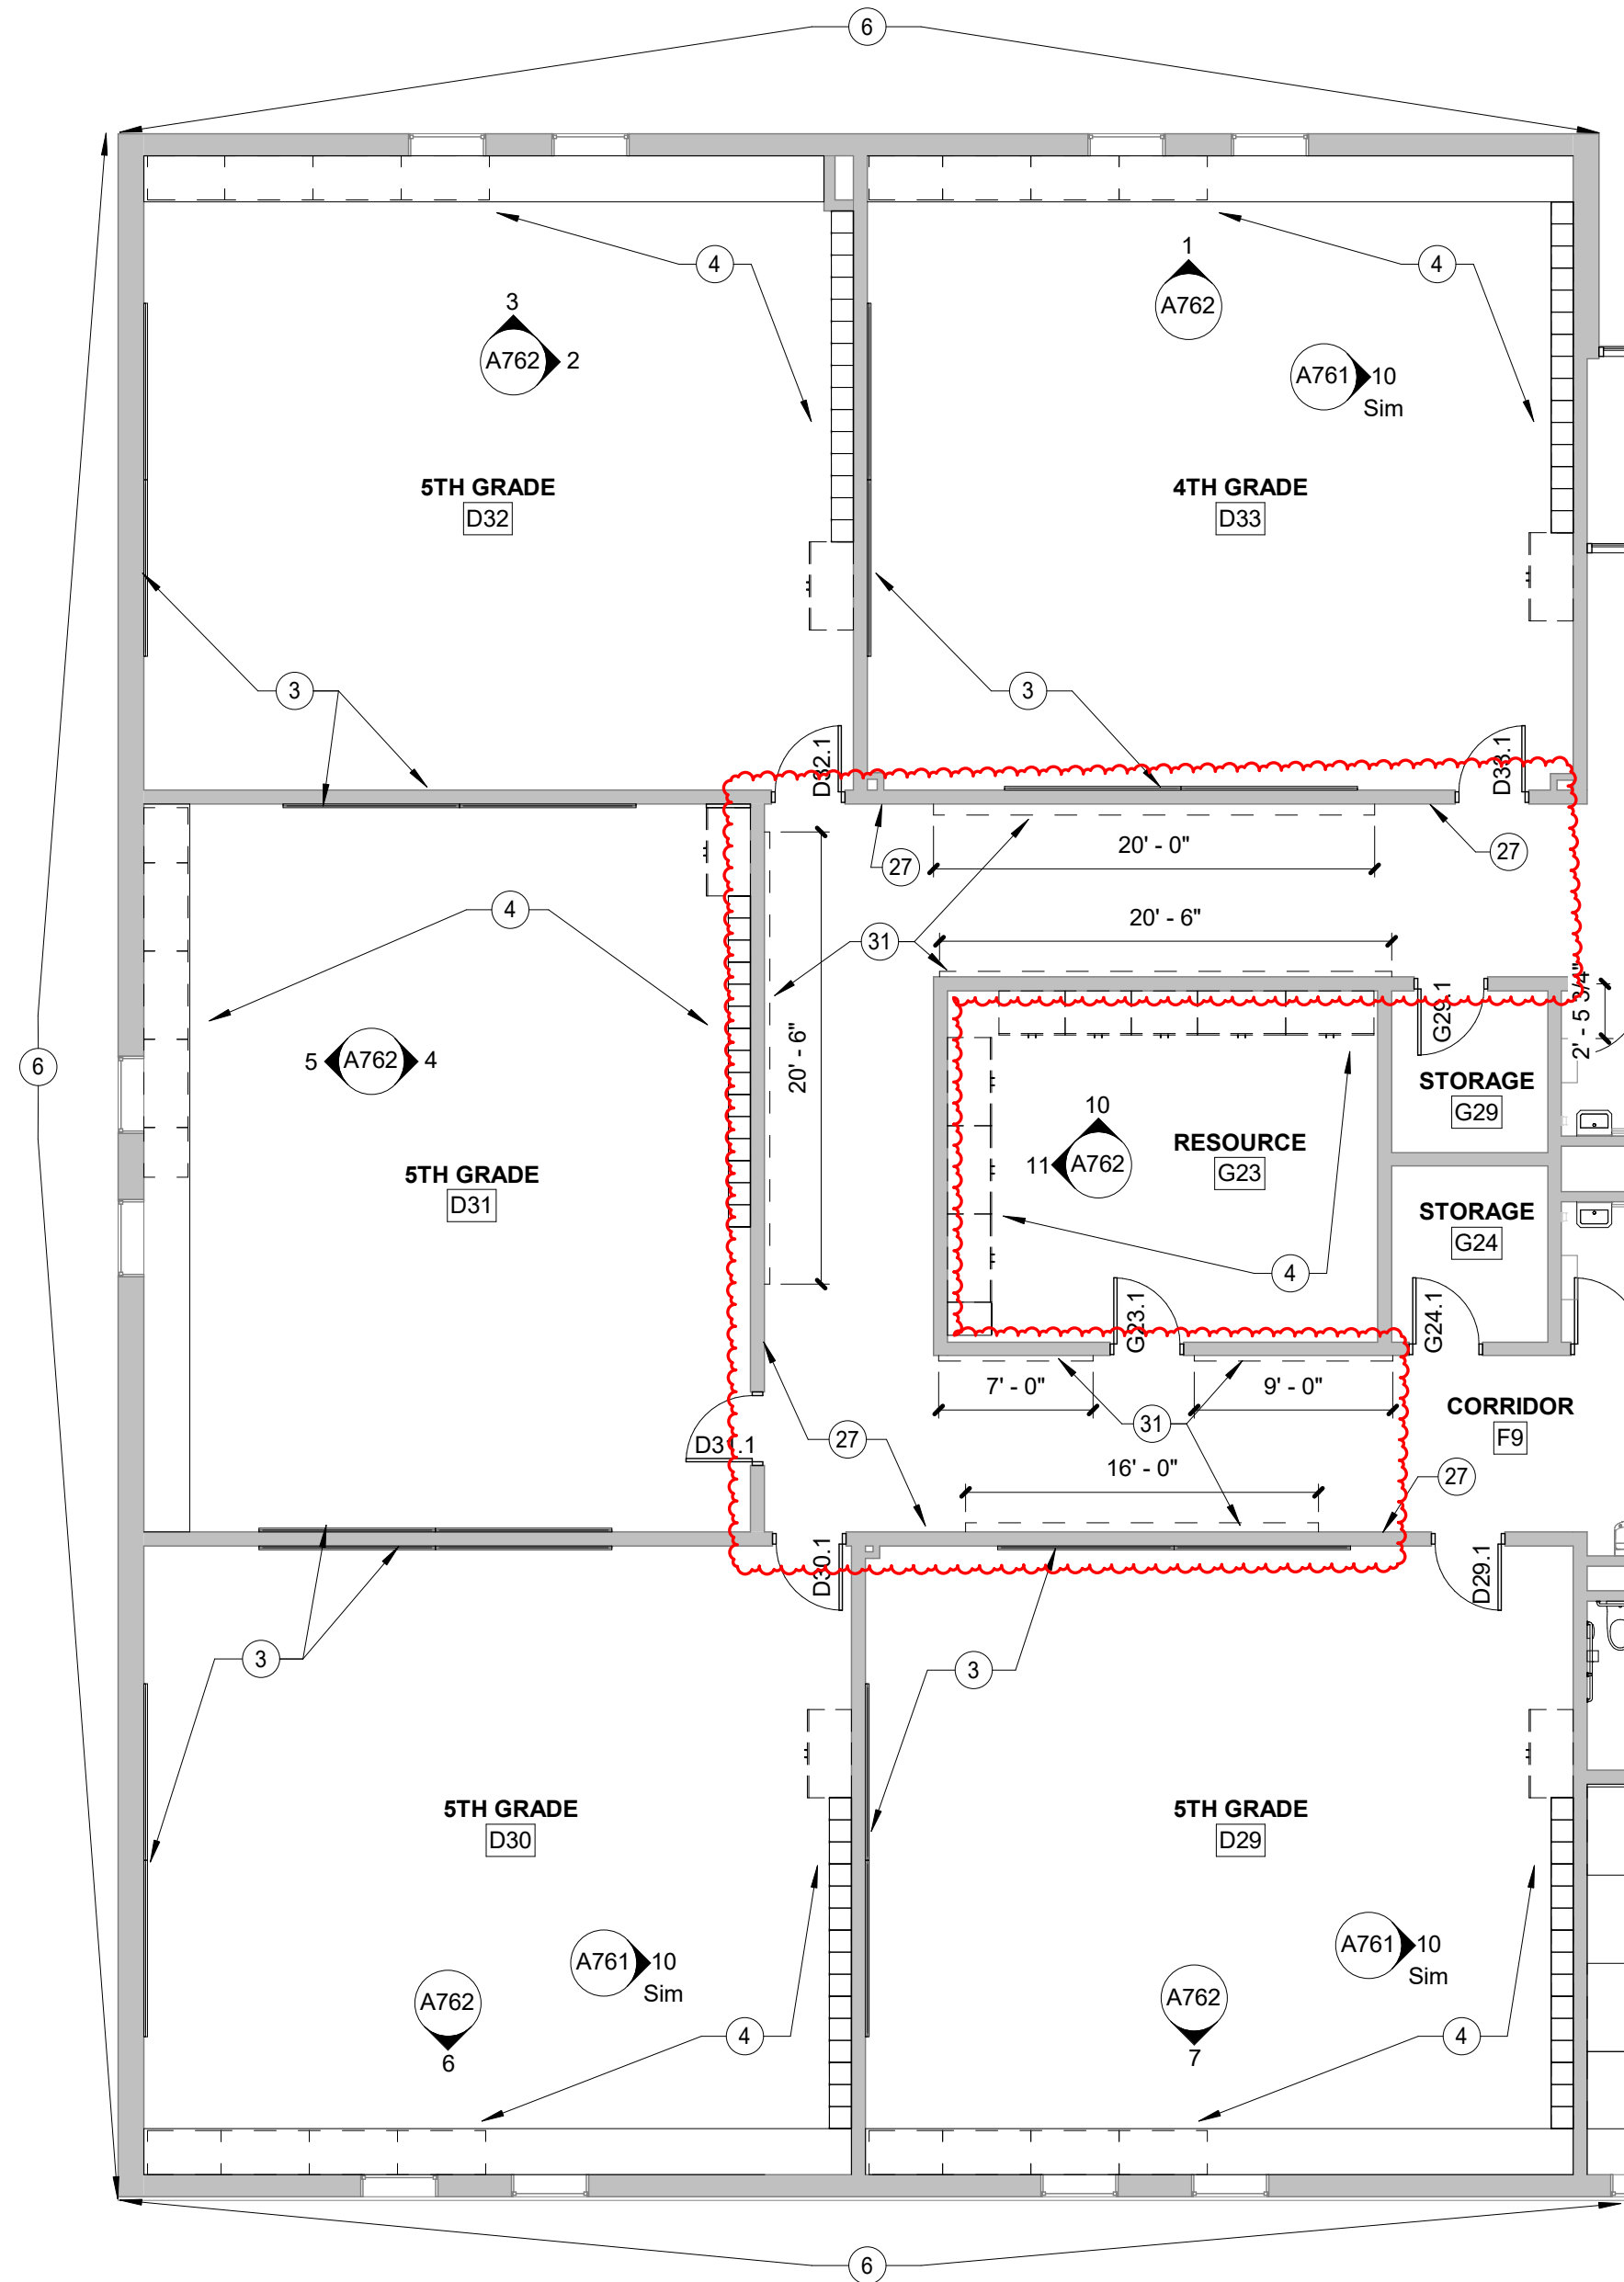

GENERAL NOTES

1. PROVIDE CORNER GUARDS AT ALL OUTSIDE CORNERS WITH GYPSUM BOARD FROM 1'-6" AFF TO 4'-0" AFF.
2. PROVIDE BULL-NOSE FINISH ON ALL OUTSIDE CORNERS OF CMU WALLS.
3. SEE A112 FOR ENLARGED PLANS.
4. VIF ALL DIMENSIONS FOR CASEWORK.
5. INTERIOR DIMENSIONS ARE TAKEN TO THE FACE OF MASONRY OR STUDS.
6. FOR ALL RESTROOM FACILITIES AND JANITOR CLOSETS WITH GYPSUM WALL FINISH REPLACE 5/8" TYPE "X" GYPSUM BOARD WITH 5/8" MOISTURE RESISTANT GYPSUM BOARD. SEE SPECS FOR DETAILS.
7. COLUMN LOCATIONS IN CAFETERIA TO BE PAINTED PT-2.
8. WALLS TO GO UP TO DECK UNLESS OTHERWISE NOTED.
9. DO NOT PAINT OVER EXISTING VINYL WALL GRAPHICS, LETTERING, AND MURALS.

PLAN NOTES - FLOOR PLAN

1. REINSTALL VINYL WALL MURAL.
2. MUSIC PIT INFILL. REFER TO STRUCTURAL DRAWING FOR ADDITIONAL DETAILS. ALTERNATE BID.
3. REINSTALL MARKERBOARDS AND TACKBOARDS WITH TRACKS AS REQUIRED BY MANUFACTURER. MARKERBOARDS AND TACKBOARDS PROVIDED BY OWNER.
4. NEW CASEWORK. REFER TO CASEWORK ELEVATIONS.
5. WALL MOUNTED WALL PADDING FLOOR TO CEILING.
6. MASONRY RESTORATION WORK. REFER TO S-SERIES DRAWINGS.
7. INSTALL NEW ALUMINUM EXTERIOR DOORS. REFER TO DOOR SCHEDULE AND SPECIFICATIONS.
8. NEW PLUMBING FIXTURES. REFER TO P-SERIES.
9. NEW COUNTERTOP OVER EXISTING CABINETS.
10. REINSTALL SALVAGED CASEWORK AS BASE BID. OMIT REINSTALLATION IF ALTERNATE IS ACCEPTED.
11. REINSTALL NEW WALL FINISH SURROUND TO 4'-0" AFF. REF FINISH LEGEND.
12. LED SCOREBOARDS AS ALTERNATE. REF E-SERIES.
13. NEW CASEWORK AS ALTERNATE. REFER TO CASEWORK ELEVATIONS.
14. INSTALL NEW HOLLOW METAL EXTERIOR DOORS AND FRAMES. REFER TO DOOR SCHEDULE AND SPECIFICATIONS.
15. FINISH SURFACE OF WALL TO ALIGN WITH EXISTING WALL PLANES. INSTALL FURRING AS REQUIRED.
16. NEW TOILET PAPER DISPENSERS.
17. NEW SANITARY NAPKIN DISPOSAL CONTAINERS.
18. NEW RECESSED PAPER TOWEL DISPENSERS. SEE ELEVATIONS FOR ADDITIONAL LOCATIONS.
19. NEW SOAP DISPENSERS. SEE ELEVATIONS FOR ADDITIONAL LOCATIONS.
20. INSTALL NEW TACKBOARD, 4'-0" H x 4'-0" W.
21. INSTALL THREE ROWS OF TACKSTRIPS. TOP TACKSTRIP SHALL BE AT 6'-6" AFF, AND SPACED 1'-8" O.C.
22. NEW PLUMBING ACCESS PANEL. COORDINATE LOCATION WITH ADJACENT EQUIPMENT AND FIXTURES.
23. NEW 3'-0" H x 4'-0" W MIRRORS.
24. BASE BID: NEW 8'-0" COUNTERTOP OVER EXISTING CABINETS. VIF.
25. BASE BID: NEW COUNTERTOP OVER EXISTING CABINETS. VIF.
26. REINSTALL EXISTING TACKBOARDS. CONFIRM FINAL INSTALL HEIGHT AND PLACEMENT WITH OWNER.
27. INSTALL ONE ROW OF TACKSTRIP AT 5'-0" AFF.
28. NEW TOILET/RINNAL PARTITIONS.
29. NEW TOILET/RINNAL PARTITIONS.
30. ADA GRAB BARS.
31. INSTALL TWO ROWS OF TACKSTRIPS. TOP TACKSTRIP SHALL BE AT 5'-0" AFF, AND SPACED 1'-8" O.C.
32. NEW WALL MURAL / VINYL WALL DECAL AT FULL HEIGHT OF AVAILABLE WALL.

SHELBYVILLE CENTRAL SCHOOLS
LOPER ELEMENTARY SCHOOL RENOVATIONS
901 LOPER DRIVE
SHELBYVILLE, IN 46176

LANCER+BEEBE, LLC
ARCHITECTURE | PLANNING | INTERIORS
220 N. COLLEGE AVE
INDIANAPOLIS, IN 46202

REVISIONS:



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1	4/20/2022	Revision 1


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PROJECT: #21140
DATE: 04/06/2022
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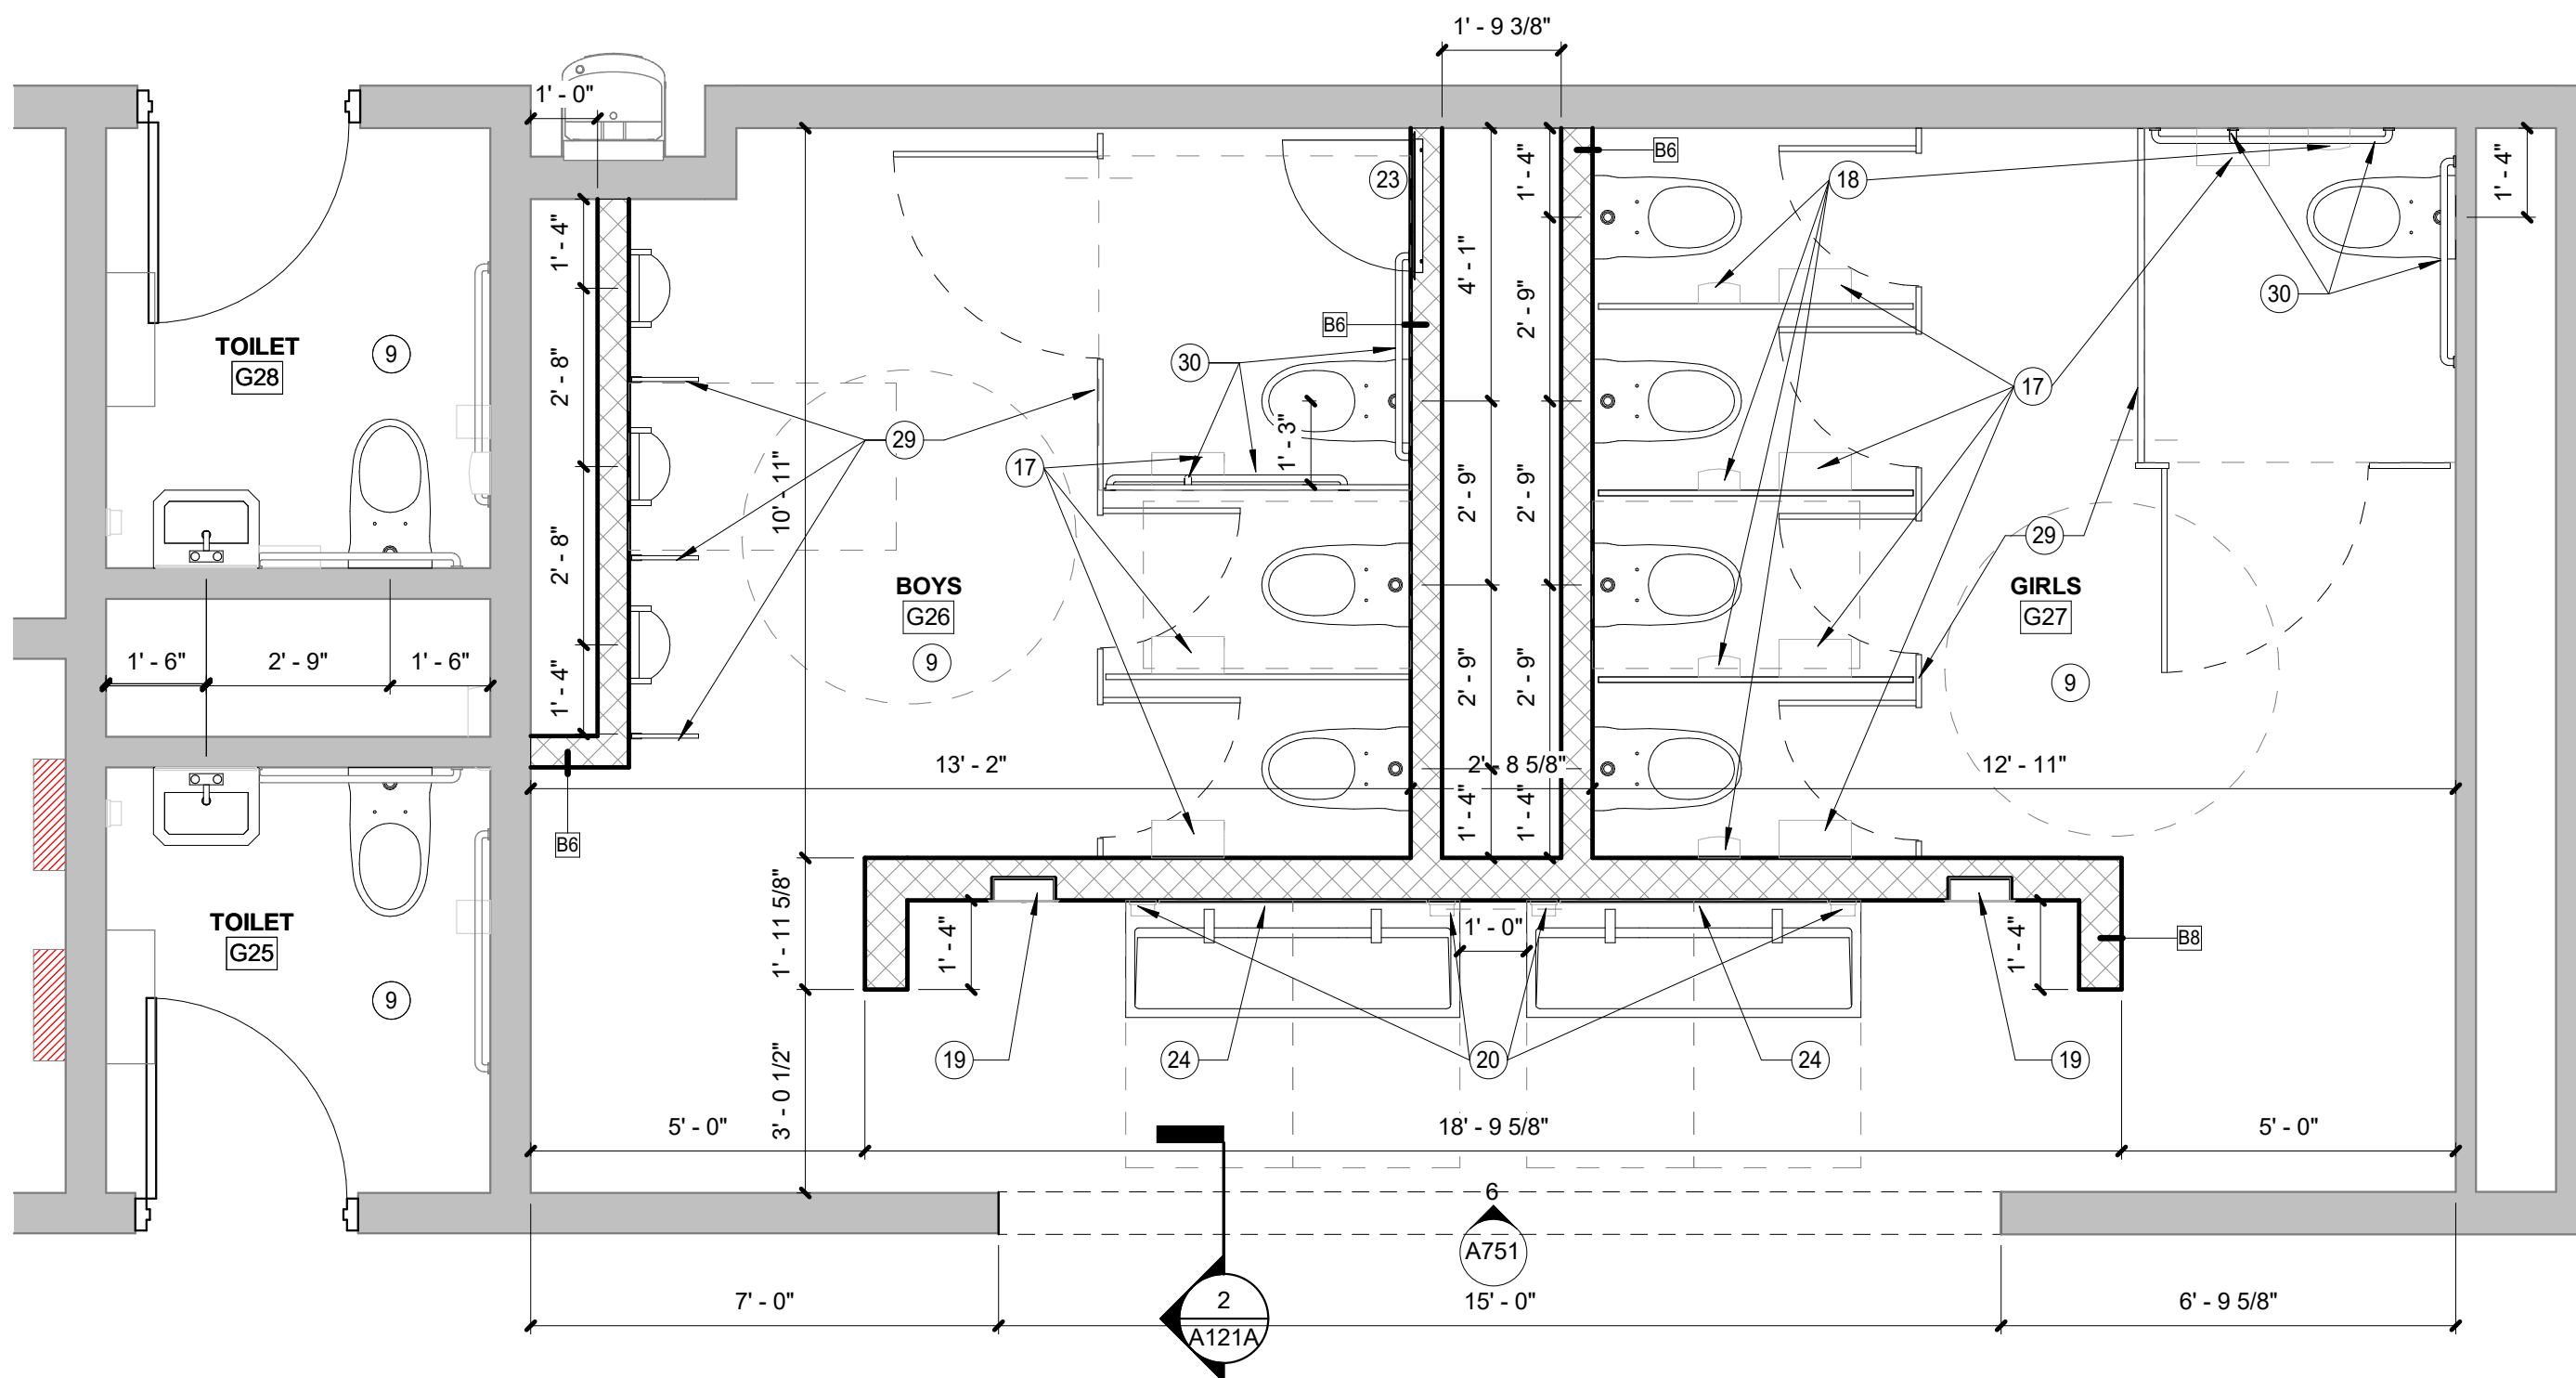
FLOOR PLAN -
FIRST FLOOR -
UNIT C

A101C




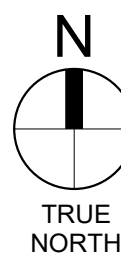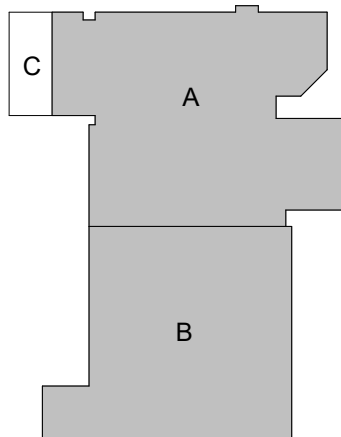


4 ENLARGED MEDIA CENTER PLAN
SCALE: 3/8" = 1'-0" REF. 1 / A101A

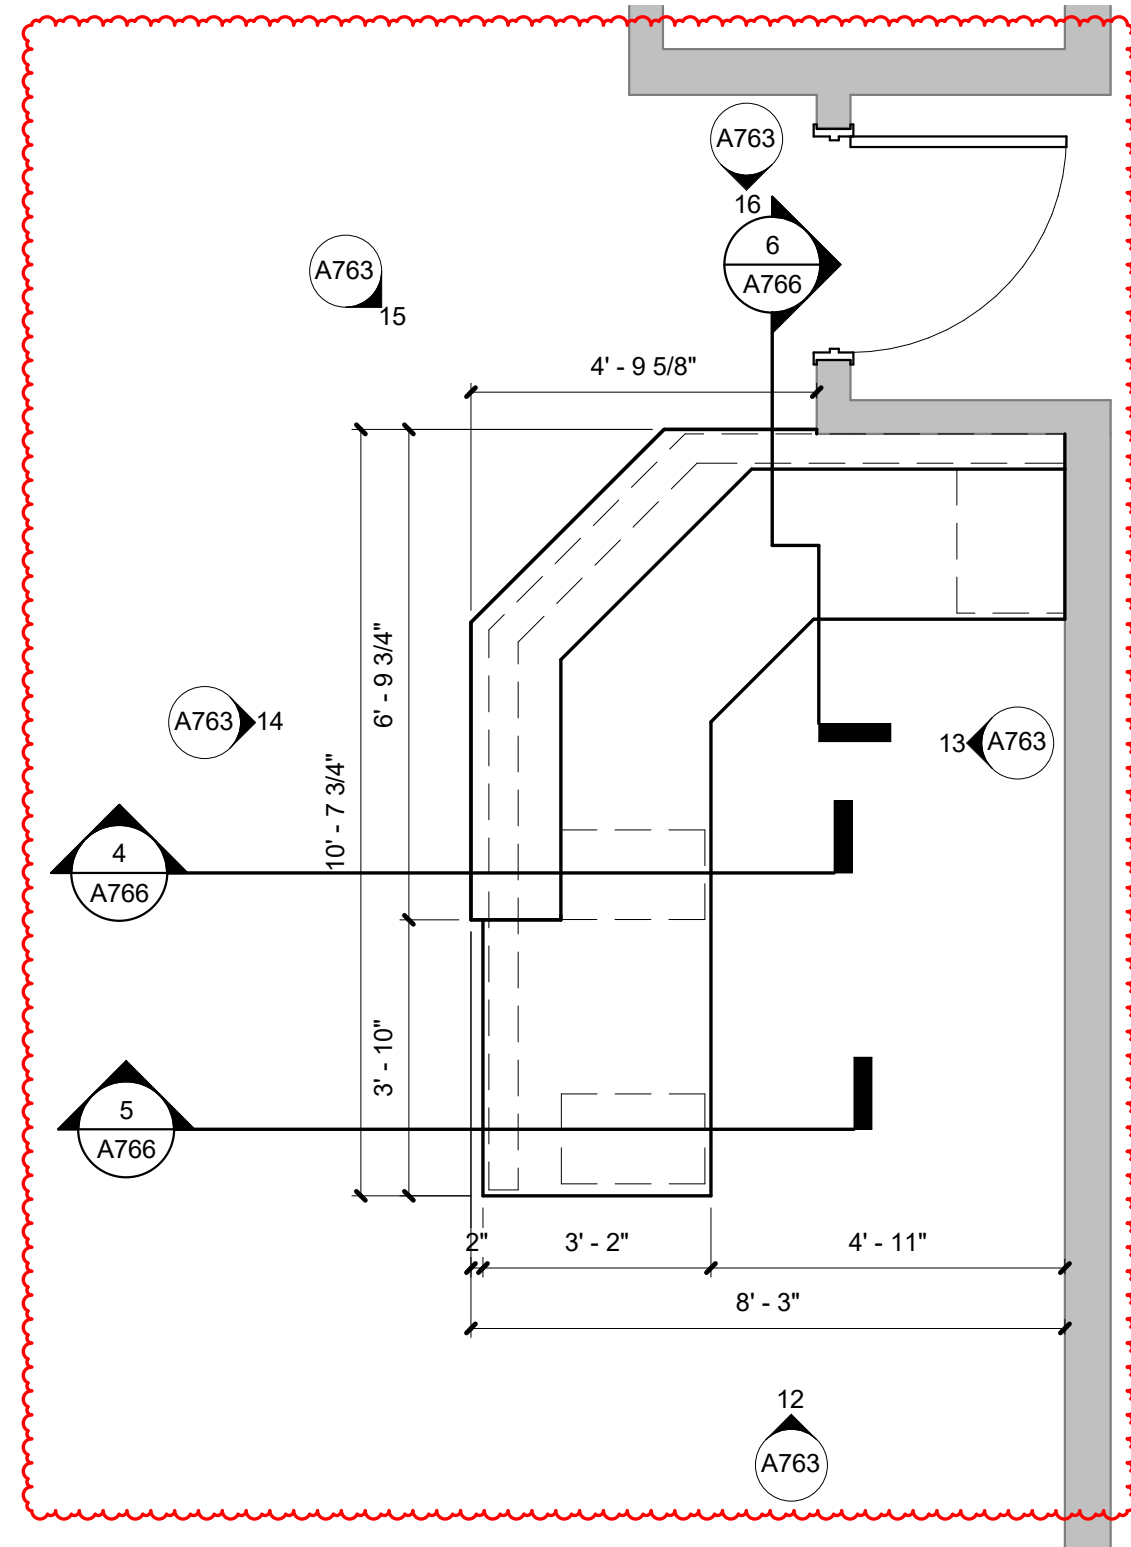

3 ENLARGED RESTROOM PLAN - 4TH AND 5TH GRADE
SCALE: 3/8" = 1'-0" REF. 1 / A101A

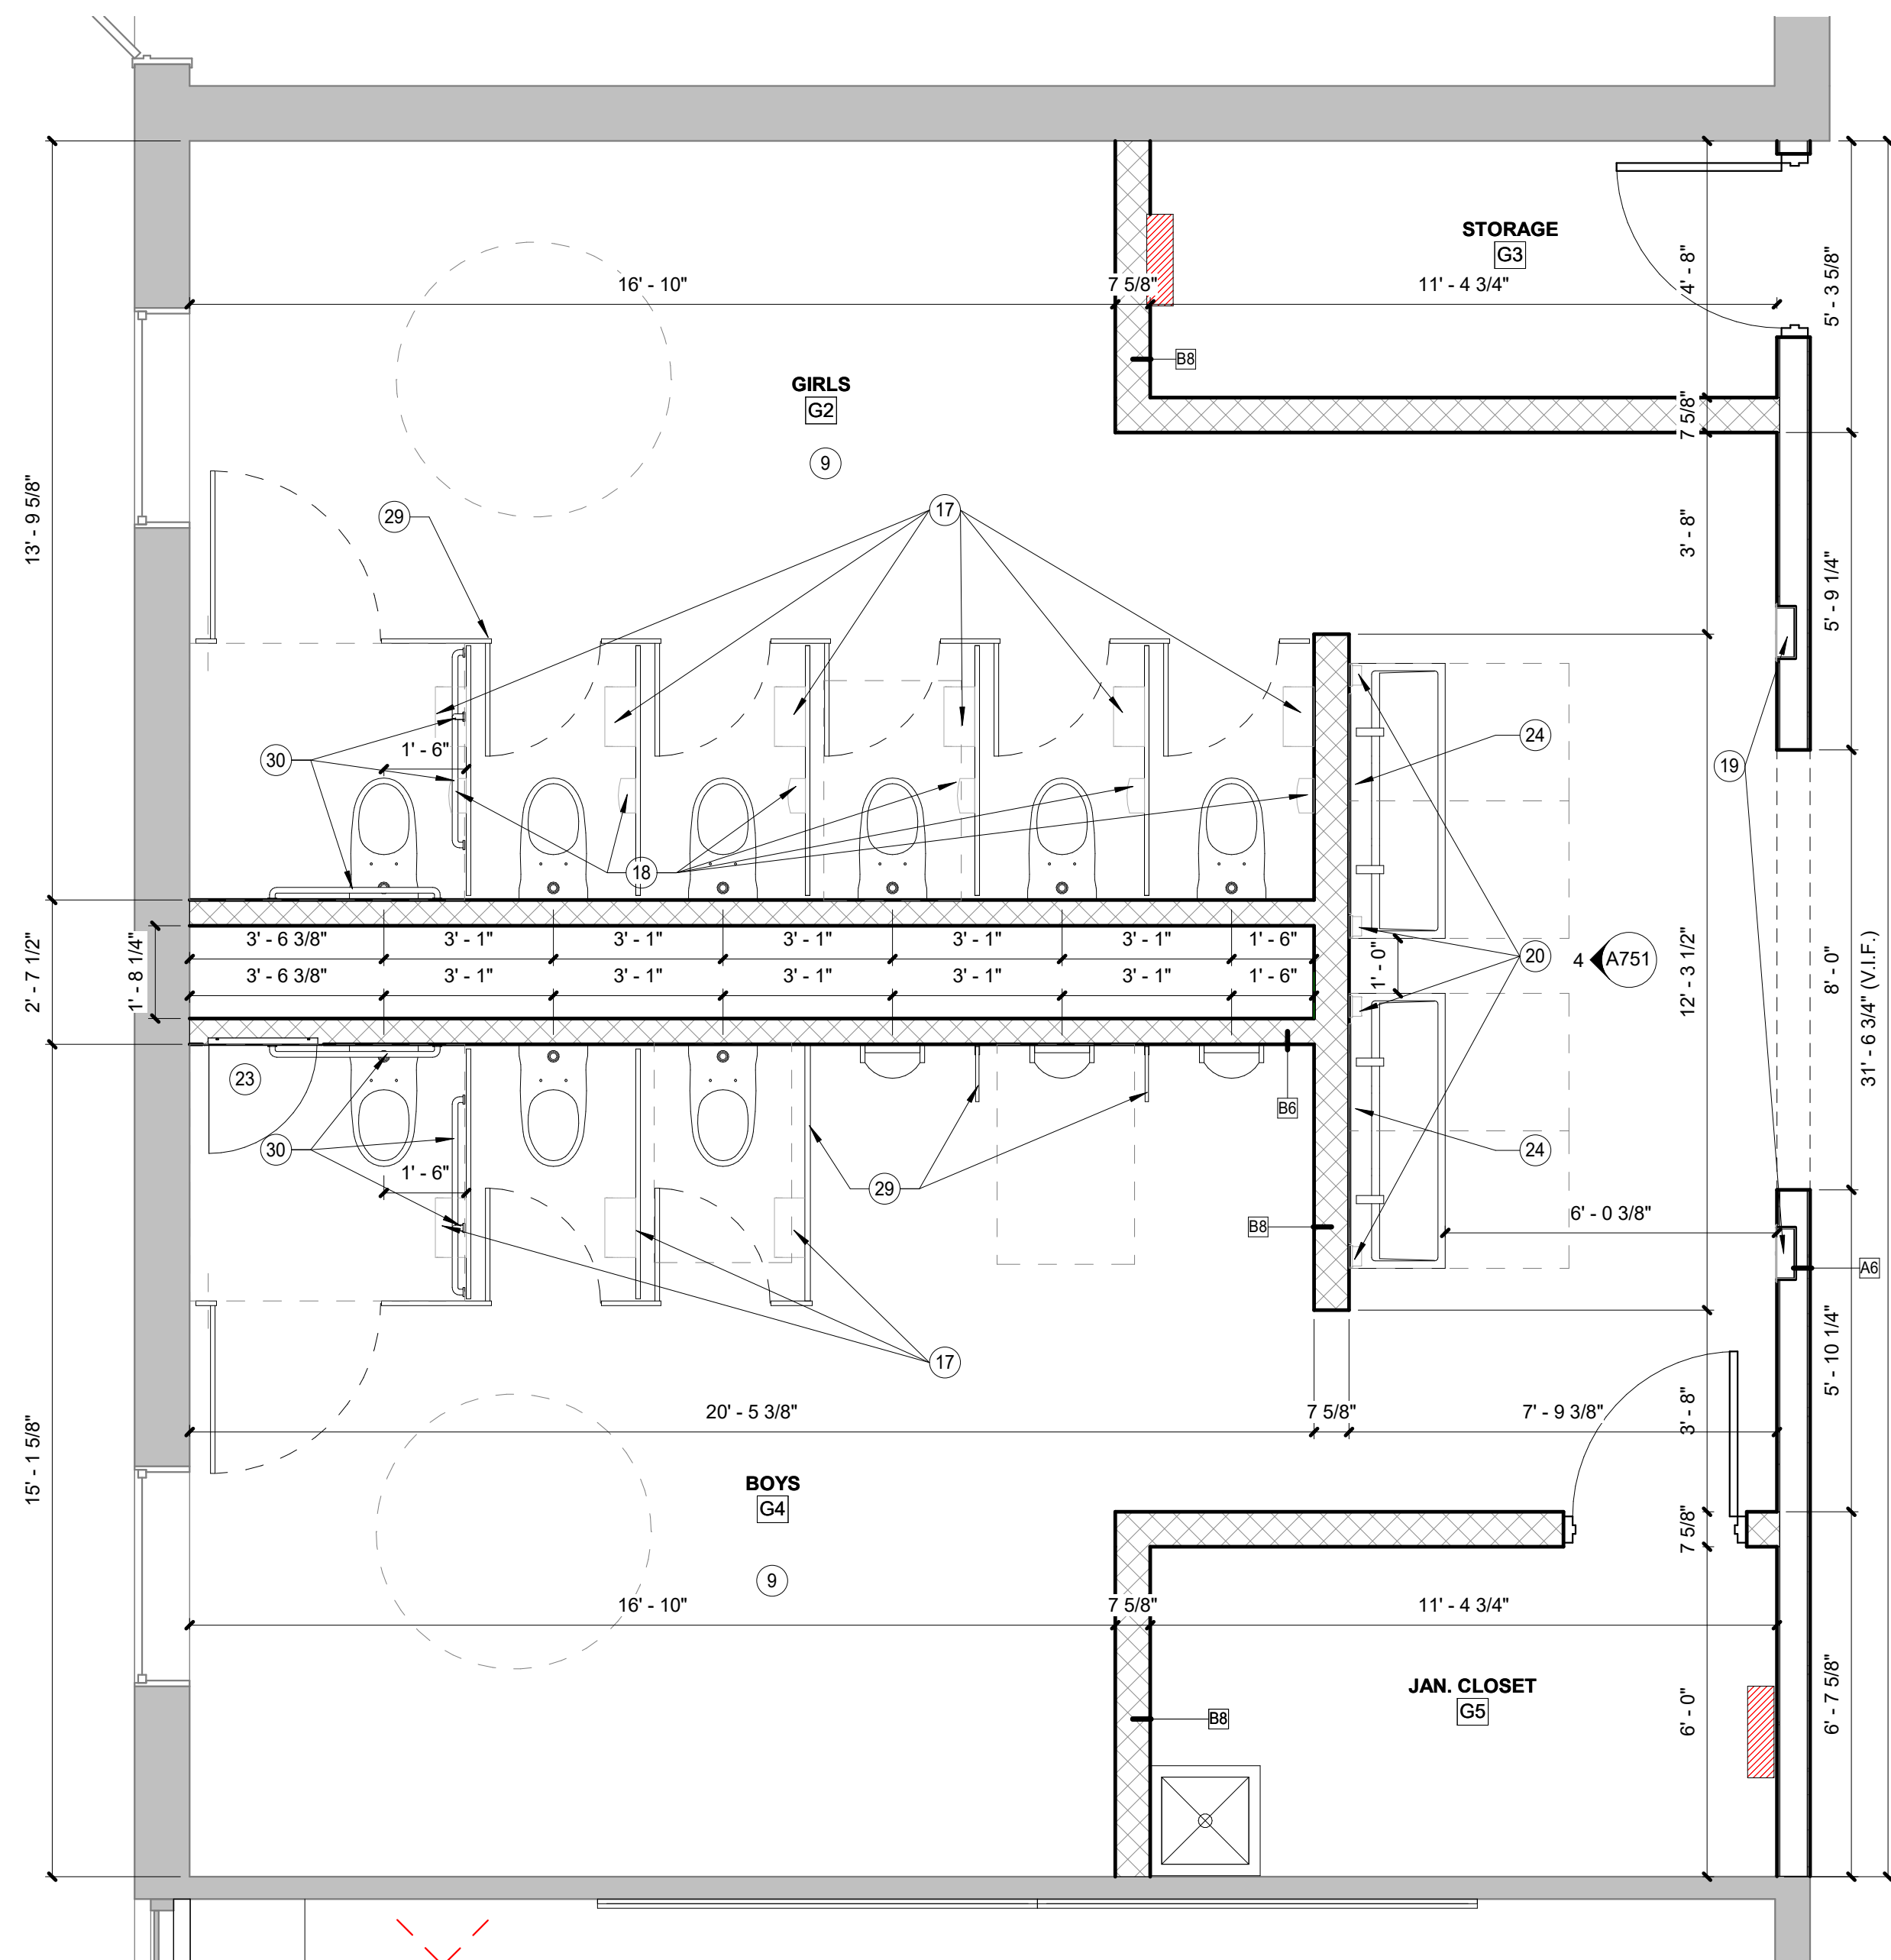

2 ENLARGED RESTROOM PLAN - 2ND GRADE
SCALE: 3/8" = 1'-0" REF. 1 / A101B

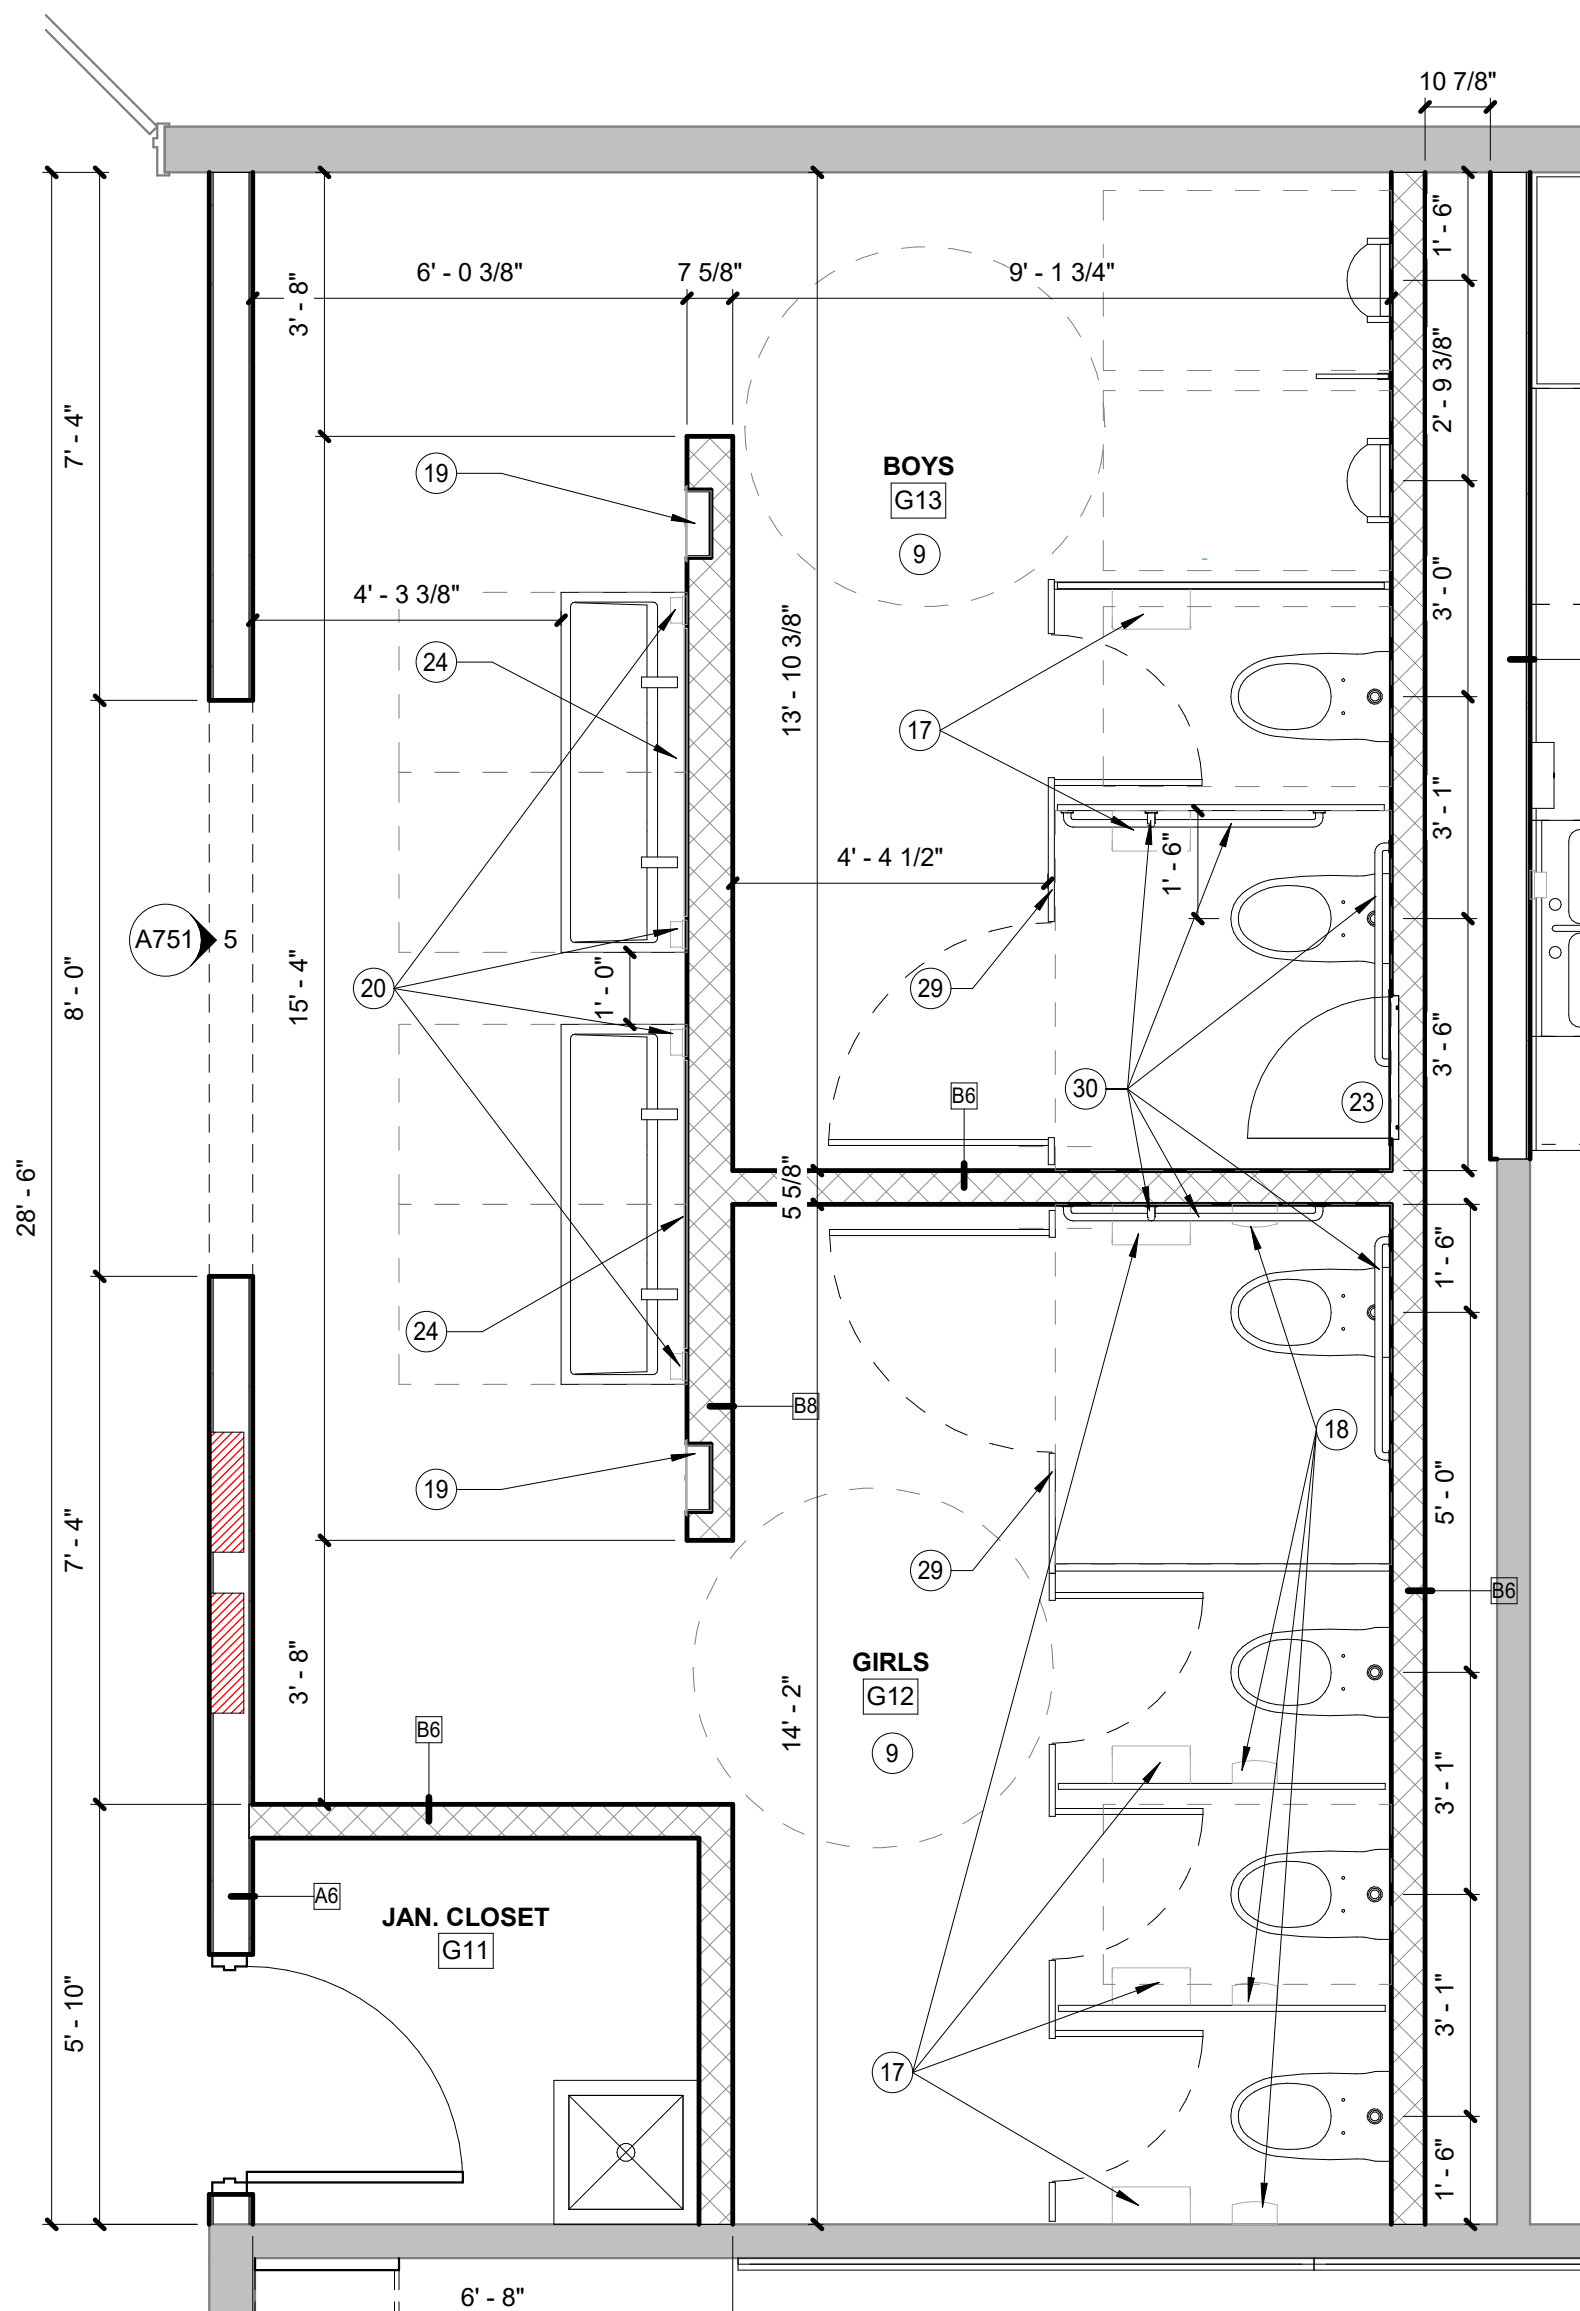

1 ENLARGED RESTROOM PLAN - 1ST AND 3RD GRADE
SCALE: 3/8" = 1'-0" REF. 1 / A101A

GENERAL NOTES


1. PROVIDE HOOKS ON ALL PARTITION DOORS
2. PROVIDE HOOKS ON ALL DOORS INTO SINGLE OCCUPANCY RESTROOMS
3. MOUNT HOOKS AT 48" AFF MAX IN ALL ACCESSIBLE RESTROOMS

PLAN NOTES - FLOOR PLAN

- 1 REINSTALL VINYL WALL MURAL.
- 2 MUSIC PIT INFILL. REFER TO STRUCTURAL DRAWING FOR ADDITIONAL DETAILS. ALTERNATE BID.
- 3 REINSTALL MARKERBOARDS AND TACKBOARDS WITH TRACKS AS REQUIRED BY MANUFACTURER. MARKERBOARDS AND TACKBOARDS PROVIDED BY OWNER.
- 4 NEW CASEWORK. REFER TO CASEWORK ELEVATIONS.
- 5 WALL MOUNTED WALL PADDING FLOOR TO CEILING.
- 6 MASONARY RESTORATION WORK. REFER TO S-SERIES DRAWINGS.
- 8 INSTALL NEW ALUMINUM EXTERIOR DOORS. REFER TO DOOR SCHEDULE AND SPECIFICATIONS.
- 9 NEW PLUMBING FIXTURES. REFER TO P-SERIES.
- 10 NEW COUNTERTOP OVER EXISTING CABINETS.
- 11 REINSTALL SALVAGED CASEWORK AS BASE BID. OMIT REINSTALLTION IF ALTERNATE IS ACCEPTED.
- 12 INSTALL NEW WALL FINISH SURROUND TO 4'-0" AFF. REFER FINISH LEGEND.
- 13 LED SCOREBOARDS AS ALTERNATE. REFER E-SERIES.
- 14 NEW CASEWORK AS ALTERNATE. REFER TO CASEWORK ELEVATIONS.
- 15 INSTALL NEW HOLLOW METAL EXTERIOR DOORS AND FRAMES. REFER TO DOOR SCHEDULE AND SPECIFICATIONS.
- 16 FINISH SURFACE OF WALL TO ALIGN WITH EXISTING WALL PLANES. INSTALL FURRING AS REQUIRED.
- 17 NEW TOILET PAPER DISPENSERS.
- 18 NEW SANITARY NAPKIN DISPOSAL CONTAINERS.
- 19 NEW RECESSED PAPER TOWEL DISPENSERS. SEE ELEVATIONS FOR ADDITIONAL LOCATIONS.
- 20 NEW SOAP DISPENSERS. SEE ELEVATIONS FOR ADDITIONAL LOCATIONS.
- 21 INSTALL NEW TACKBOARD, 4'-0" H x 4'-0" W.
- 22 INSTALL THREE ROWS OF TACKSTRIPS. TOP TACKSTRIP SHALL BE AT 6'-6" AFF, AND SPACED 1'-8" O.C.
- 23 NEW PLUMBING ACCESS PANEL. COORDINATE LOCATION WITH ADJACENT EQUIPMENT AND FIXTURES.
- 24 NEW 3'-0" H x 4'-0" W MIRRORS.
- 25 BASE BID: NEW 8'-0" COUNTERTOP OVER EXISTING CABINETS. VIF.
- 26 BASE BID: NEW COUNTERTOP OVER EXISTING CABINETS. VIF.
- 27 REINSTALL EXISTING TACKBOARDS. CONFIRM FINAL INSTALL HEIGHT AND PLACEMENT WITH OWNER.
- 28 INSTALL ONE ROW OF TACKSTRIP AT 5'-0" AFF.
- 29 NEW TOILET/URNAL PARTITIONS.
- 30 ADA GRAB BARS.
- 31 INSTALL TWO ROWS OF TACKSTRIPS. TOP TACKSTRIP SHALL BE AT 5'-0" AFF, AND SPACED 1'-8" O.C.
- 32 NEW WALL MURAL / VINYL WALL DECAL AT FULL HEIGHT OF AVAILABLE WALL.

#	Date	Desc.
1	4.20.2022	Revision 1

PLT DATE/TIME: 4/20/2022 2:48:30 PM

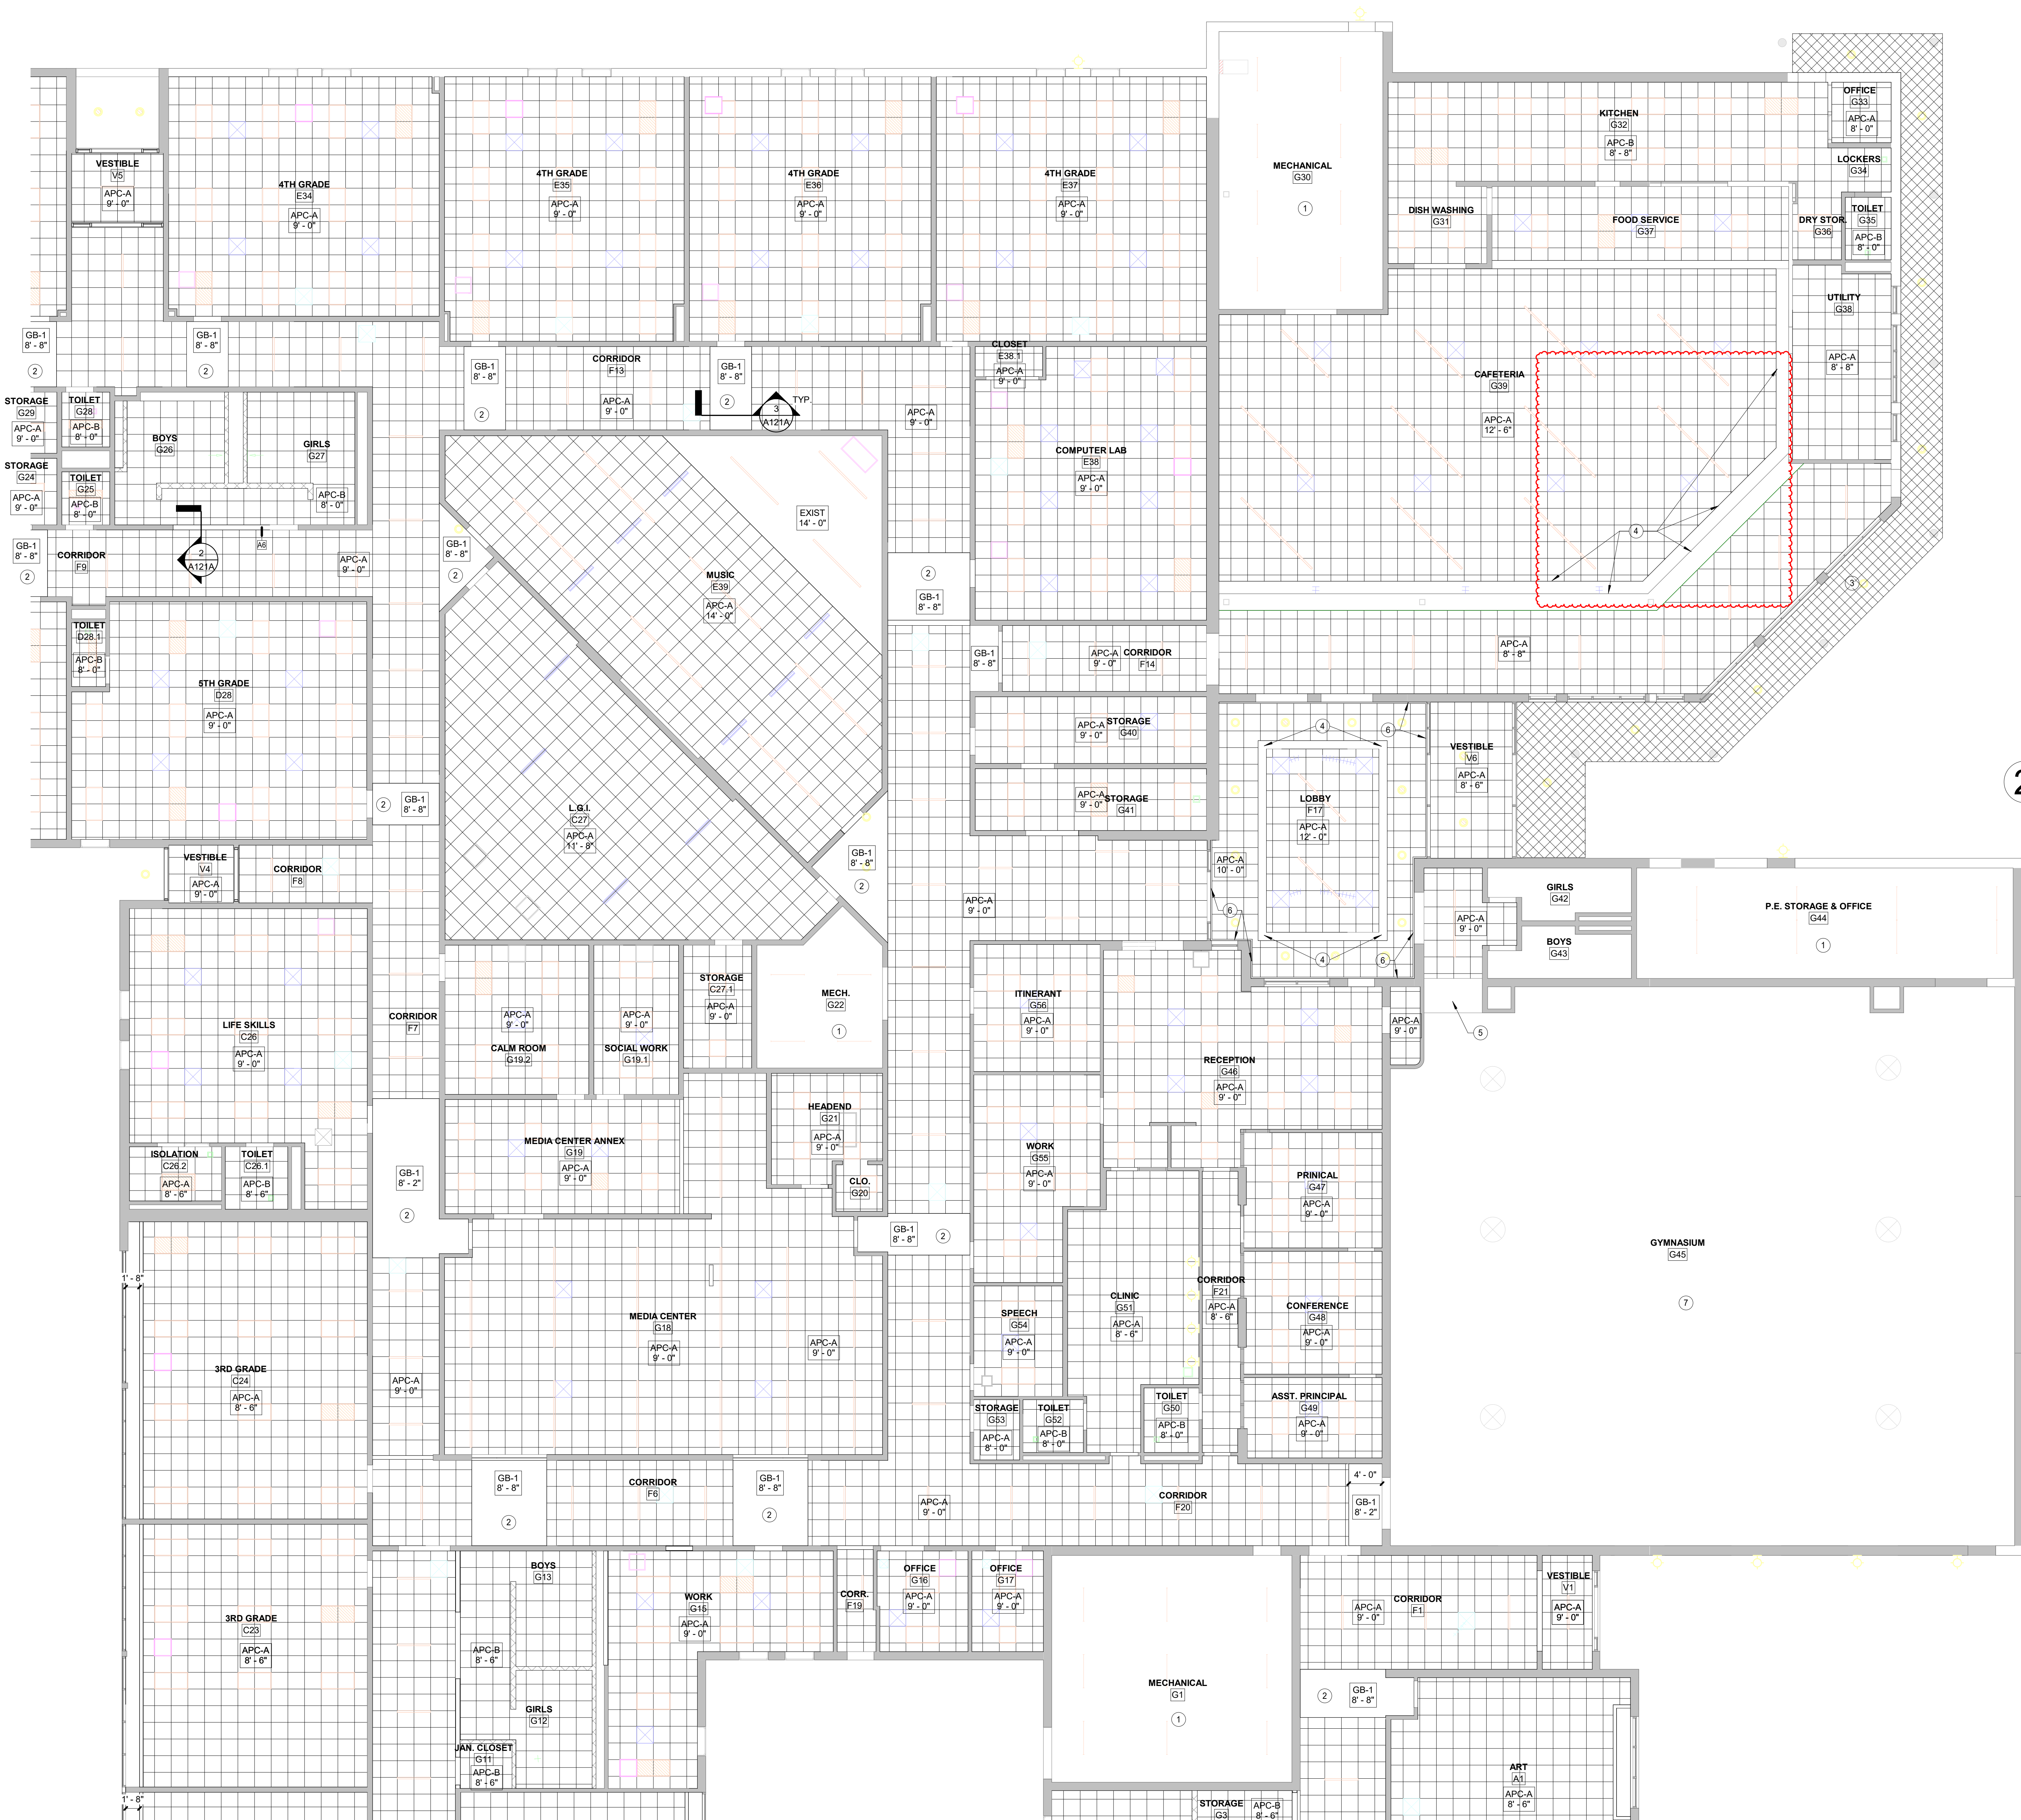


1 REFLECTED CEILING PLAN - FIRST FLOOR - UNIT A
SCALE: 1/8" = 1'-0" REF. 14 / A763

GENERAL NOTES


1. ALL GYP CEILINGS TO BE PAINTED PT-1 UNLESS OTHERWISE NOTED.
2. 2-HOUR FIRE RATED GYPSUM BOARD CEILING CONSTRUCTION.

PLAN NOTES - RCP

1. NO ARCHITECTURAL WORK IN THIS AREA
2. GYP CEILING TO BE PAINTED PT-2. REF FINISH LEGEND.
3. NEW EPS SOFFIT. PROVIDE NEW SUBSTRATE/FRAMING AS NEEDED.
4. EXISTING BULKHEAD TO REMAIN. PAINT PT-1. REF FINISH LEGEND.
5. EXISTING CEILING TO BE PAINTED PT-1. REF FINISH LEGEND.
6. EXISTING CROWN MOLDING TO REMAIN. PAINT PT-2. REF FINISH LEGEND.
7. ACOUSTICAL CEILING PANELS IN GYM TO BE PAINTED PT-1. ALTERNATE BID.

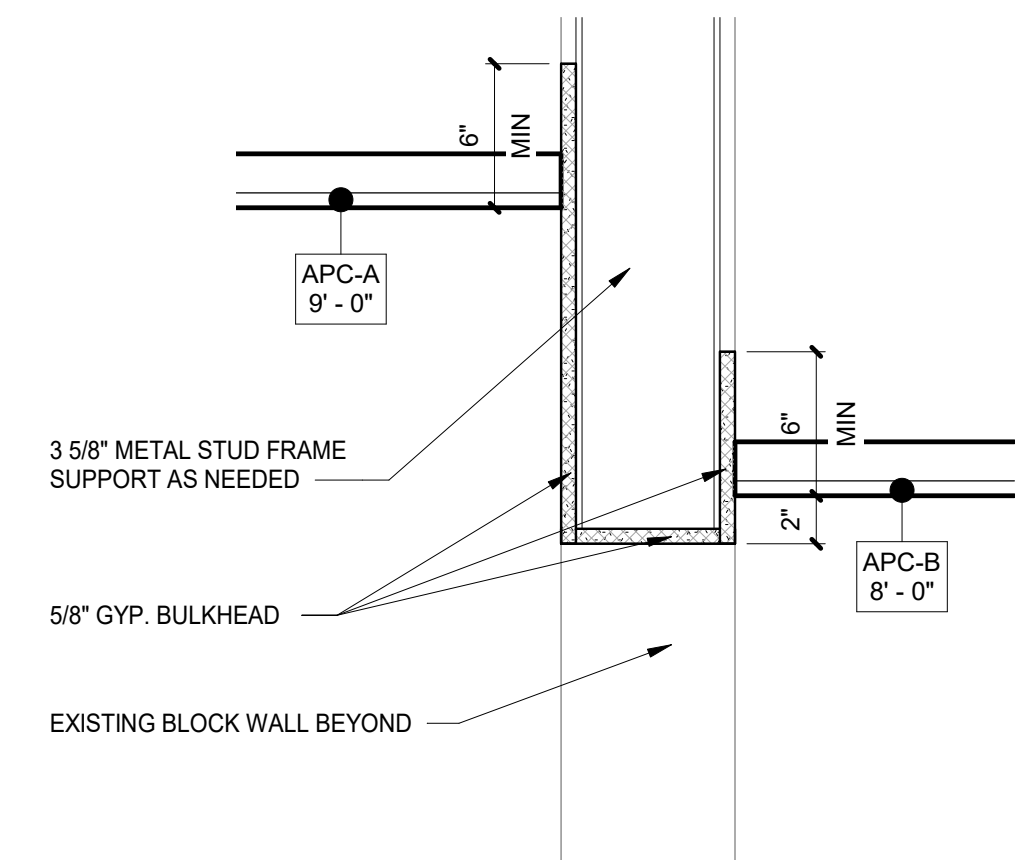

2 RESTROOM BULKHEAD DETAIL
SCALE: 1 1/2" = 1'-0" REF. 1 / A101A

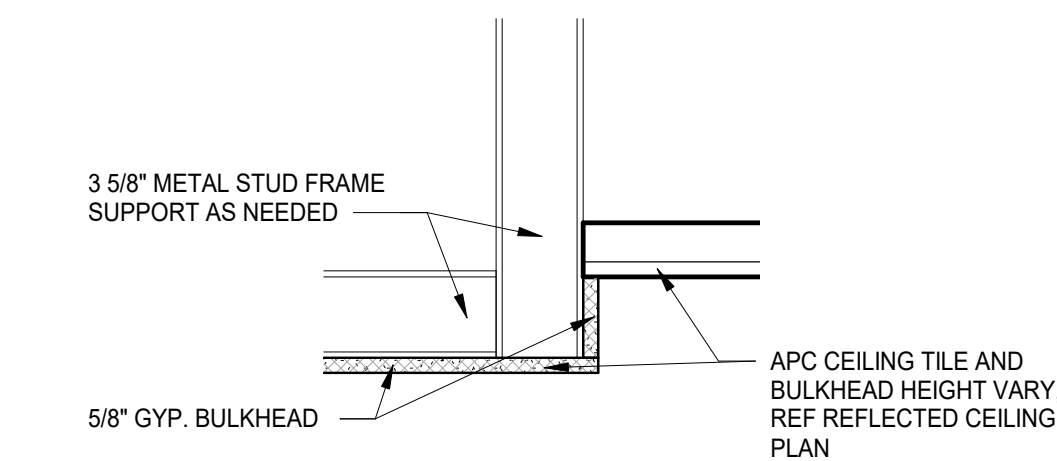


3 TYP GYP BULKHEAD DETAIL
SCALE: 1 1/2" = 1'-0" REF. 1 / A121A


REVISIONS:			
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1	4/20/2022	Revision 1	

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PROJECT: #21140
DATE: 04/08/2022
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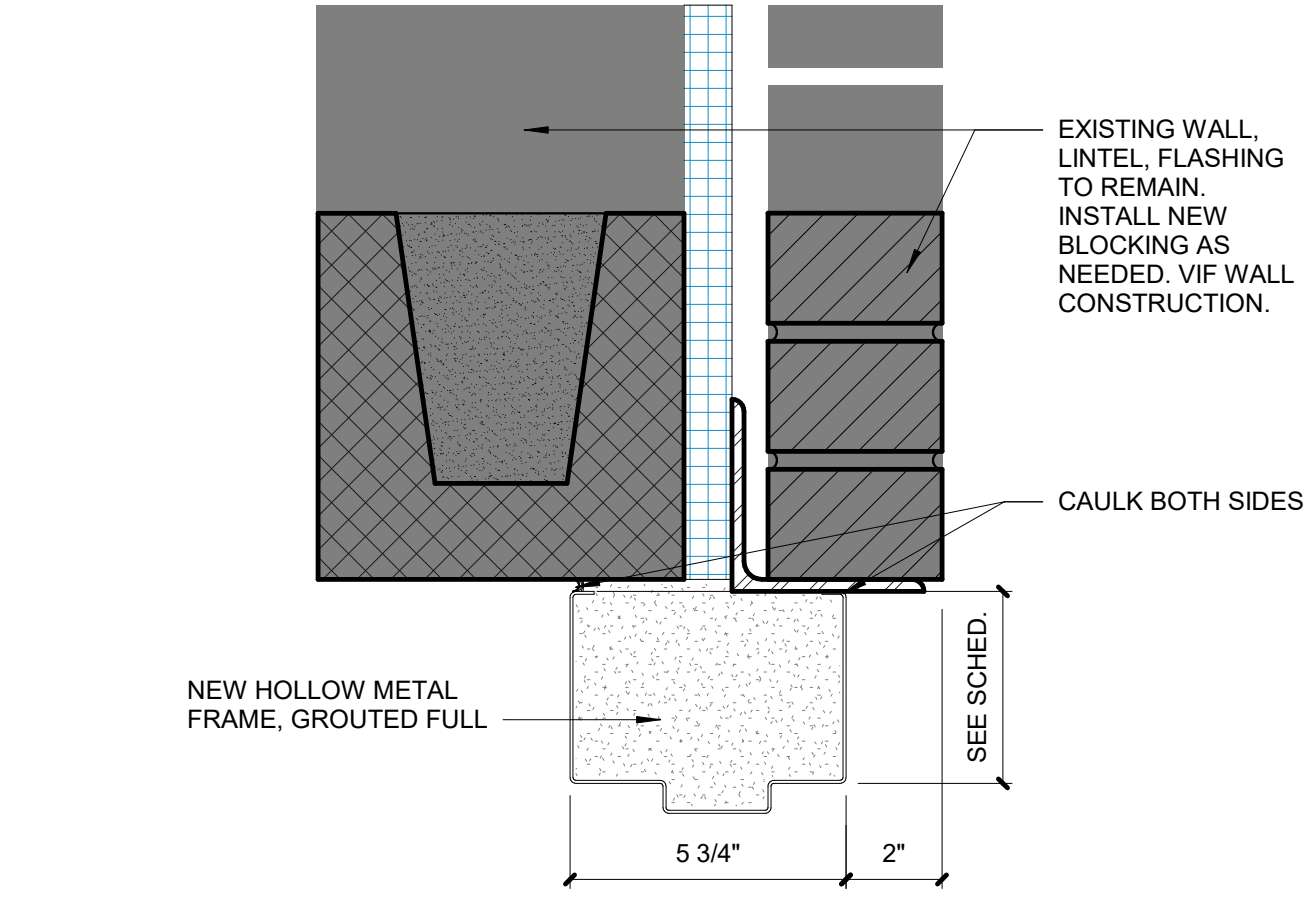
REFLECTED CEILING PLAN - FIRST FLOOR - UNIT A

A121A




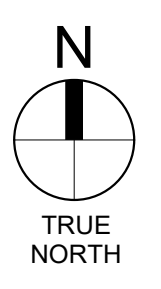

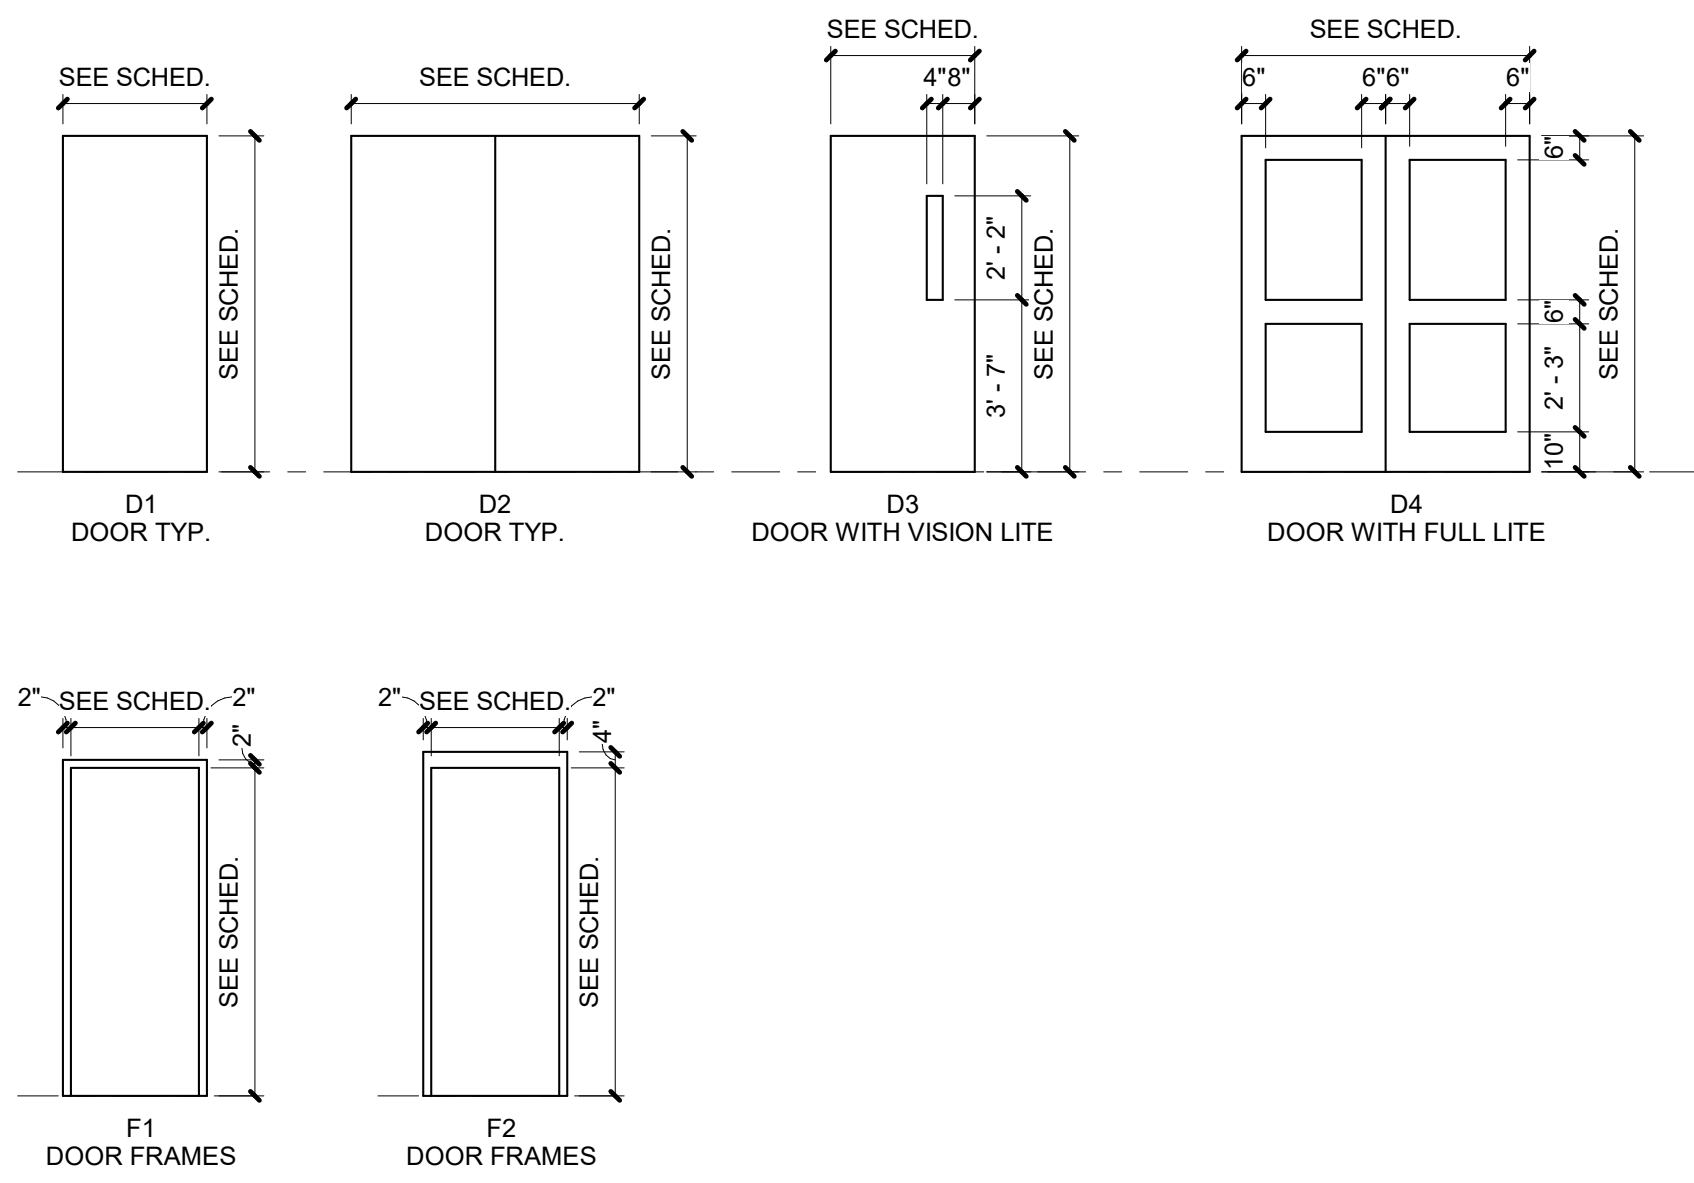DOOR SCHEDULE															
DR #	ROOM NAME	ROOM #	OVT Hardware Set	DOOR			FRAME			GLAZING	FIRE RATING	NOTES			
				HEIGHT	WIDTH	ELEV	MATERIAL	SIZE	ELEV				MATERIAL		
C24.1	3RD GRADE	C24	08	7'-0"	3'-0"	D3	WOOD	36" x 84"	EX	HM	TEMP	20 MIN			
C26.1	LIFE SKILLS	C26	07	7'-0"	3'-0"	D3	WOOD	36" x 84"	EX	HM	TEMP	20 MIN			
C26.2	TOILET	C26.1	03	7'-0"	3'-0"	D1	WOOD	36" x 84"	EX	HM	-	-			
C27.1	L.G.I.	C27	19	7'-0"	3'-0"	D3	WOOD	36" x 84"	EX	HM	TEMP	20 MIN			
C27.2	L.G.I.	C27	18	7'-0"	3'-0"	D3	WOOD	36" x 84"	EX	HM	TEMP	20 MIN			
C27.3	STORAGE	C27.1	09	7'-0"	3'-0"	D1	WOOD	36" x 84"	EX	HM	-	-			
D28.1	5TH GRADE	D28	07	7'-0"	3'-0"	D1	WOOD	36" x 84"	EX	HM	-	20 MIN			
D28.2	TOILET	D28.1	03	7'-0"	3'-0"	D1	WOOD	36" x 84"	EX	HM	-	-			
D29.1	5TH GRADE	D29	07	7'-0"	3'-0"	D3	WOOD	36" x 84"	EX	HM	TEMP	20 MIN			
D30.1	5TH GRADE	D30	08	7'-0"	3'-0"	D3	WOOD	36" x 84"	EX	HM	TEMP	20 MIN			
D31.1	5TH GRADE	D31	07	7'-0"	3'-0"	D3	WOOD	36" x 84"	EX	HM	TEMP	20 MIN			
D32.1	5TH GRADE	D32	08	7'-0"	3'-0"	D3	WOOD	36" x 84"	EX	HM	TEMP	20 MIN			
D33.1	4TH GRADE	D33	07	7'-0"	3'-0"	D3	WOOD	36" x 84"	EX	HM	TEMP	20 MIN			
E34.1	4TH GRADE	E34	07	7'-0"	3'-0"	D3	WOOD	36" x 84"	EX	HM	TEMP	20 MIN			
E35.1	4TH GRADE	E35	07	7'-0"	3'-0"	D3	WOOD	36" x 84"	EX	HM	TEMP	20 MIN			
E36.1	4TH GRADE	E36	07	7'-0"	3'-0"	D3	WOOD	36" x 84"	EX	HM	TEMP	20 MIN			
E37.1	4TH GRADE	E37	08	7'-0"	3'-0"	D3	WOOD	36" x 84"	EX	HM	TEMP	20 MIN			
E38.1	COMPUTER LAB	E38	07	7'-0"	3'-0"	D3	WOOD	36" x 84"	EX	HM	TEMP	20 MIN			
E38.2	CLOSET	E38.1	14	6'-0"	6'-0"	D2	WOOD	72" x 84"	EX	HM	-	-			
E39.1	MUSIC	E39	19	7'-0"	3'-0"	D3	WOOD	36" x 84"	EX	HM	TEMP	20 MIN			
E39.2	MUSIC	E39	19	7'-0"	3'-0"	D3	WOOD	36" x 84"	EX	HM	TEMP	20 MIN			
E47.1	CORRIDOR	E46	17	7'-0"	6'-0"	ETR	ALUM	ETR	EX	ALUM	EXT	-	EXISTING DOOR WITH NEW ACCESS CONTROL. SEE ELECTRICAL FOR DETAILS.		
G1.1	MECHANICAL	G1		7'-0"	3'-0"	D1	HM	36" x 84"	EX	HM	-	-			
G5.1	JAN. CLOSET	G5	12	7'-0"	3'-0"	D1	WOOD	36" x 84"	F1	HM	-	-			
G8.1	TOILET	G8	04	7'-0"	3'-0"	D1	WOOD	36" x 84"	EX	HM	-	-			
G14.1	JAN. CLOSET	G14	11	7'-0"	3'-0"	D1	WOOD	36" x 84"	F1	HM	-	-			
G15.1	WORK	G15		7'-0"	3'-0"	D3	WOOD	36" x 84"	EX	HM	-	20 MIN			
G18.1	MEDIA CENTER	G18	18	7'-0"	3'-0"	D3	WOOD	36" x 84"	EX	HM	TEMP	20 MIN			
G18.2	MEDIA CENTER	G18	18	7'-0"	3'-0"	D3	WOOD	36" x 84"	EX	HM	TEMP	20 MIN			
G19.1	SOCIAL WORK	G19.1	05	7'-0"	3'-0"	D3	WOOD	36" x 84"	EX	HM	TEMP	-			
G19.2	CORRIDOR	F7	08	7'-0"	3'-0"	D3	WOOD	36" x 84"	EX	HM	TEMP	20 MIN			
G19.2A	CALM ROOM	G19.2	06	7'-0"	3'-0"	D3	WOOD	36" x 84"	EX	HM	TEMP	-			
G21.1	HEADEND	G21	05	7'-0"	3'-0"	D1	WOOD	36" x 84"	EX	HM	-	-			
G22.1	MECH.	G22	16	7'-0"	6'-0"	D2	HM	72" x 84"	EX	HM	-	20 MIN			
G23.1	RESOURCE	G23	07	7'-0"	3'-0"	D3	WOOD	36" x 84"	EX	HM	TEMP	20 MIN			
G24.1	STORAGE	G24	11	7'-0"	3'-0"	D1	WOOD	36" x 84"	EX	HM	-	20 MIN			
G25.1	TOILET	G25	04	7'-0"	3'-0"	D1	WOOD	36" x 84"	EX	HM	-	20 MIN			
G28.1	TOILET	G28	04	7'-0"	3'-0"	D1	WOOD	36" x 84"	EX	HM	-	20 MIN			
G29.1	STORAGE	G29	11	7'-0"	3'-0"	D1	WOOD	36" x 84"	EX	HM	-	20 MIN			
G40.1	STORAGE	G40	11	7'-0"	3'-0"	D3	WOOD	36" x 84"	EX	HM	TEMP	20 MIN			
G41.1	STORAGE	G41	15	7'-0"	6'-0"	D2	HM	72" x 84"	EX	HM	-	20 MIN			
G44.1	P.E. STORAGE & OFFICE	G44	13	7'-0"	3'-0"	D1	HM	36" x 84"	F2	HM	-	-			
G45.1	GYMNASIUM	G45	20	7'-0"	3'-0"	D1	HM	36" x 84"	F1	HM	-	-			
G46.1	LOBBY	F17	10	7'-0"	3'-0"	ETR	WOOD	ETR	EX	HM	EXT	-	EXISTING DOOR WITH NEW ACCESS CONTROL. SEE ELECTRICAL FOR DETAILS.		
V1.1	VESTIBLE	V1	25	7'-0"	6'-0"	ETR	ALUM	ETR	EX	ALUM	EXT	-	EXISTING DOOR WITH NEW ACCESS CONTROL. SEE ELECTRICAL FOR DETAILS.		
V2.1	VESTIBLE	V2	25	7'-0"	6'-0"	ETR	ALUM	ETR	EX	ALUM	EXT	-	EXISTING DOOR WITH NEW ACCESS CONTROL. SEE ELECTRICAL FOR DETAILS.		
V3.1	VESTIBLE	V3	25	7'-0"	6'-0"	ETR	ALUM	ETR	EX	ALUM	EXT	-	EXISTING DOOR WITH NEW ACCESS CONTROL. SEE ELECTRICAL FOR DETAILS.		
V4.1	VESTIBLE	V4	24	7'-0"	6'-0"	D4	ALUM	GLASS	EX	ALUM	TEMP	-			
V4.2	VESTIBLE	V4	02	7'-0"	6'-0"	D4	ALUM	GLASS	EX	ALUM	TEMP	-			
V5.1	VESTIBLE	V5	23	7'-0"	6'-0"	D4	ALUM	GLASS	EX	ALUM	TEMP	-	NEW ACCESS CONTROL SEE ELECTRICAL FOR DETAILS		
V5.2	VESTIBLE	V5	01	7'-0"	6'-0"	D4	ALUM	GLASS	EX	ALUM	TEMP	-			
V6.1	VESTIBLE	V6	21	7'-0"	6'-0"	ETR	ALUM	ETR	EX	ALUM	EXT	-	EXISTING DOOR WITH NEW ACCESS CONTROL. SEE ELECTRICAL FOR DETAILS.		
V6.2	VESTIBLE	V6	26	7'-0"	6'-0"	ETR	ALUM	ETR	EX	ALUM	EXT	-	EXISTING DOOR WITH NEW ACCESS CONTROL. SEE ELECTRICAL FOR DETAILS.		
V6.3	LOBBY	F17	22	7'-0"	6'-0"	ETR	ALUM	ETR	EX	ALUM	EXT	-	EXISTING DOOR WITH NEW ACCESS CONTROL. SEE ELECTRICAL FOR DETAILS.		
V6.4	LOBBY	F17	25	7'-0"	6'-0"	ETR	ALUM	ETR	EX	ALUM	EXT	-	EXISTING DOOR WITH NEW ACCESS CONTROL. SEE ELECTRICAL FOR DETAILS.		



1 CMU/BRICK EXISTING WALL NEW FRAME HEAD
SCALE: 3" = 1'-0"

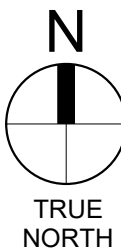


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#	Date	Desc.
1	4/20/2022	Revision 1

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PROJECT: #21140	
DATE: 04/06/2022	
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DOOR SCHEDULE

1 INTERIOR FINISH PLAN - FIRST FLOOR - UNIT A

SCALE: 1/8" = 1'-0" REF. 14 / A763

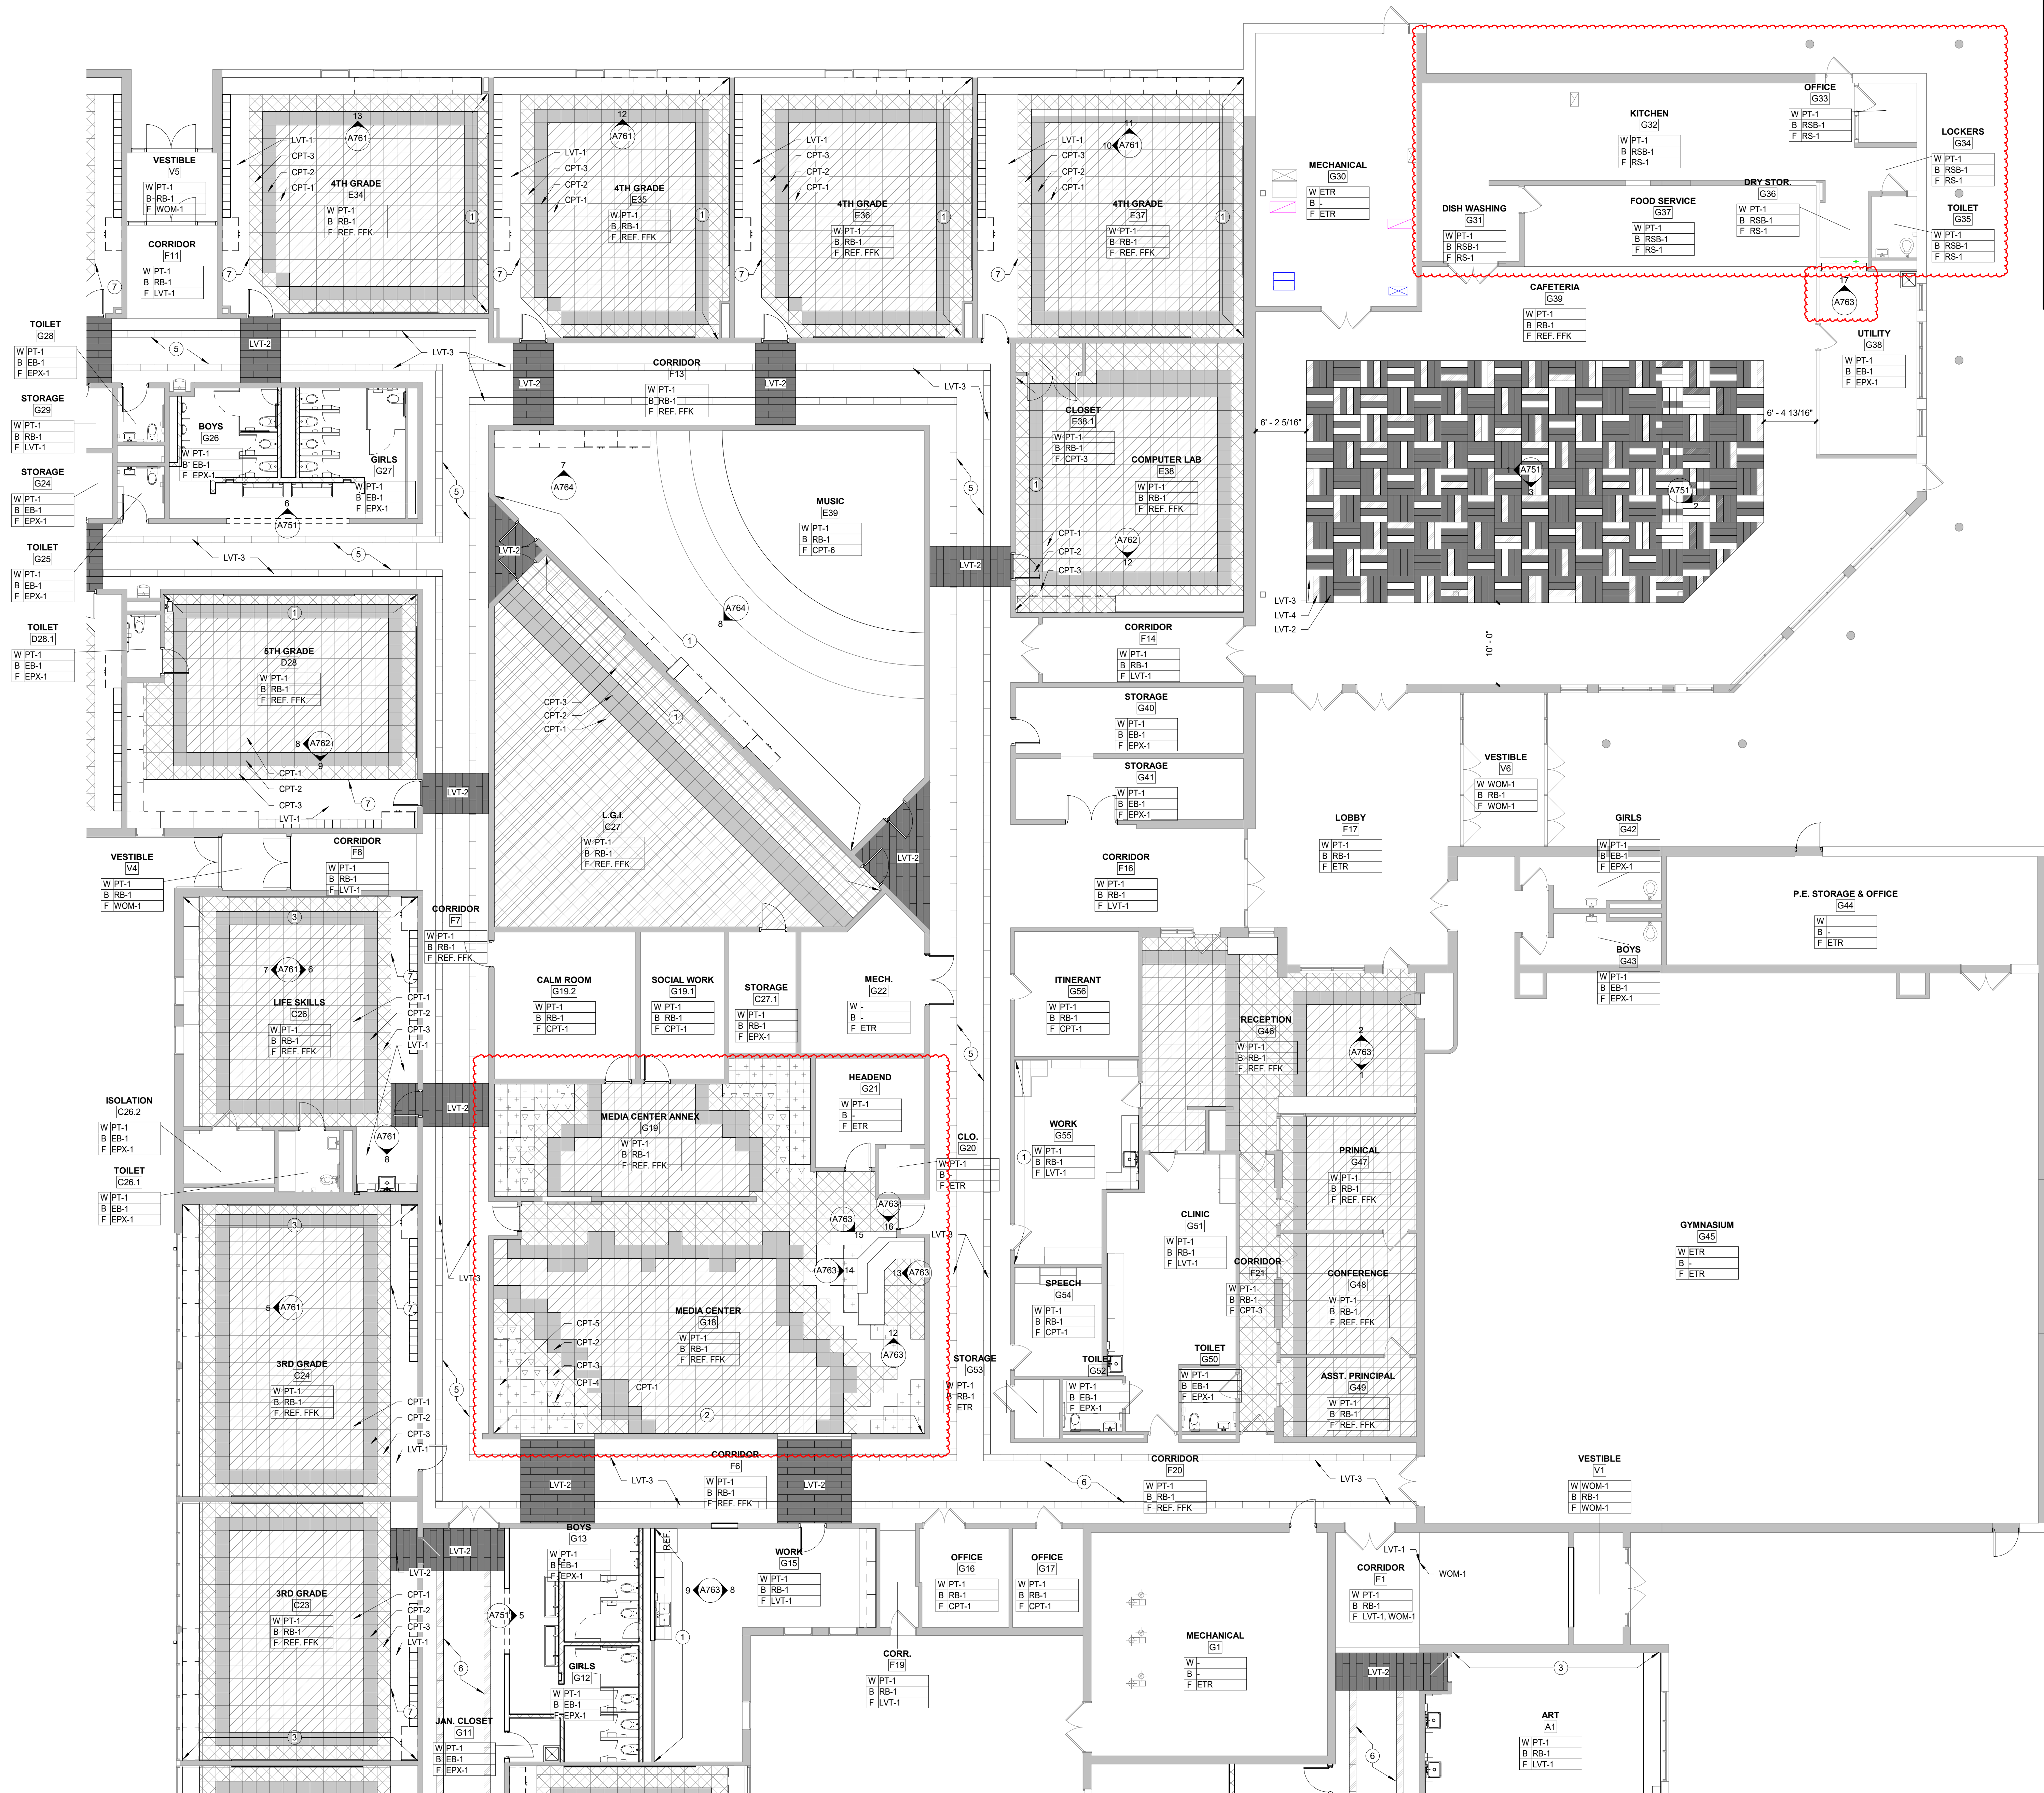

GENERAL NOTES

1. PROVIDE DRYWALL REVEAL JOINT WHERE DRYWALL MEETS DISSIMILAR MATERIALS
2. PROVIDE SCHLUTER EDGE WHERE TILE MEETS DISSIMILAR MATERIALS
3. DO NOT INSTALL RUBBER WALL BASE IN FRONT OF THE TILE
4. DO NOT INSTALL GYPSUM BOARD BEHIND TILE BACKER BOARD
5. WHERE ONLY PAINT IS INDICATED AS A FINISH, REFER TO PLANS FOR SUBSTRATE
6. PAINT EXPOSED STEEL COLUMNS IN CAFETERIA PT-2
7. PAINT HM WINDOW FRAMES AND EXTERIOR HM DOORS PT-2
8. PAINT INTERIOR HM DOORS PT-2
9. GRIND DOWN THE EDGE OF TERRAZZO WHERE IT MEETS DISSIMILAR FLOORING
10. ALL PAINT INSIDE RESTROOMS, CORRIDORS, AND KITCHEN TO BE EPOXY BASED PAINT
11. PAINT PLAIN GYPSUM BOARD CEILING PT-1 UNLESS OTHERWISE INDICATED ON FINISH PLANS AND REFLECTED CEILING PLANS
12. IF A ROOM HAS NO FLOORING HATCH PATTERN, SEE ROOM TAG FOR FLOORING
13. PROVIDE SCHLUTER EDGE TRIM WHERE TILE EDGE IS EXPOSED.

PLAN NOTES - FINISH PLAN

1. PROVIDE ACCENT PAINT (PT-3) WALL AT THIS LOCATION. REF FINISH LEGEND.
2. PROVIDE ACCENT PAINT (PT-4) WALL AT THIS LOCATION. REF FINISH LEGEND.
3. PROVIDE ACCENT PAINT (PT-5) WALL AT THIS LOCATION. REF FINISH LEGEND.
4. FRP (WP-1) AT THIS LOCATION. REF FINISH LEGEND.
5. USE TWO FULL TILES OF LVT-1 CENTERED IN CORRIDOR.
6. USE THREE FULL TILES OF LVT-1 CENTERED IN CORRIDOR.
7. START FULL FLOORING TILE HERE.

FINISH FLOOR KEY (FFK)

	CPT-1
	CPT-2
	CPT-3
	CPT-4
	CPT-5
	LVT-1
	LVT-2
	LVT-3
	LVT-4

SHELBYVILLE CENTRAL SCHOOLS
LOPER ELEMENTARY SCHOOL RENOVATIONS
901 LOPER DRIVE
SHELBYVILLE, IN 46176


LANCER + BEEBE, LLC
ARCHITECTURE | PLANNING | INTERIORS
220 N. COLLEGE AVE
INDIANAPOLIS, IN 46202

REVISIONS:	#	Date	Desc.
	1	4/20/2022	Revision 1

100% CONSTRUCTION DOCUMENTS
PROJECT: #21140
DATE: 04/08/2022
DRAWN BY: Author

INTERIOR
FINISH PLAN -
FIRST FLOOR -
UNIT A

A721A

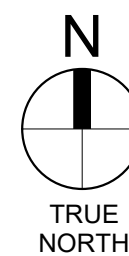


GENERAL NOTES


1. PROVIDE SCHLUTER TRIM WHERE TILE MEETS DISSIMILAR MATERIALS
2. DO NOT INSTALL GYPSUM BOARD BEHIND BACKER BOARD WHERE TILE FINISH IS INDICATED
3. VERIFY ALL WATER FOUNTAIN LOCATIONS IN FEILD

○ ELEVATION NOTES - INTERIOR


- 1 ACOUSTICAL PANELS (AP-1) REF FINISH LEGEND
- 2 WALL TILE 1 (WT-1) REF FINISH LEGEND
- 3 UPPER CABINETS ABOVE CUBBIES AS ALTERNATE.
- 4 WALL TILE 2 (WT-2) REF FINISH LEGEND
- 5 ACOUSTICAL PANELS (AP-2) REF FINISH LEGEND
- 6 ACOUSTICAL PANELS (AP-3) REF FINISH LEGEND
- 7 "4" EPOXY BASE (EB-1) USE SCHLUTER JOLLY WHERE TILE AND EPOXY BASE MEET. REF FINISH LEGEND
- 8 WALL TILE (WT-3) REF FINISH LEGEND
- 9 HEAVY DUTY SHELVING WITH ADJUSTABLE BRACKETS ON TRACK SYSTEM. REF SPECS
- 10 ACOUSTICAL PANELS (AP-4) REF FINISH LEGEND
- 11 WATERFALL SOLID SURFACE. REF FINISH LEGEND
- 12 PROVIDE ACCENT PAINT (PT-2) AND RB-1 AT THIS LOCATION. REF FINISH LEGEND
- 13 PROVIDE PL-1 AT THIS LOCATION. REF FINISH LEGEND.

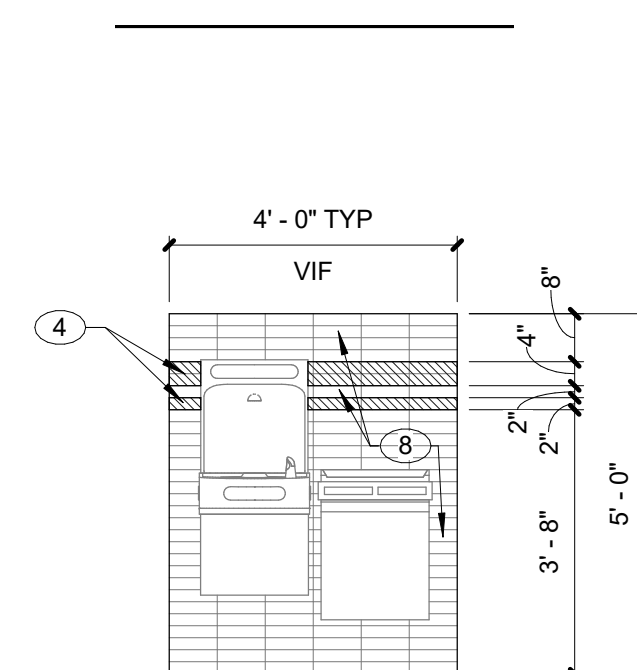


7 TYP. WATER FOUNTAIN ELEVATION
SCALE: 3/8" = 1'-0" REF. 1 / A101A

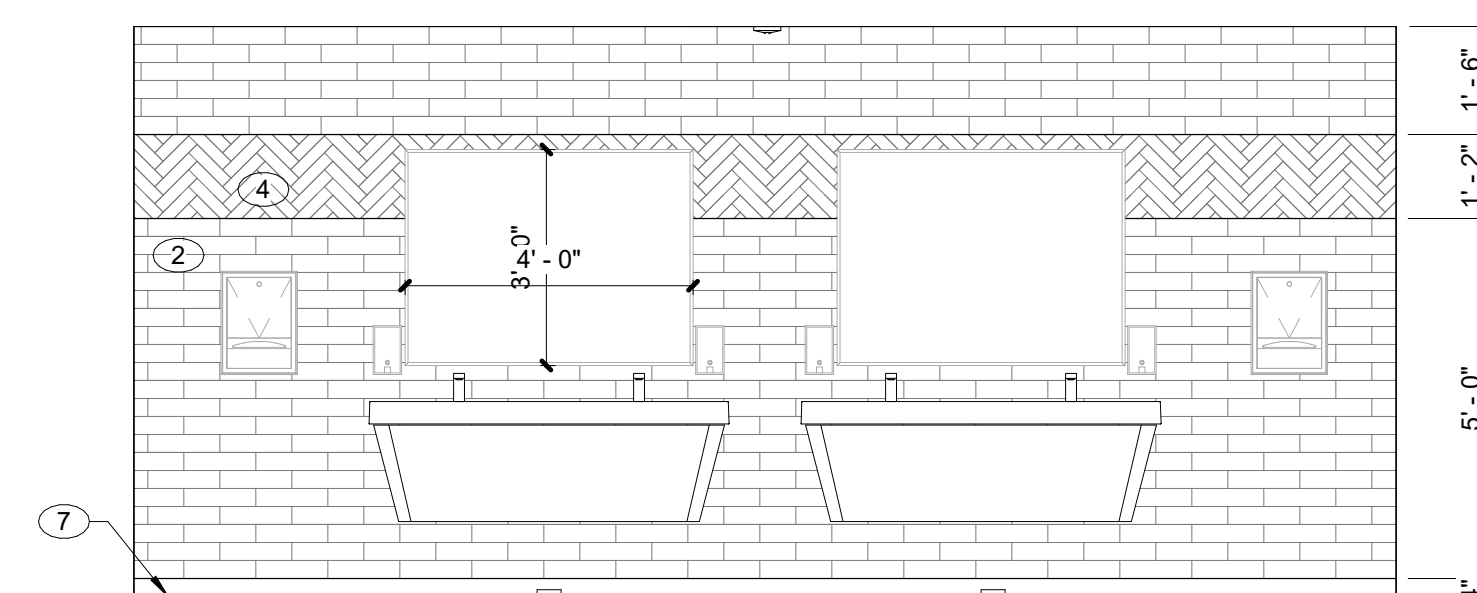


6 G26 & G27 RESTROOM ELEVATION
SCALE: 3/8" = 1'-0" REF. 1 / A101A

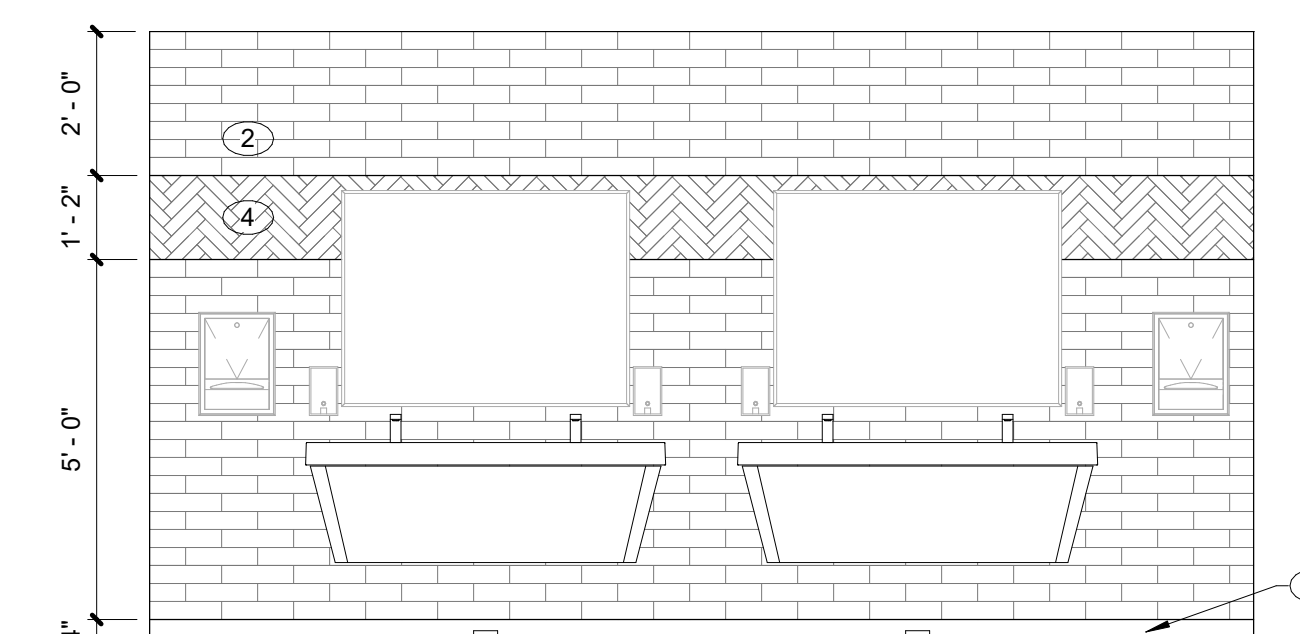


5 G12 & G13 RESTROOM ELEVATION

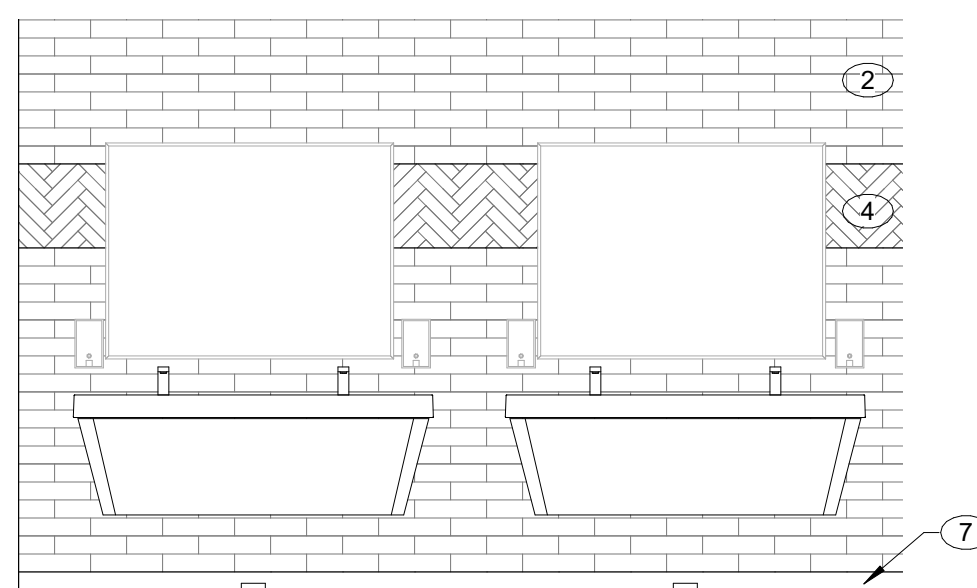


4 G2 & G4 RESTROOM ELEVATION

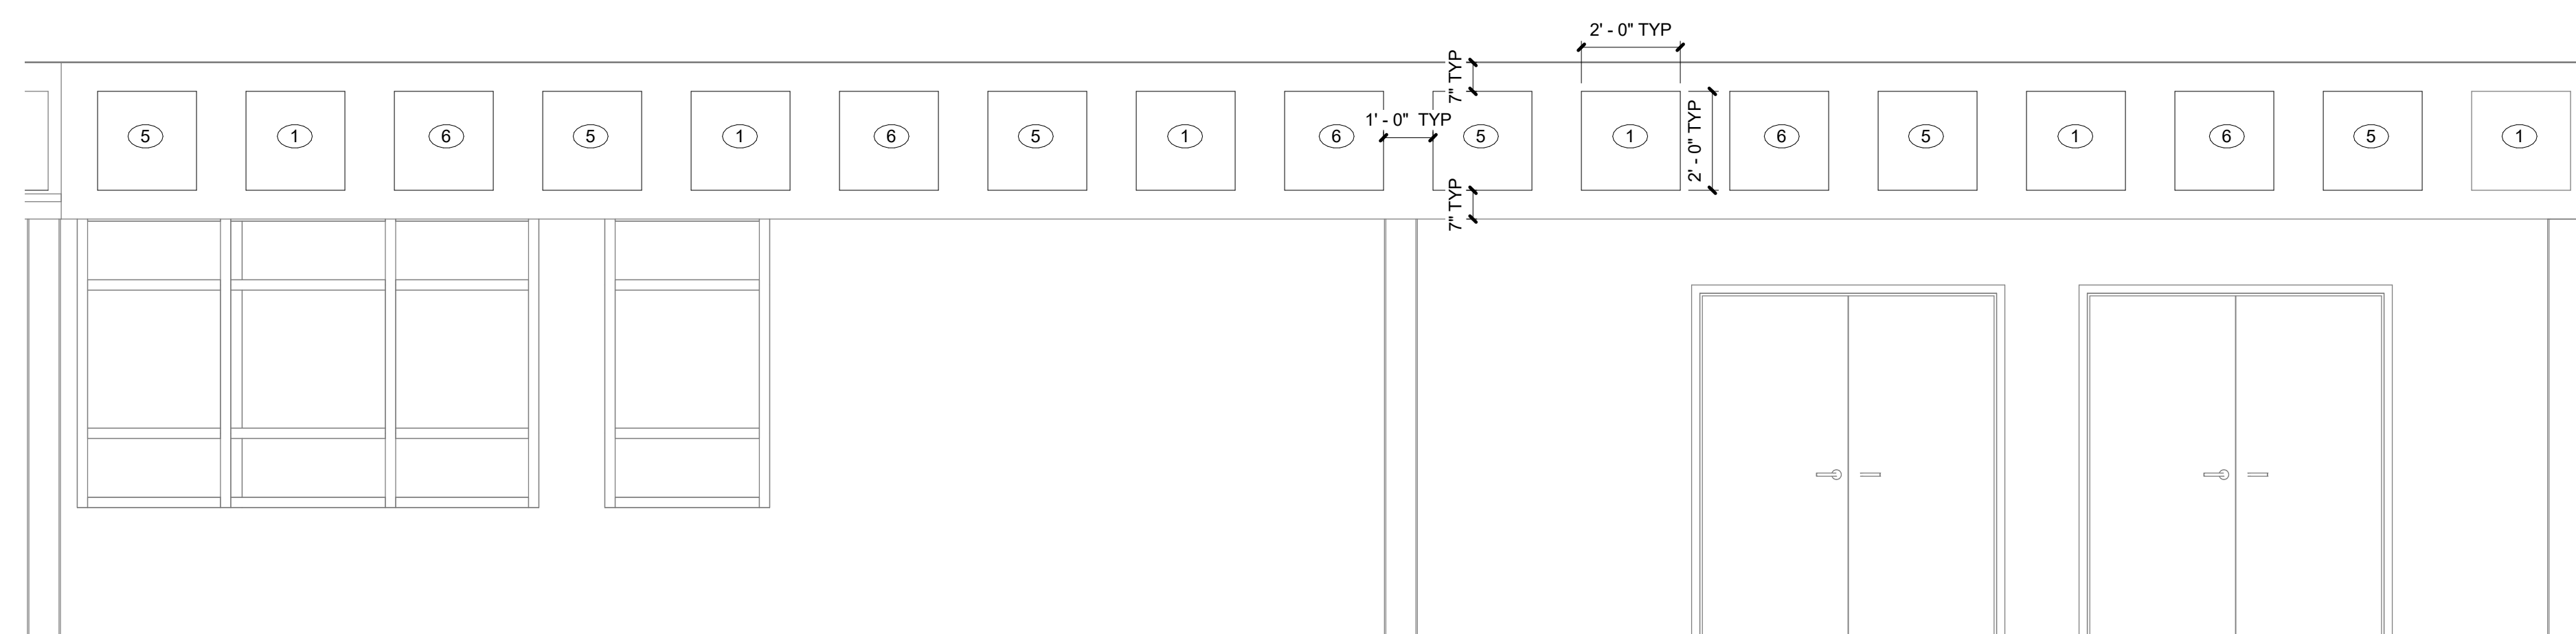

3 CAFETERIA ELEVATION - SOUTH

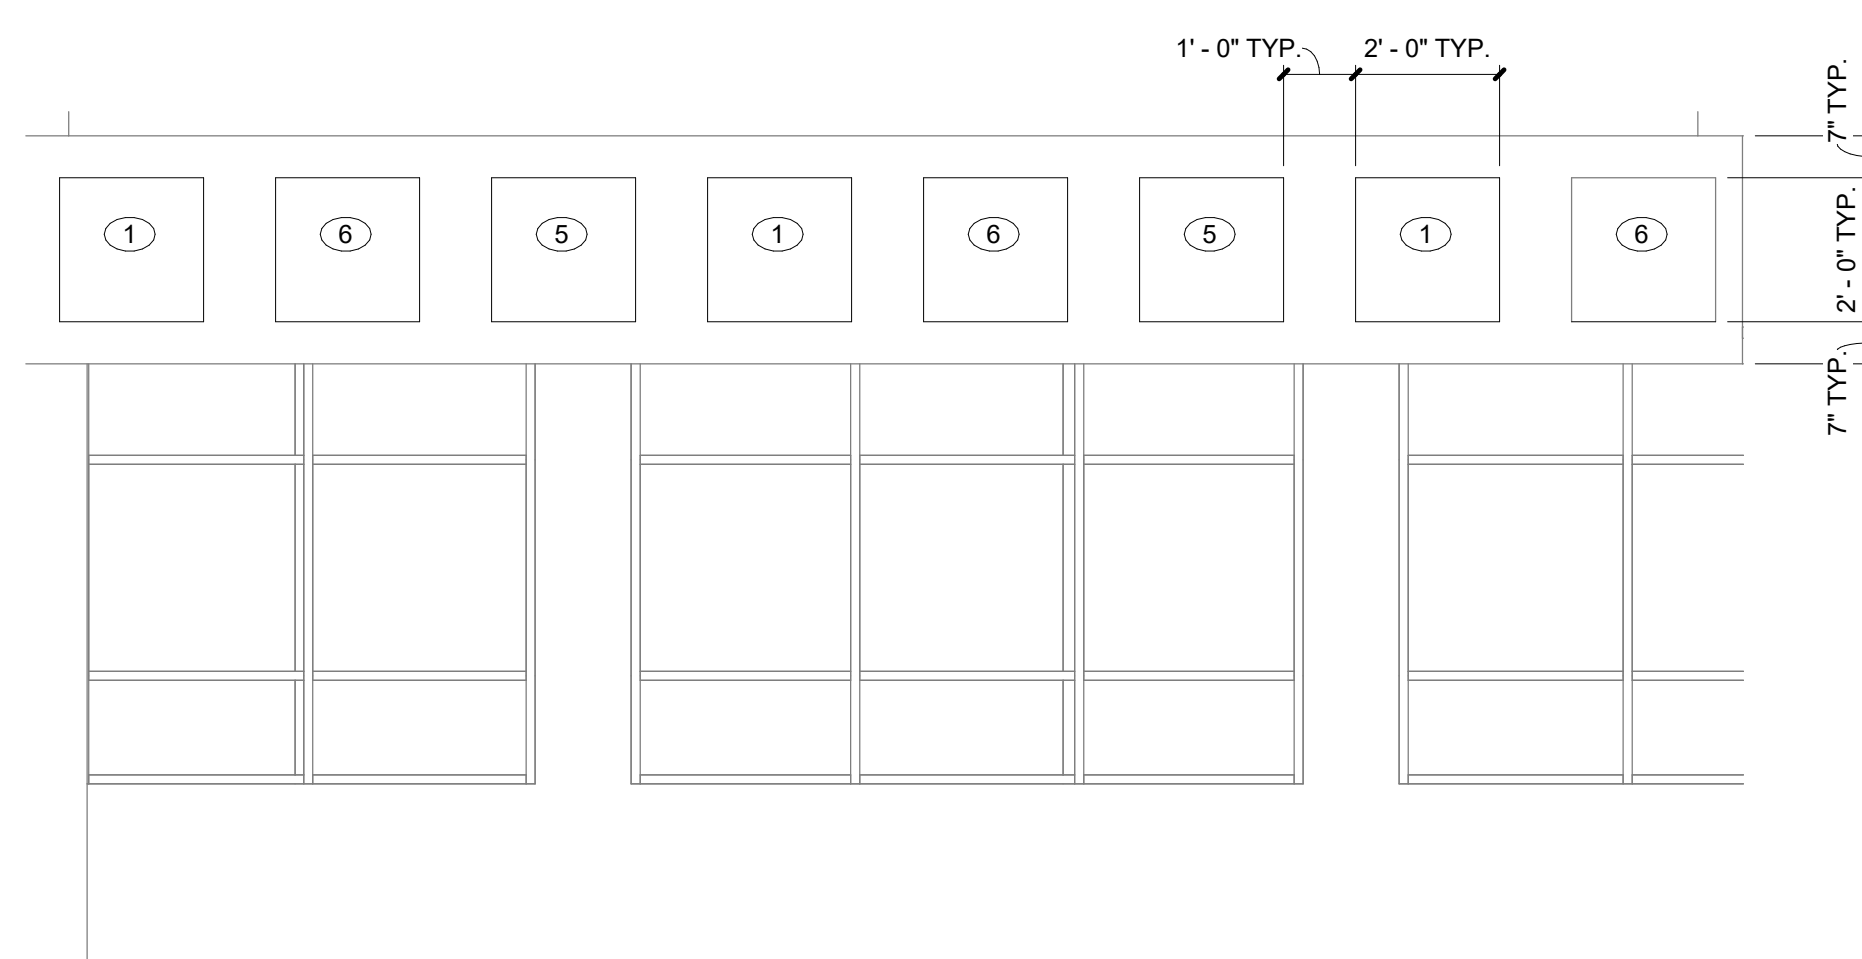


2 CAFETERIA ELEVATION - SOUTHEAST

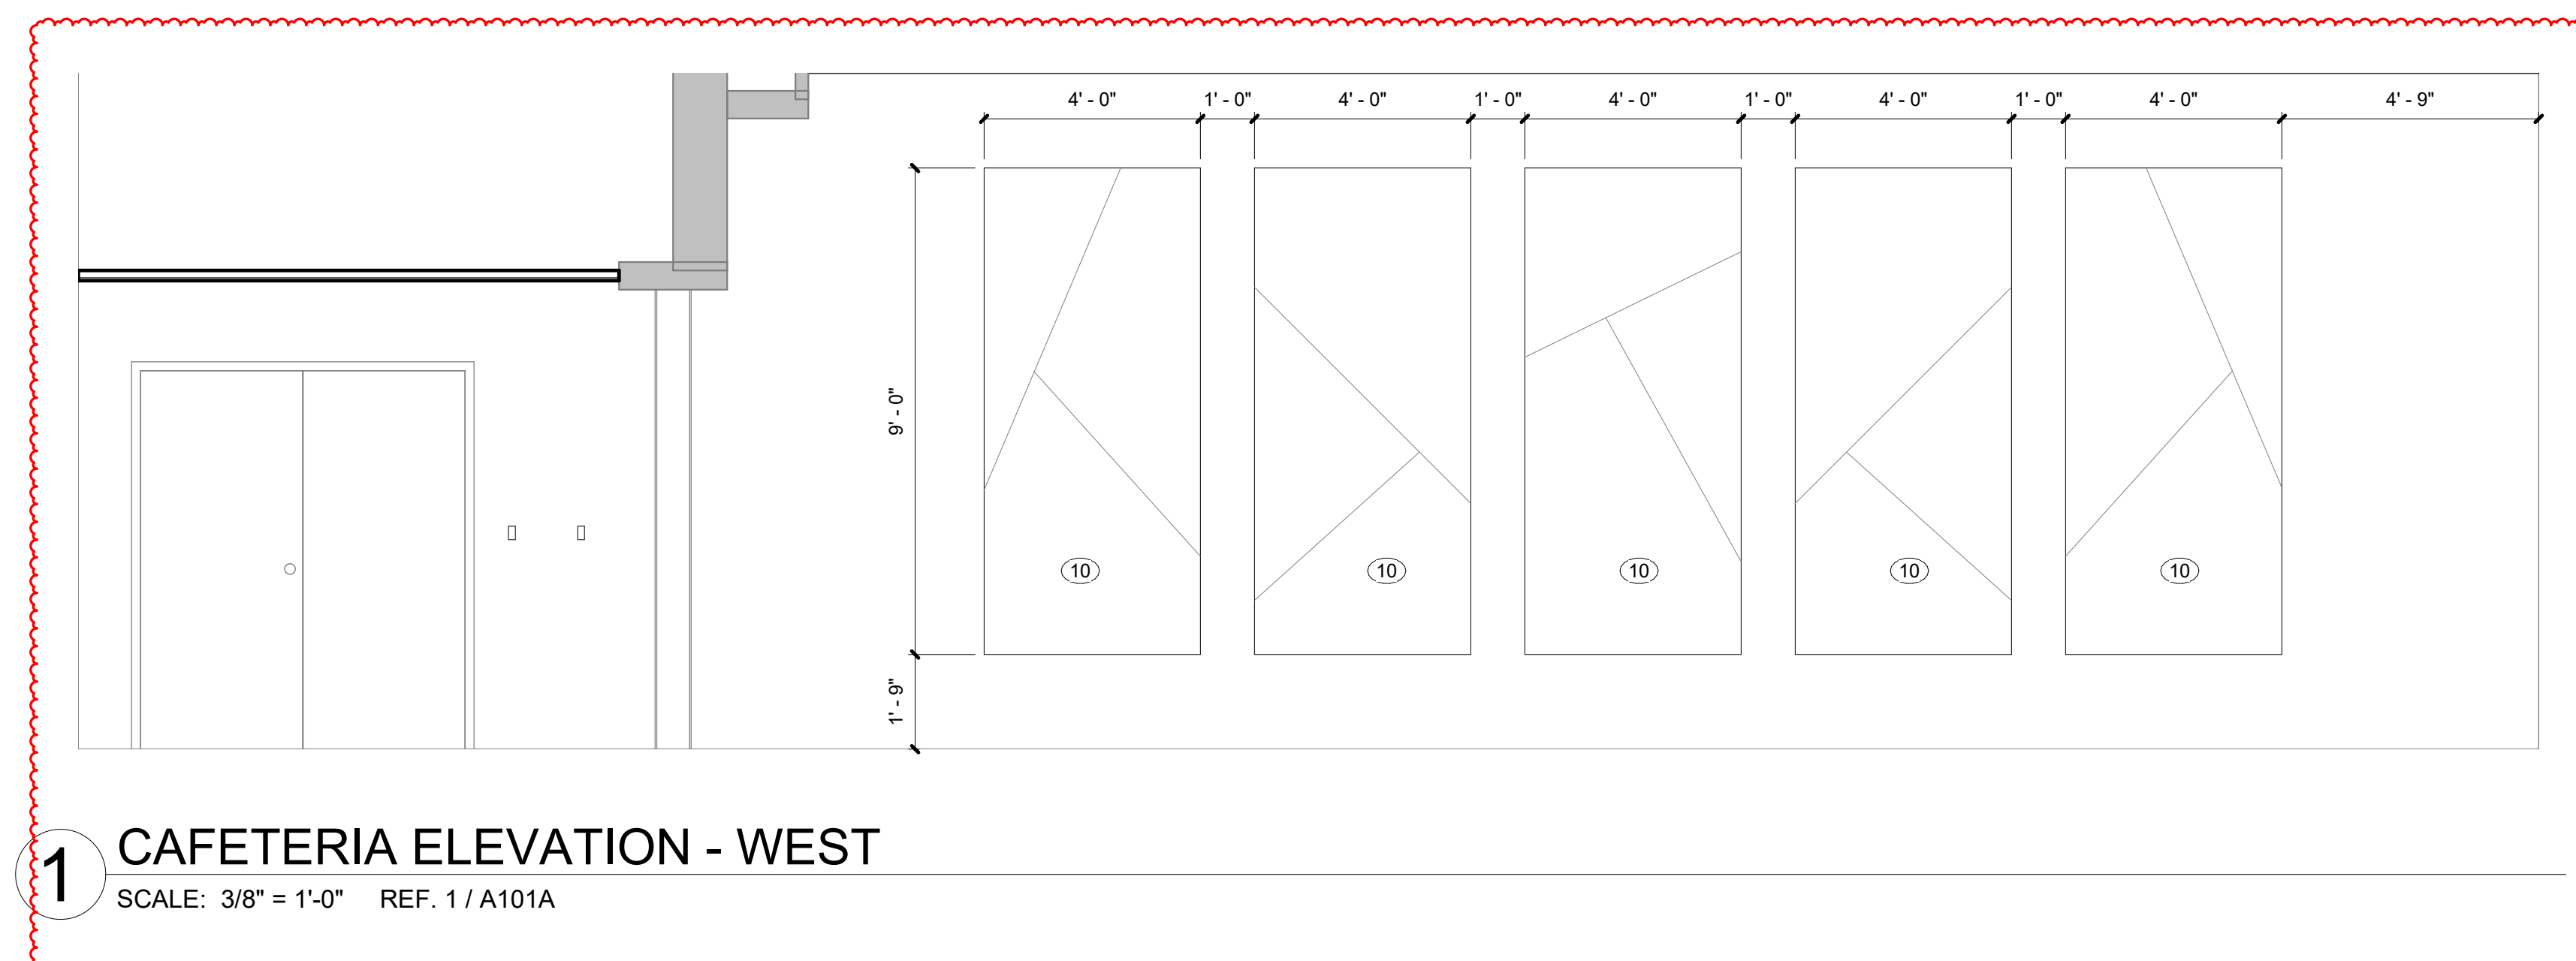


1 CAFETERIA ELEVATION - WEST

SCALE: 3/8" = 1'-0" REF. 1 / A101A

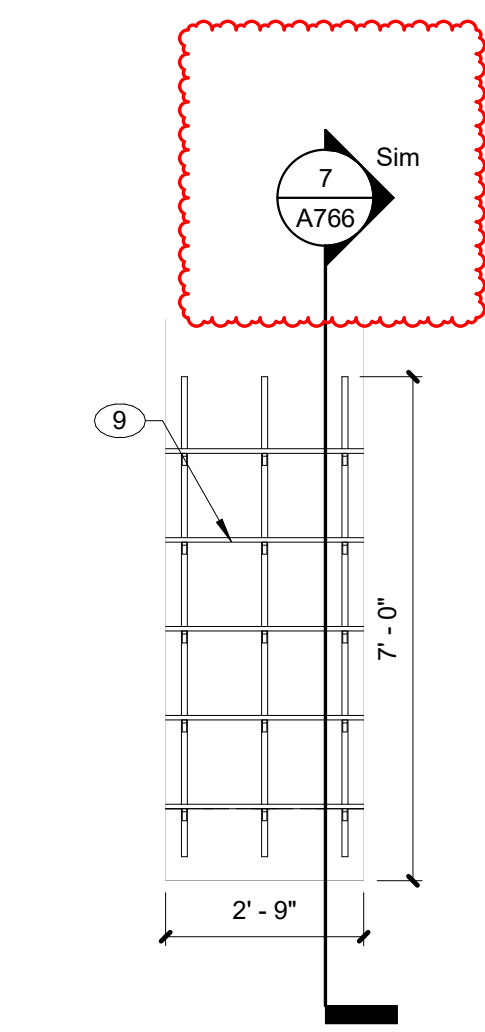


13 TYP. STORAGE CLOSET SHELIVING
SCALE: 3/8" = 1'-0" REF. 1 / A101B

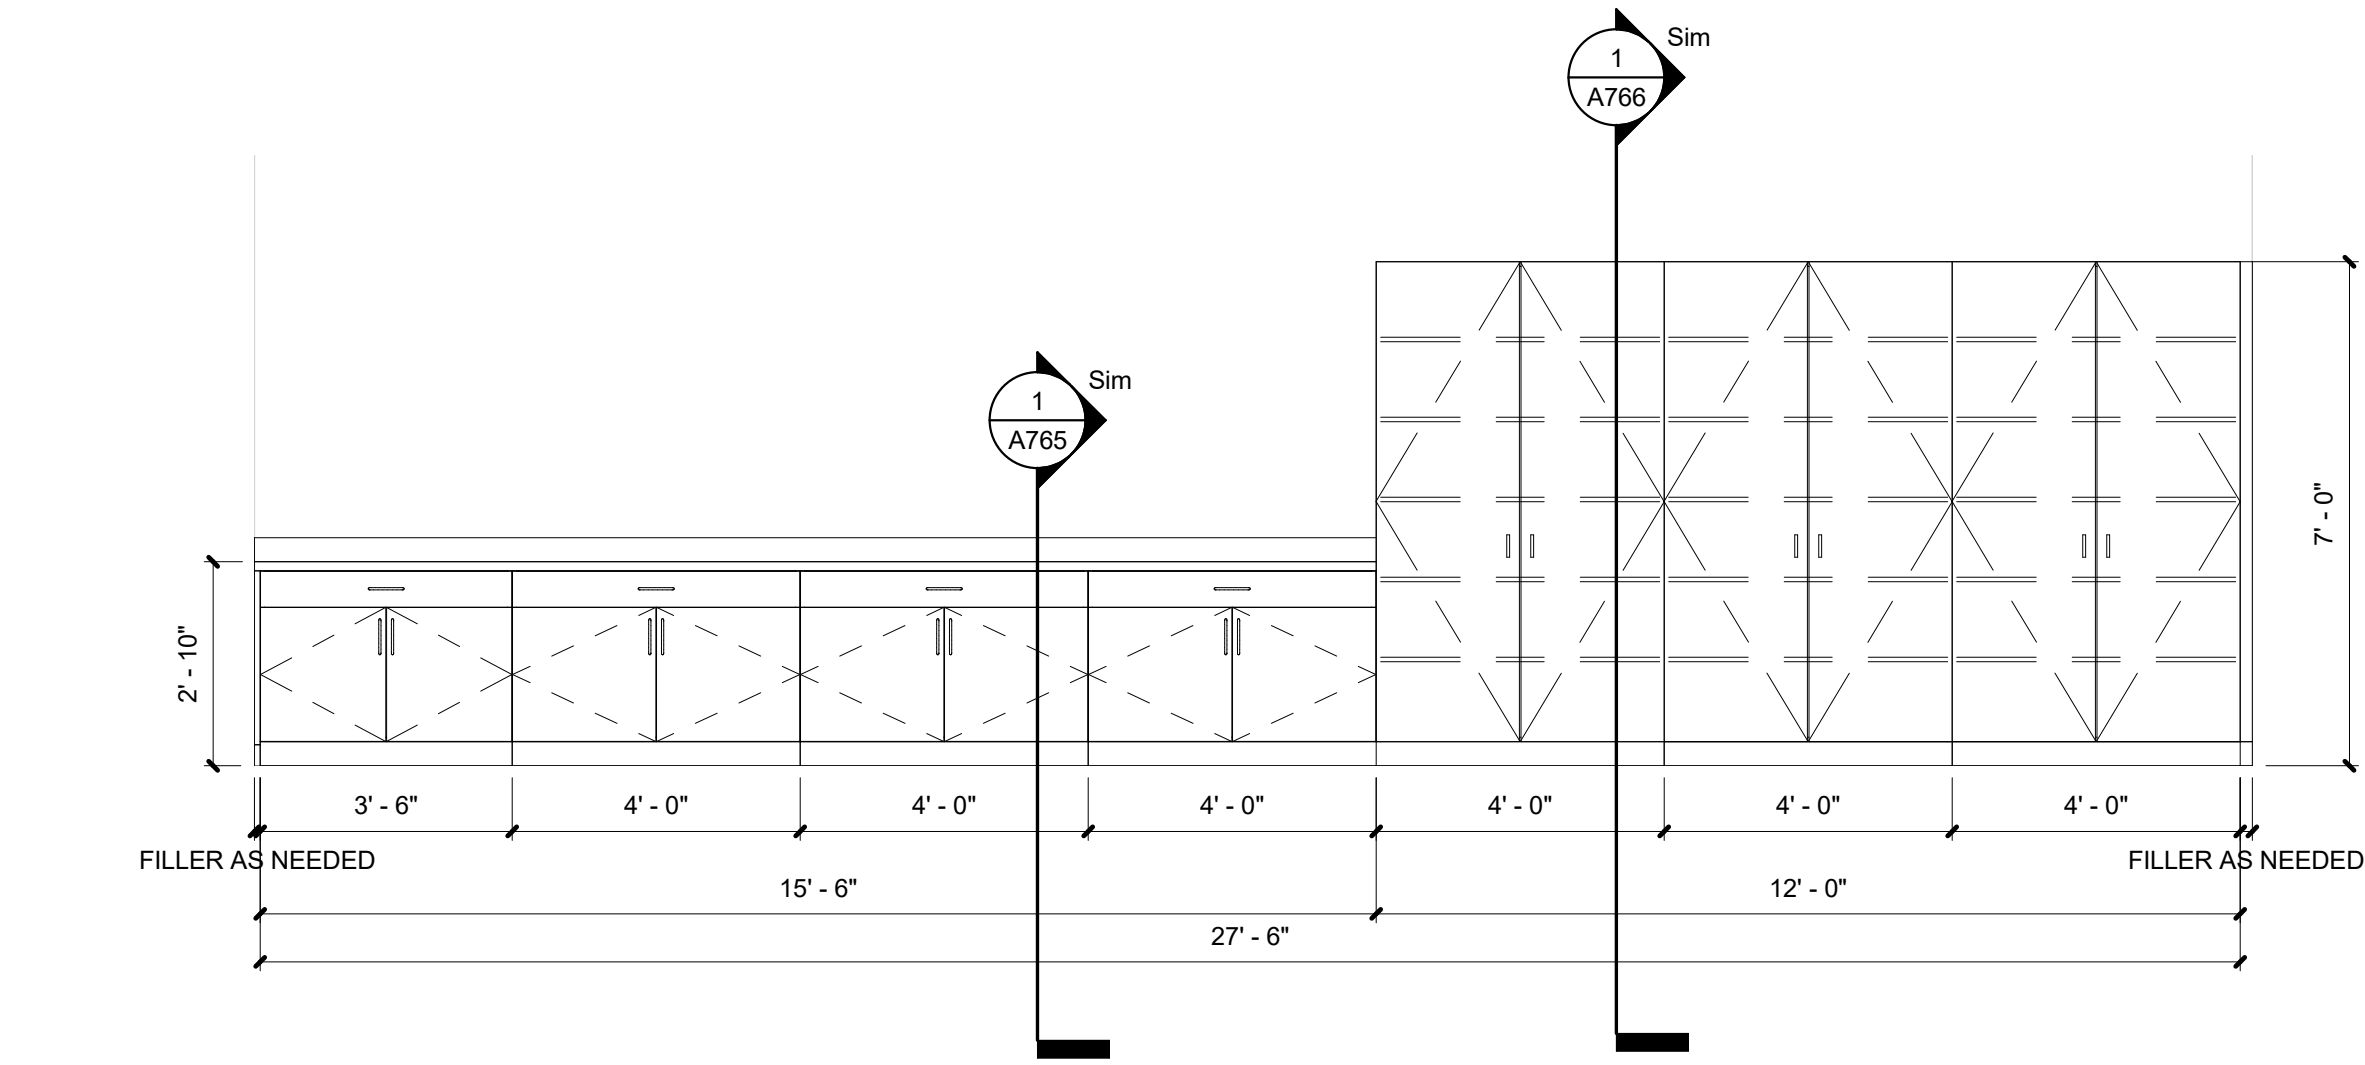

12 E38 CASEWORK ELEVATION - SOUTH
SCALE: 3/8" = 1'-0" REF. 1 / A101A


ELEVATION NOTES - INTERIOR

1. ACOUSTICAL PANELS (AP-1), REF FINISH LEGEND
2. WALL TILE 1 (WT-1), REF FINISH LEGEND
3. UPPER CABINETS ABOVE CUBBIES AS ALTERNATE
4. WALL TILE 2 (WT-2), REF FINISH LEGEND
5. ACOUSTICAL PANELS (AP-2), REF FINISH LEGEND
6. ACOUSTICAL PANELS (AP-3), REF FINISH LEGEND
7. 4" EPOXY BASE (EB-1), USE SCHLUTER JOLLY WHERE TILE AND EPOXY BASE MEET, REF FINISH LEGEND
8. WALL TILE (WT-3), REF FINISH LEGEND
9. HEAVY DUTY SHELIVING WITH ADJUSTABLE BRACKETS ON TRACK SYSTEM, REF SPECS.
10. ACOUSTICAL PANELS (AP-4), REF FINISH LEGEND
11. WATERFALL SOLID SURFACE SS-1, REF FINISH LEGEND
12. PROVIDE ACCENT PAINT (PT-2) AND RB-1 AT THIS LOCATION, REF FINISH LEGEND.
13. PROVIDE PL-1 AT THIS LOCATION, REF FINISH LEGEND.

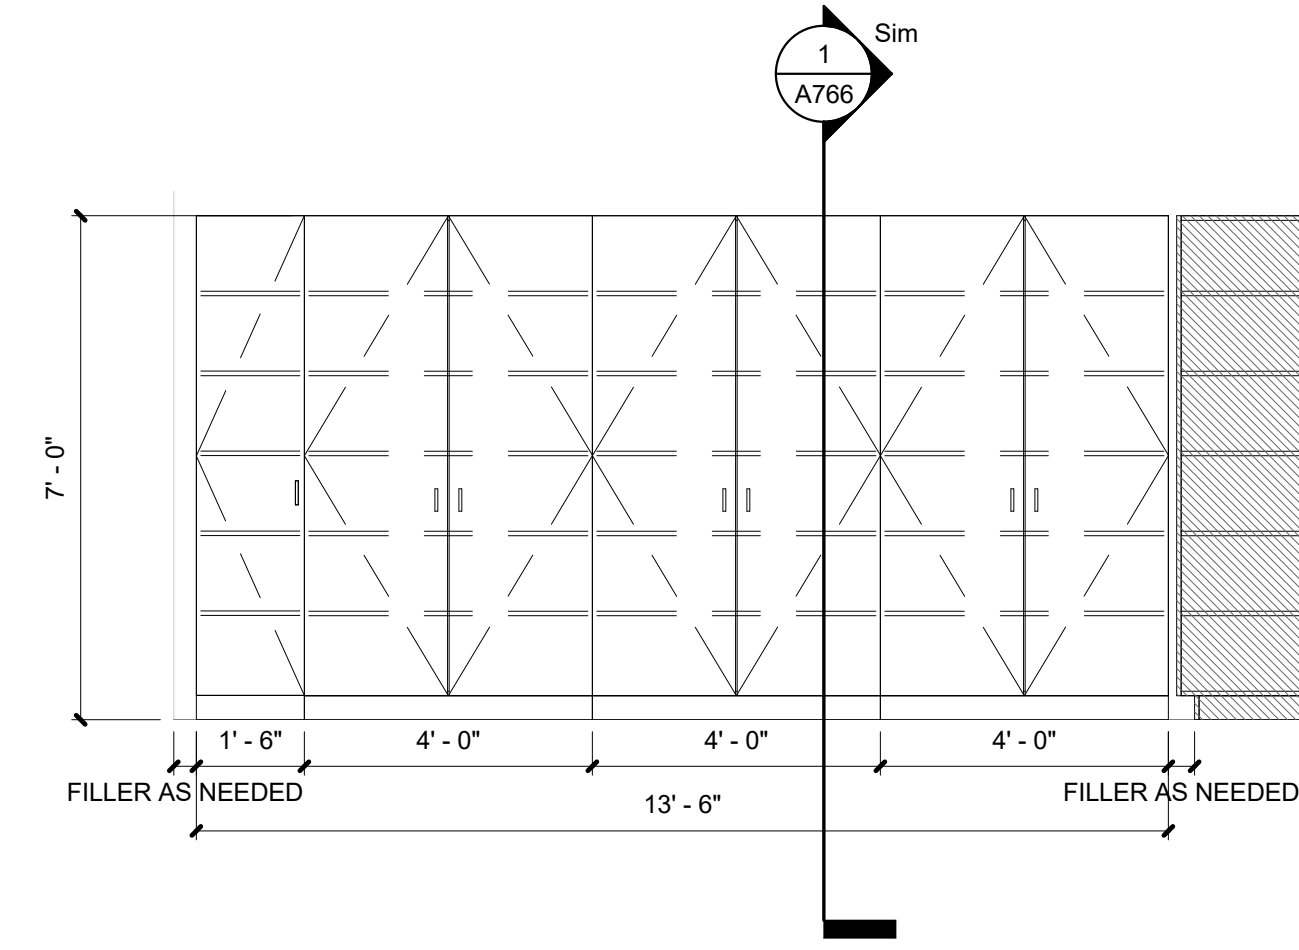


11 G23 CASEWORK ELEVATION - WEST
SCALE: 3/8" = 1'-0" REF. 1 / A101C


GENERAL CASEWORK NOTES	
1. FABRICATE WOODWORK/MILLWORK ITEMS TO ACTUAL FIELD DIMENSIONS. CONTRACTOR SHALL SUBMIT FOR DESIGNERS APPROVALS SHOP DRAWINGS SAMPLES OR MANUFACTURER'S LITERATURE FOR ALL ITEMS. SHOP DRAWINGS SHALL SHOW SUFFICIENT DETAIL TO DETERMINE COMPLIANCE WITH STANDARDS AND DESIGN INTENT.	7. ALL VERTICAL PLASTIC LAMINATE SURFACES AND SHELVES TO BE PL-1. ALL COUNTERTOPS THAT ARE PLASTIC LAMINATE TO BE PL-2 UNLESS OTHERWISE NOTED. REF FINISH LEGEND.
2. PROVIDE ALL NECESSARY FURRING AND GROUNDS FOR WOODWORK AND FINISH ITEMS. COORDINATE LOCATION OF BLOCKING WITHIN FRAMED WALLS AS NECESSARY FOR ITEMS TO BE SECURED TO SURFACE. ALL FASTENERS SHALL BE CONCEALED.	8. ALL INTERIORS BEHIND DOORS/ DRAWERS AND NOT VISIBLE SHALL BE WHITE.
3. FINISH ALL SIDES AND BACK OF MILLWORK/ CASEWORK	9. ALL NEW SOLID SURFACE COUNTERTOPS TO BE SS-1. SOLID SURFACE COUNTERS LOCATED AT SINKS. REF FLOOR PLAN AND FINISH LEGEND.
4. PROVIDE GROMMETS IN COUNTERTOPS ABOVE ALL ELECTRICAL RECEPTICALS AND TELEPHONE DATA ROUTINGS.	10. SEE ELEC. DWGS FOR ELECTRICAL DEVICES.
5. ALL PULLS TO BE 4" SATIN NICKEL SOLID WIRE PULL.	11. VERIFY ALL DIMENSIONS IN FIELD AND PROVIDE COMPLETE SHOP DRAWINGS.
6. PROVIDE LOOKS FOR ALL STORAGE BASE CABINETS/ TALL STORAGE CABINETS. ALL DRAWERS AND DOORS, ALL UPPER WALL CABINETS AND ALL DISPLAY CASE SLIDING GLASS PANELS.	12. PROVIDE BLIND CORNER BASE AND UPPER CABINETS - TYPICAL.

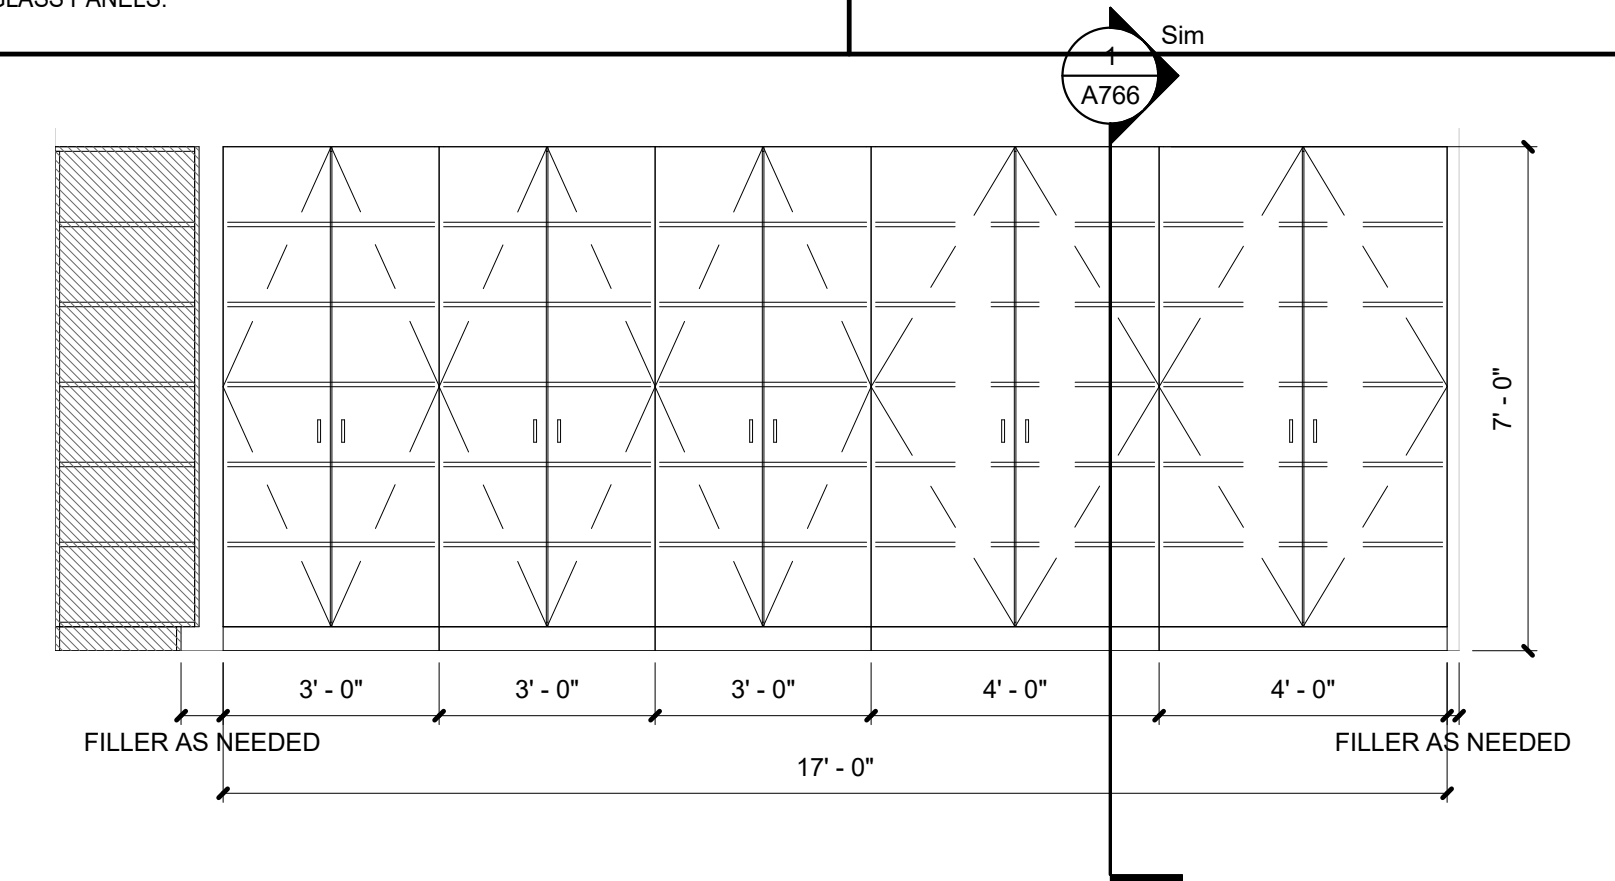


10 G23 CASEWORK ELEVATION - NORTH
SCALE: 3/8" = 1'-0" REF. 1 / A101C

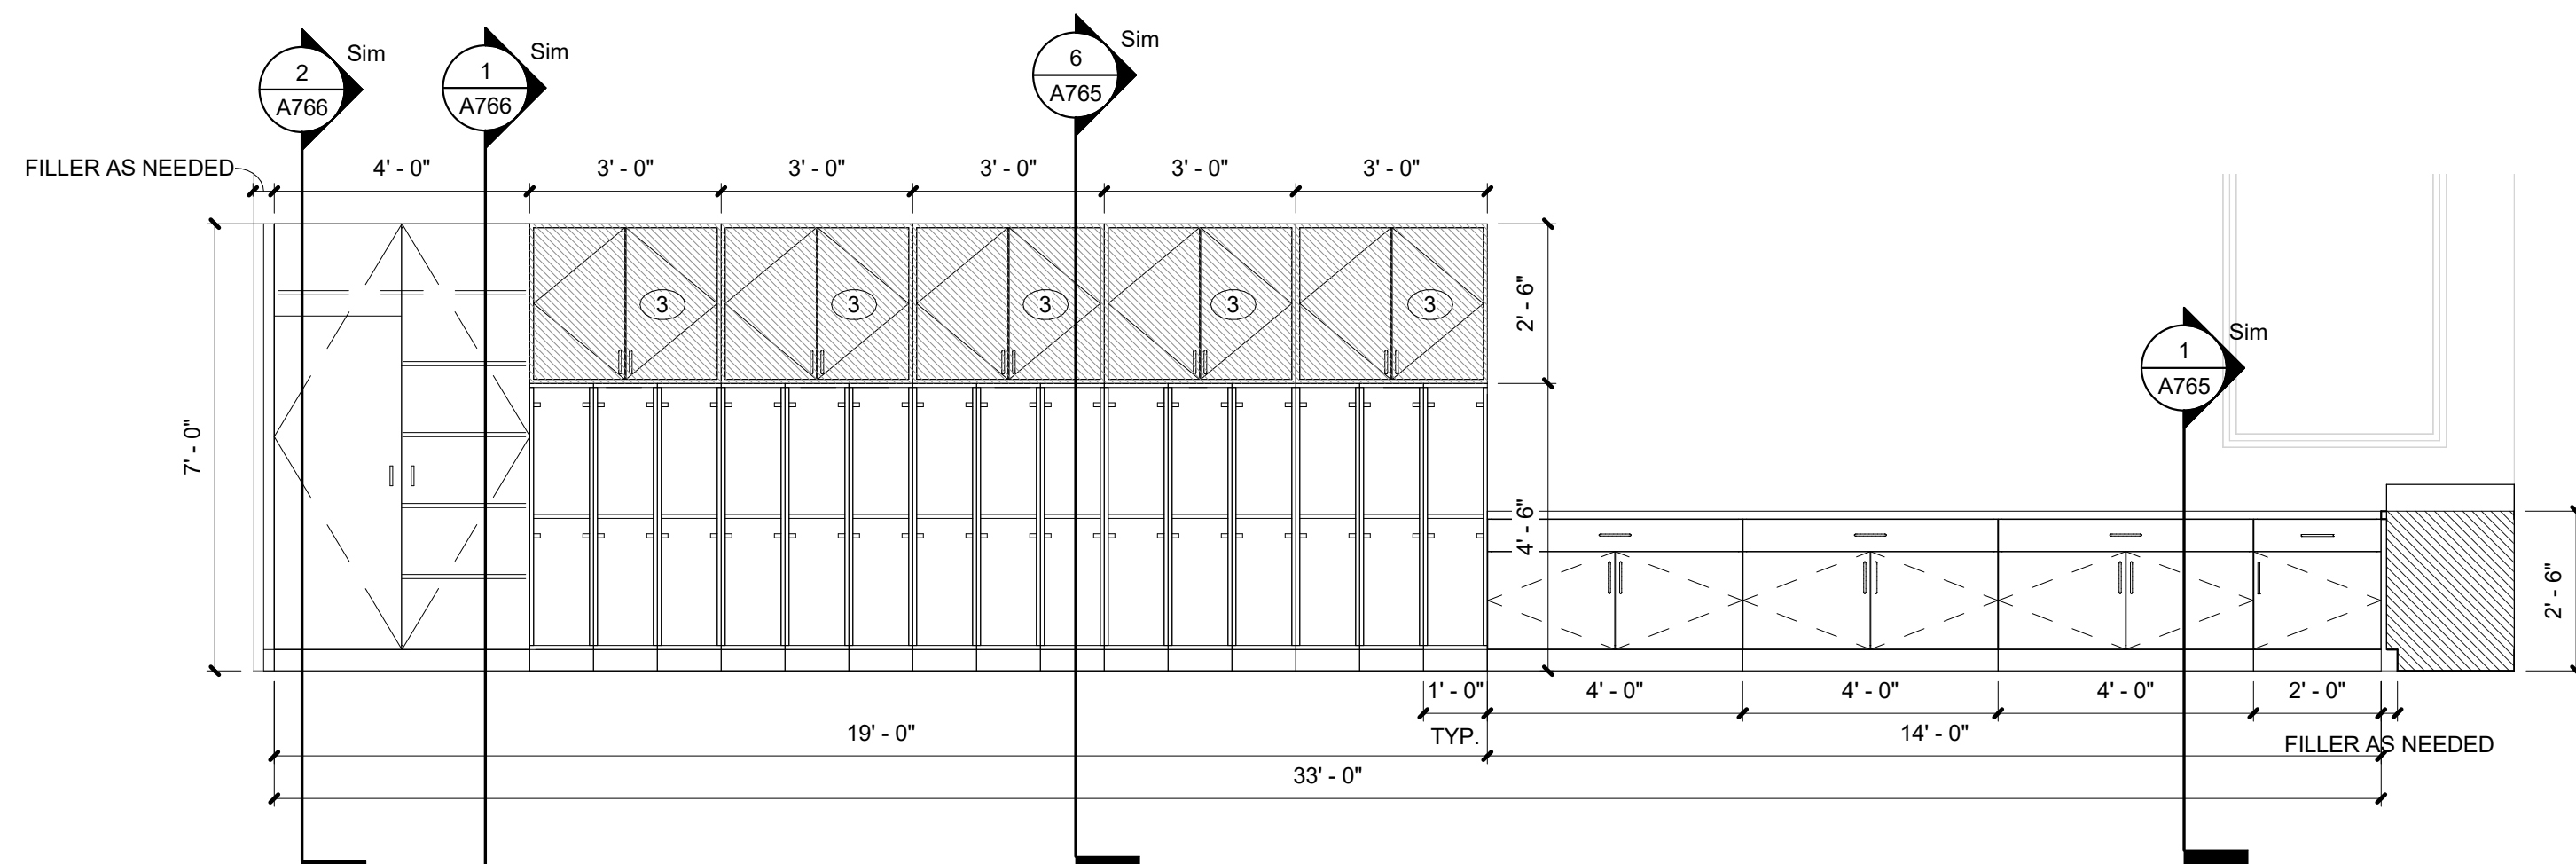


9 D28 CASEWORK ELEVATION - SOUTH
SCALE: 3/8" = 1'-0" REF. 1 / A101A

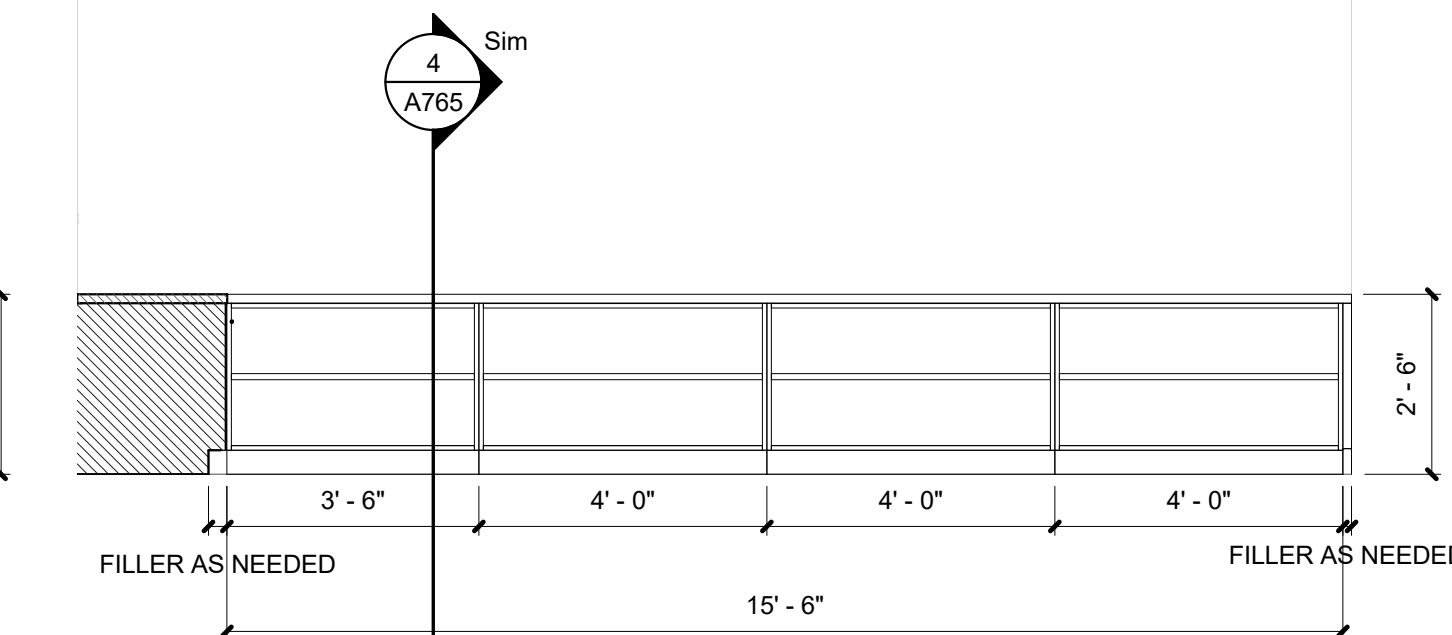


8 D28 CASEWORK ELEVATION - WEST
SCALE: 3/8" = 1'-0" REF. 1 / A101A

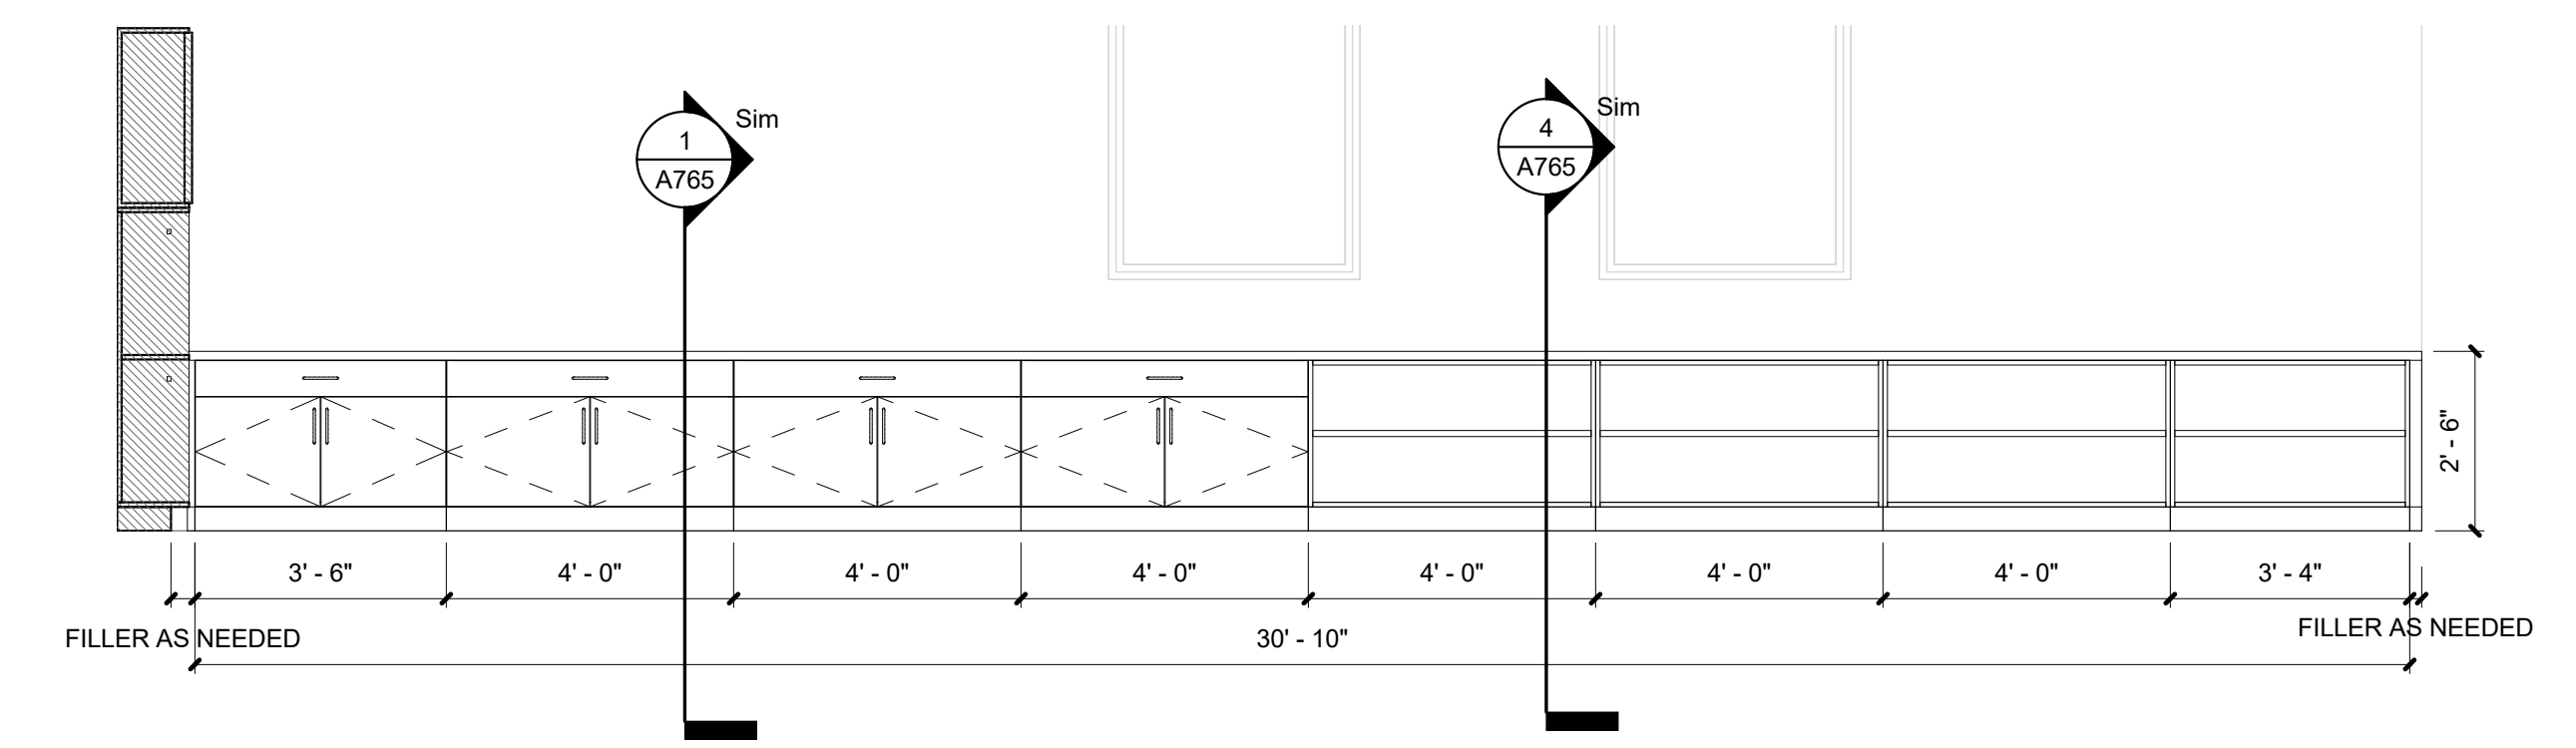


7 D29 CASEWORK ELEVATION - SOUTH
SCALE: 3/8" = 1'-0" REF. 1 / A101A

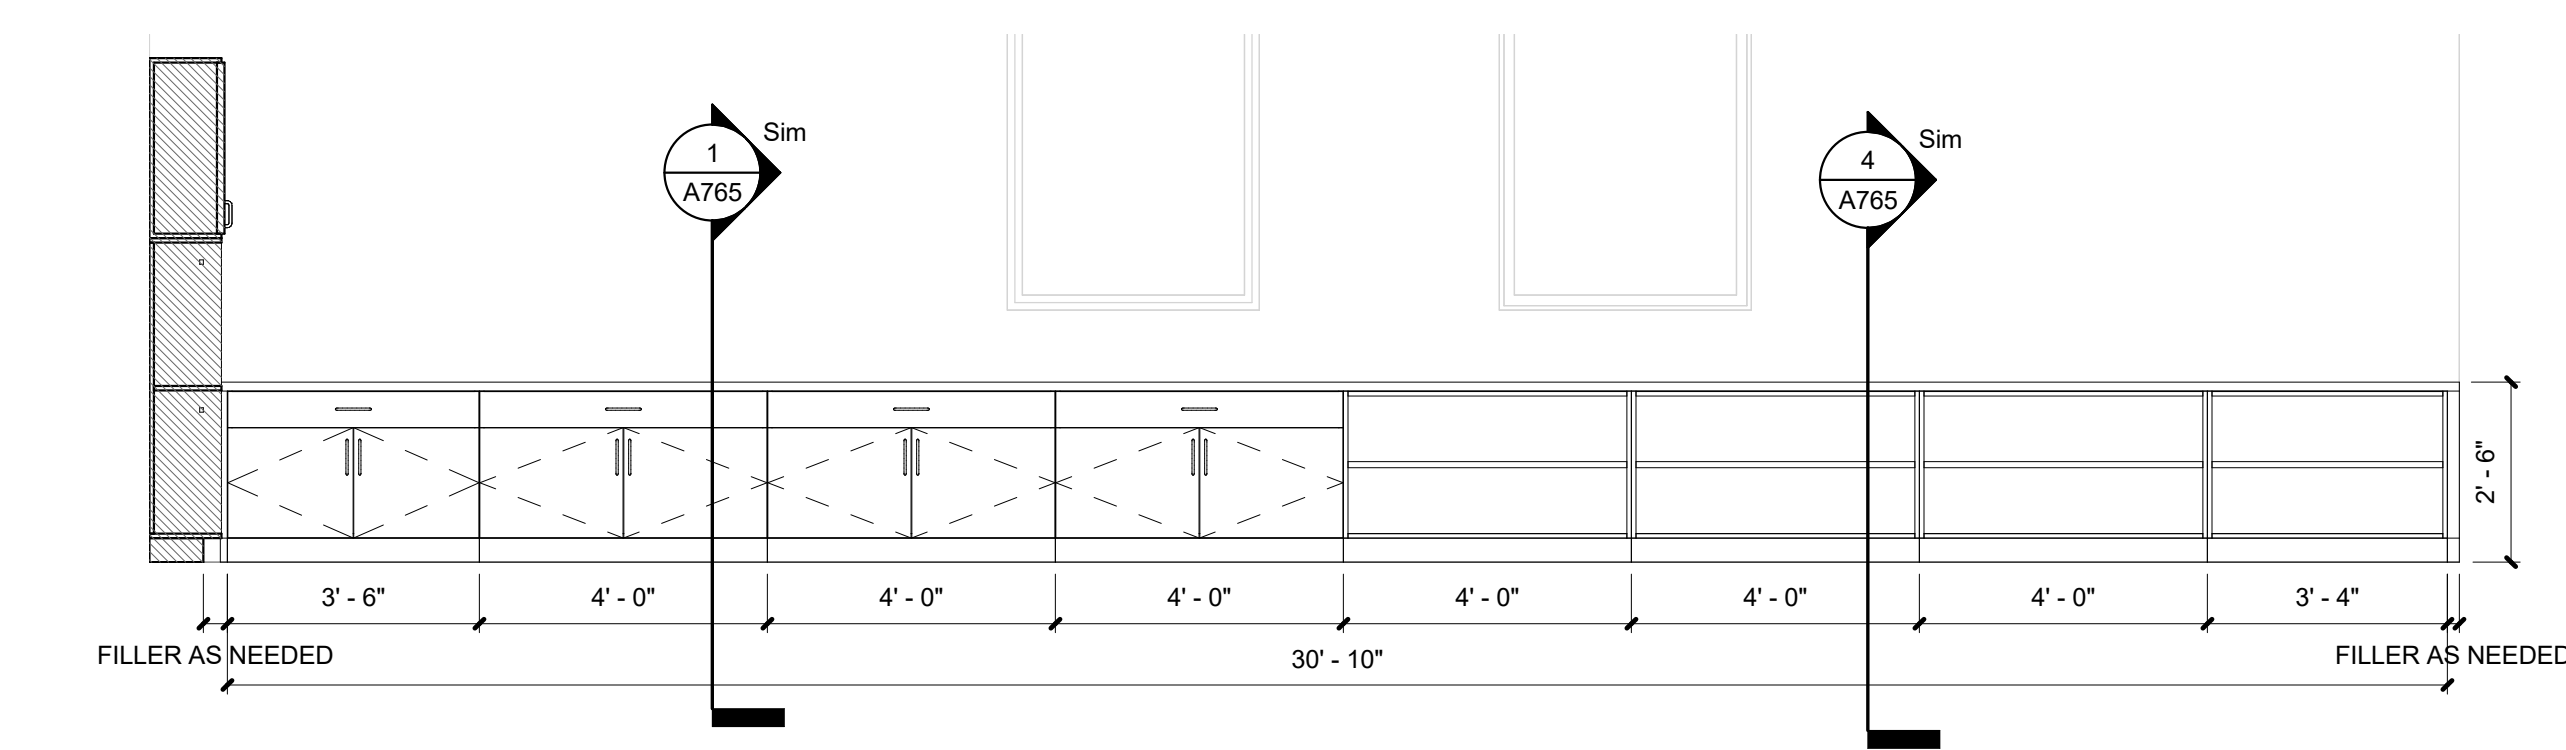


6 D30 CASEWORK ELEVATION - SOUTH
SCALE: 3/8" = 1'-0" REF. 1 / A101C

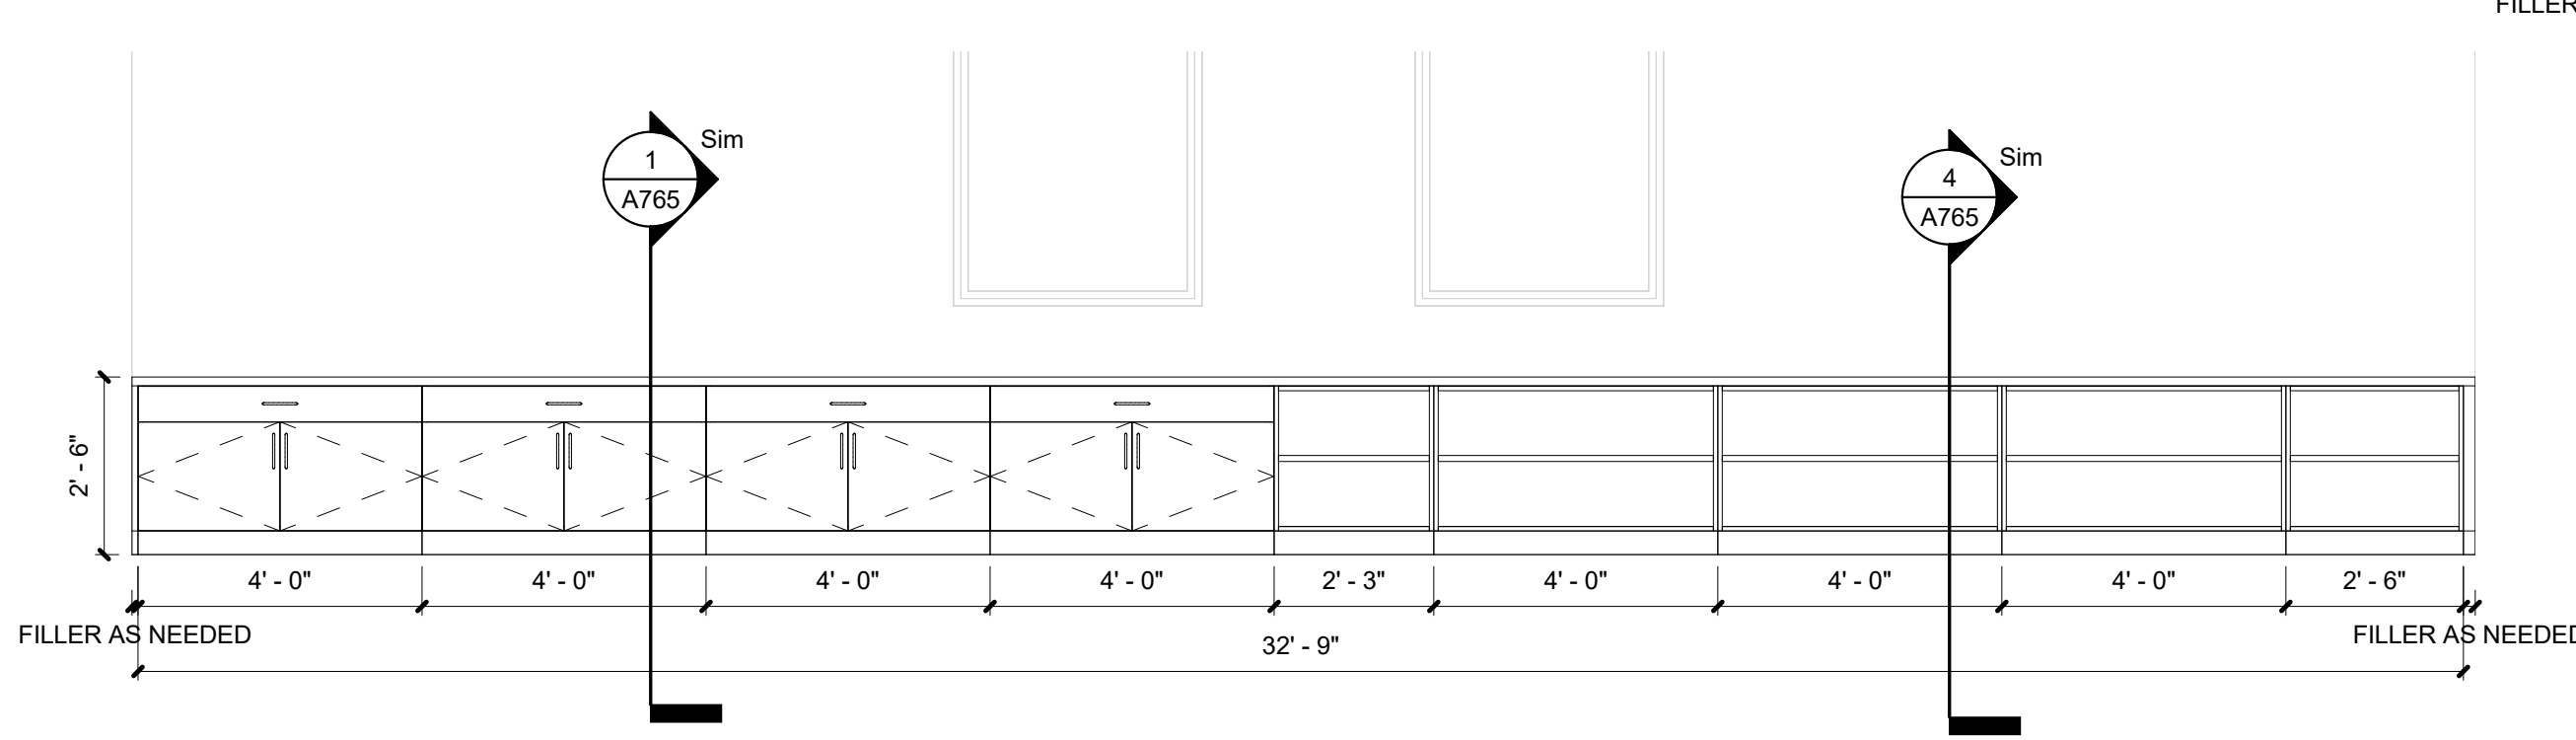


5 D31 CASEWORK ELEVATION - WEST
SCALE: 3/8" = 1'-0" REF. 1 / A101C

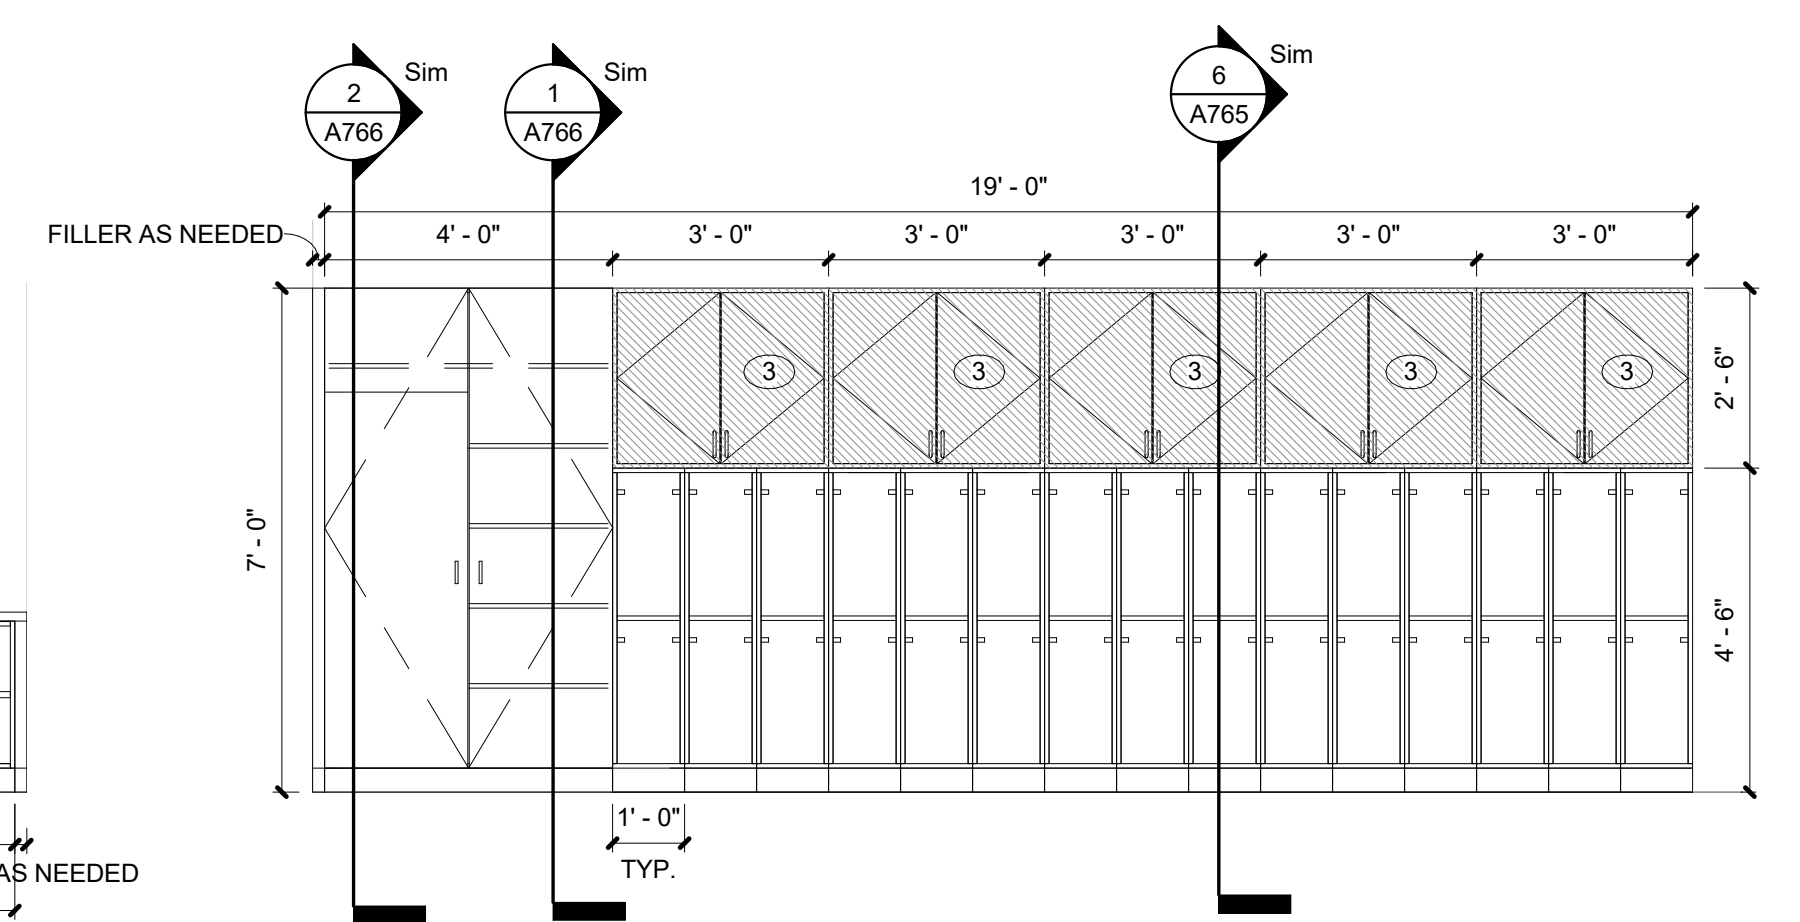


4 D31 CASEWORK ELEVATION - EAST
SCALE: 3/8" = 1'-0" REF. 1 / A101C

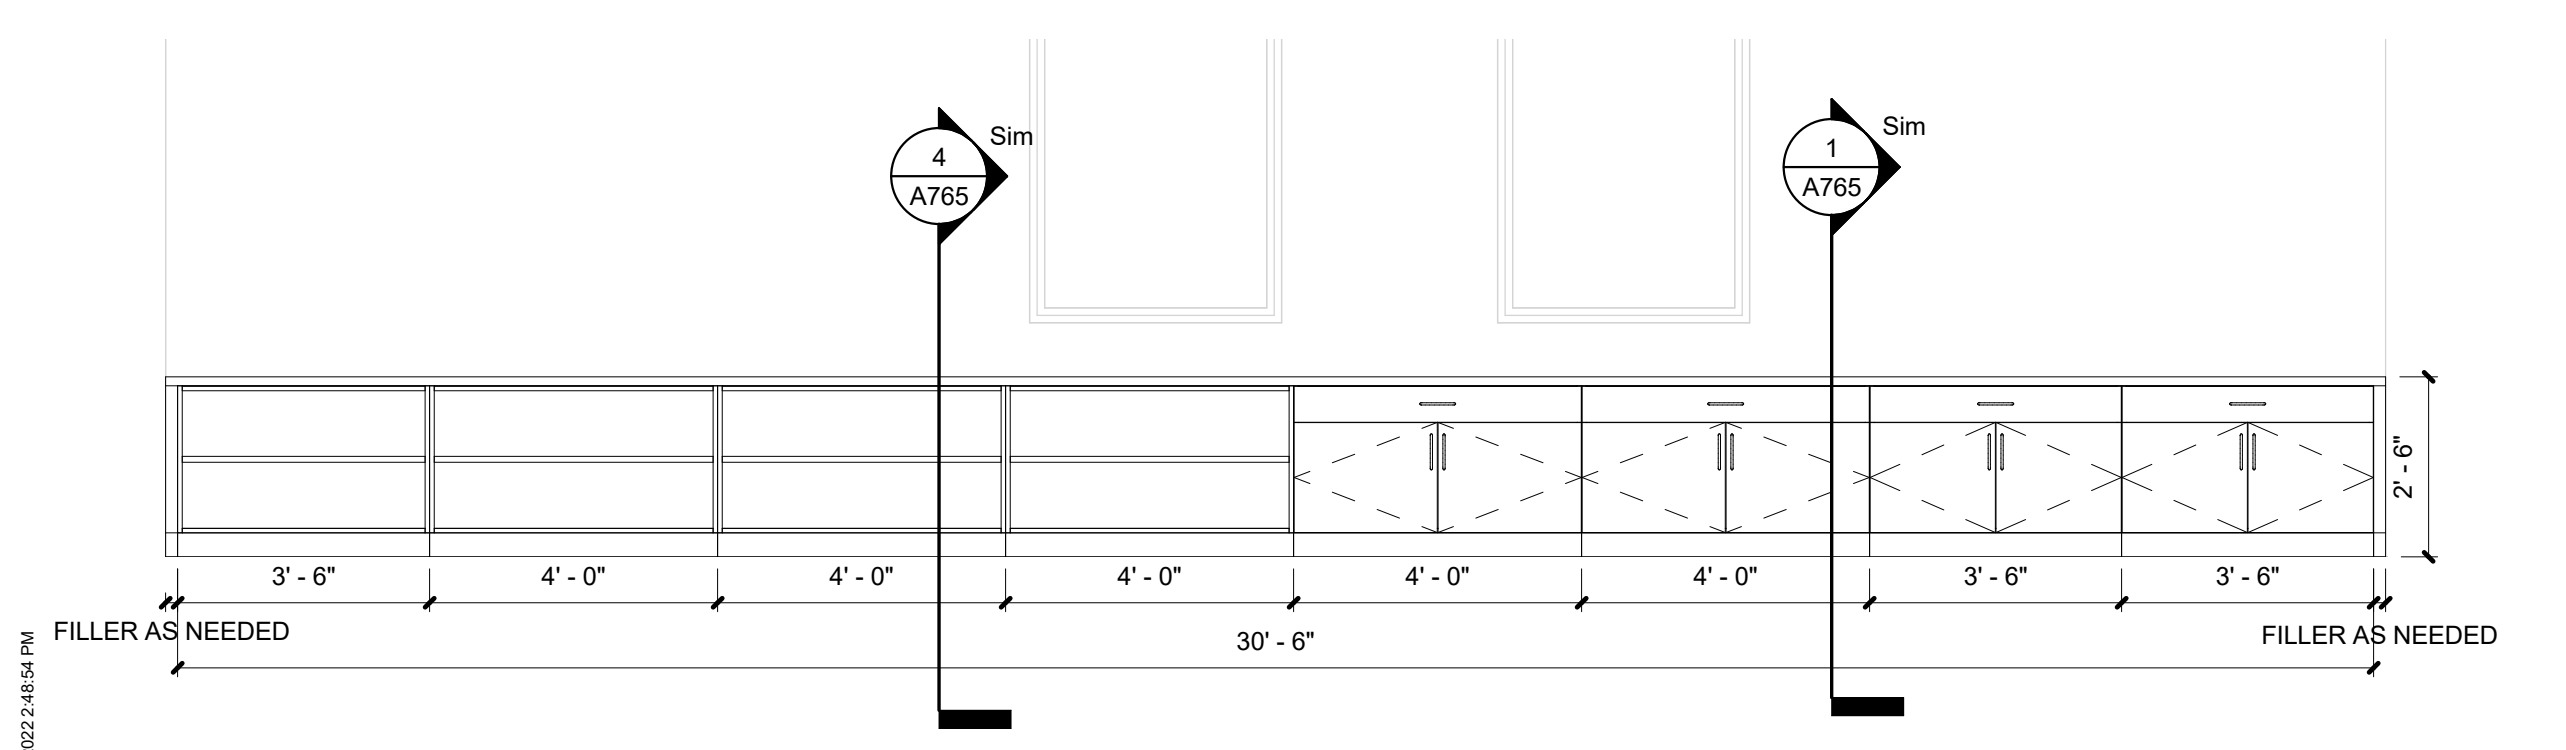


3 D32 CASEWORK ELEVATION - NORTH
SCALE: 3/8" = 1'-0" REF. 1 / A101C

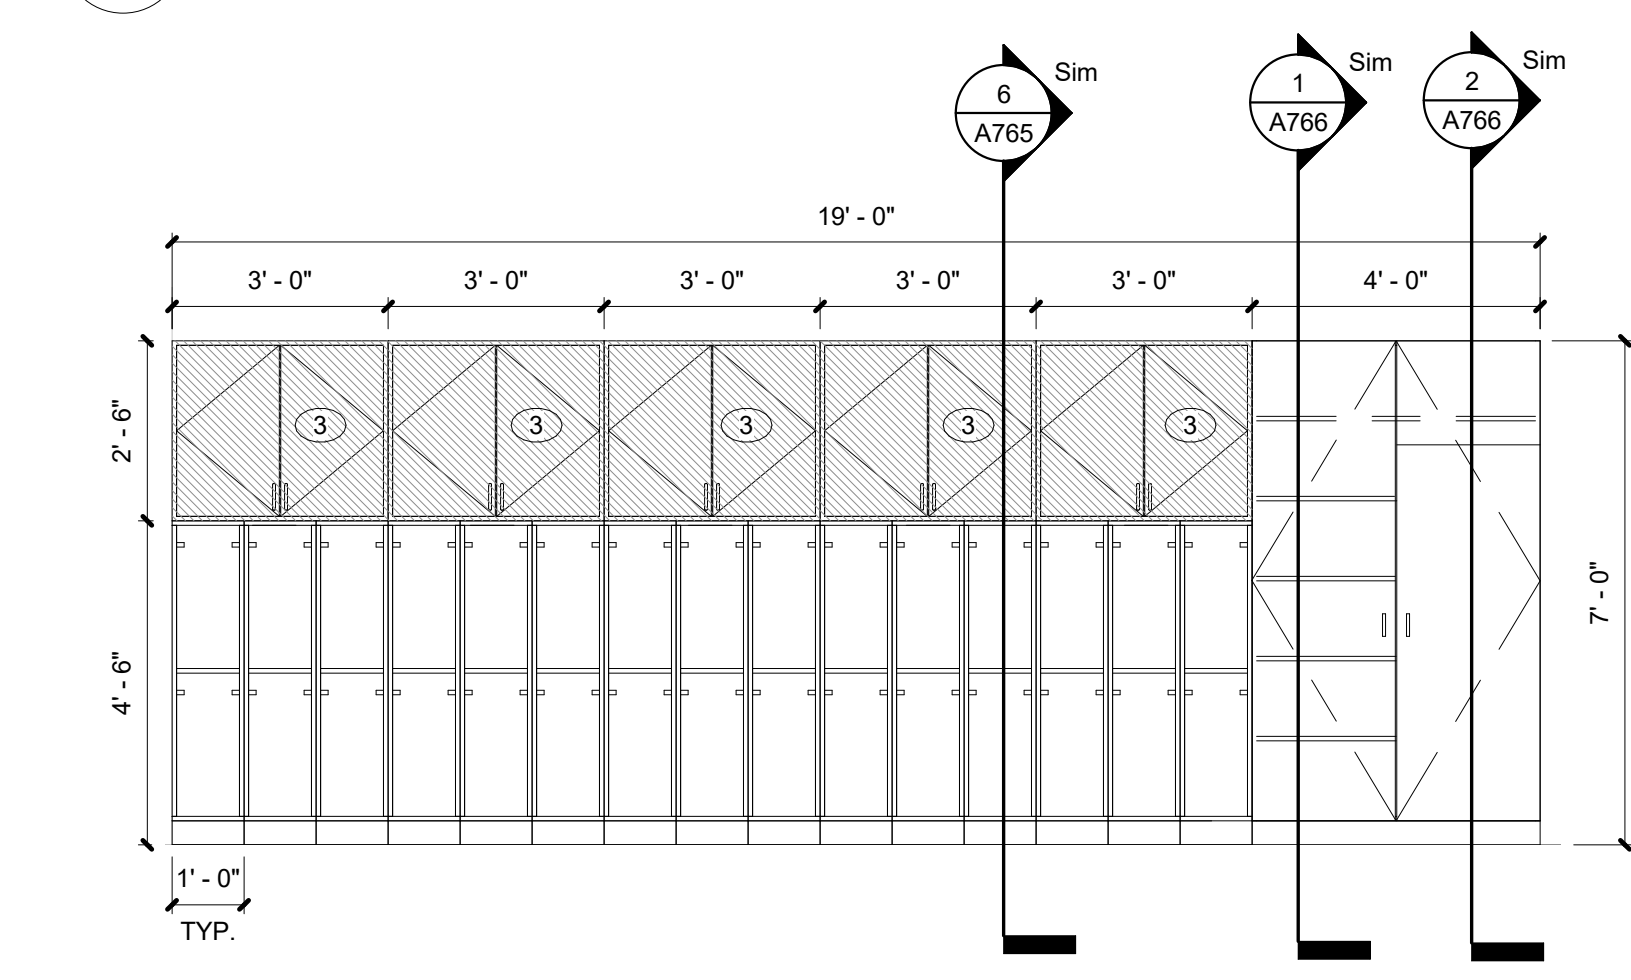

2 D32 CASEWORK ELEVATION - EAST
SCALE: 3/8" = 1'-0" REF. 1 / A101C

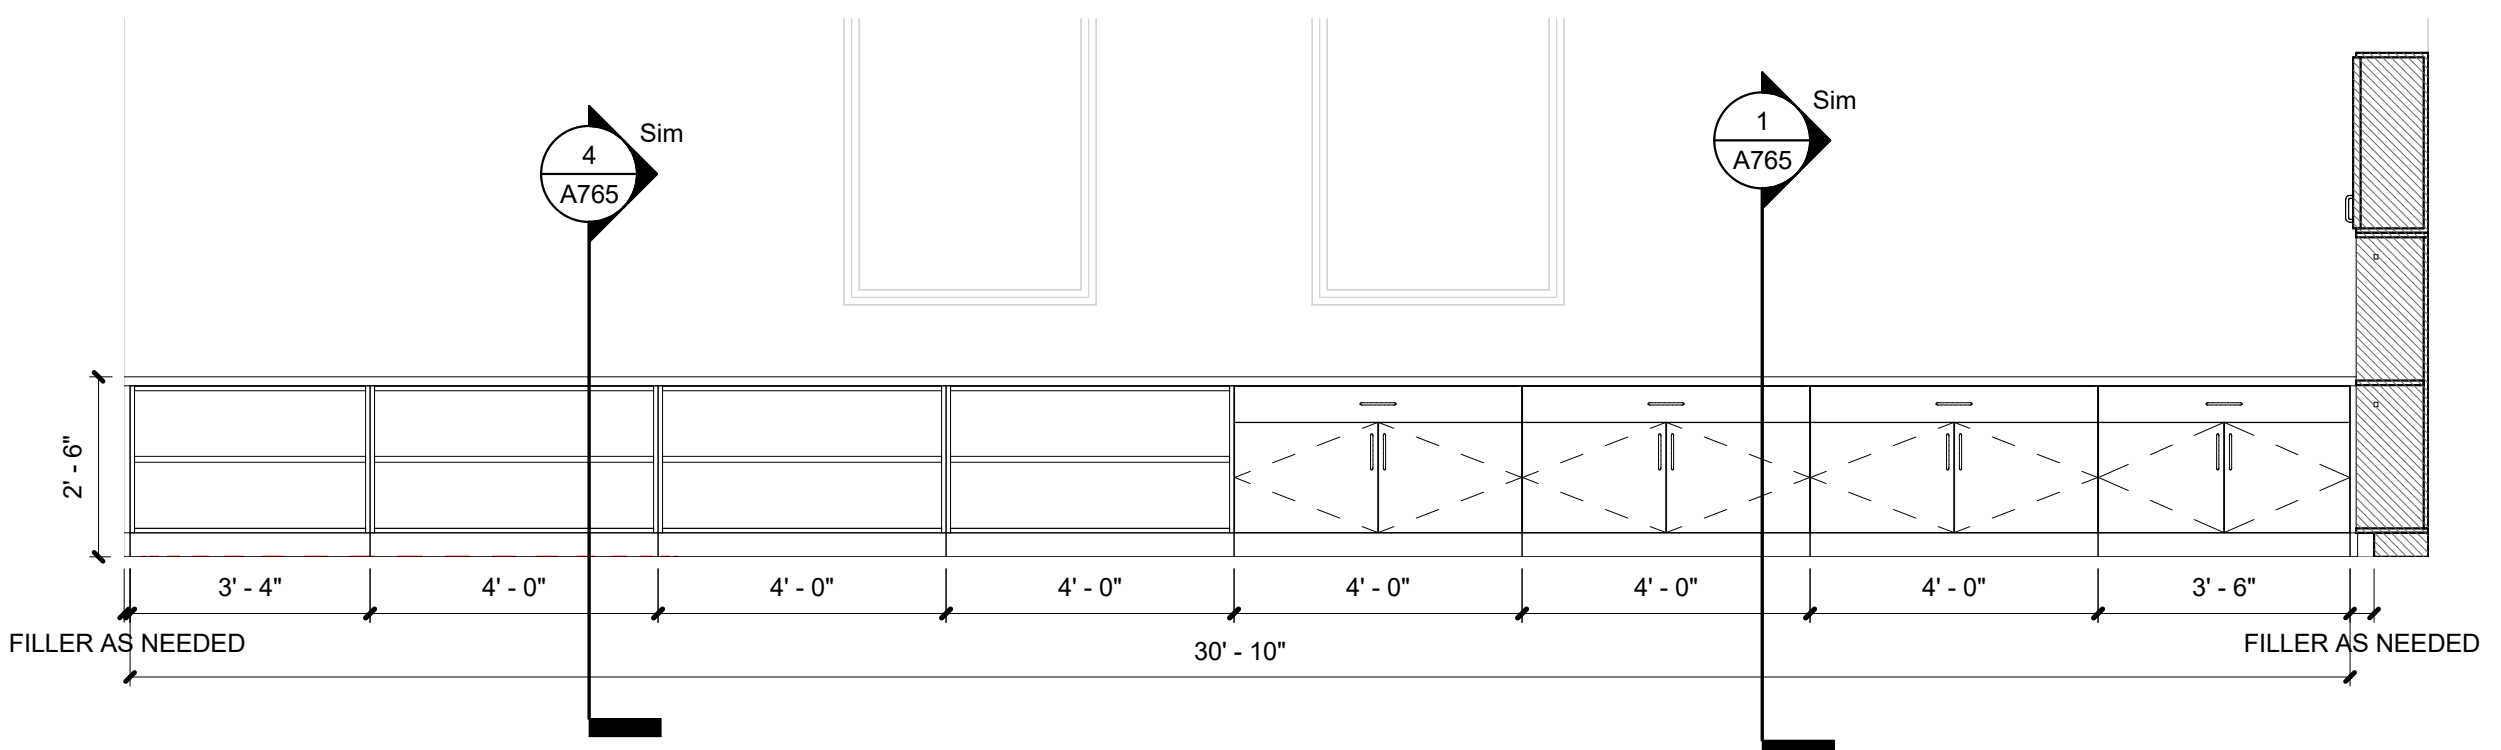

1 D33 CASEWORK ELEVATION - NORTH
SCALE: 3/8" = 1'-0" REF. 1 / A101A

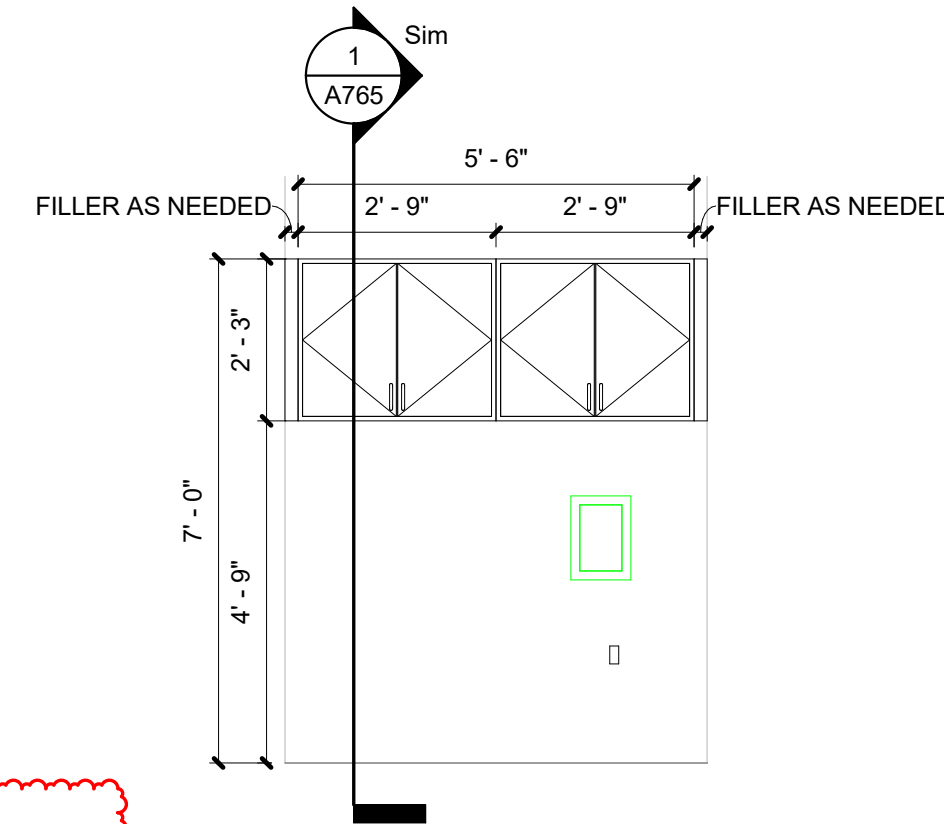


17 G38 CASEWORK ELEVATION - NORTH
SCALE: 3/8" = 1'-0" REF. 1 / A101A

ELEVATION NOTES - INTERIOR


- ACOUSTICAL PANELS (AP-1). REF FINISH LEGEND
- WALL TILE (WT-1). REF FINISH LEGEND
- UPPER CABINETS ABOVE CUBBIES AS ALTERNATE.
- WALL TILE 2 (WT-2). REF FINISH LEGEND
- ACOUSTICAL PANELS (AP-2). REF FINISH LEGEND
- ACOUSTICAL PANELS (AP-3). REF FINISH LEGEND
- 4" EPOXY BASE (EB-1). USE SCHLUTER JOLLY WHERE TILE AND EPOXY BASE MEET. REF FINISH LEGEND
- WALL TILE (WT-3). REF FINISH LEGEND
- HEAVY DUTY SHELVING WITH ADJUSTABLE BRACKETS ON TRACK SYSTEM. REF SPECS.
- ACOUSTICAL PANELS (AP-4). REF FINISH LEGEND
- WATERFALL SOLID SURFACE SS-1. REF FINISH LEGEND
- PROVIDE ACCENT PAINT (PT-2) AND RB-1 AT THIS LOCATION. REF FINISH LEGEND.
- PROVIDE PL-1 AT THIS LOCATION. REF FINISH LEGEND.

GENERAL CASEWORK NOTES


- FABRICATE WOODWORK/ MILLWORK ITEMS TO ACTUAL FIELD DIMENSIONS. CONTRACTOR SHALL SUBMIT FOR DESIGNERS APPROVALS SHOP DRAWING SAMPLES OR MANUFACTURERS LITERATURE FOR ALL ITEMS. SHOP DRAWINGS SHALL SHOW SUFFICIENT DETAIL TO DETERMINE COMPLIANCE WITH STANDARDS AND DESIGN INTENT.
- PROVIDE ALL NECESSARY FURRING AND GROUNDS FOR WOODWORK AND FINISH ITEMS. COORDINATE LOCATION OF BLOCKING WITHIN FRAMED WALLS AS NECESSARY FOR ITEMS TO BE SECURED TO SURFACE. ALL FASTENERS SHALL BE CONCEALED.
- FINISH ALL SIDES AND BACK OF MILLWORK/ CASEWORK
- PROVIDE GROMMETS IN COUNTERTOPS ABOVE ALL ELECTRICAL RECEPTALS AND TELEPHONE DATA ROUTINGS.
- ALL PULLS TO BE 4" SATIN NICKEL SOLID WIRE PULL.
- PROVIDE LOOKS FOR ALL STORAGE BASE CABINETS/ TALL STORAGE CABINETS. ALL DRAWERS AND DOORS, ALL UPPER WALL CABINETS AND ALL DISPLAY CASE SLIDING GLASS PANELS.
- ALL VERTICAL PLASTIC LAMINATE SURFACES AND SHELVES TO BE PL-1. ALL COUNTERTOPS THAT ARE PLASTIC LAMINATE TO BE PL-2 UNLESS OTHERWISE NOTED. REF FINISH LEGEND.
- ALL INTERIORS BEHIND DOORS/ DRAWERS AND NOT VISIBLE SHALL BE WHITE.
- ALL NEW SOLID SURFACE COUNTERTOPS TO BE SS-1. SOLID SURFACE COUNTERS LOCATED AT SINKS. REF FLOOR PLAN AND FINISH LEGEND.
- SEE ELEC. DWGS FOR ELECTRICAL DEVICES.
- VERIFY ALL DIMENSIONS IN FIELD AND PROVIDE COMPLETE SHOP DRAWINGS.
- PROVIDE BLIND CORNER BASE AND UPPER CABINETS - TYPICAL.

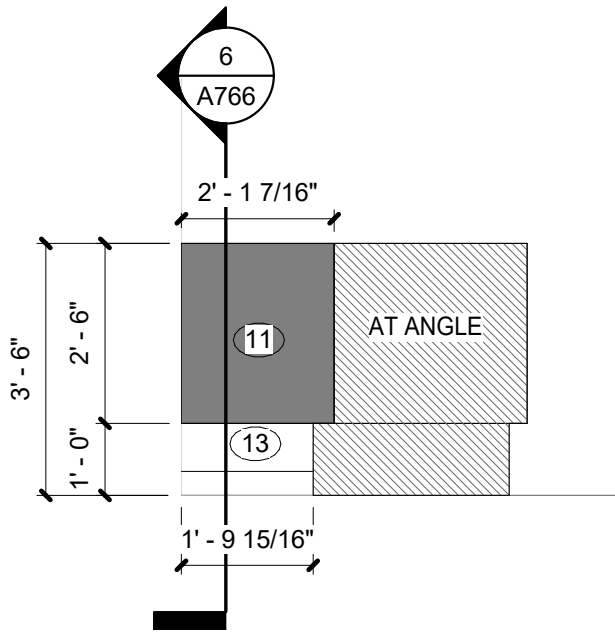


16 MEDIA CIRCULATION - SOUTH
SCALE: 3/8" = 1'-0" REF. 1 / A101A

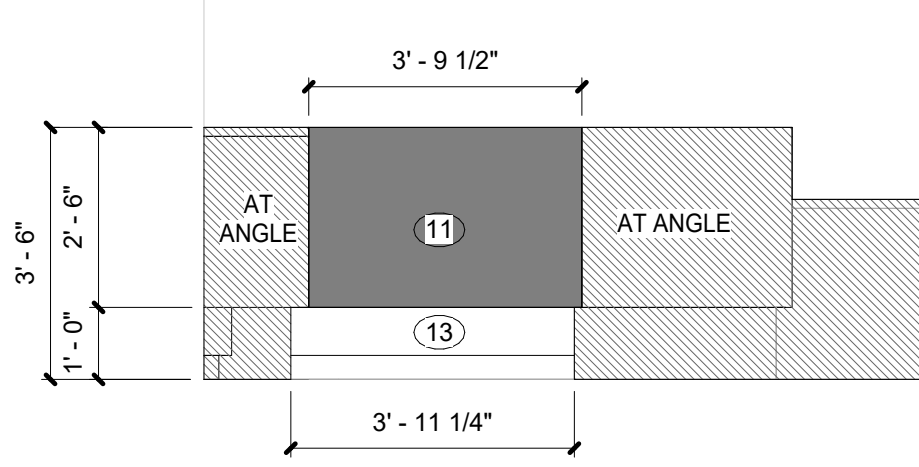


15 MEDIA CIRCULATION - SOUTHEAST
SCALE: 3/8" = 1'-0" REF. 1 / A101A

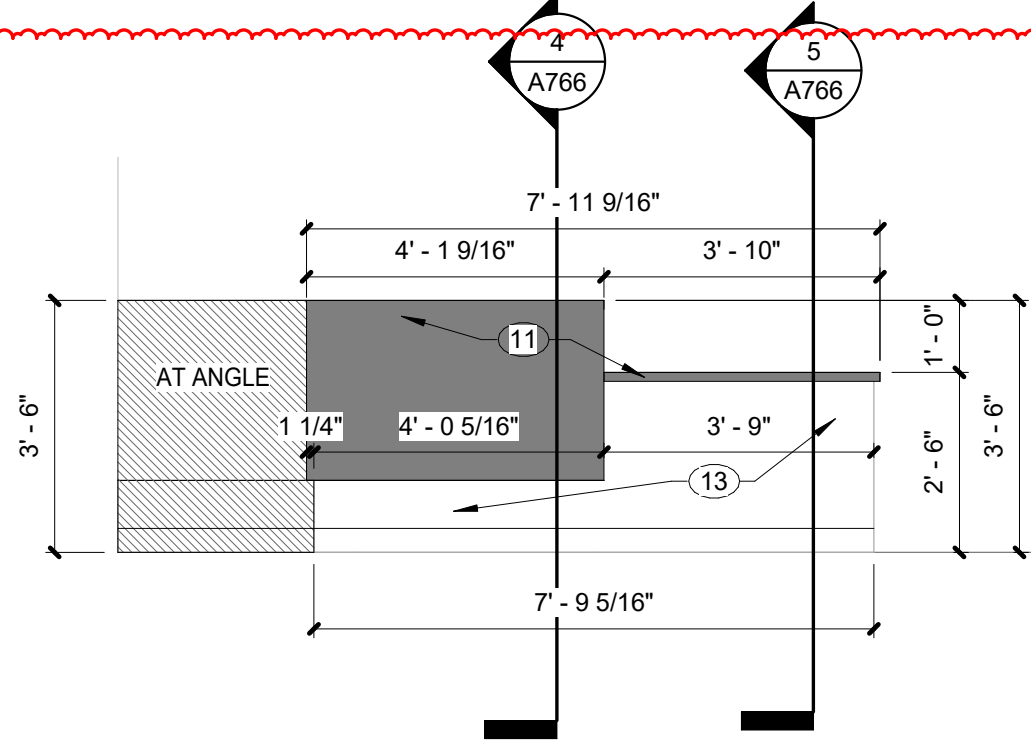


14 MEDIA CIRCULATION - EAST
SCALE: 3/8" = 1'-0" REF. 1 / A101A

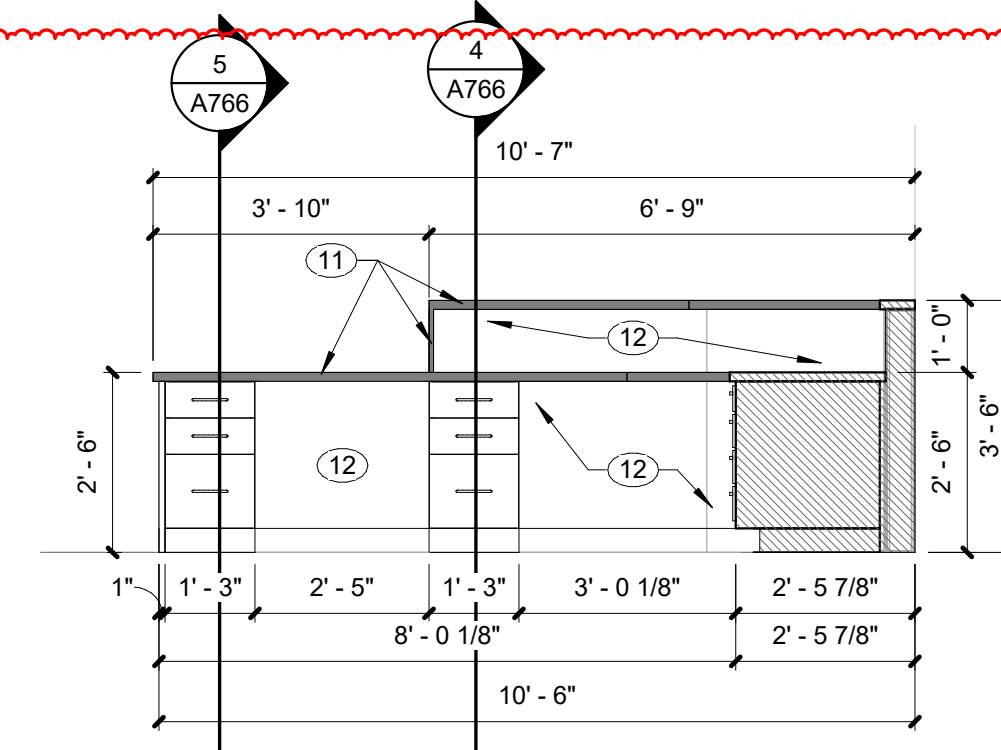


13 MEDIA CIRCULATION - WEST
SCALE: 3/8" = 1'-0" REF. 1 / A101A

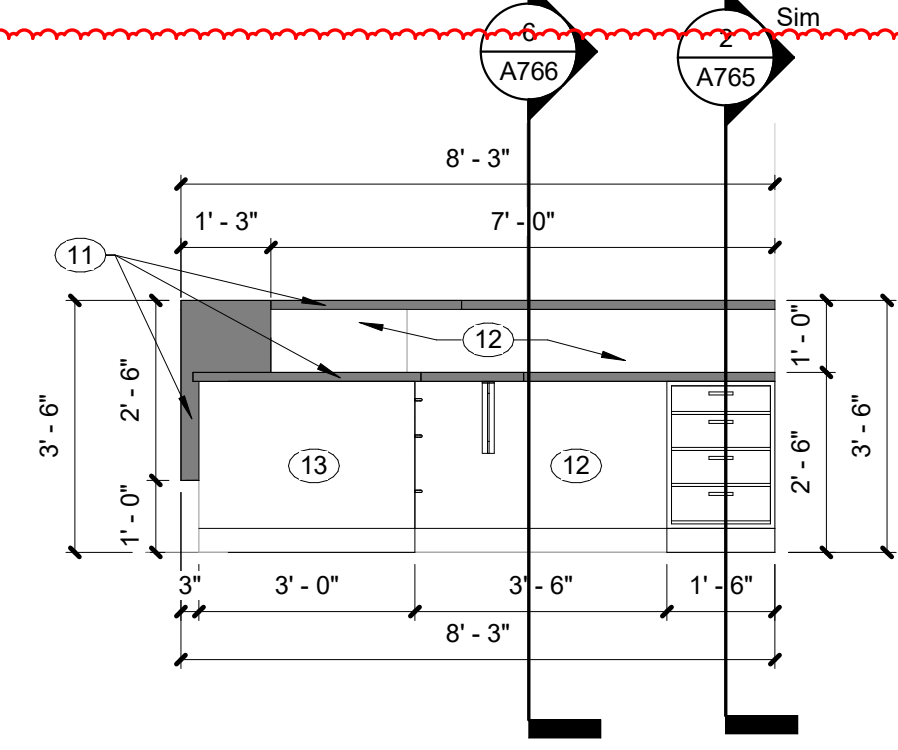


12 MEDIA CIRCULATION - NORTH
SCALE: 3/8" = 1'-0" REF. 1 / A101A

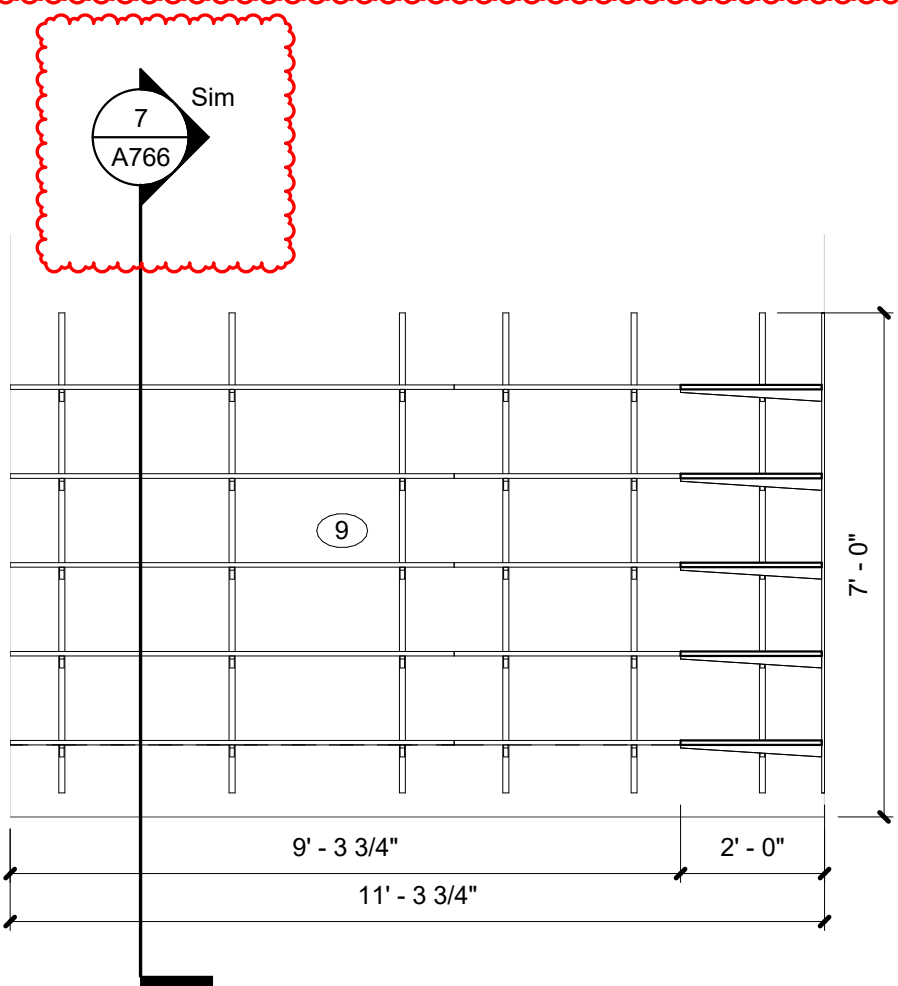


11 B14.1 CASEWORK ELEVATION - WEST
SCALE: 3/8" = 1'-0" REF. 1 / A101B

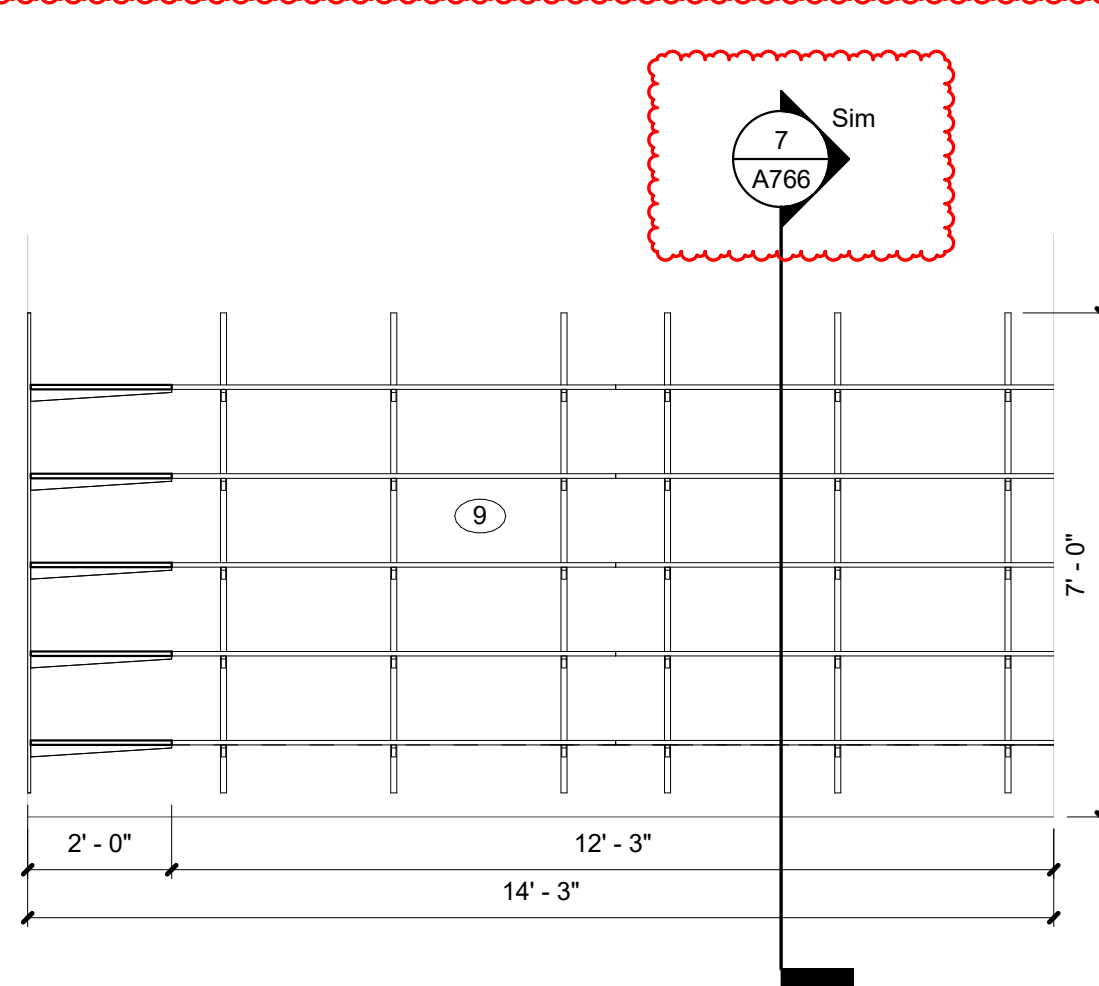


10 B14.1 CASEWORK ELEVATION - NORTH
SCALE: 3/8" = 1'-0" REF. 1 / A101B

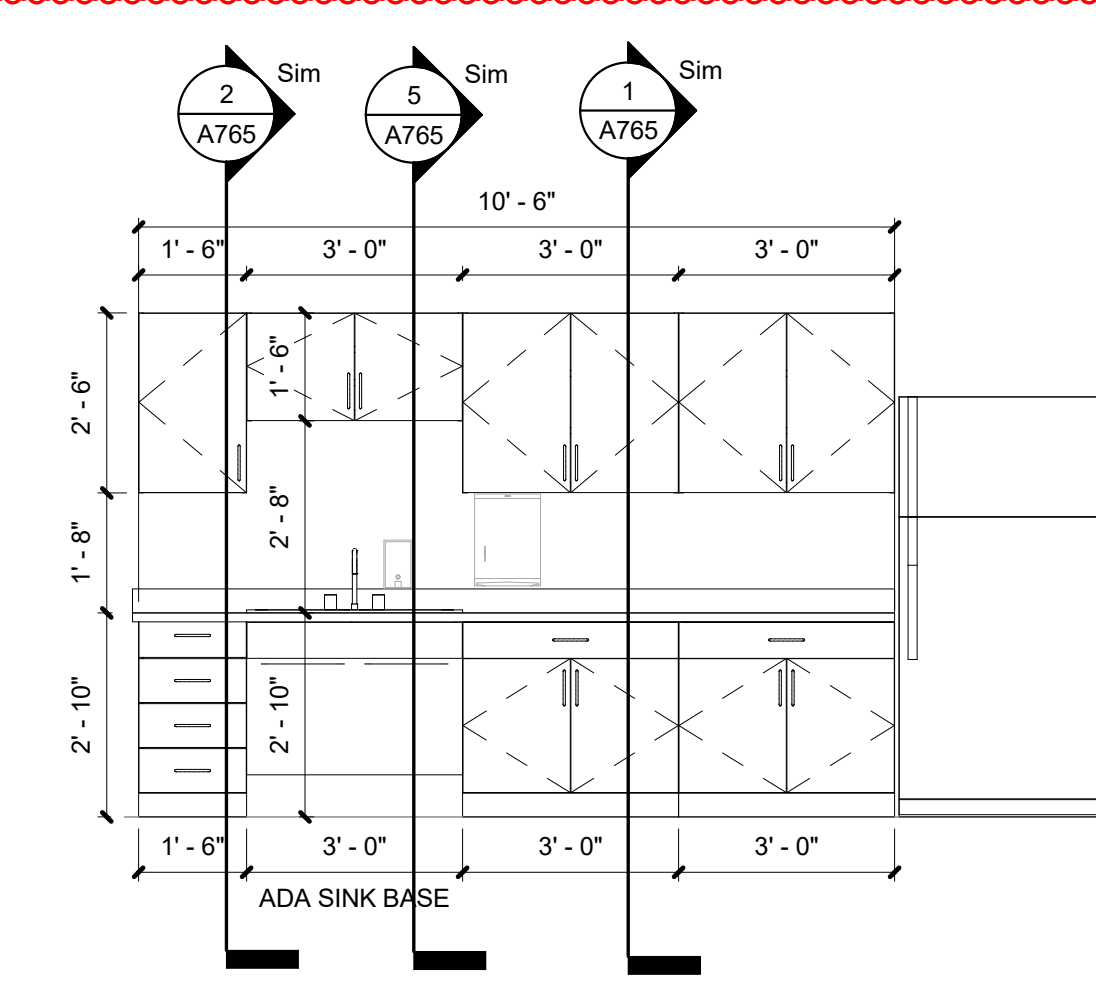


9 G15 CASEWORK ELEVATION - WEST
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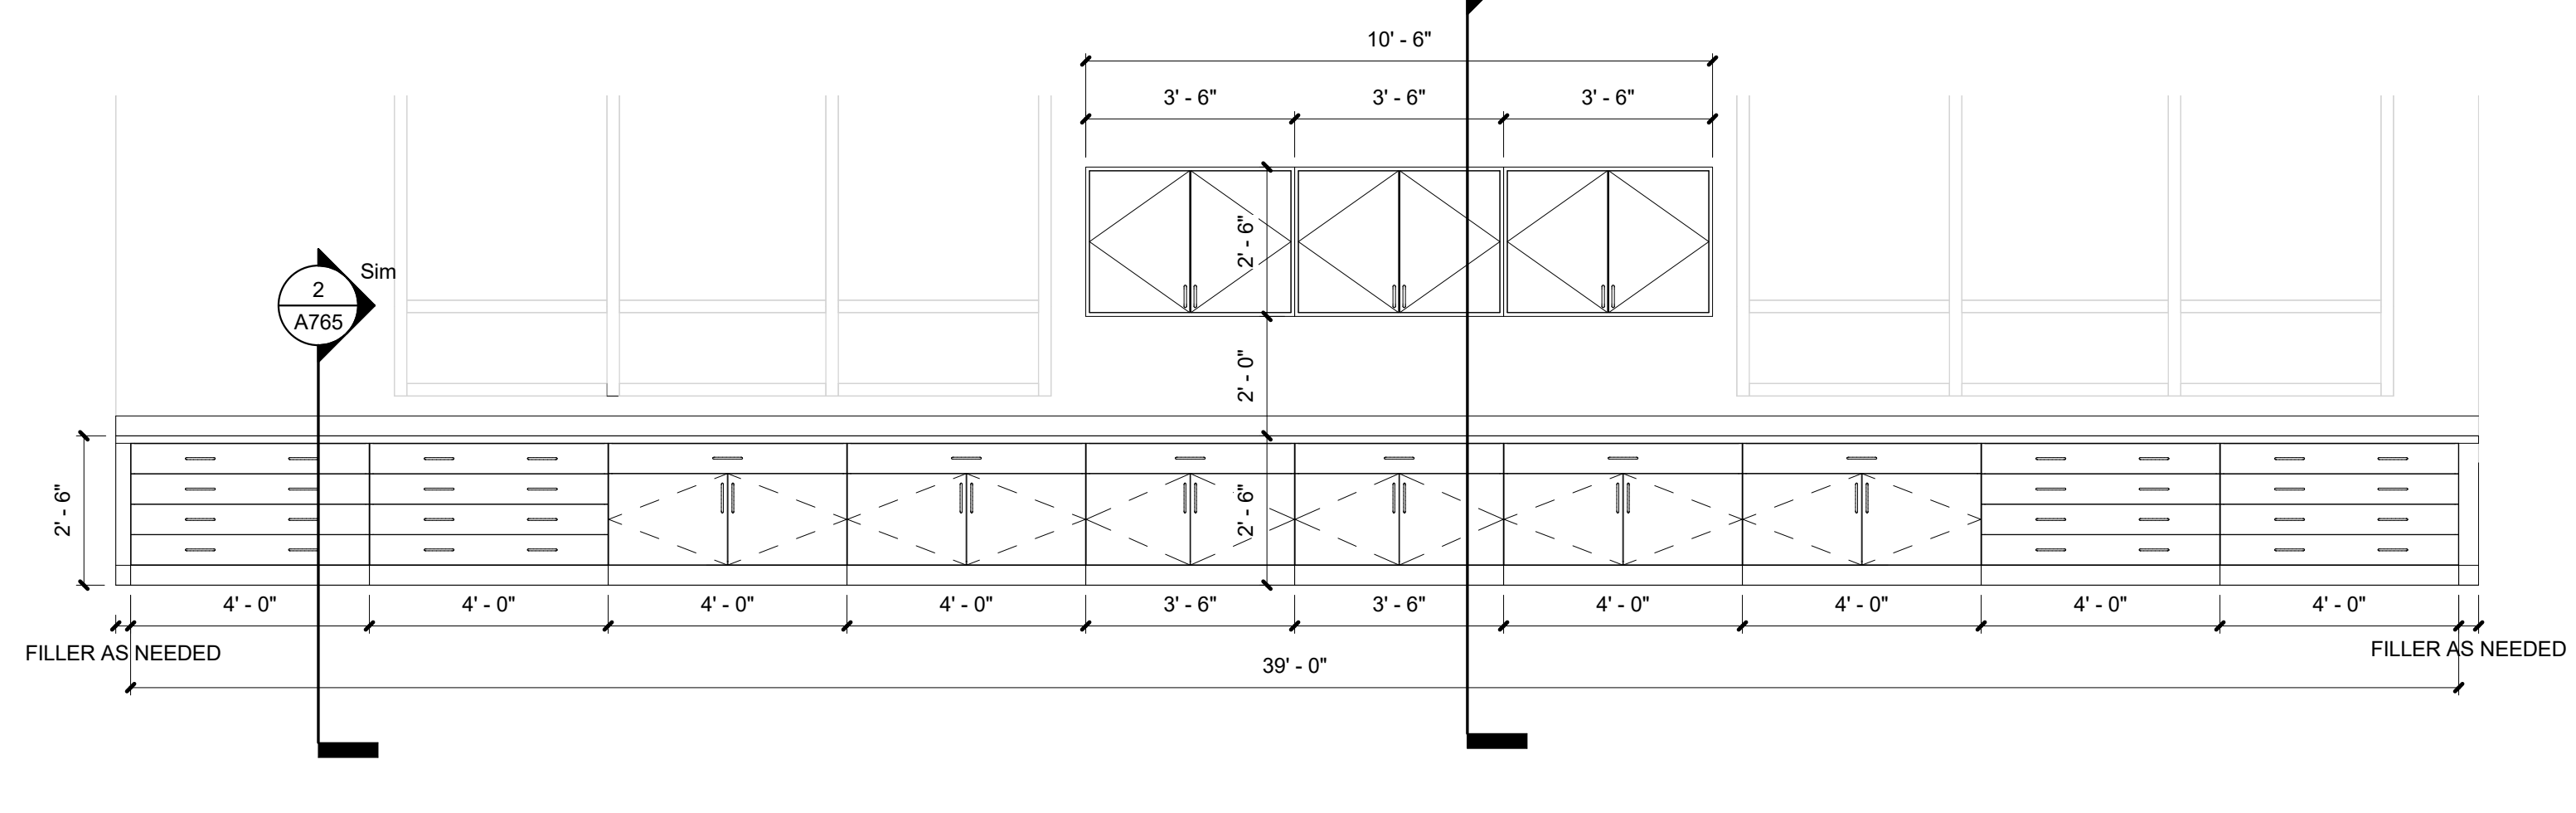
8 G15 CASEWORK ELEVATION - EAST
SCALE: 3/8" = 1'-0" REF. 1 / A101A

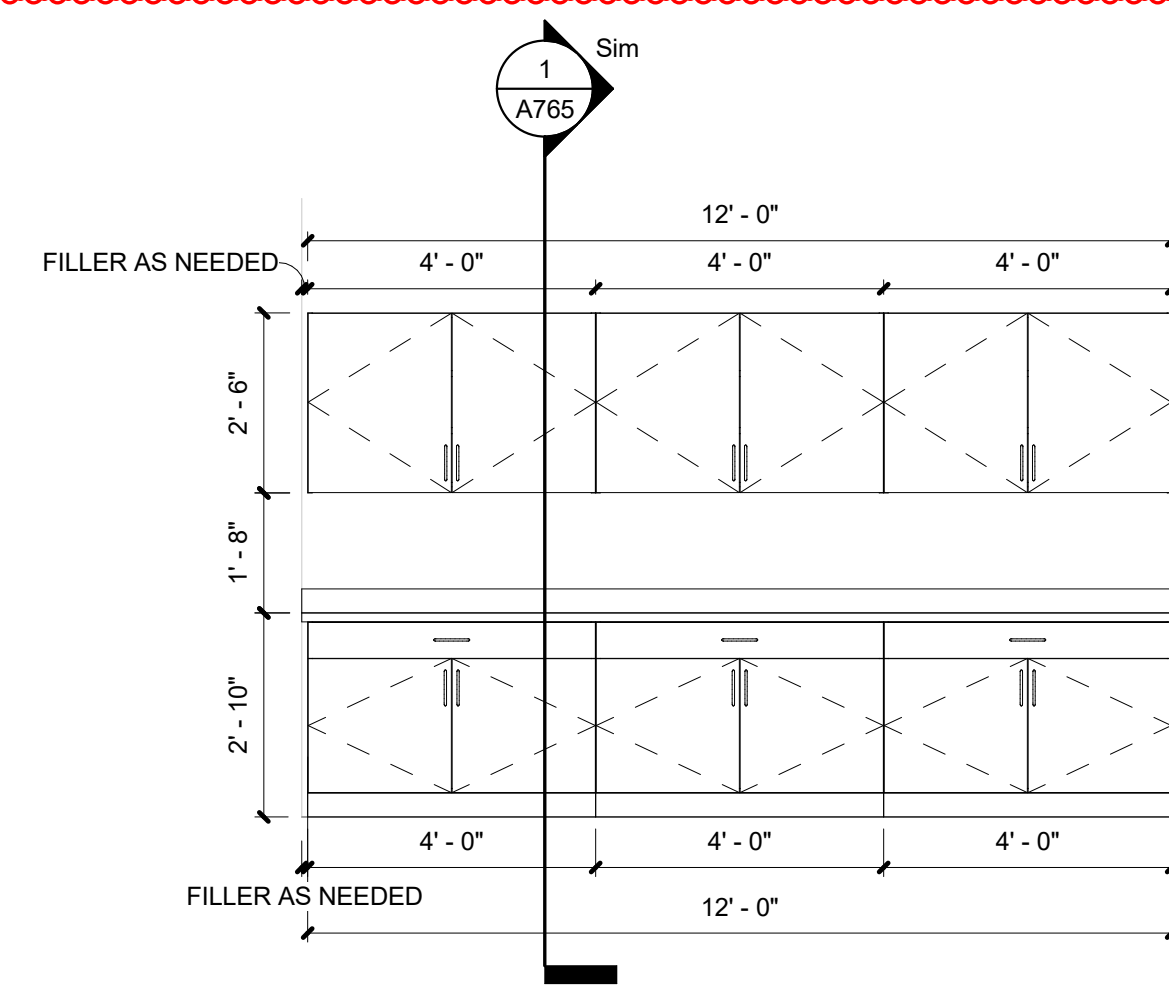


7 A1.2 CASEWORK ELEVATION - SOUTH
SCALE: 3/8" = 1'-0" REF. 1 / A101B

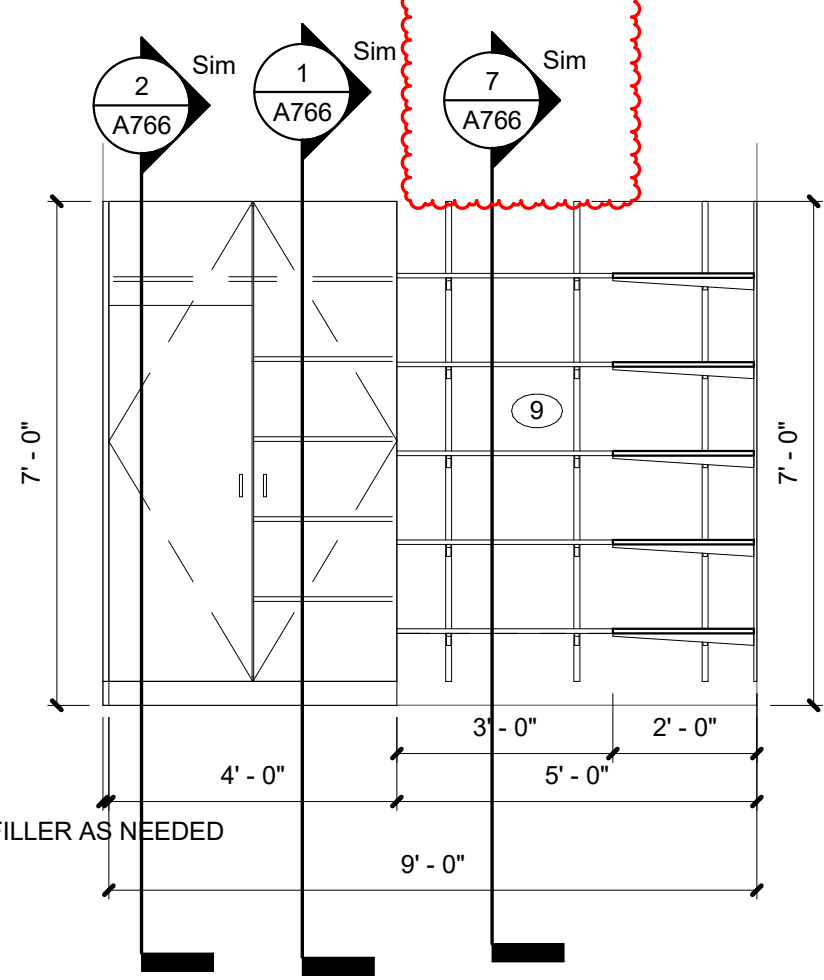


6 A1.2 CASEWORK ELEVATION - WEST
SCALE: 3/8" = 1'-0" REF. 1 / A101B

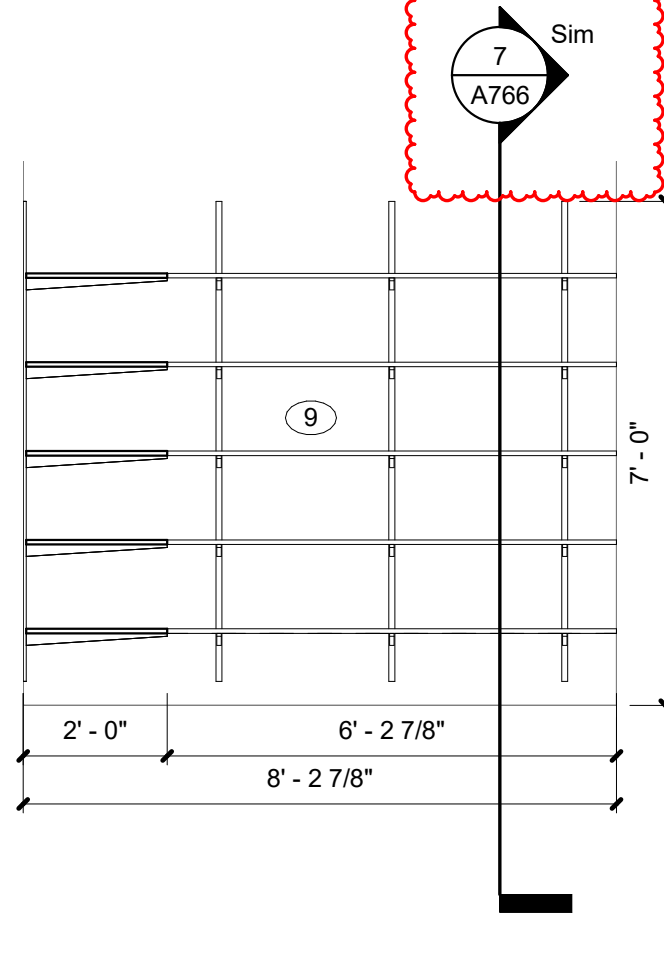


5 A1 CASEWORK ELEVATION - EAST
SCALE: 3/8" = 1'-0" REF. 1 / A101A

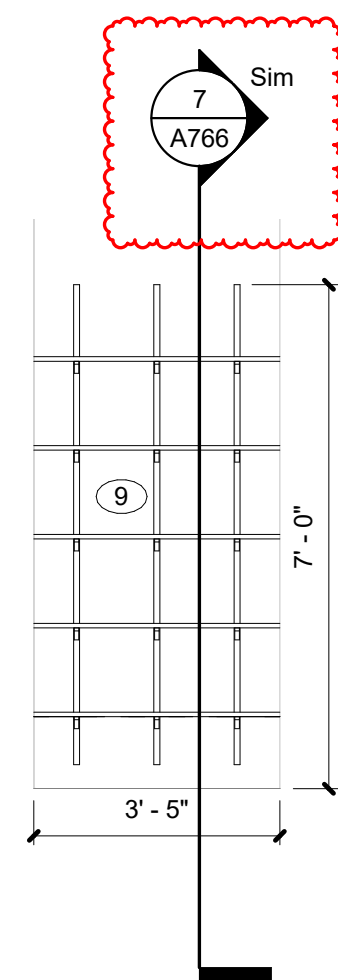


4 A1 CASEWORK ELEVATION - SOUTH
SCALE: 3/8" = 1'-0" REF. 1 / A101B

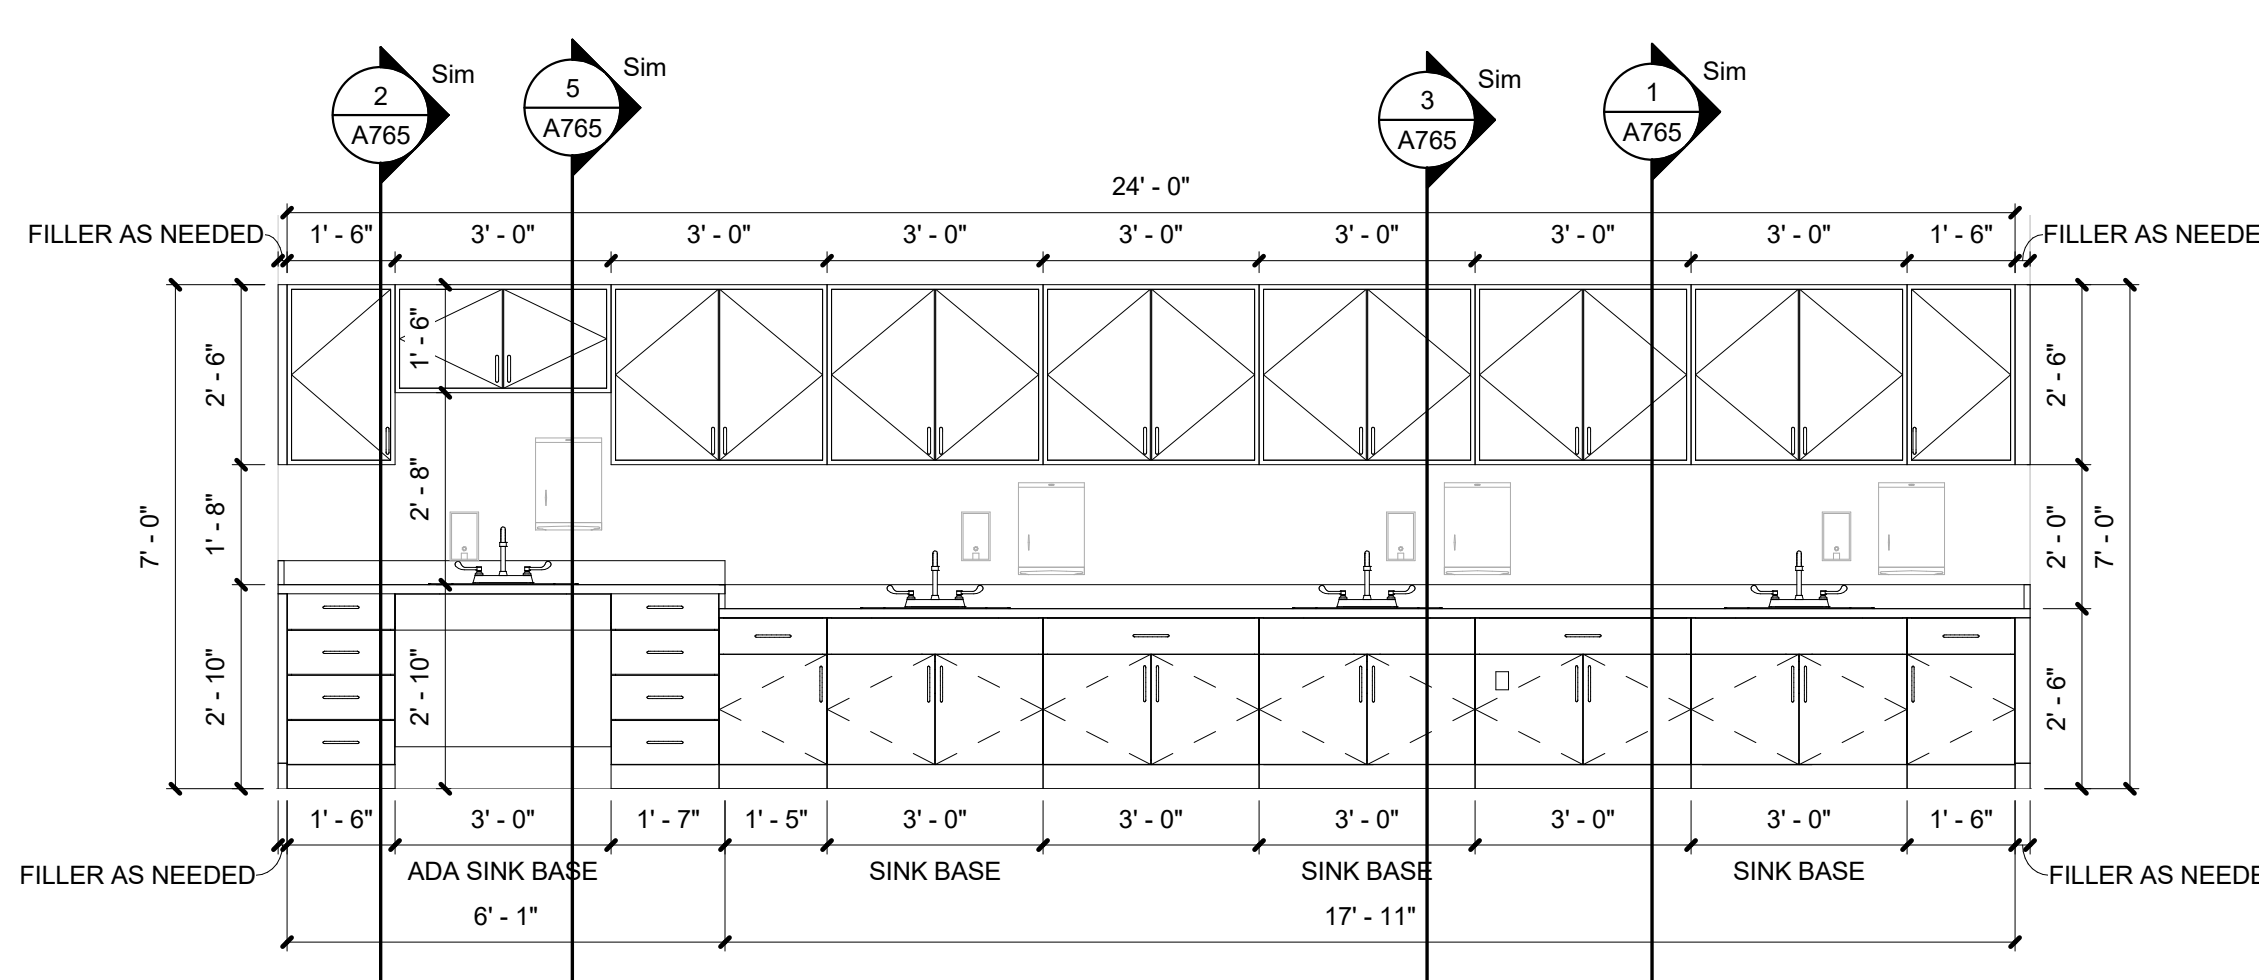

3 A1 CASEWORK ELEVATION - WEST
SCALE: 3/8" = 1'-0" REF. 1 / A101A

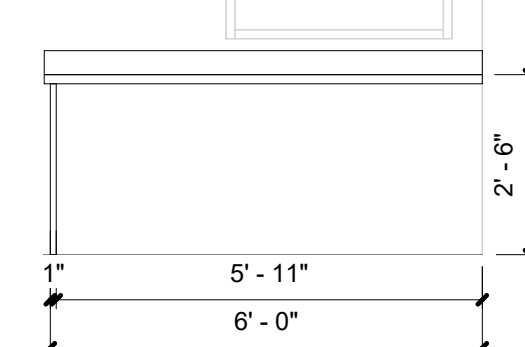

2 RECEPTION CASEWORK ELEVATION - NORTH
SCALE: 3/8" = 1'-0" REF. 1 / A101A

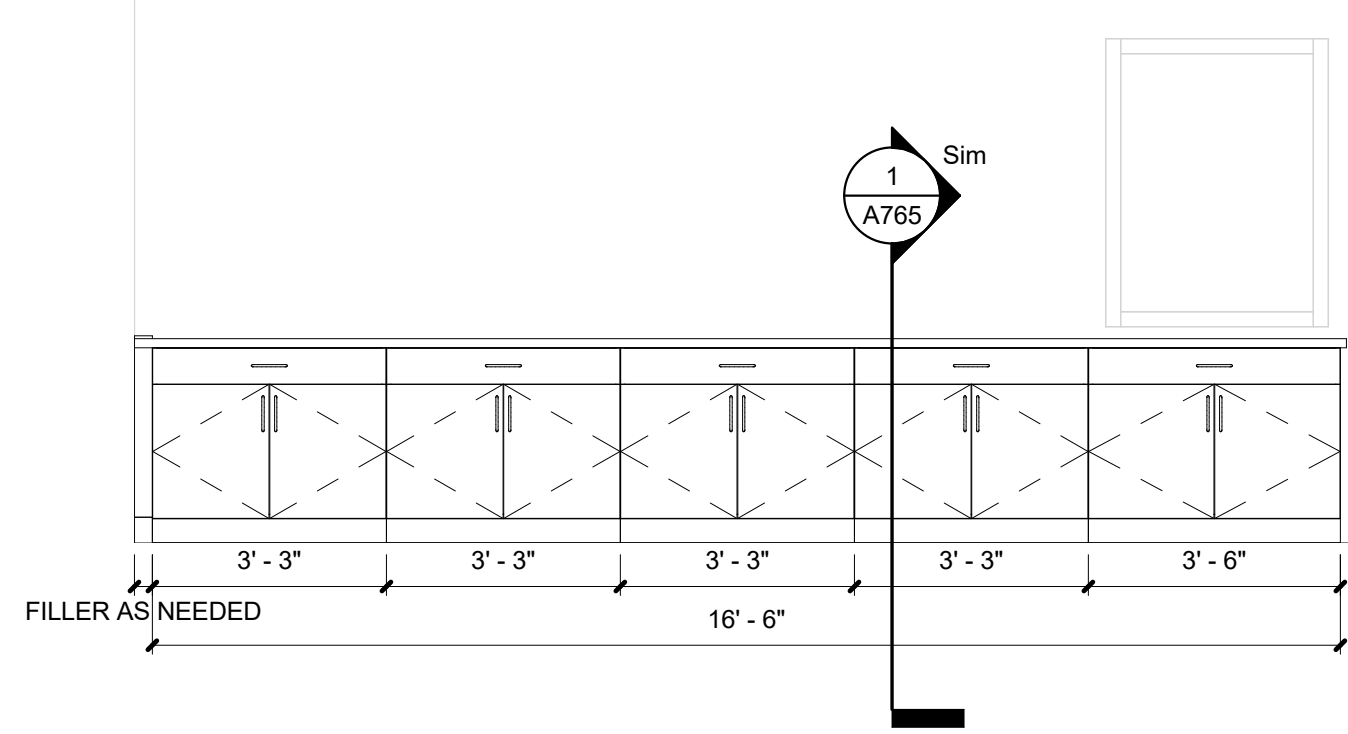









1 RECEPTION CASEWORK ELEVATION - SOUTH
SCALE: 3/8" = 1'-0" REF. 1 / A101A

ELEVATION NOTES - INTERIOR

1. ACOUSTICAL PANELS (AP-1), REF FINISH LEGEND
2. WALL TILE 1 (WT-1), REF FINISH LEGEND
3. UPPER CABINETS ABOVE CUBBIES AS ALTERNATE.
4. WALL TILE 2 (WT-2), REF FINISH LEGEND
5. ACOUSTICAL PANELS (AP-2), REF FINISH LEGEND
6. ACOUSTICAL PANELS (AP-3), REF FINISH LEGEND
7. 4" EPOXY BASE (EB-1), USE SCHLUTER JOLLY WHERE TILE AND EPOXY BASE MEET, REF FINISH LEGEND
8. WALL TILE (WT-3), REF FINISH LEGEND
9. HEAVY DUTY SHELVING WITH ADJUSTABLE BRACKETS ON TRACK SYSTEM, REF SPECS.
10. ACOUSTICAL PANELS (AP-4), REF FINISH LEGEND
11. WATERFALL SOLID SURFACE SS-1, REF FINISH LEGEND.
12. PROVIDE ACCENT PAINT (PT-2) AND RB-1 AT THIS LOCATION, REF FINISH LEGEND.
13. PROVIDE PL-1 AT THIS LOCATION, REF FINISH LEGEND.

GENERAL CASEWORK NOTES

1. FABRICATE WOODWORK/ MILLWORK ITEMS TO ACTUAL FIELD DIMENSIONS. CONTRACTOR SHALL SUBMIT FOR DESIGNERS APPROVALS SHOP DRAWING SAMPLES OR MANUFACTURER'S LITERATURE FOR ALL ITEMS. SHOP DRAWINGS SHALL SHOW SUFFICIENT DETAIL TO DETERMINE COMPLIANCE WITH STANDARDS AND DESIGN INTENT.
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3. FINISH ALL SIDES AND BACK OF MILLWORK/ CASEWORK
4. PROVIDE GROMMETS IN COUNTERTOPS ABOVE ALL ELECTRICAL RECPETICALS AND TELEPHONE DATA ROUTINGS.
5. ALL PULLS TO BE 4" SATIN NICKEL SOLID WIRE PULL.
6. PROVIDE LOOKS FOR ALL STORAGE BASE CABINETS/ TALL STORAGE CABINETS. ALL DRAWERS AND DOORS, ALL UPPER WALL CABINETS AND ALL DISPLAY CASE SLIDING GLASS PANELS.
7. ALL VERTICAL PLASTIC LAMINATE SURFACES AND SHELVES TO BE PL-1. ALL COUNTERTOPS THAT ARE PLASTIC LAMINATE TO BE PL-2 UNLESS OTHERWISE NOTED. REF FINISH LEGEND.
8. ALL INTERIORS BEHIND DOORS/ DRAWERS AND NOT VISIBLE SHALL BE WHITE.
9. ALL NEW SOLID SURFACE COUNTERTOPS TO BE SS-1. SOLID SURFACE COUNTERS LOCATED AT SINKS, REF FLOOR PLAN AND FINISH LEGEND.
10. SEE ELEC. DWGS FOR ELECTRICAL DEVICES.
11. VERIFY ALL DIMENSIONS IN FIELD AND PROVIDE COMPLETE SHOP DRAWINGS.
12. PROVIDE BLIND CORNER BASE AND UPPER CABINETS - TYPICAL.

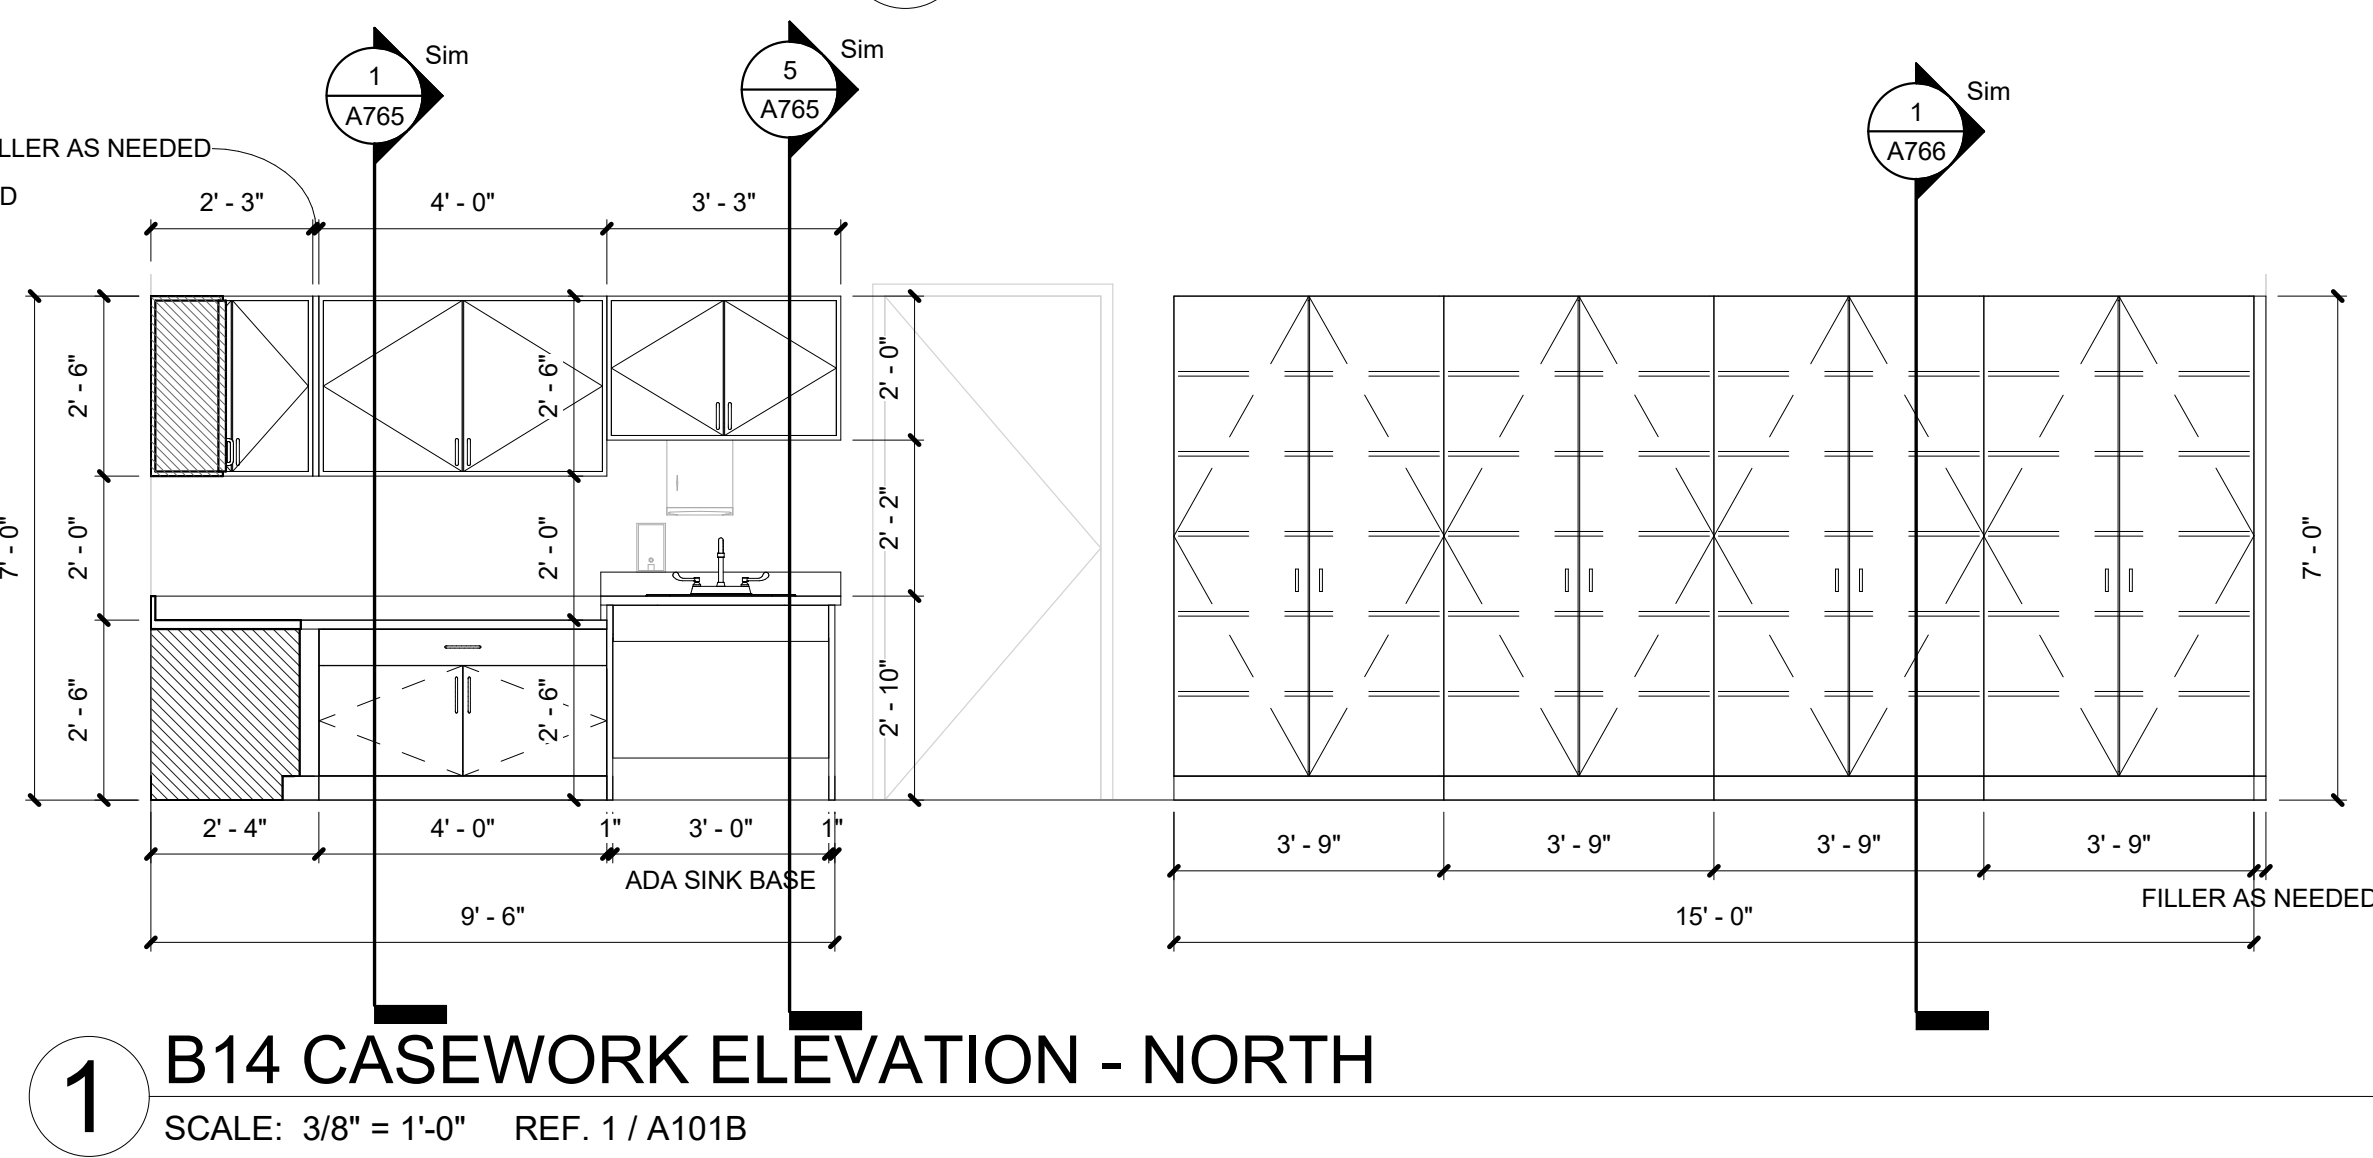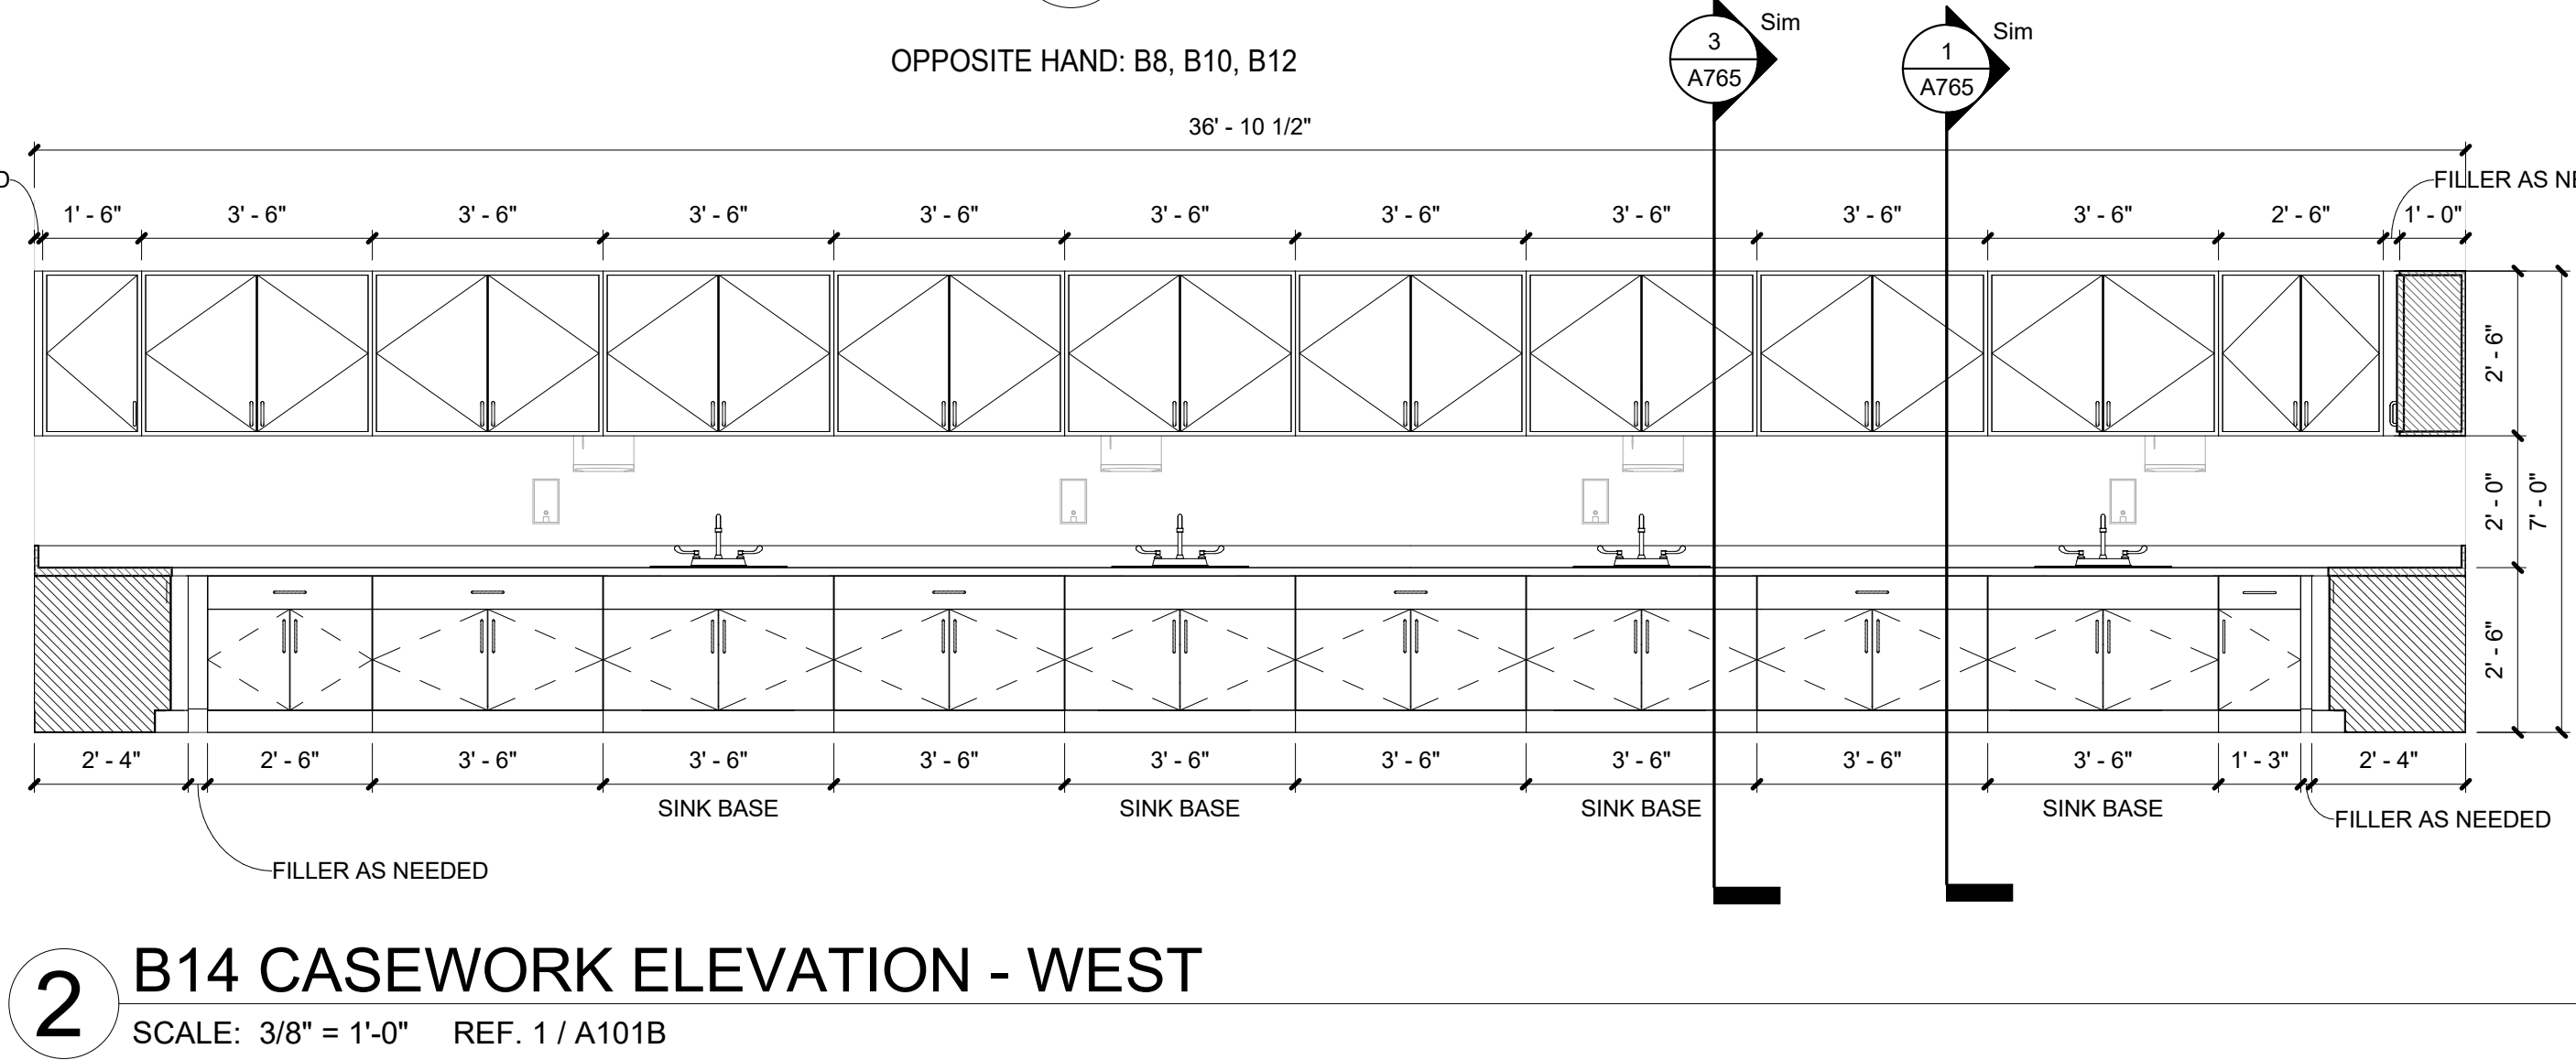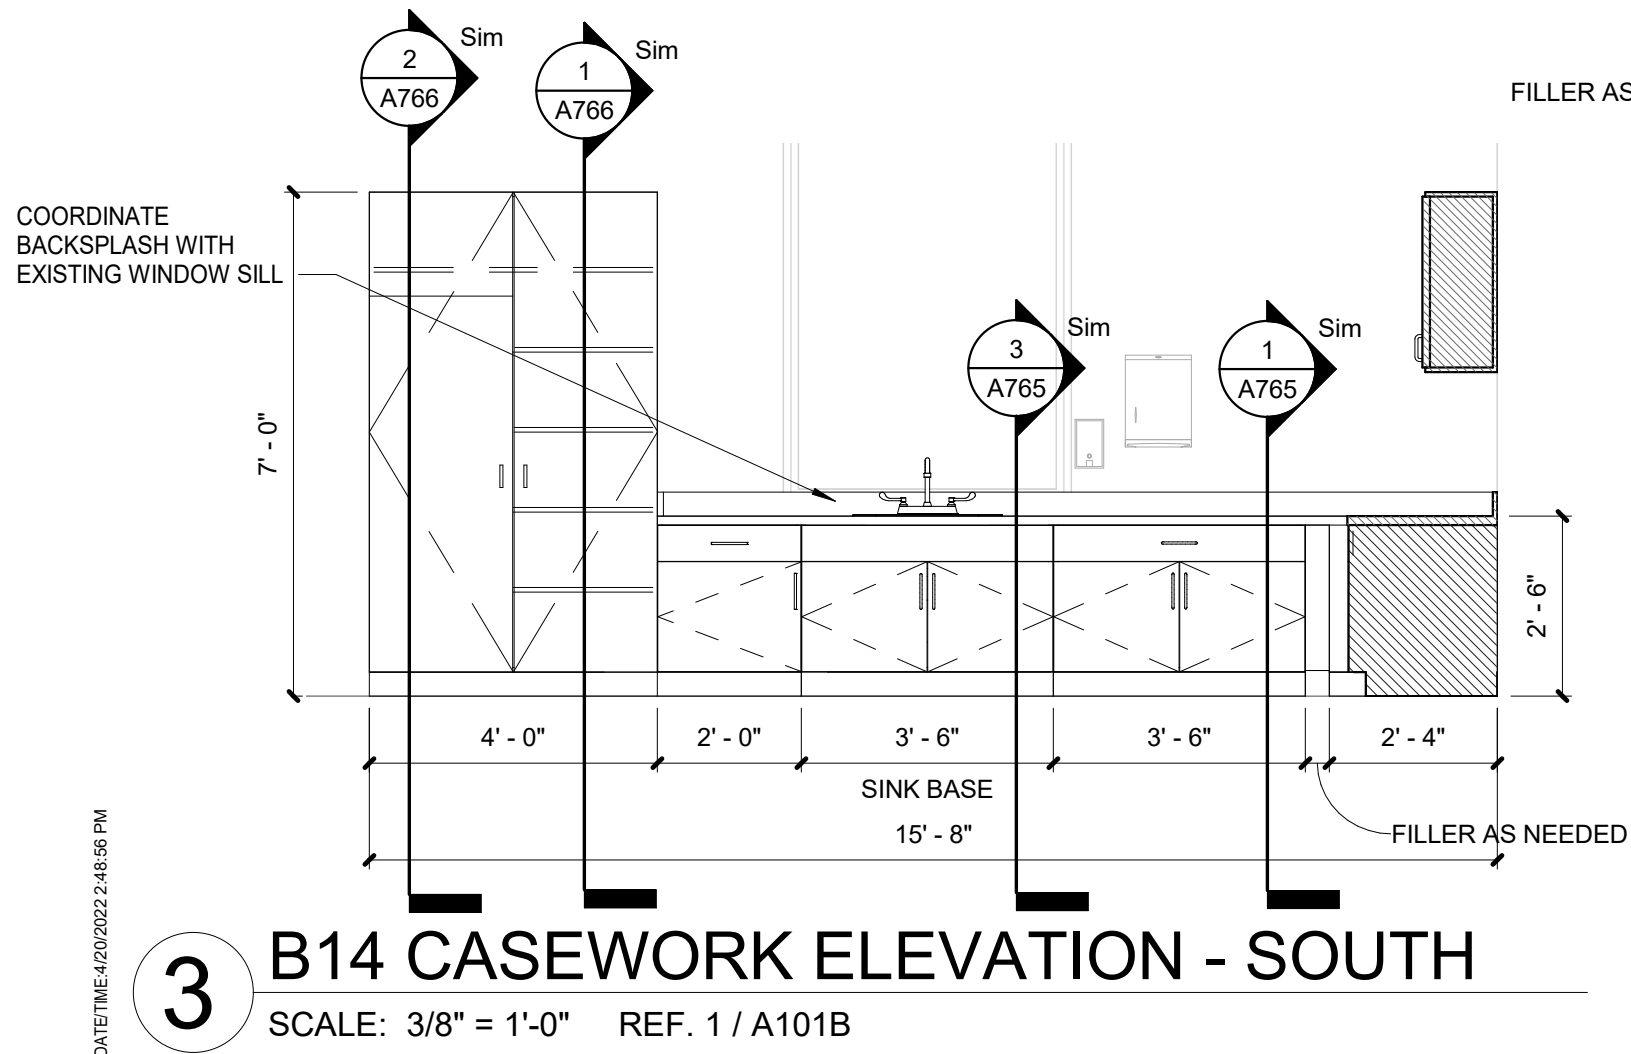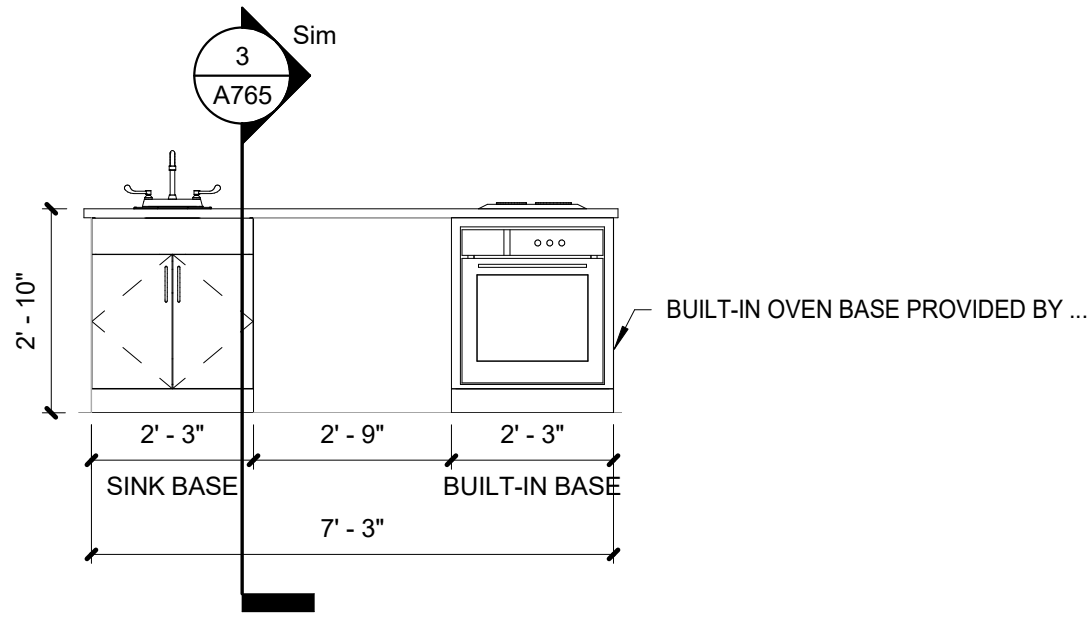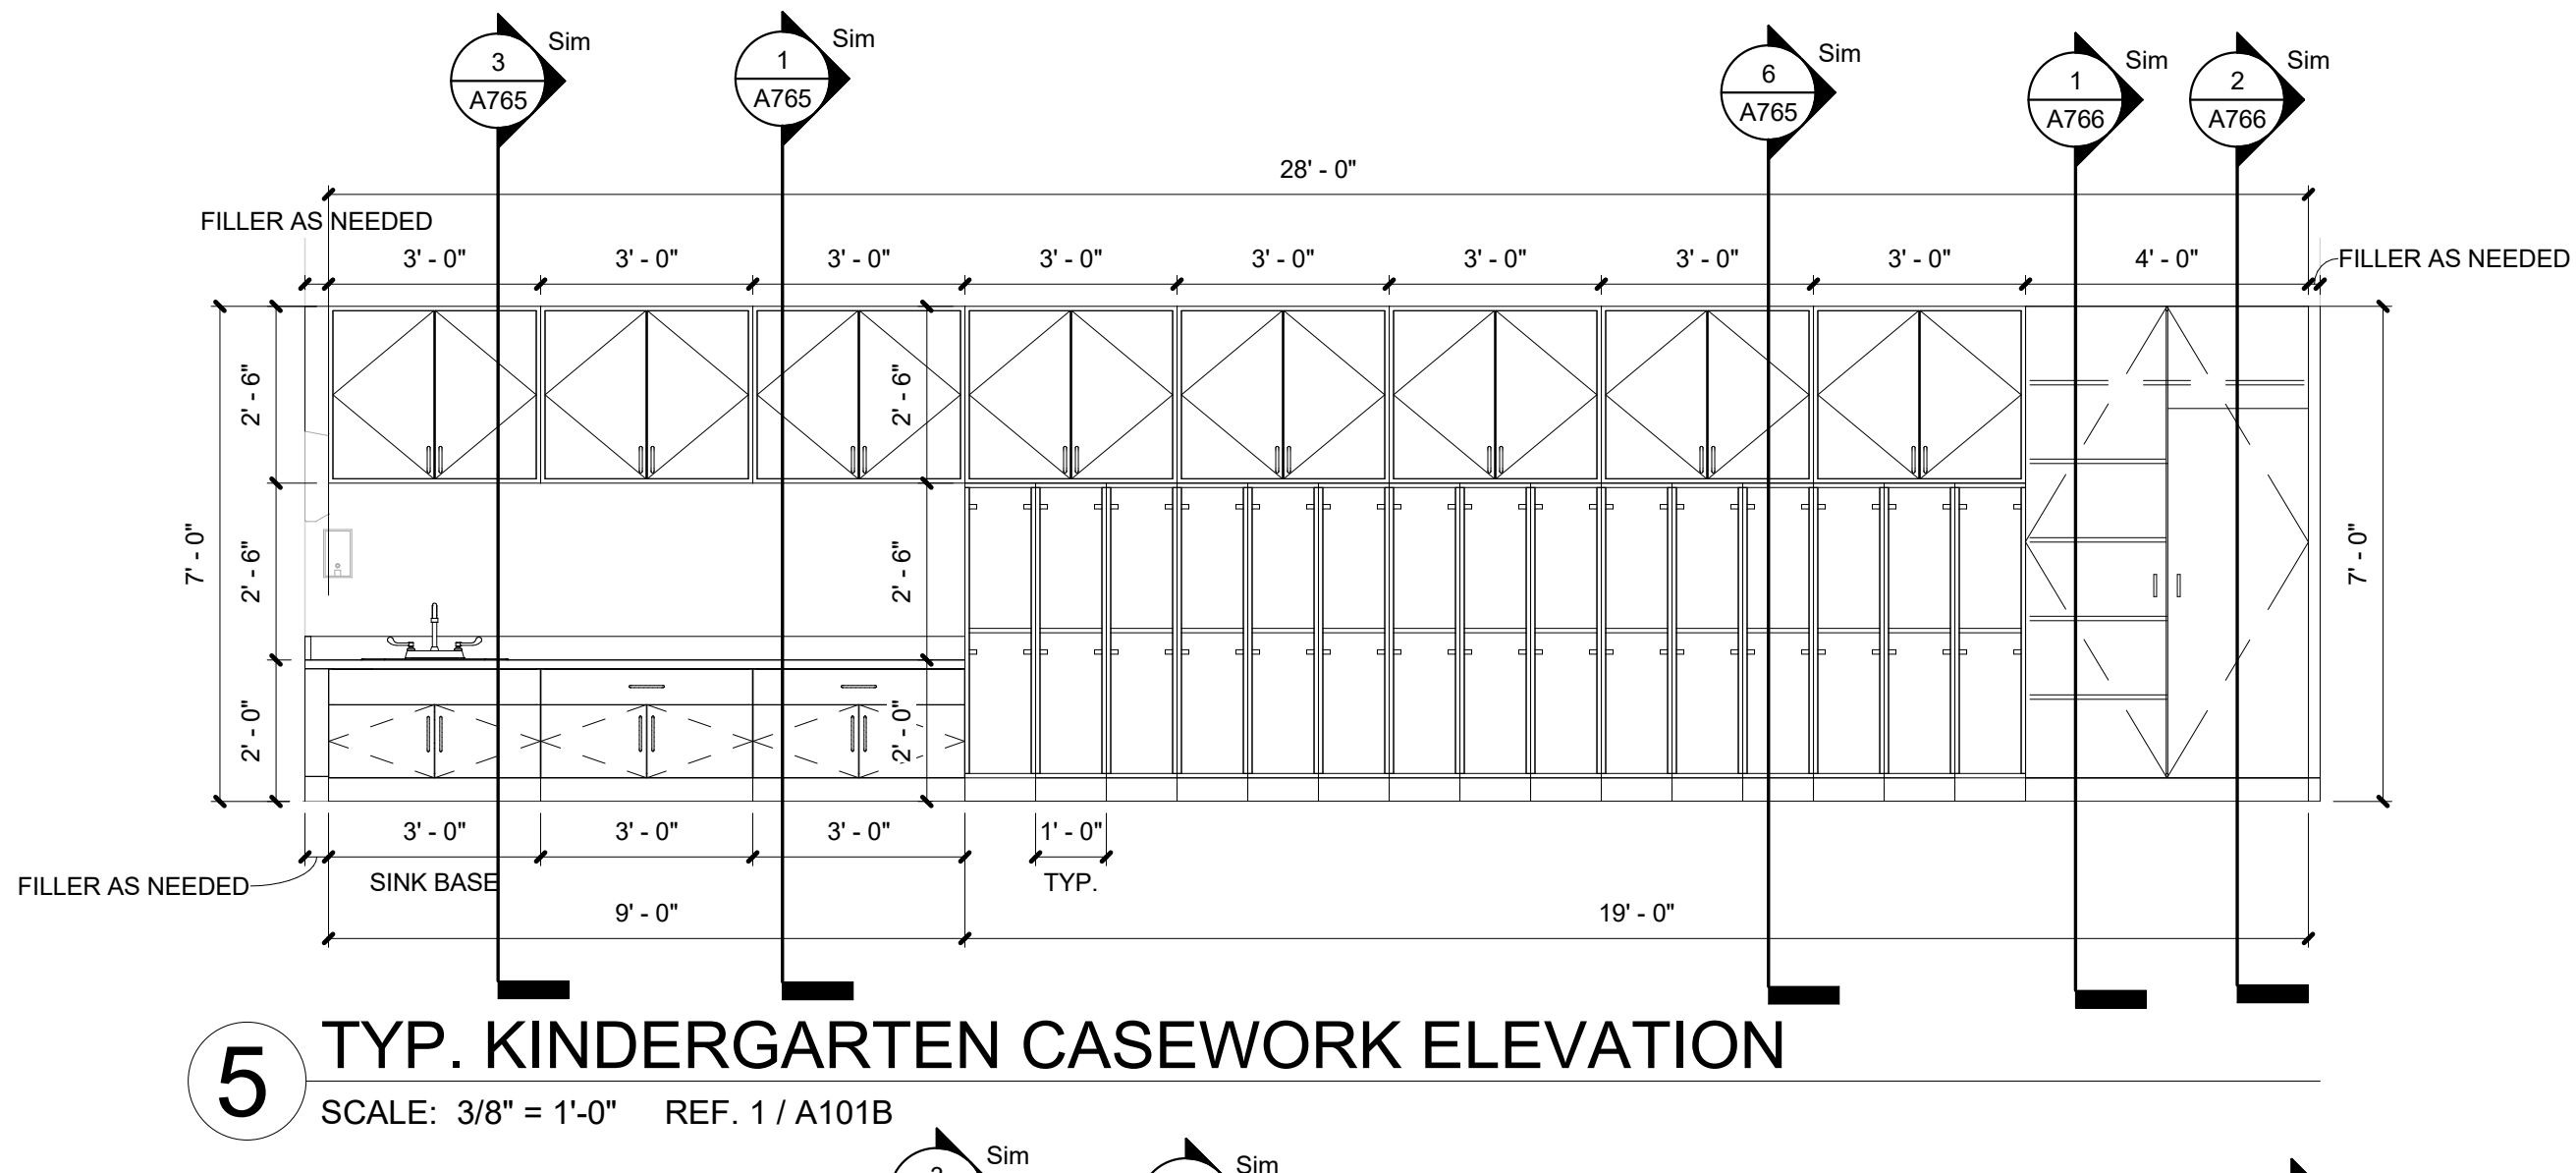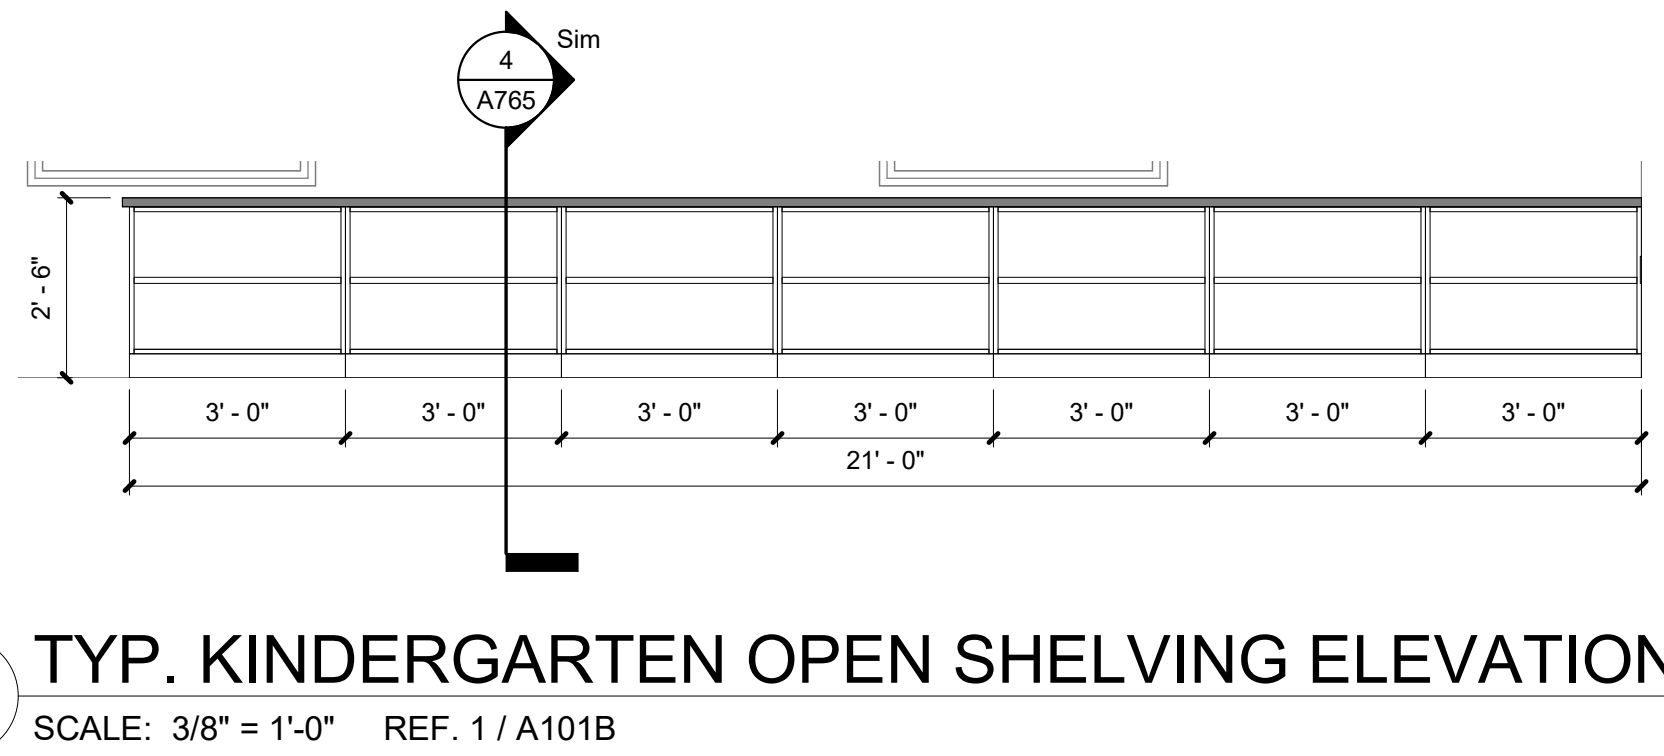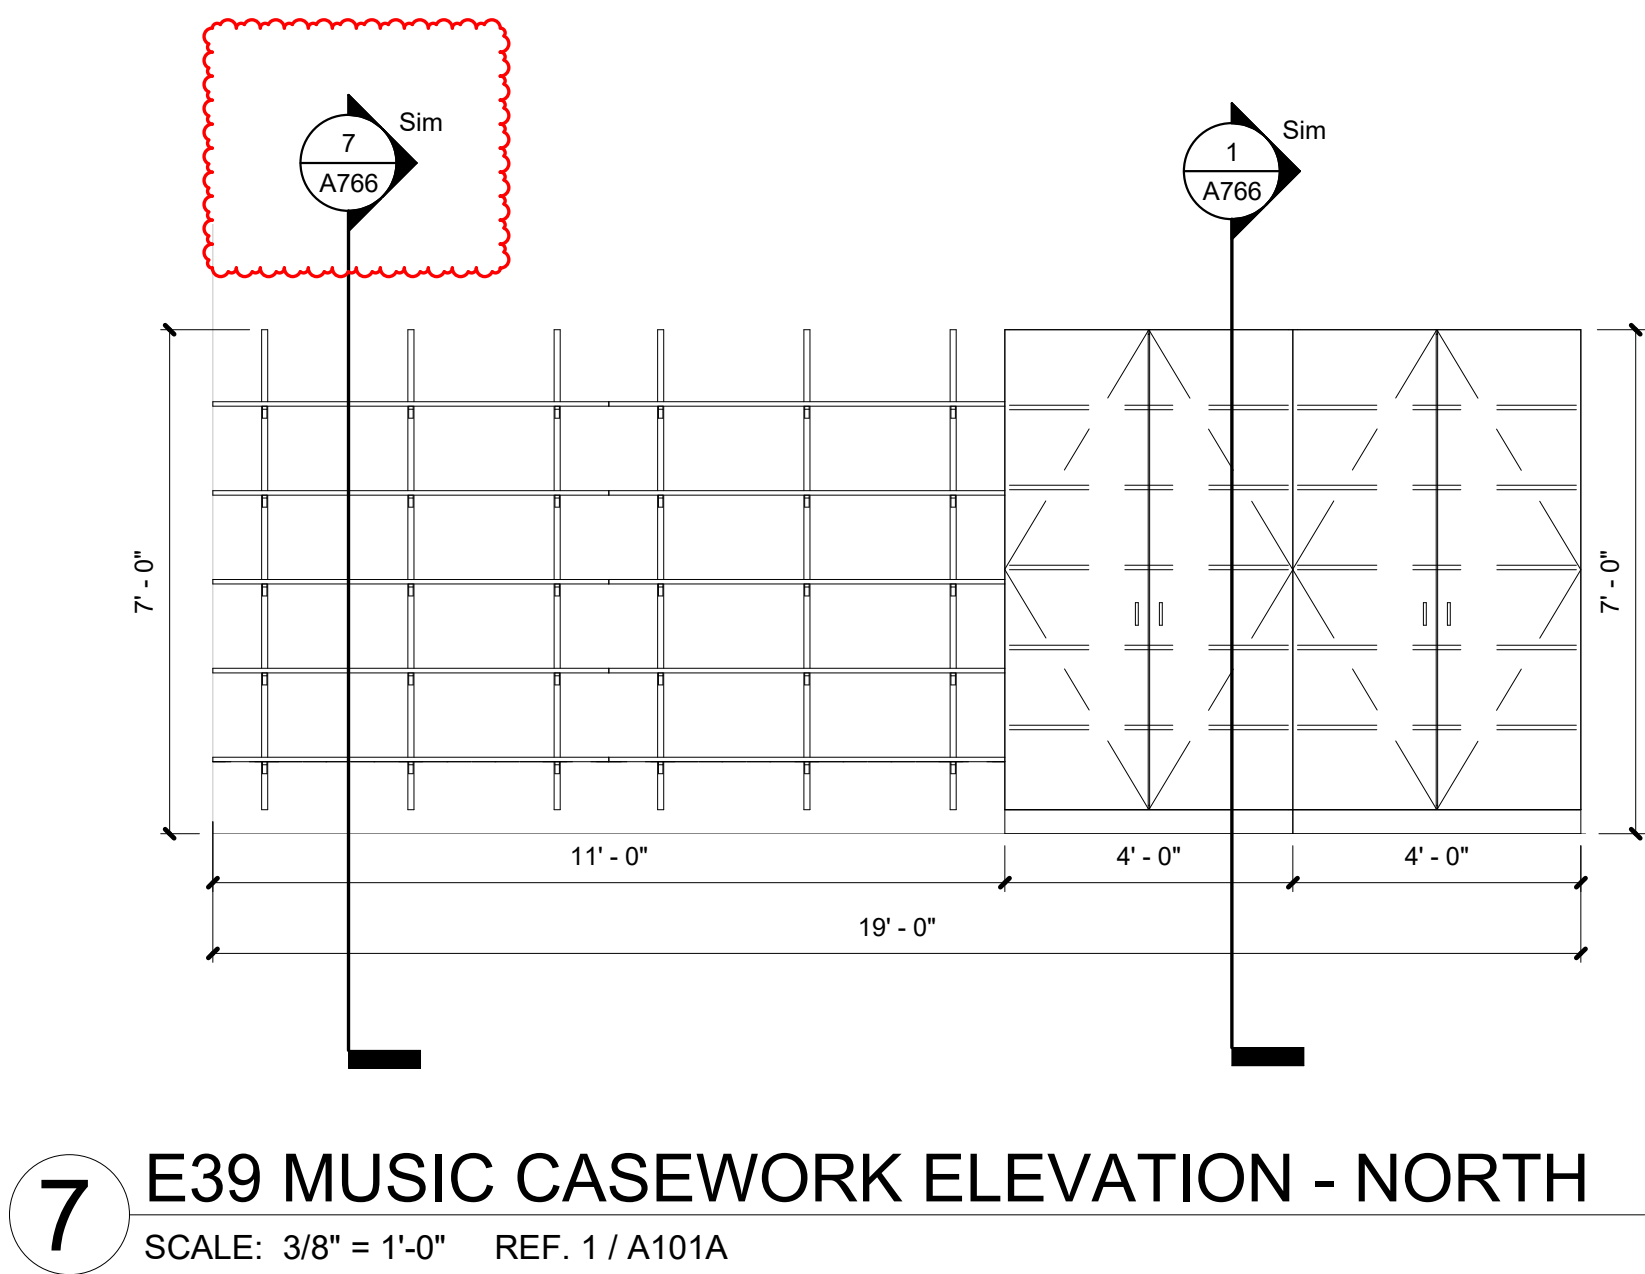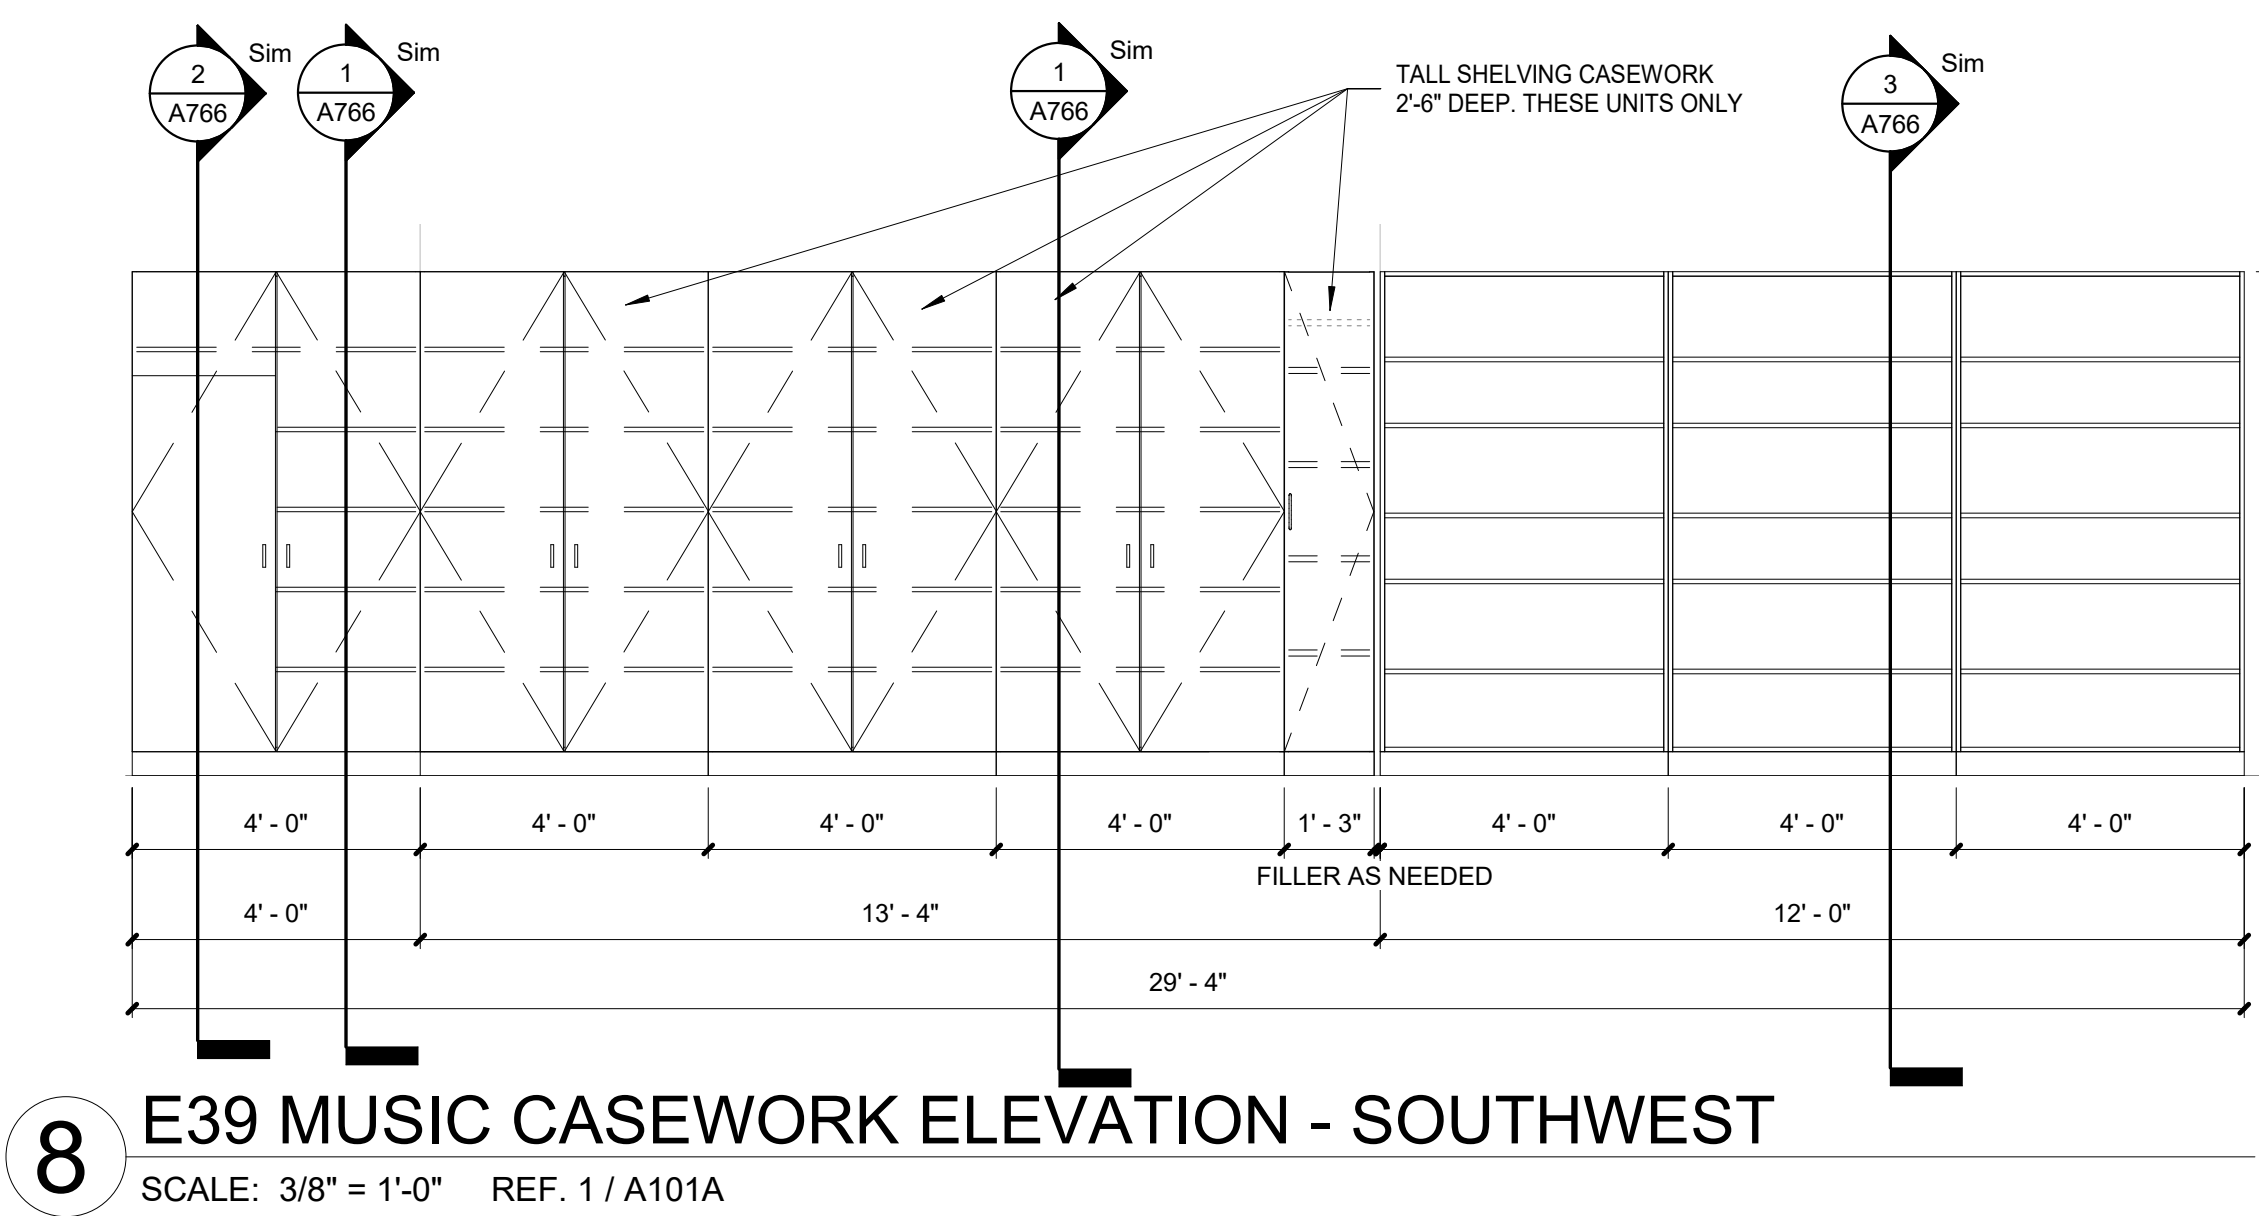

SHELBYVILLE CENTRAL SCHOOLS
LOPER ELEMENTARY SCHOOL RENOVATIONS
901 LOPER DRIVE
SHELBYVILLE, IN 46176

NOT FOR CONSTRUCTION

REVISIONS:	Dir.	Date	Revision
#			
1		14.20.2022	Revision 1

100% CONSTRUCTION DOCUMENTS
PROJECT: #21140
DATE: 04.08.2022
DRAWN BY: Author


CASEWORK ELEVATIONS - ALTERNATES

A764




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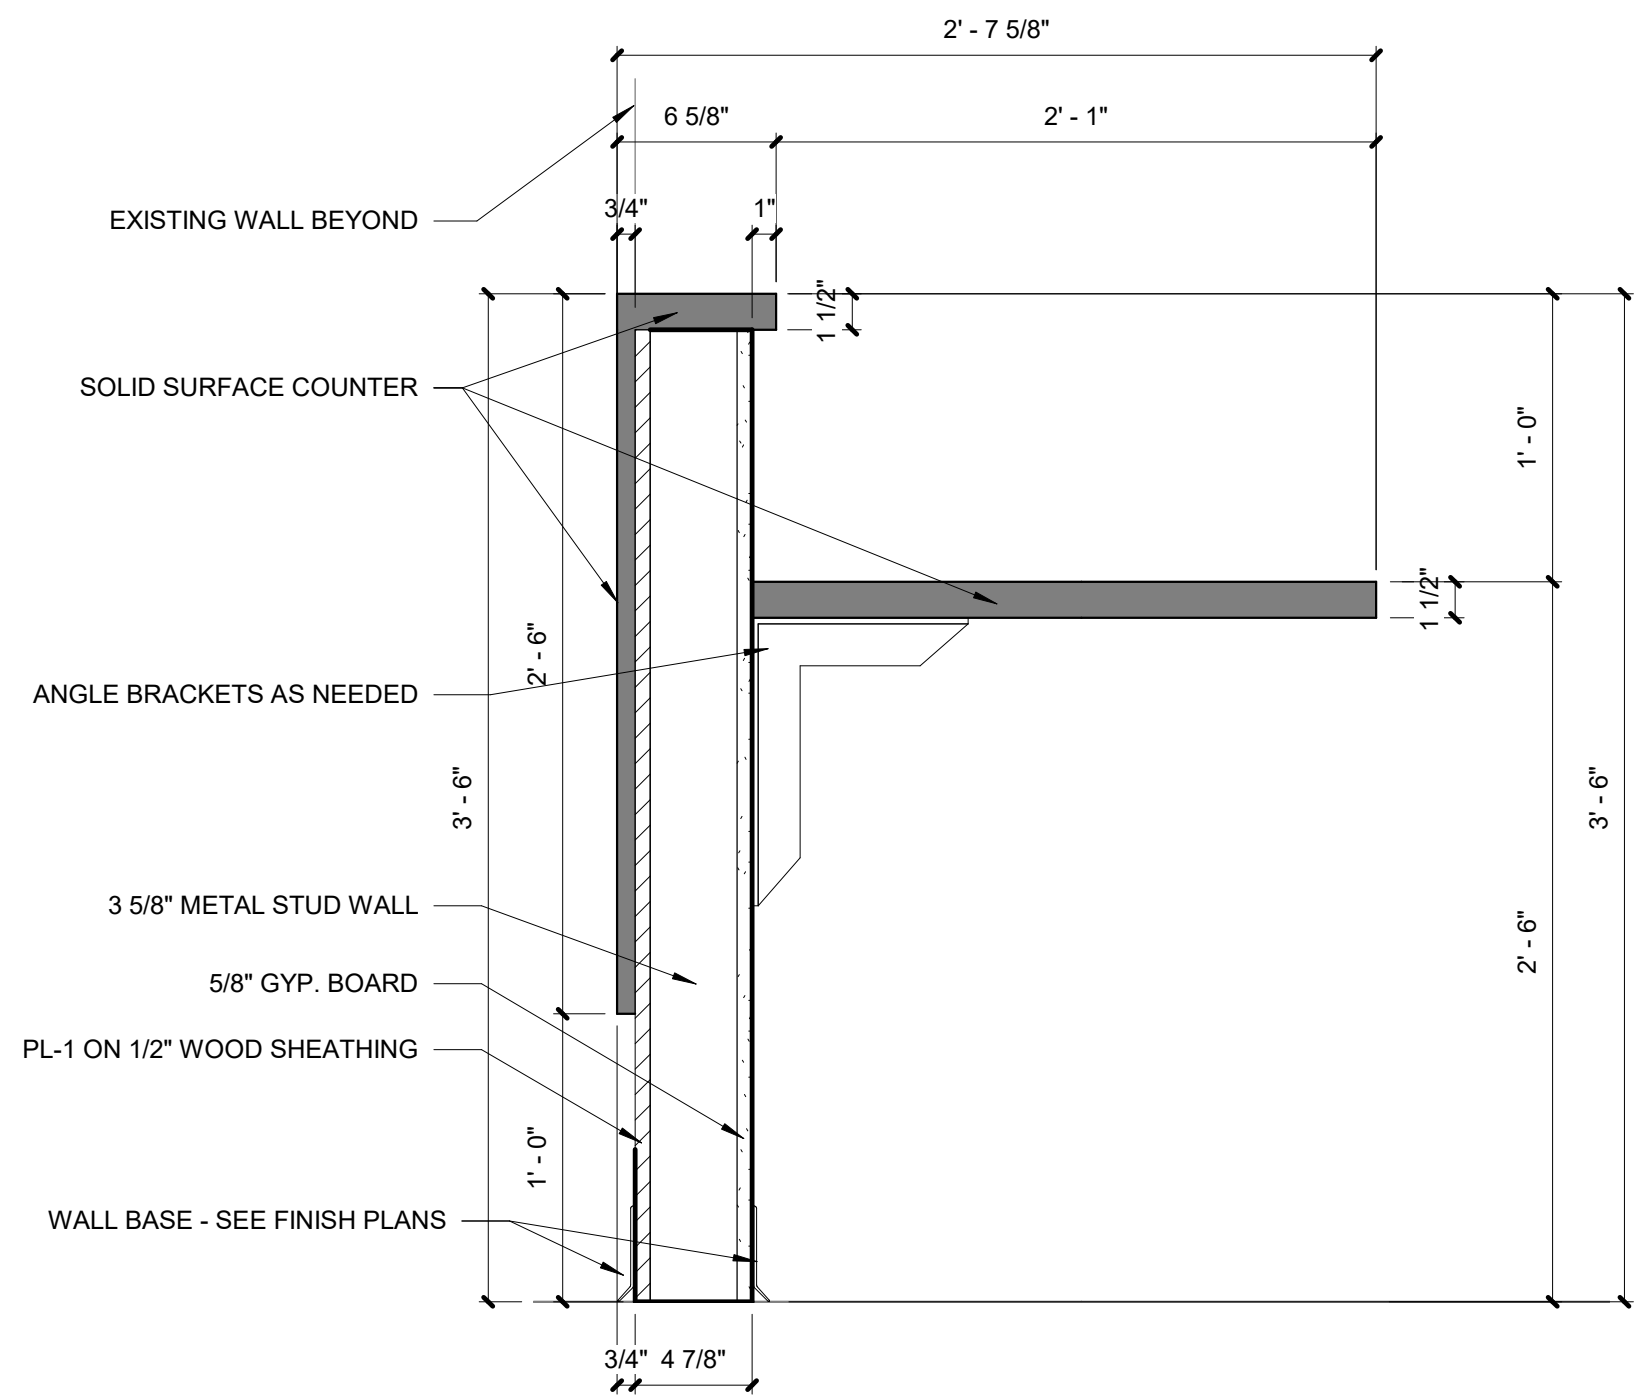
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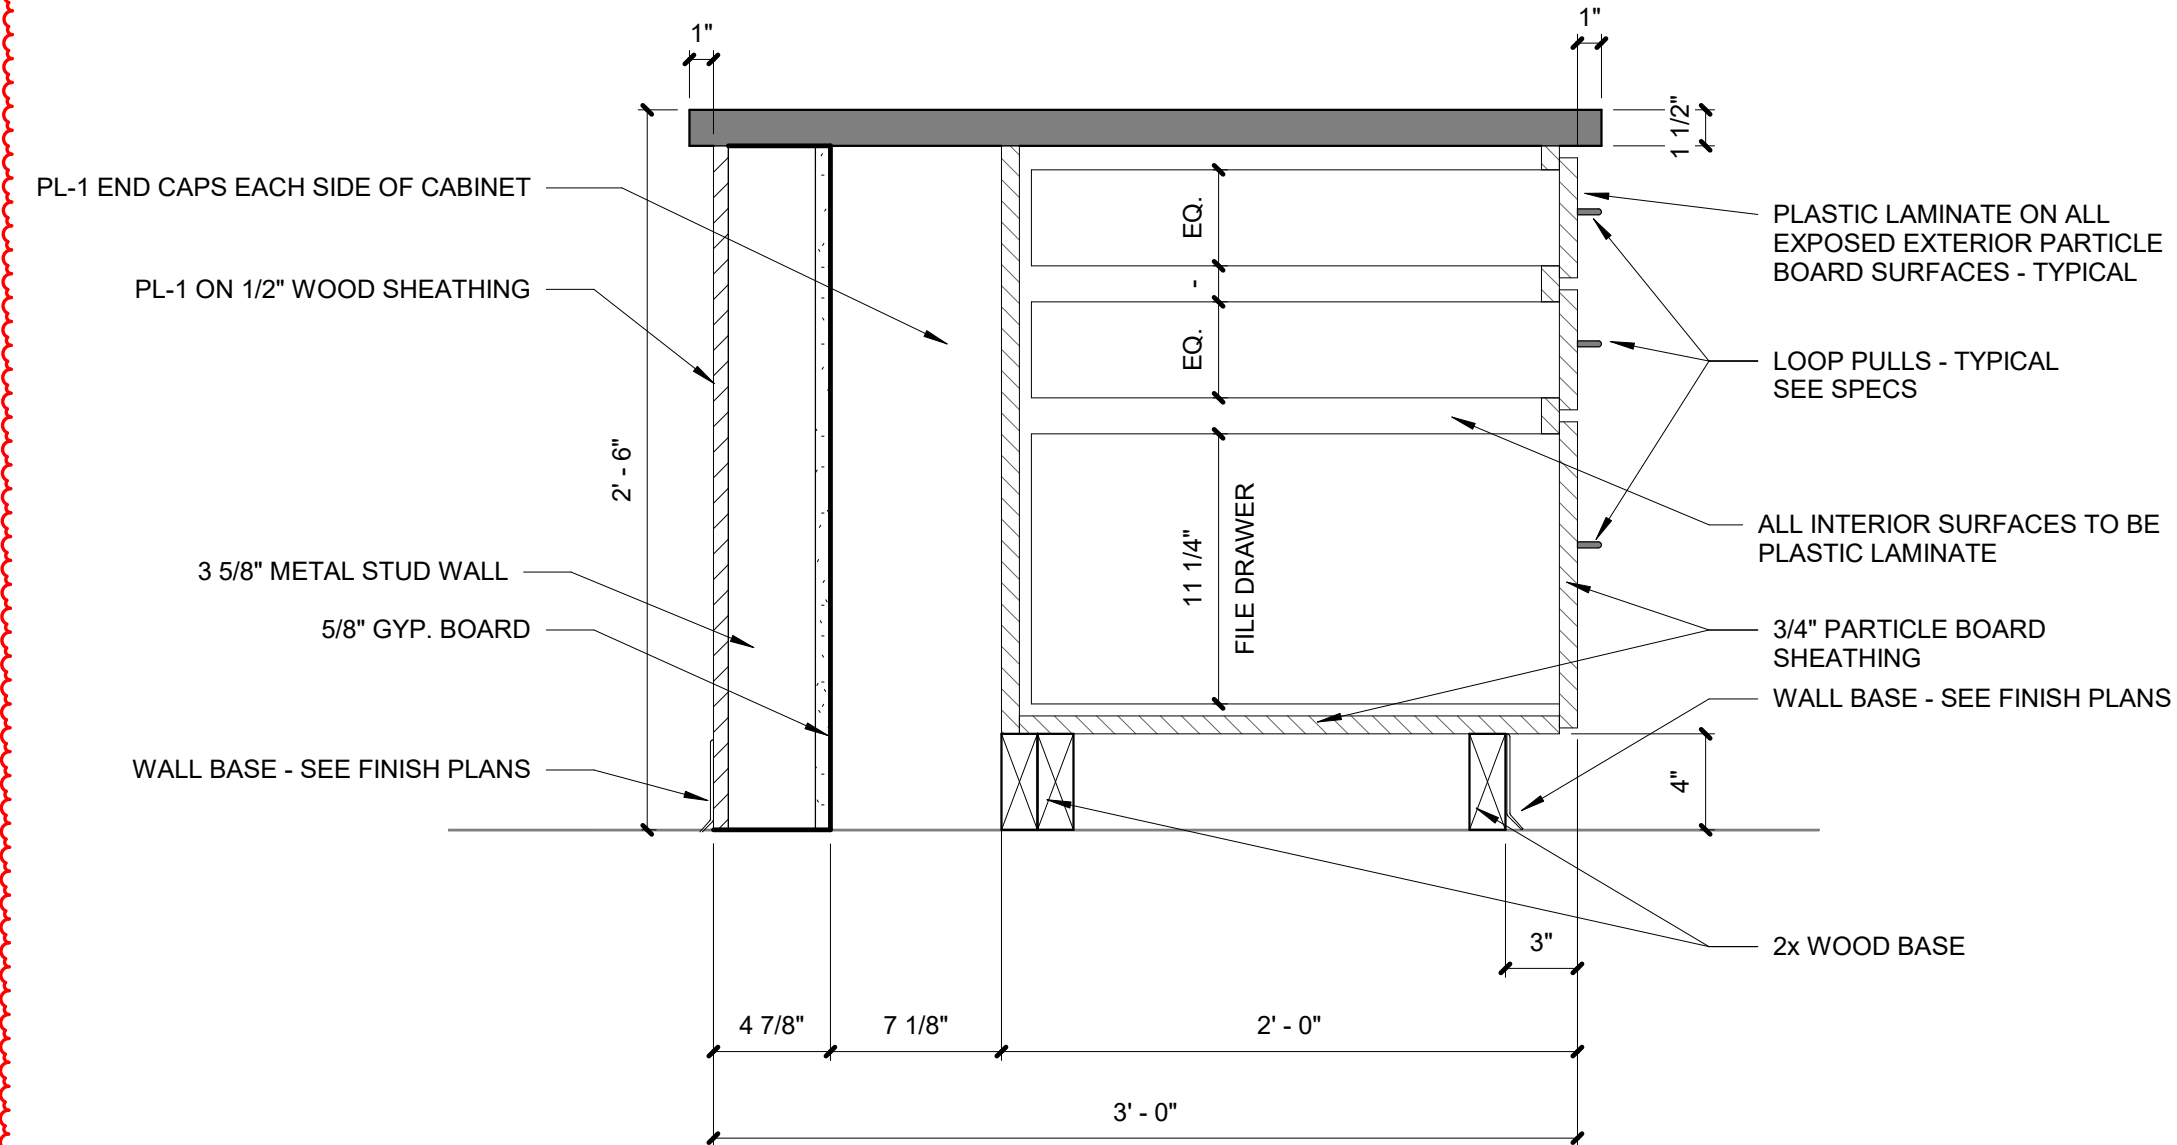
7 CASEWORK TYP. SECTION - TRACK SHELVING
SCALE: 1 1/2" = 1'-0" REF. 13 / A762

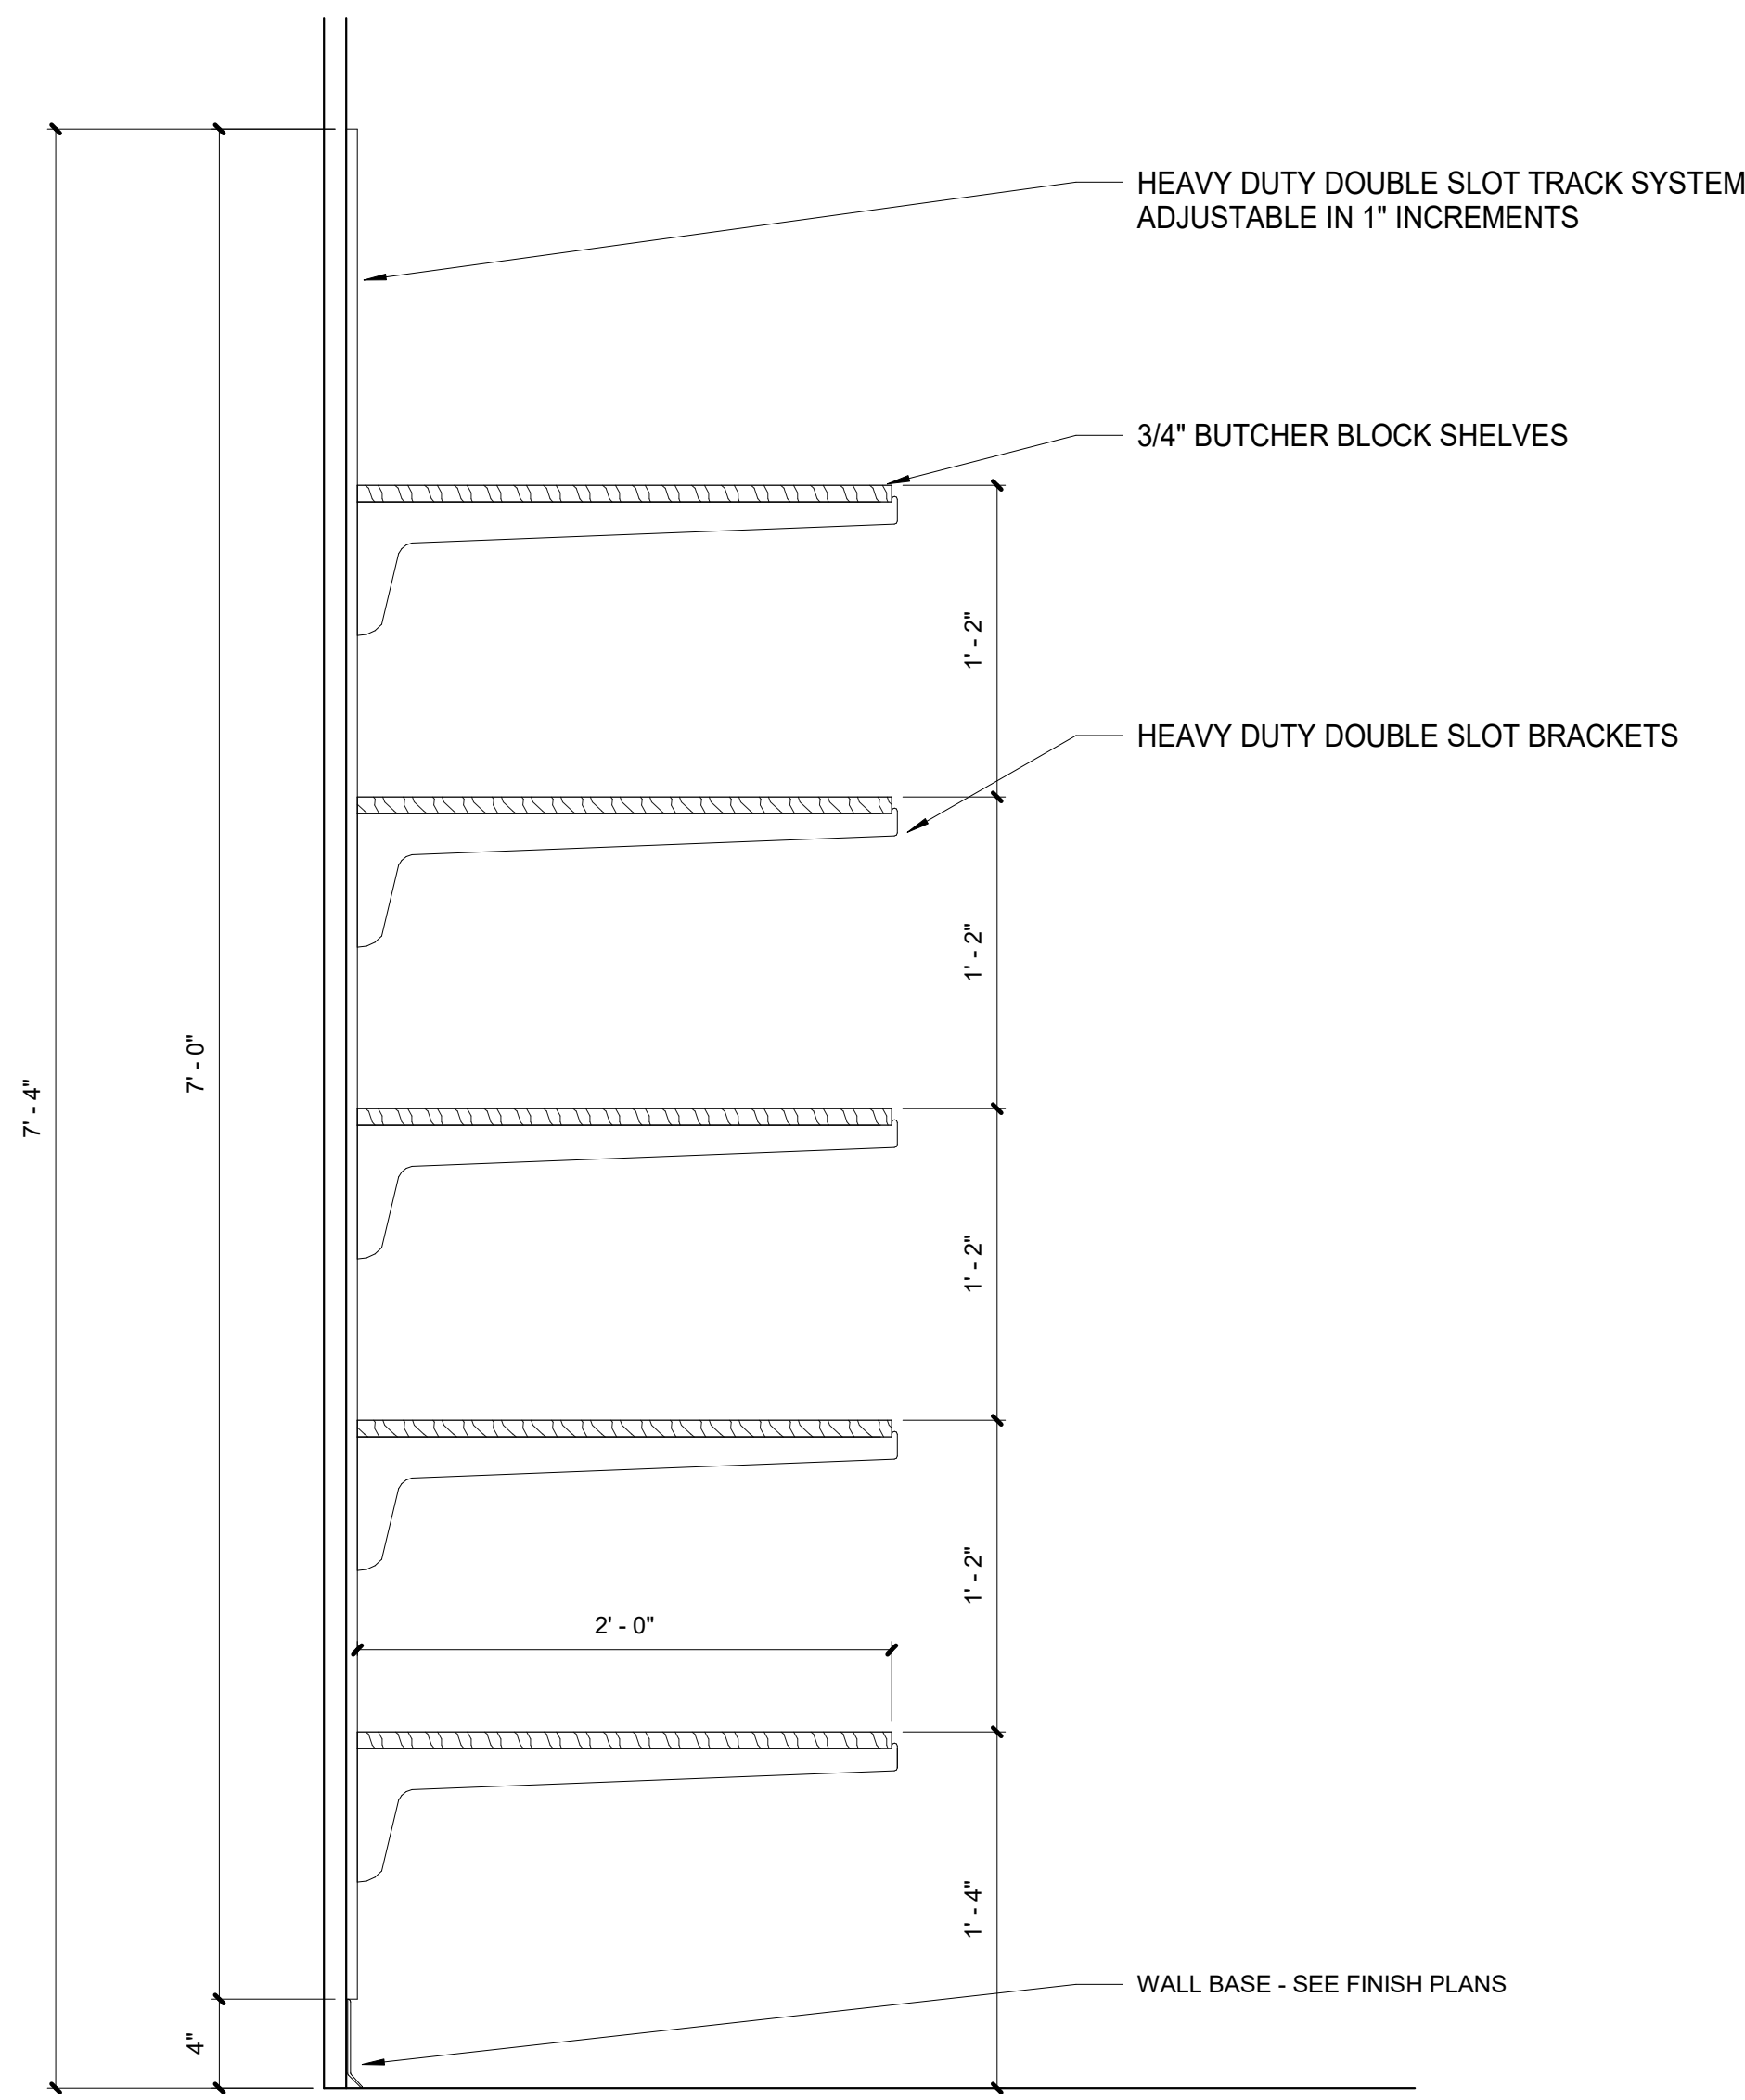


3 CASEWORK TYP. SECTION - TALL OPEN SHELVING
SCALE: 1 1/2" = 1'-0" REF. 8 / A764

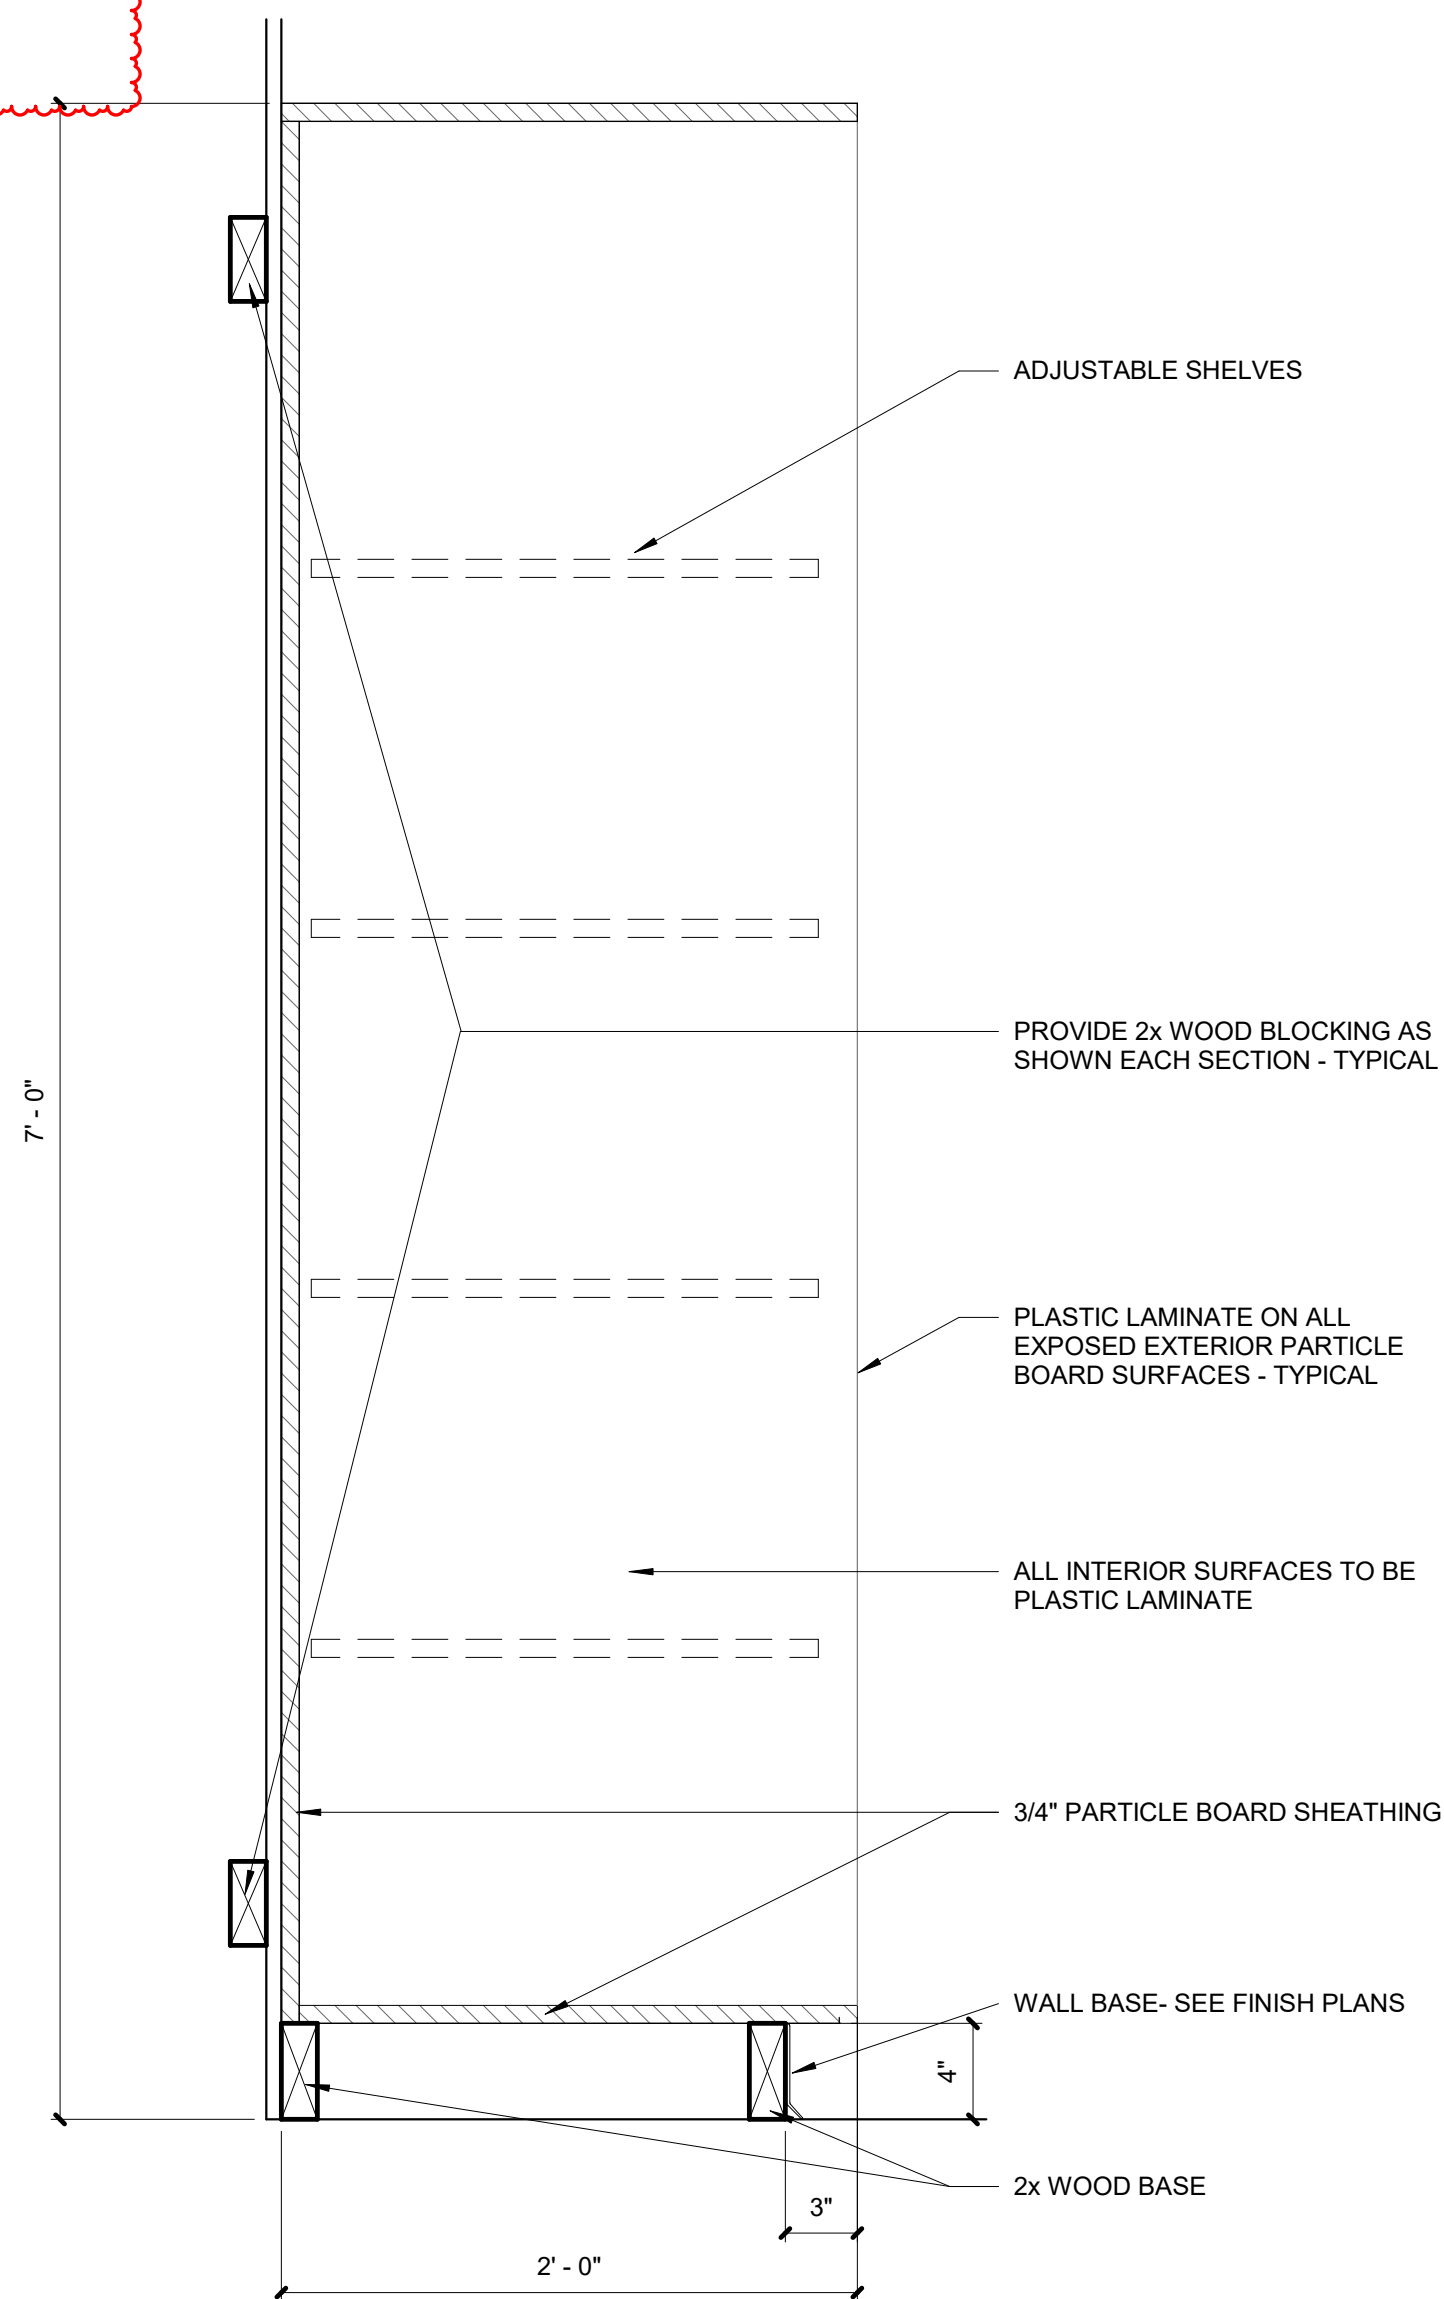

6 CASEWORK SECTION - MEDIA CIRCULATION N/S
SCALE: 1 1/2" = 1'-0" REF. 4 / A112




5 CASEWORK SECTION - MEDIA CIRCULATION E/W AT SHORT WALL
SCALE: 1 1/2" = 1'-0" REF. 4 / A112

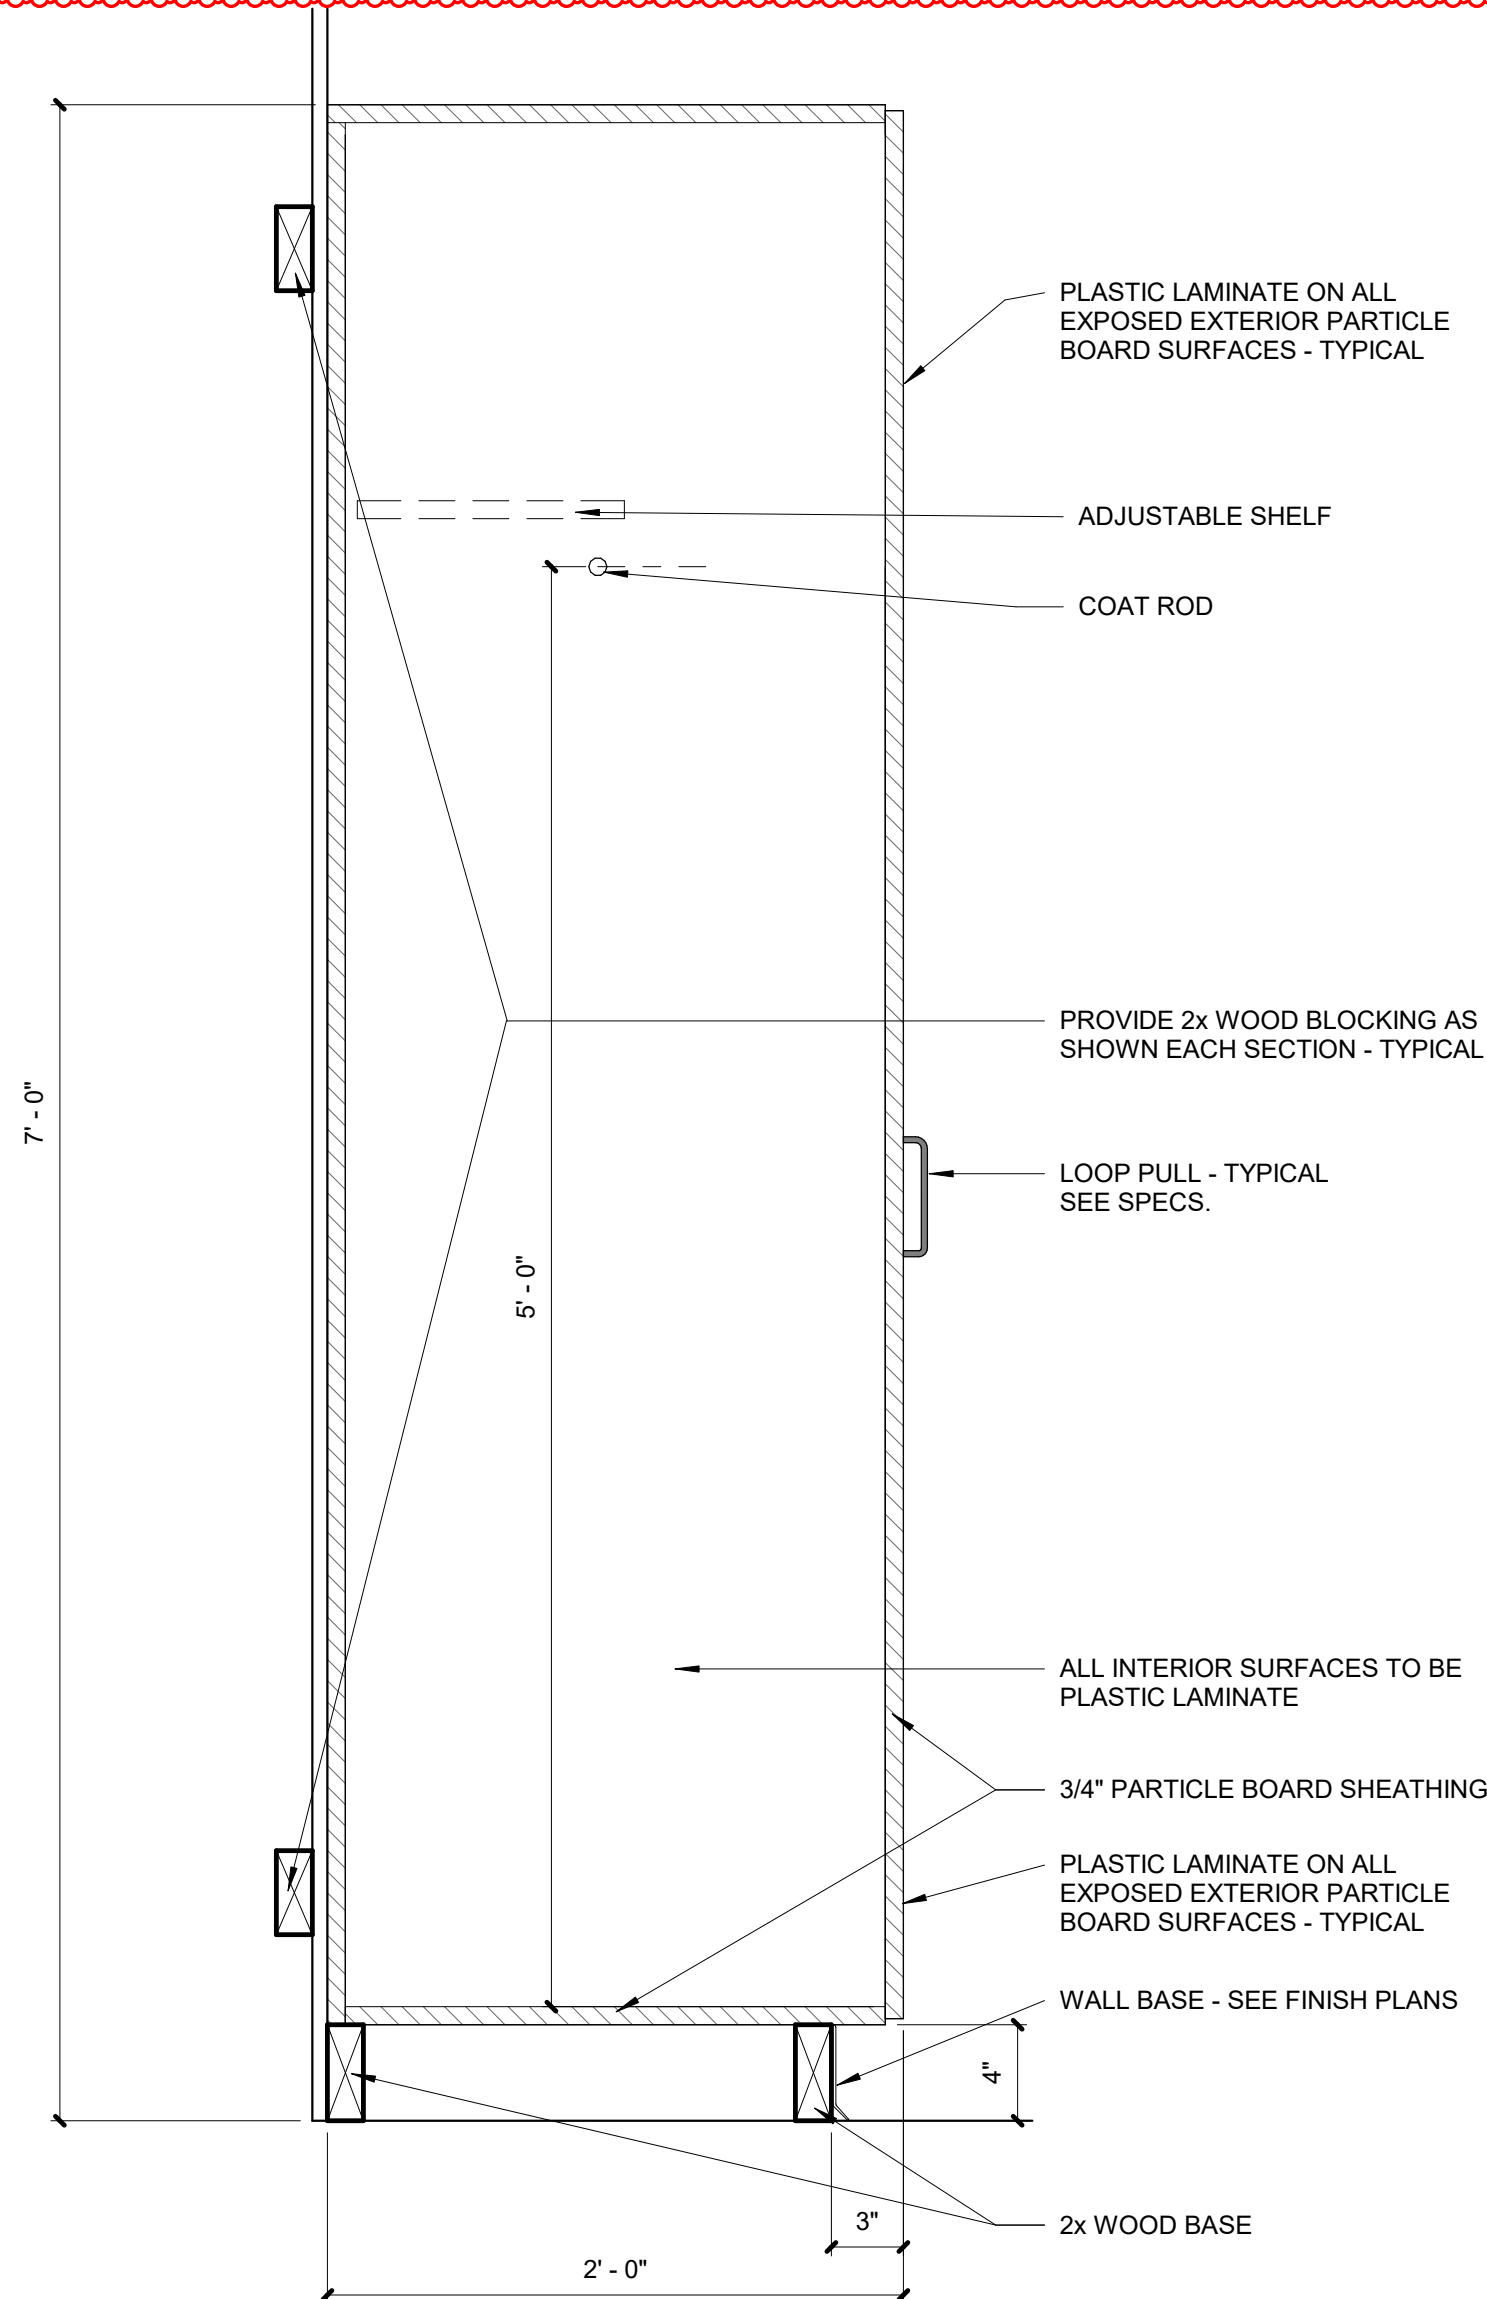


2 CASEWORK TYP. SECTION - TALL WARDROBE COAT ROD
SCALE: 1 1/2" = 1'-0" REF. 1 / A761

GENERAL CASEWORK NOTES	
1. FABRICATE WOODWORK/ MILLWORK ITEMS TO ACTUAL FIELD DIMENSIONS. CONTRACTOR SHALL SUBMIT FOR DESIGNER'S APPROVALS SHOP DRAWINGS, SAMPLES OR MANUFACTURER'S LITERATURE FOR ALL ITEMS. SHOP DRAWINGS SHALL SHOW SUFFICIENT DETAIL TO DETERMINE COMPLIANCE WITH STANDARDS AND DESIGN INTENT.	7. ALL VERTICAL PLASTIC LAMINATE SURFACES AND SHELVES TO BE PL-1. ALL COUNTERTOPS THAT ARE PLASTIC LAMINATE TO BE PL-2 UNLESS OTHERWISE NOTED. REF FINISH LEGEND.
2. PROVIDE ALL NECESSARY FURRING AND GROUNDS FOR WOODWORK AND FINISH ITEMS. COORDINATE LOCATION OF BLOCKING WITHIN FRAMED WALLS AS NECESSARY FOR ITEMS TO BE SECURED TO SURFACE. ALL FASTENERS SHALL BE CONCEALED.	8. ALL INTERIORS BEHIND DOORS/ DRAWERS AND NOT VISIBLE SHALL BE WHITE.
3. FINISH ALL SIDES AND BACK OF MILLWORK/ CASEWORK	9. ALL NEW SOLID SURFACE COUNTERTOPS TO BE SS-1. SOLID SURFACE COUNTERS LOCATED AT SINKS. REF FLOOR PLAN AND FINISH LEGEND.
4. PROVIDE GROMMETS IN COUNTERTOPS ABOVE ALL ELECTRICAL RECEPTALS AND TELEPHONE DATA ROUTINGS.	10. SEE ELEC. DWGS FOR ELECTRICAL DEVICES.
5. ALL PULLS TO BE 4" SATIN NICKEL SOLID WIRE PULL.	11. VERIFY ALL DIMENSIONS IN FIELD AND PROVIDE COMPLETE SHOP DRAWINGS.
6. PROVIDE LOOKS FOR ALL STORAGE BASE CABINETS/ TALL STORAGE CABINETS. ALL DRAWERS AND DOORS, ALL UPPER WALL CABINETS AND ALL DISPLAY CASE SLIDING GLASS PANELS.	12. PROVIDE BLIND CORNER BASE AND UPPER CABINETS - TYPICAL.

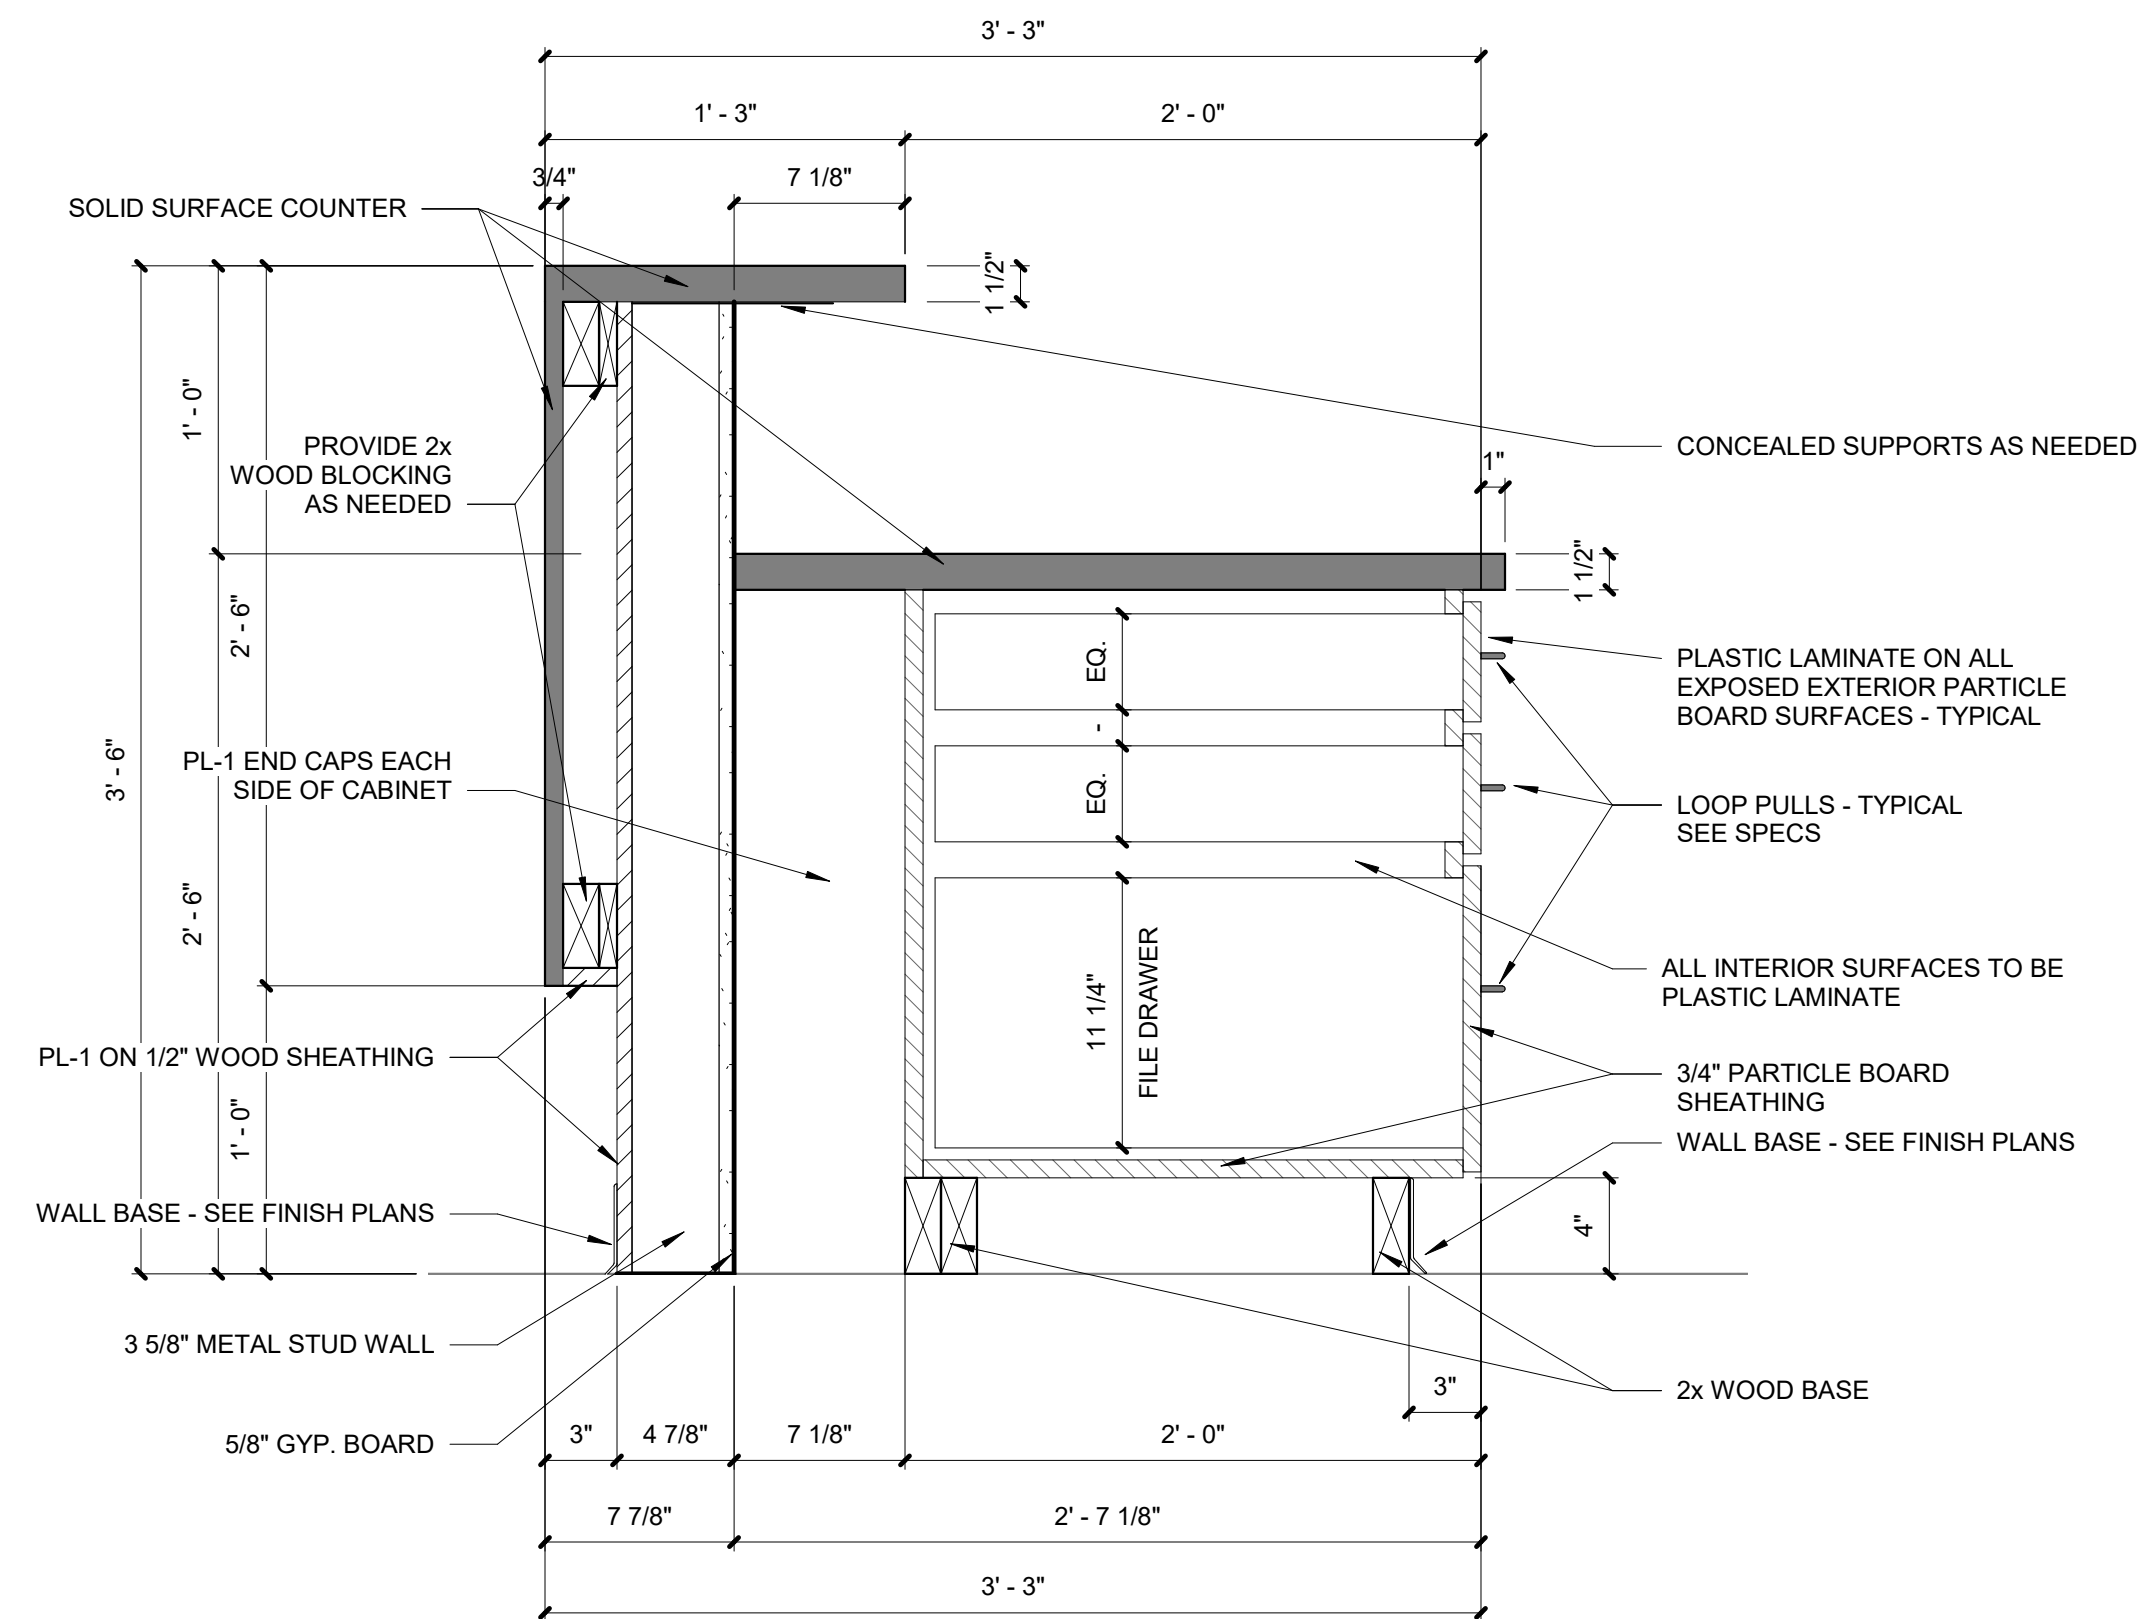

4 CASEWORK SECTION - MEDIA CIRCULATION E/W AT TALL WALL
SCALE: 1 1/2" = 1'-0" REF. 4 / A112

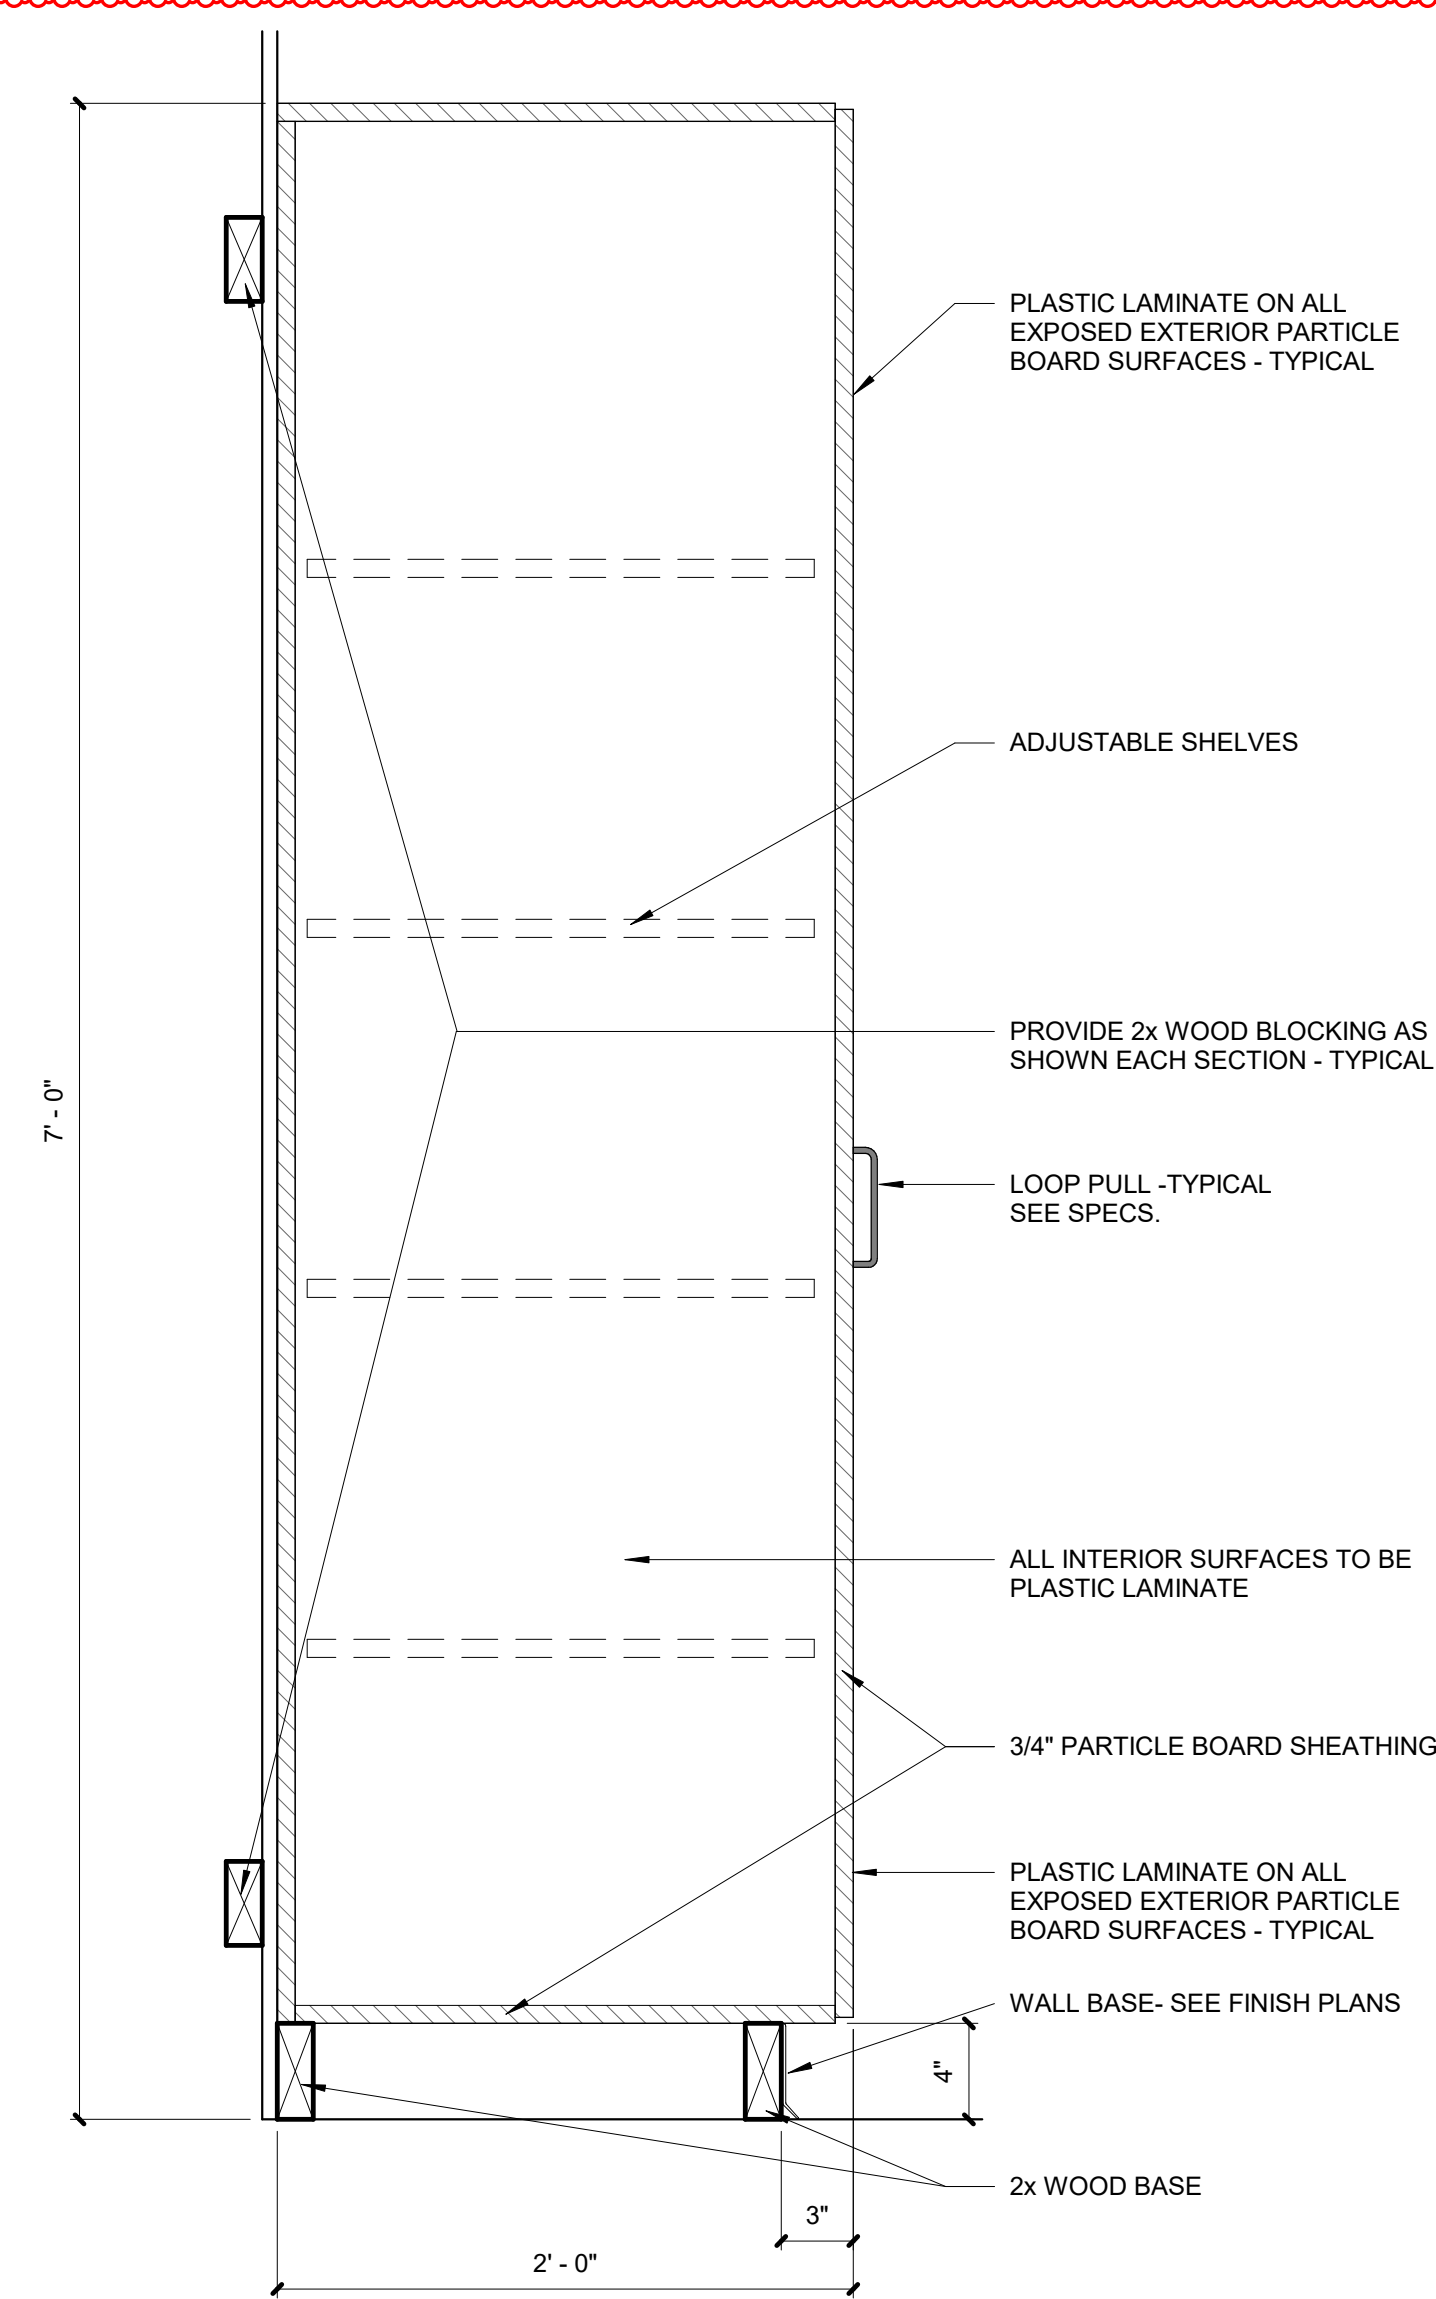

1 CASEWORK TYP. SECTION - TALL SHELVING
SCALE: 1 1/2" = 1'-0" REF. 1 / A761

