## ADDENDUM NO. 3

#### August 19, 2022

Additions and Renovations Hawthorne Elementary School 8301 E. Rawles Avenue Indianapolis, IN 46219

#### TO: ALL BIDDERS OF RECORD

This Addendum forms a part of and modifies the Bidding Requirements, Contract Forms, Contract Conditions, the Specifications, and the Drawings dated July 1, 2022, by CSO Architects. Acknowledge receipt of the Addendum in the space provided on the Bid Form. Failure to do so may subject the Bidder to disqualification.

This Addendum consists of Pages ADD 3-1 through ADD 3-2, and Addendum No. 3 from CSO Architects dated August 19, 2022, consisting of four (4) pages, Specification Section 09 68 16 – Sheet Carpeting, Cripe Addendum No. 3, Context Addendum, Addendum Drawings: C101, C401A, C501, L050, L103, L113, S101, S102, S711, S712, E102, E103.

#### A. SPECIFICATION SECTION 01 12 00 MULTIPLE CONTRACT SUMMARY

1. Paragraph 3.30 Bid Categories:

#### A. BID CATEGORY NO.1 – GENERAL TRADES

#### Add the following clarification:

- 13. The retention and protection of any and all existing electronic/technical items during demolition including but not limited to speakers, internet hubs, low voltage wiring or other such devices which may be connected to or resting on existing ceilings is included in this scope of work. Assure that any such devices are retained in such manner to prevent damage during the Work. Photographically record any devices which are retained for future reference.
- 14. Unless specifically assigned to another Bid Category, see Addendum no. 2, storm and Sanitary sewers described on the Civil Drawings are included in this scope of work

#### B. <u>BID CATEGORY NO.2 – MASONRY</u>

#### Add the following Clarification:

3. Provision of masonry ties or other connectors which are to be welded or otherwise attached to steel or other construction included in Bid Category No.3 – Structural Steel shall be provided included in this scope of work.

#### C. <u>BID CATEGORY NO. 3 – STRUCTURAL STEEL</u>

#### Add the following Clarification:

Masonry ties which are to be welded or otherwise connected to steel or other
construction included in Bid Category No.3 – Structural Steel shall be provided
to the Bid Category No.3 by the Bid Category No 2 – Masonry Contractor.
Installation of ties, including but not limited to welding, is included in this scope
of work.

#### E. <u>BID CATEGORY NO. 5 – ROOFING</u>

#### Add the following Clarifications:

- 3. Metal Closure shown in Detail 8/A407 and any similar condition is included in this scope of work.
- 4. Unless specifically assigned to another bid category, any and all flashing of new construction including but not limited to roof penetrations and curbs is included in the scope of this work.

#### L. <u>BID CATEGORY NO. 12 – ELECTRICAL AND TECHNOLOGY</u>

#### Add the following clarification:

 Subsequent to ceiling demolition, protection of and re-installation of any and all Owner's existing electronic/technical items including but not limited to speakers, internet hubs, low voltage wiring or other such devices which were connected to or resting on existing ceilings prior to demolition is included in this scope of work.

#### **ADDENDUM**



ADDENDUM NO: 3

**BID PACKAGE NO:** 

PROJECT: ADDITIONS AND RENOVATIONS TO HAWTHORNE ELEMENTARY SCHOOL

PROJECT NO: 2021054 DATE: August 19, 2022 BY: Lisa Roberson

This Addendum is issued in accordance with the provisions of "The General Conditions of the Contract for Construction," Article 1, "Contract Documents" and becomes a part of the Contract Documents as provided therein. This Addendum includes:

Addendum Pages: ADD 1 of 4 through ADD 4 of 4

Attached Documents: SPECIFICATION SECTION 09 68 16 - SHEET CARPETING

CRIPE Addendum #3 with Attachments
CONTEXT Addendum #3 with Attachments
LHB Addendum #3 with Attachments

STAIR Associates, Inc. Addendum #3 with Attachments

#### **PART 0 - GENERAL INFORMATION**

0.1 If you have trouble viewing downloaded PDFs, please contact

Greg.Holman@easternengineering.com

0.2 A list of planholders can be found on the Eastern Engineering website:

https://www.csoplanroom.com/View/ViewJob.aspx?job\_id=9598&view=ph

#### **PART 1 - BIDDING REQUIREMENTS**

1.1 NOT USED

#### **PART 2 - SPECIFICATIONS**

- 2.1 SECTION 00 00 20 TABLE OF CONTENTS
  - A. Add SECTION 09 68 16 SHEET CARPETING to Table of Contents (All Project Manual Volumes).
- 2.2 SECTION 08 11 13 HOLLOW METAL DOORS AND FRAMES
  - A. ADD the following to Paragraph 2.01.A
    - 8. De La Fontaine



#### 2.3 SECTION 09 66 25

- A. In SUMMARY 1.02.S DELETE the following:
  - 1. "in existing stairways only"

#### 2.4 SECTION 09 68 16 – SHEET CARPETING

A. ADD Specification Section in its entirety, attached to this Addendum.

#### 2.5 SECTION 09 72 15 – DIGITAL WALL COVERINGS

- A. DELETE all references to Operable Panel Partitions as follows:
  - 1. DELETE 1.02.A.2
  - 2. DELETE 1.02.B
  - 3. DELETE from 2.02.I. the following: "and as coordinated with operable panel partition manufacturer's shop drawings."
  - 4. DELETE from 2.03.I. the following: "and as coordinated with operable panel partition manufacturer's shop drawings."

#### **PART 3 - DRAWINGS**

#### **ARCHITECTURAL**

#### 3.1 SHEET A401 – WALL SECTIONS

- A. At 1/A401, ADD the following note to interior stool at high Gymnasium windows:
  - 1. "12" Bullnose CONCRETE BLOCK WINDOW STOOL MITER TO BULLNOSE JAMBS AT 45 DEGREE ANGLE TO CREATE NEAT JOINTS (TYPICAL)."
- B. At 1/A401, ADD the following note to interior jambs at high Gymnasium window:
  - 1. "12" Bullnose CONCRETE BLOCK WINDOW JAMBS MITER TO BULLNOSE STOOL AT 45 DEGREE ANGLE TO CREATE NEAT JOINTS (TYPICAL)."

#### 3.2 SHEET A404 – WALL SECTIONS

- A. At WALL SECTION 2/A404:
  - 1. REVISE note "3/4" EXTERIOR SHEATHING" to read "5/8" EXTERIOR GYPSUM SHEATHING"

Addendum 3 ADD 2 of 4



#### 3.3 SHEET A405 – WALL SECTIONS

- A. At WALL SECTIONS 1/A405, 2/A405 and 5/A405:
  - 1. REVISE note "¾" EXTERIOR SHEATHING" to read "5/8" EXTERIOR GYPSUM SHEATHING"

#### 3.4 SHEET A407 – VERTICAL CIRCULATION SECTIONS AND DETAILS

A. ADD the following note to SECTION DETAIL 8:

"METAL CLOSURE AT TOP OF CHASE TO BE 12 GA. METAL, BRACED AS MAY BE REQUIRED TO ELIMINATE DEFLECTION AND SLOPED TO MINIMIZE COLLECTION OF DUST AND DEBRIS. TRIM MAY BE ANCHORED WITH CLIPS (CONCEALED FASTENING SYSTEM) AS IF IT WERE A ROOF COPING OR FASCIA. CLOSURE TO COMPLETELY CLOSE OFF CHASE INCLUDING AT BLEACHER (NORTH) SIDE. OTHER ATTACHMENT OPTIONS WILL BE CONSIDERED. PAINT TO MATCH ADJACENT STRUCTURE ABOVE MASONRY."

#### 3.5 SHEET A501 – DOOR SCHEDULE AND FRAME ELEVATIONS

- A. At Door and Frame Schedule, REVISE the following:
  - 1. At Door A134A, REVISE Door Material to be HM (Hollow Metal)
  - 2. At Door A134A, REVISE Door Finish to be PT (Paint)
  - 3. At Door A134A, REVISE Door Elevation to be D5
  - 4. At Door A134A, ADD #17 to Remarks Column
- B. At Keyed Door Notes, ADD the following:

"17. DOOR A134A TO BE EXTRA-HEAVY-DUTY 16 GA HOLLOW METAL IN 14 GA HOLLOW METAL FRAME AND TO HAVE HEAVY DUTY BLOCKING/FRAMING AT HARDWARE LOCATIONS"

#### 3.6 SHEET A602 – GYM INTERIOR ELEVATION

A. ADD Note at 1/A602 to read:

"PROVIDE GYPSUM BOARD BULKHEAD AT TOP OF WALL FROM 23'-4" A.F.F. TO UNDERNEATH SIDE OF ROOF DECK – ENTIRE WIDTH OF WALL – SEE 4/A406. COPE BULKHEAD AS REQUIRED FOR TIGHT FIT TO TOP CHORD OF JOISTS/SEATS AND TO DECK AND CAULK."

Addendum 3 ADD 3 of 4



#### 3.7 SHEET A800 – FINISH LEGEND AND INFORMATION

A. REVISE finish C4 BROADLOOM CARPET on Finish Legend as follows:

C4 BROADLOOM CARPET

MFR: TO BE DETERMINED SHAW CONTRACT

**COLLECTION: HAND DRAWN** 

STYLE: TBD CONTÉ

COLOR: TBD SLATE 13585

LOCATION: STAIRS OF STORY TIME A154

#### 3.8 SHEET A801A – FIRST FLOOR FINISH PLAN – UNIT A

A. REVISE west wall countertop finish tag in A159 FACULTY LOUNGE from PL4 to SS2.

#### 3.9 <u>SHEET A801BC – FIRST FLOOR FINISH PLAN – UNIT B AND C</u>

- A. REVISE countertop finish tag from <del>SS2</del> to **SS1** in the following classrooms:
  - 1. B101, B102, B103, B104, B105, B106, B111, B112, B113, B117

#### 3.10 SHEET A801D – FIRST FLOOR FINISH PLAN – UNIT D

A. REVISE casework finish tag in D101 ART LAB from PL2 to PL3.

#### **END ADDENDUM 3**

Addendum 3 ADD 4 of 4

#### SECTION 09 68 16 - SHEET CARPETING

**ADDENDUM 3** 

#### PART 1 - GENERAL

#### 1.01 RELATED DOCUMENTS

A. Drawings and general provisions of the Contract, including General and Supplementary Conditions and Division 01 Specification Sections, apply to this Section.

#### 1.02 SUMMARY

A. Section includes: Tufted Carpet.

В.

#### 1.03 ACTION SUBMITTALS

- A. Product Data: For each type of product.
  - 1. Include manufacturer's written data on physical characteristics, durability, and fade resistance.
  - 2. Include installation recommendations for each type of substrate.
- B. Shop Drawings: Show the following:
  - 1. Columns, doorways, enclosing walls or partitions, built-in cabinets, and locations where cutouts are required in carpet tiles.
  - 2. Carpet tile type, color, and dye lot.
  - Type of subfloor.
  - 4. Type of installation.
  - 5. Pattern of installation.
  - 6. Pattern type, location, and direction.
  - 7. Pile direction.
  - 8. Type, color, and location of insets and borders.
  - 9. Type, color, and location of edge, transition, and other accessory strips.
  - 10. Transition details to other flooring materials.
- C. Samples: For each of the following products and for each color and texture required. Label each Sample with manufacturer's name, material description, color, pattern, and designation indicated on Drawings and in schedules.
  - 1. Carpet: 12-inch- (300-mm-) square Sample.
  - 2. Exposed Edge, Transition, and Other Accessory Stripping: 12-inch- (300-mm-) long Samples.
  - 3. Carpet Cushion: 6-inch- (150-mm-) square Sample.
  - 4. Carpet Seam: 6-inch (150-mm) Sample.
  - 5. Mitered Carpet Border Seam: 12-inch- (300-mm-) square Sample. Show carpet pattern alignment.
- D. Product Schedule: For carpet and carpet cushion. Use same designations indicated on Drawings.

#### 1.04 INFORMATIONAL SUBMITTALS

- A. Qualification Data: For Installer.
- B. Product Test Reports: For carpet, for tests performed by a qualified testing agency.
- C. Sample Warranty: For special warranty.

#### 1.05 CLOSEOUT SUBMITTALS

- A. Maintenance Data: For carpet to include in maintenance manuals. Include the following:
  - 1. Methods for maintaining carpet, including cleaning and stain-removal products and procedures and manufacturer's recommended maintenance schedule.
  - 2. Precautions for cleaning materials and methods that could be detrimental to carpet tile.

#### 1.06 MAINTENANCE MATERIAL SUBMITTALS

- A. Furnish extra materials, from the same product run, that match products installed and that are packaged with protective covering for storage and identified with labels describing contents.
  - 1. Carpet: Full-width rolls equal to [5] < Insert number > percent of amount installed for each type indicated, but not less than 10 sq. yd. (8.3 sq. m).

#### 1.07 QUALITY ASSURANCE

- A. Installer Qualifications: An experienced installer who is certified by the International Certified Floorcovering Installers Association at the Commercial II certification level.
- B. Fire-Test-Response Ratings: Where indicated, provide carpet tile identical to those of assemblies tested for fire response according to NFPA 253 by a qualified testing agency.

#### 1.08 DELIVERY, STORAGE, AND HANDLING

A. Comply with CRI 104.

#### 1.09 FIELD CONDITIONS

- A. Comply with CRI 104 for temperature, humidity, and ventilation limitations.
- B. Environmental Limitations: Do not deliver or install carpet until spaces are enclosed and weathertight, wet work in spaces is complete and dry, and ambient temperature and humidity conditions are maintained at occupancy levels during the remainder of the construction period.
- C. Do not install carpet over concrete slabs until slabs have cured and are sufficiently dry to bond with adhesive and concrete slabs have pH range recommended by carpet tile manufacturer.
- D. Where demountable partitions or other items are indicated for installation on top of carpet tiles, install carpet before installing these items.

#### 1.10 WARRANTY

- A. Special Warranty for Carpet: Manufacturer agrees to repair or replace components of carpet tile installation that fail in materials or workmanship within specified warranty period.
  - 1. Warranty does not include deterioration or failure of carpet tile due to unusual traffic, failure of substrate, vandalism, or abuse.
  - 2. Failures include, but are not limited to, more than 10 percent edge raveling, snags, runs, dimensional stability, excess static discharge, loss of tuft bind strength, loss of face fiber, and delamination.
  - 3. Warranty Period: 10 years from date of Substantial Completion.

#### PART 2 - PRODUCTS

#### 2.01 PERFORMANCE REQUIREMENTS

- A. Fire Performance Characteristics: Provide carpeting that is identical to that tested for the following fire performance requirements, according to test method indicated, by UL or other testing and inspecting agency acceptable to authorities having jurisdiction.
  - 1. Flammability: Passes Methenamine Pill Test per ASTM D 2859.
  - 2. Surface Burning Characteristics per ASTM E 84:
    - a. Flame Spread: Not more than 75.
    - b. Smoke Developed: Not more than 100.
  - 3. Critical Radiant Flux: Not less than 0.45 watts per sq. centimeter per ASTM E 648.
  - 4. Smoke Density: With flame, 15.4 minimum value; without flame, 9.1 minimum value per ASTM E 662.
- B. All submitted test numbers should represent average for standard production goods.
- C. Required Test Reports:
  - 1. Pill Test / DOC-FF-1-70 (ASTM D-2589) Requirement: Pass
  - 2. Flooring Radiant Panel / ASTM E-648 Requirement: Class I (Above .45 w/cm)
  - CRI VOC Chamber Test/Indoor Air Quality test (CRI-IAQ) Green Label Plus Test.
  - 4. Lightfastness: Rating of not less than 3 on International Grey Scale after 40 SFU's when tested in accordance with AATCC Test Method 16E.
  - 5. Crockfastness: Minimum stain rating on International Grey Scale of not less than 3 wet or dry when tested in accordance with AATCC Test Method 165.
  - 6. Atmospheric Fading: Burned Gas shall not be less than 3 on International Grey Scale after two cycles on each test as per AATCC Test Method 129 Ozone and AATCC Test Method 23.

#### 2.02 TUFTED CARPET

A. Basis-of-Design Product: The design for carpet tile is based on product indicated on Drawings in Material Finish Schedule, Material Finish Legend, and Finish Plans. Subject to compliance with requirements, another manufacturer's product of a similar and equivalent nature will be acceptable when, in the Architect's sole judgment rendered

during the Bidding period, differences do not materially detract from the design concept or intended performance.

- B. Fiber Content: 100 percent nylon 6, 6.
- C. Primary Backing/Backcoating: Manufacturer's standard composite materials.
- D. Secondary Backing: Manufacturer's standard material.
- E. Applied Soil-Resistance Treatment: Manufacturer's standard material.
- F. Antimicrobial Treatment: Manufacturer's standard material.
- G. Performance Characteristics: As follows:
  - 1. Appearance Retention Rating: Severe traffic, 3.5 minimum according to ASTM D 7330.
  - 2. Critical Radiant Flux Classification: Not less than 0.45 W/sq. cm.
  - 3. Dry Breaking Strength: Not less than 100 lbf (445 N) according to ASTM D 2646.
  - 4. Tuft Bind: Not less than 8 lbf (36 N) according to ASTM D 1335.
  - Delamination: Not less than 4 lbf/in. (18 N/mm) according to ASTM D 3936.
  - 6. Dimensional Tolerance: Within 1/32 inch (0.8 mm) of specified size dimensions, as determined by physical measurement.
  - 7. Dimensional Stability: 0.2 percent or less according to ISO 2551 (Aachen Test).
  - 8. Resistance to Insects: Comply with AATCC 24.
  - 9. Noise Reduction Coefficient (NRC): according to ASTM C 423.
  - 10. Colorfastness to Crocking: Not less than 4, wet and dry, according to AATCC 165.
  - 11. Colorfastness to Light: Not less than 4 after 60 AFU (AATCC fading units) according to AATCC 16, Option E.
  - 12. Antimicrobial Activity: Not less than 2-mm halo of inhibition for gram-positive bacteria, not less than 1-mm halo of inhibition for gram-negative bacteria, and no fungal growth, according to AATCC 174.
  - 13. Electrostatic Propensity: Less than 3.5 kV according to AATCC 134.
  - 14. Emissions: Provide carpet tile that complies with testing and product requirements of CRI's "Green Label Plus" program.

#### 2.03 INSTALLATION ACCESSORIES

- A. Trowelable Leveling and Patching Compounds: Latex-modified, hydraulic-cement-based formulation provided or recommended by carpet tile manufacturer.
- B. Adhesives: Water-resistant, mildew-resistant, nonstaining, pressure-sensitive type to suit products and subfloor conditions indicated, that complies with flammability requirements for installed carpet tile and is recommended by carpet tile manufacturer for releasable installation.
  - 1. Adhesives shall have a VOC content of 50 g/L or less when calculated according to 40 CFR 59, Subpart D (EPA Method 24).
- C. Metal Edge/Transition Strips: Extruded aluminum with mill finish of profile and width shown, of height required to protect exposed edge of carpet, and of maximum lengths to minimize running joints.

#### PART 3 - EXECUTION

#### 3.01 EXAMINATION

- A. Examine substrates, areas, and conditions, with Installer present, for compliance with requirements for maximum moisture content, alkalinity range, installation tolerances, and other conditions affecting carpet tile performance. Examine carpet tile for type, color, pattern, and potential defects.
- B. Concrete Subfloors: Verify that concrete slabs comply with ASTM F 710 and the following:
  - Slab substrates are dry and free of curing compounds, sealers, hardeners, and other materials that may interfere with adhesive bond. Determine adhesion and dryness characteristics by performing bond and moisture tests recommended by carpet tile manufacturer.
  - 2. Subfloor finishes comply with requirements specified in Section 03 30 00 "Cast-in-Place Concrete" for slabs receiving carpet tile.
  - 3. Subfloors are free of cracks, ridges, depressions, scale, and foreign deposits.
- C. Proceed with installation only after unsatisfactory conditions have been corrected.

#### 3.02 PREPARATION

- A. General: Comply with CRI 104, Section 7.3, "Site Conditions; Floor Preparation," and with carpet tile manufacturer's written installation instructions for preparing substrates indicated to receive carpet tile installation.
- B. Use trowelable leveling and patching compounds, according to manufacturer's written instructions, to fill cracks, holes, depressions, and protrusions in substrates. Fill or level cracks, holes and depressions 1/8 inch (3 mm) wide or wider and protrusions more than 1/32 inch (0.8 mm) unless more stringent requirements are required by manufacturer's written instructions.
- C. Remove coatings, including curing compounds, and other substances that are incompatible with adhesives and that contain soap, wax, oil, or silicone, without using solvents. Use mechanical methods recommended in writing by carpet tile manufacturer.
- D. Broom and vacuum clean substrates to be covered immediately before installing carpet tile.

#### 3.03 INSTALLATION

- A. General: Comply with CRI 104, and with carpet manufacturer's written installation instructions for the following:
  - Direct-Glue-Down Installation: Comply with CRI 104, Section 9, "Direct Glue-Down Installation."
  - Stair Installation: Comply with CRI 104, Section 13, "Carpet on Stairs" for gluedown installation.

- B. Comply with carpet manufacturer's written recommendations and Shop Drawings for seam locations and direction of carpet; maintain uniformity of carpet direction and lay of pile. At doorways, center seams under the door in closed position.
- C. Do not bridge building expansion joints with carpet.
- D. Cut and fit carpet to butt tightly to vertical surfaces, permanent fixtures, and built-in furniture including cabinets, pipes, outlets, edgings, thresholds, and nosings. Bind or seal cut edges as recommended by carpet manufacturer.
- E. Extend carpet into toe spaces, door reveals, closets, open-bottomed obstructions, removable flanges, alcoves, and similar openings.
- F. Maintain reference markers, holes, and openings that are in place or marked for future cutting by repeating on finish flooring as marked on subfloor. Use nonpermanent, nonstaining marking device.
- G. Maintain dye lot integrity. Do not mix dye lots in same area.
- H. Cut and fit carpet tile to butt tightly to vertical surfaces, permanent fixtures, and built-in furniture including cabinets, pipes, outlets, edgings, thresholds, and nosings. Bind or seal cut edges as recommended by carpet tile manufacturer.
- I. Extend carpet tile into toe spaces, door reveals, closets, open-bottomed obstructions, removable flanges, alcoves, and similar openings.
- J. Install pattern parallel to walls and borders.

#### 3.04 CLEANING AND PROTECTION

- A. Perform the following operations immediately after installing carpet tile:
  - 1. Remove excess adhesive, seam sealer, and other surface blemishes using cleaner recommended by carpet tile manufacturer.
  - 2. Remove yarns that protrude from carpet tile surface.
  - Vacuum carpet tile using commercial machine with face-beater element.
- B. Protect installed carpet to comply with CRI 104, Section 16, "Protecting Indoor Installations."
- C. Protect carpet against damage from construction operations and placement of equipment and fixtures during the remainder of construction period. Use protection methods indicated or recommended in writing by carpet tile manufacturer.

#### **END OF SECTION**



#### Solutions by Design Since 1937

Telephone 317.844.6777

9339 Priority Way West Drive, Suite 100, Indianapolis, Indiana 46240

www.cripe.biz

August 19, 2022

**RE:** 2021054 Additions and Renovations Hawthorne Elementary School MSD of Warren Township

#### **Revised items:**

#### Sheet C101:

- 1. Added requirement for contractor to pothole the existing sanitary sewers along the west side of Unit "B" as well as along the north side of the existing building.
- 2. Added the demolition of the existing trees along the west side of Unit "B".
- 3. Added the demolition of the existing sanitary sewer along the west side of Unit "B" after the architect and engineer have reviewed the pothole data.

#### Sheet C401A

1. Revised the limits of the silt fence for the initial phase of the demolition project.

#### Sheet C501:


- 1. Removed the requirement to clean and CCTV the sanitary line directly adjacent to the north side of building the that is to be removed.
- 2. Added the installation of 6" sanitary sewer, five (5) lateral connections and three (3) clean-outs to replace the existing sanitary sewer along the west side of Unit "B" once the existing pothole info form the existing line is reviewed by the architect and engineer.


Sincerely,

#### **CRIPE** | Engineering

David Kuehnen, PE Senior Design Engineer

Cc: O:\2020\200085\20000\Docs\Engr\Addenda\2022-08-19\_Addendum #03\2022-08-19\_Addendum #03\_Cripe.docx

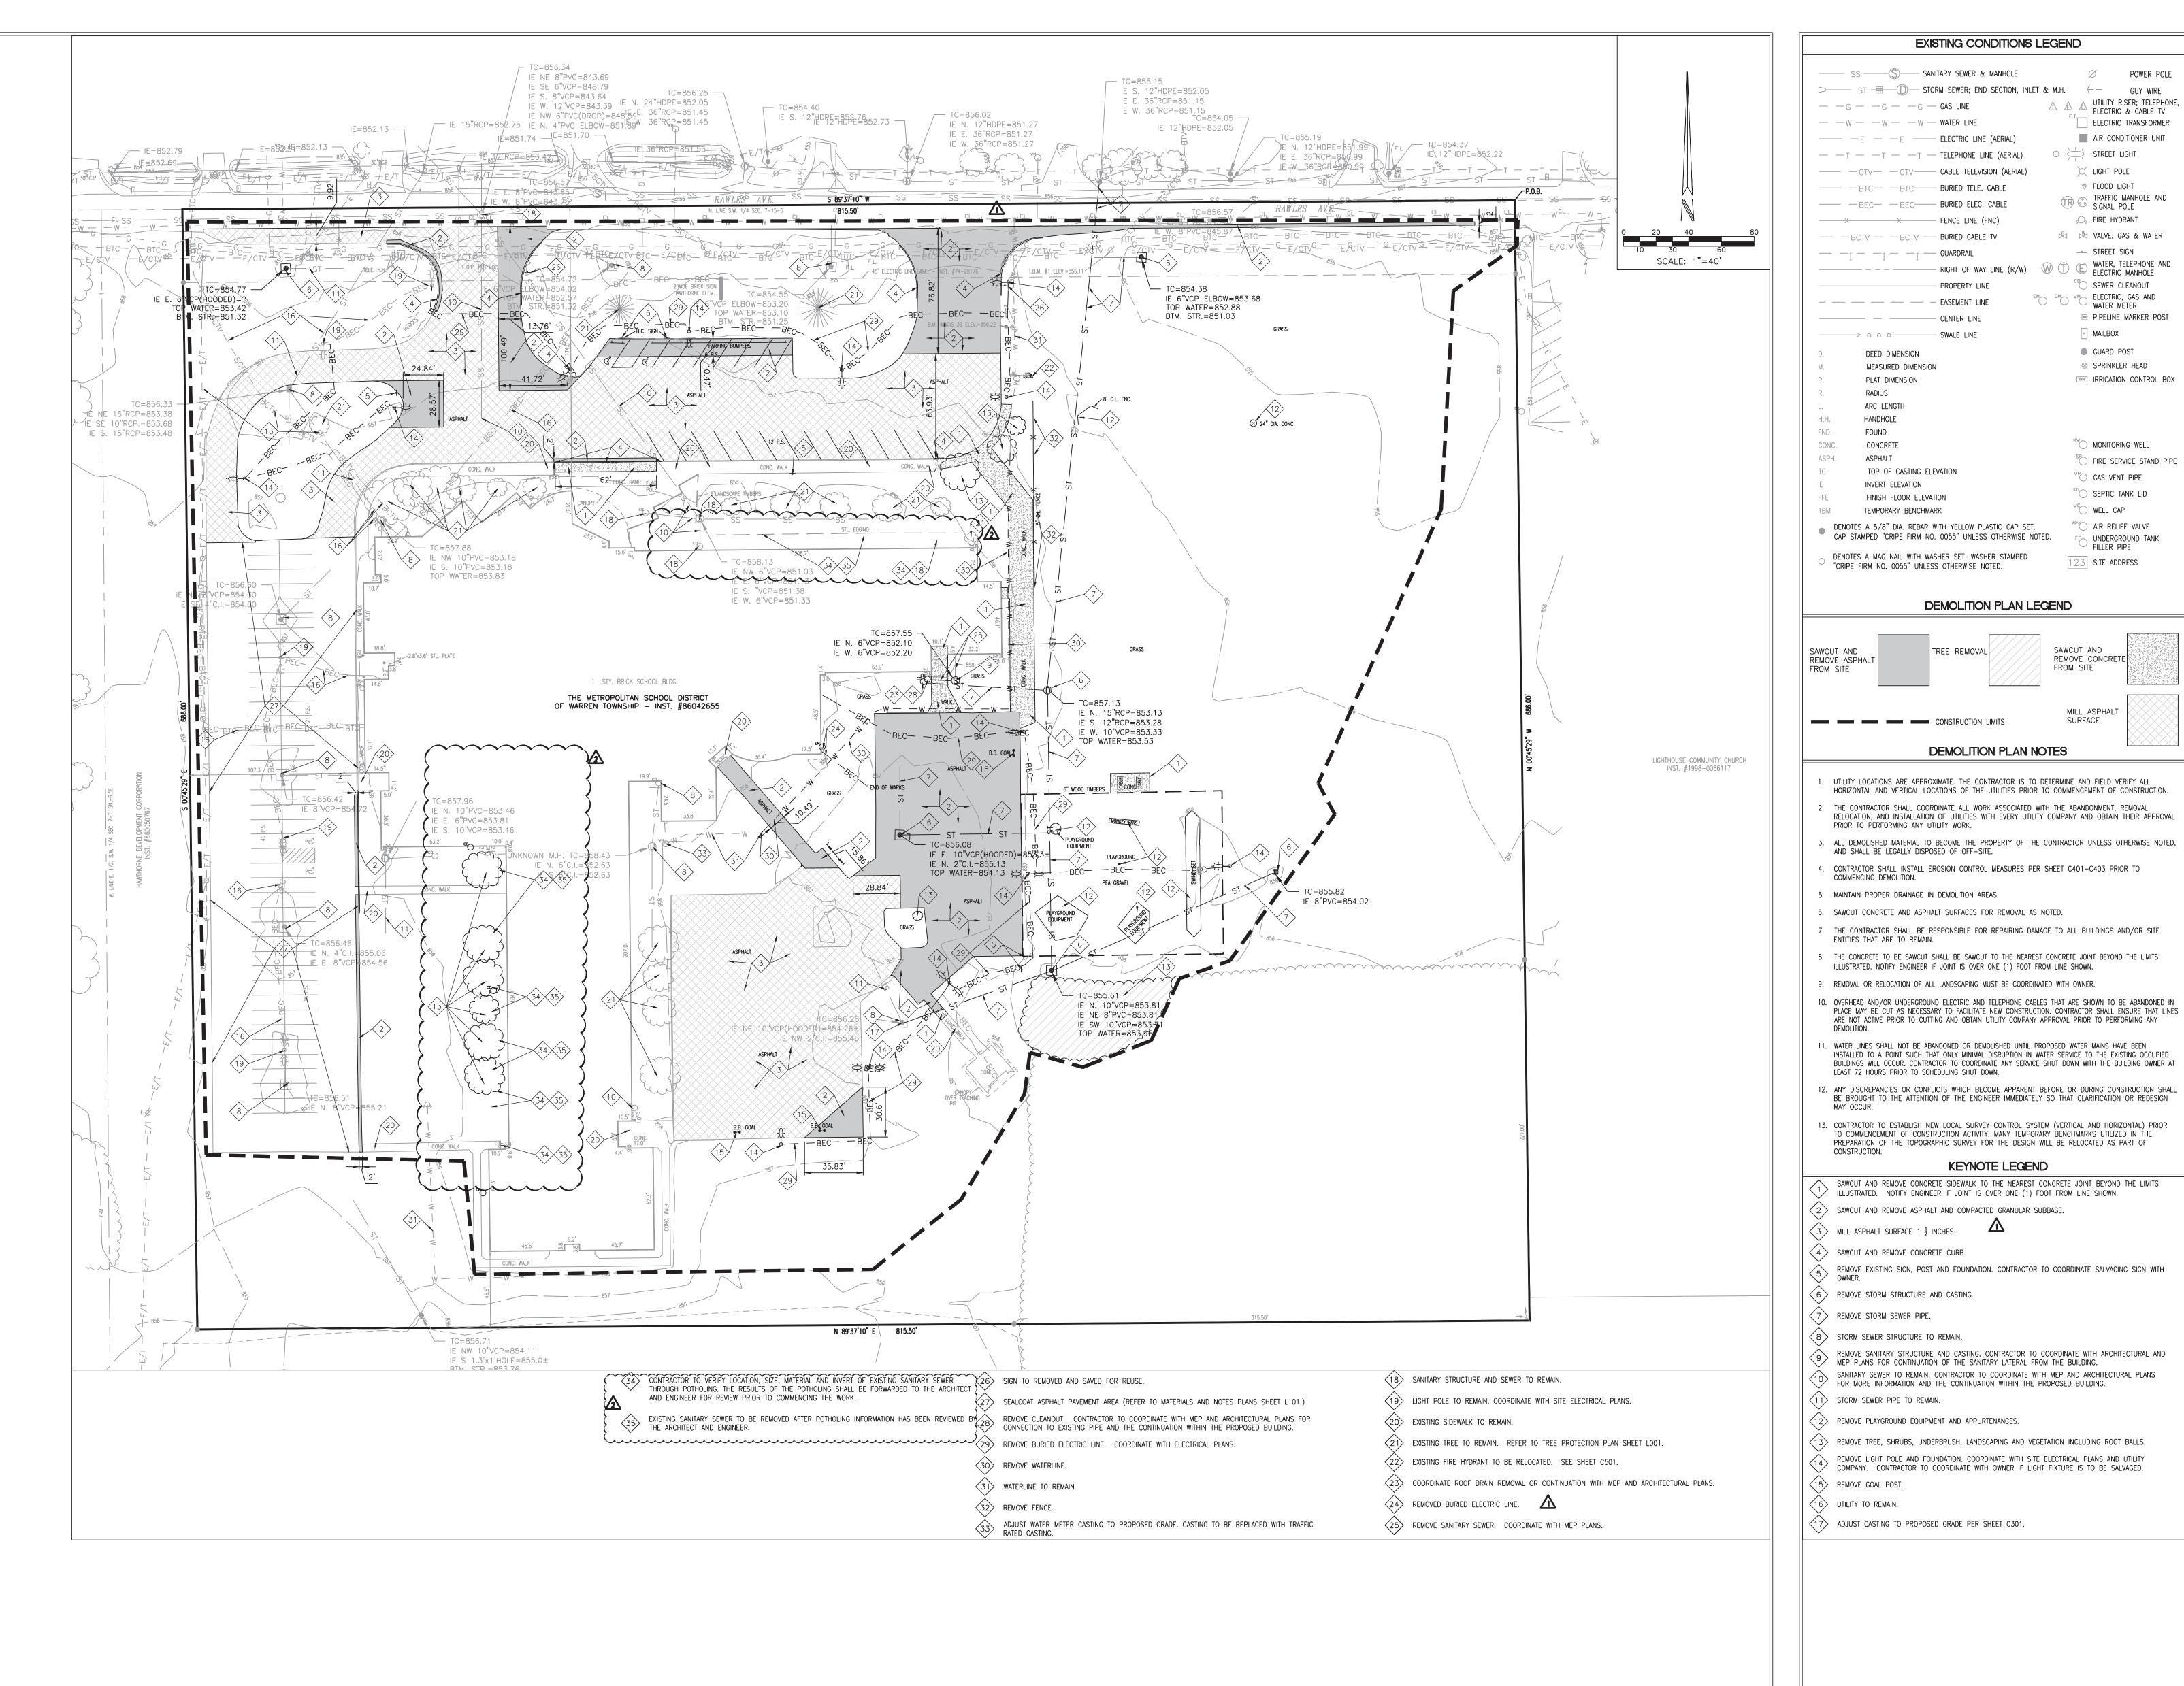

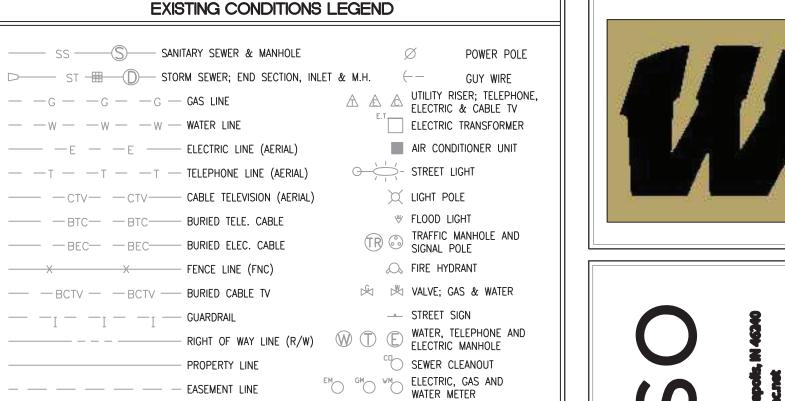

PIPELINE MARKER POST

IRRIGATION CONTROL BOX

MAILBOX

GUARD POST

⊗ SPRINKLER HEAD

MONITORING WELL

<sup>∨</sup>C GAS VENT PIPE SEPTIC TANK LID

AR RELIEF VALVE

FILLER PIPE

123 SITE ADDRESS

SAWCUT AND

FROM SITE

REMOVE CONCRETE

MILL ASPHALT

SURFACE

DEMOLITION PLAN LEGEND

DEMOLITION PLAN NOTES

KEYNOTE LEGEND

TREE REMOVAL

UNDERGROUND TANK

₩ELL CAP

FIRE SERVICE STAND PIPE



HORNE


SCOPE DRAWINGS: These drawings indicate the general scope of the terms of site design concept, the dimensions of the site, the major sitel elements and the type site utility and drainage systems.

The drawings do not necessarily indicate or describe all


**REVISIONS:** REV 01 ADDENDUM #02 08/10/22 REV 02 ADDENDUM #03 08/19/22

ISSUE DATE | DRAWN BY | CHECKED BY 2022-06-27 D.KUEHNEN S.PIERRE

**DRAWING TITLE: EXISTING** 

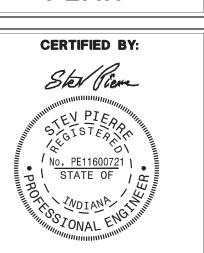

DRAWING NUMBER

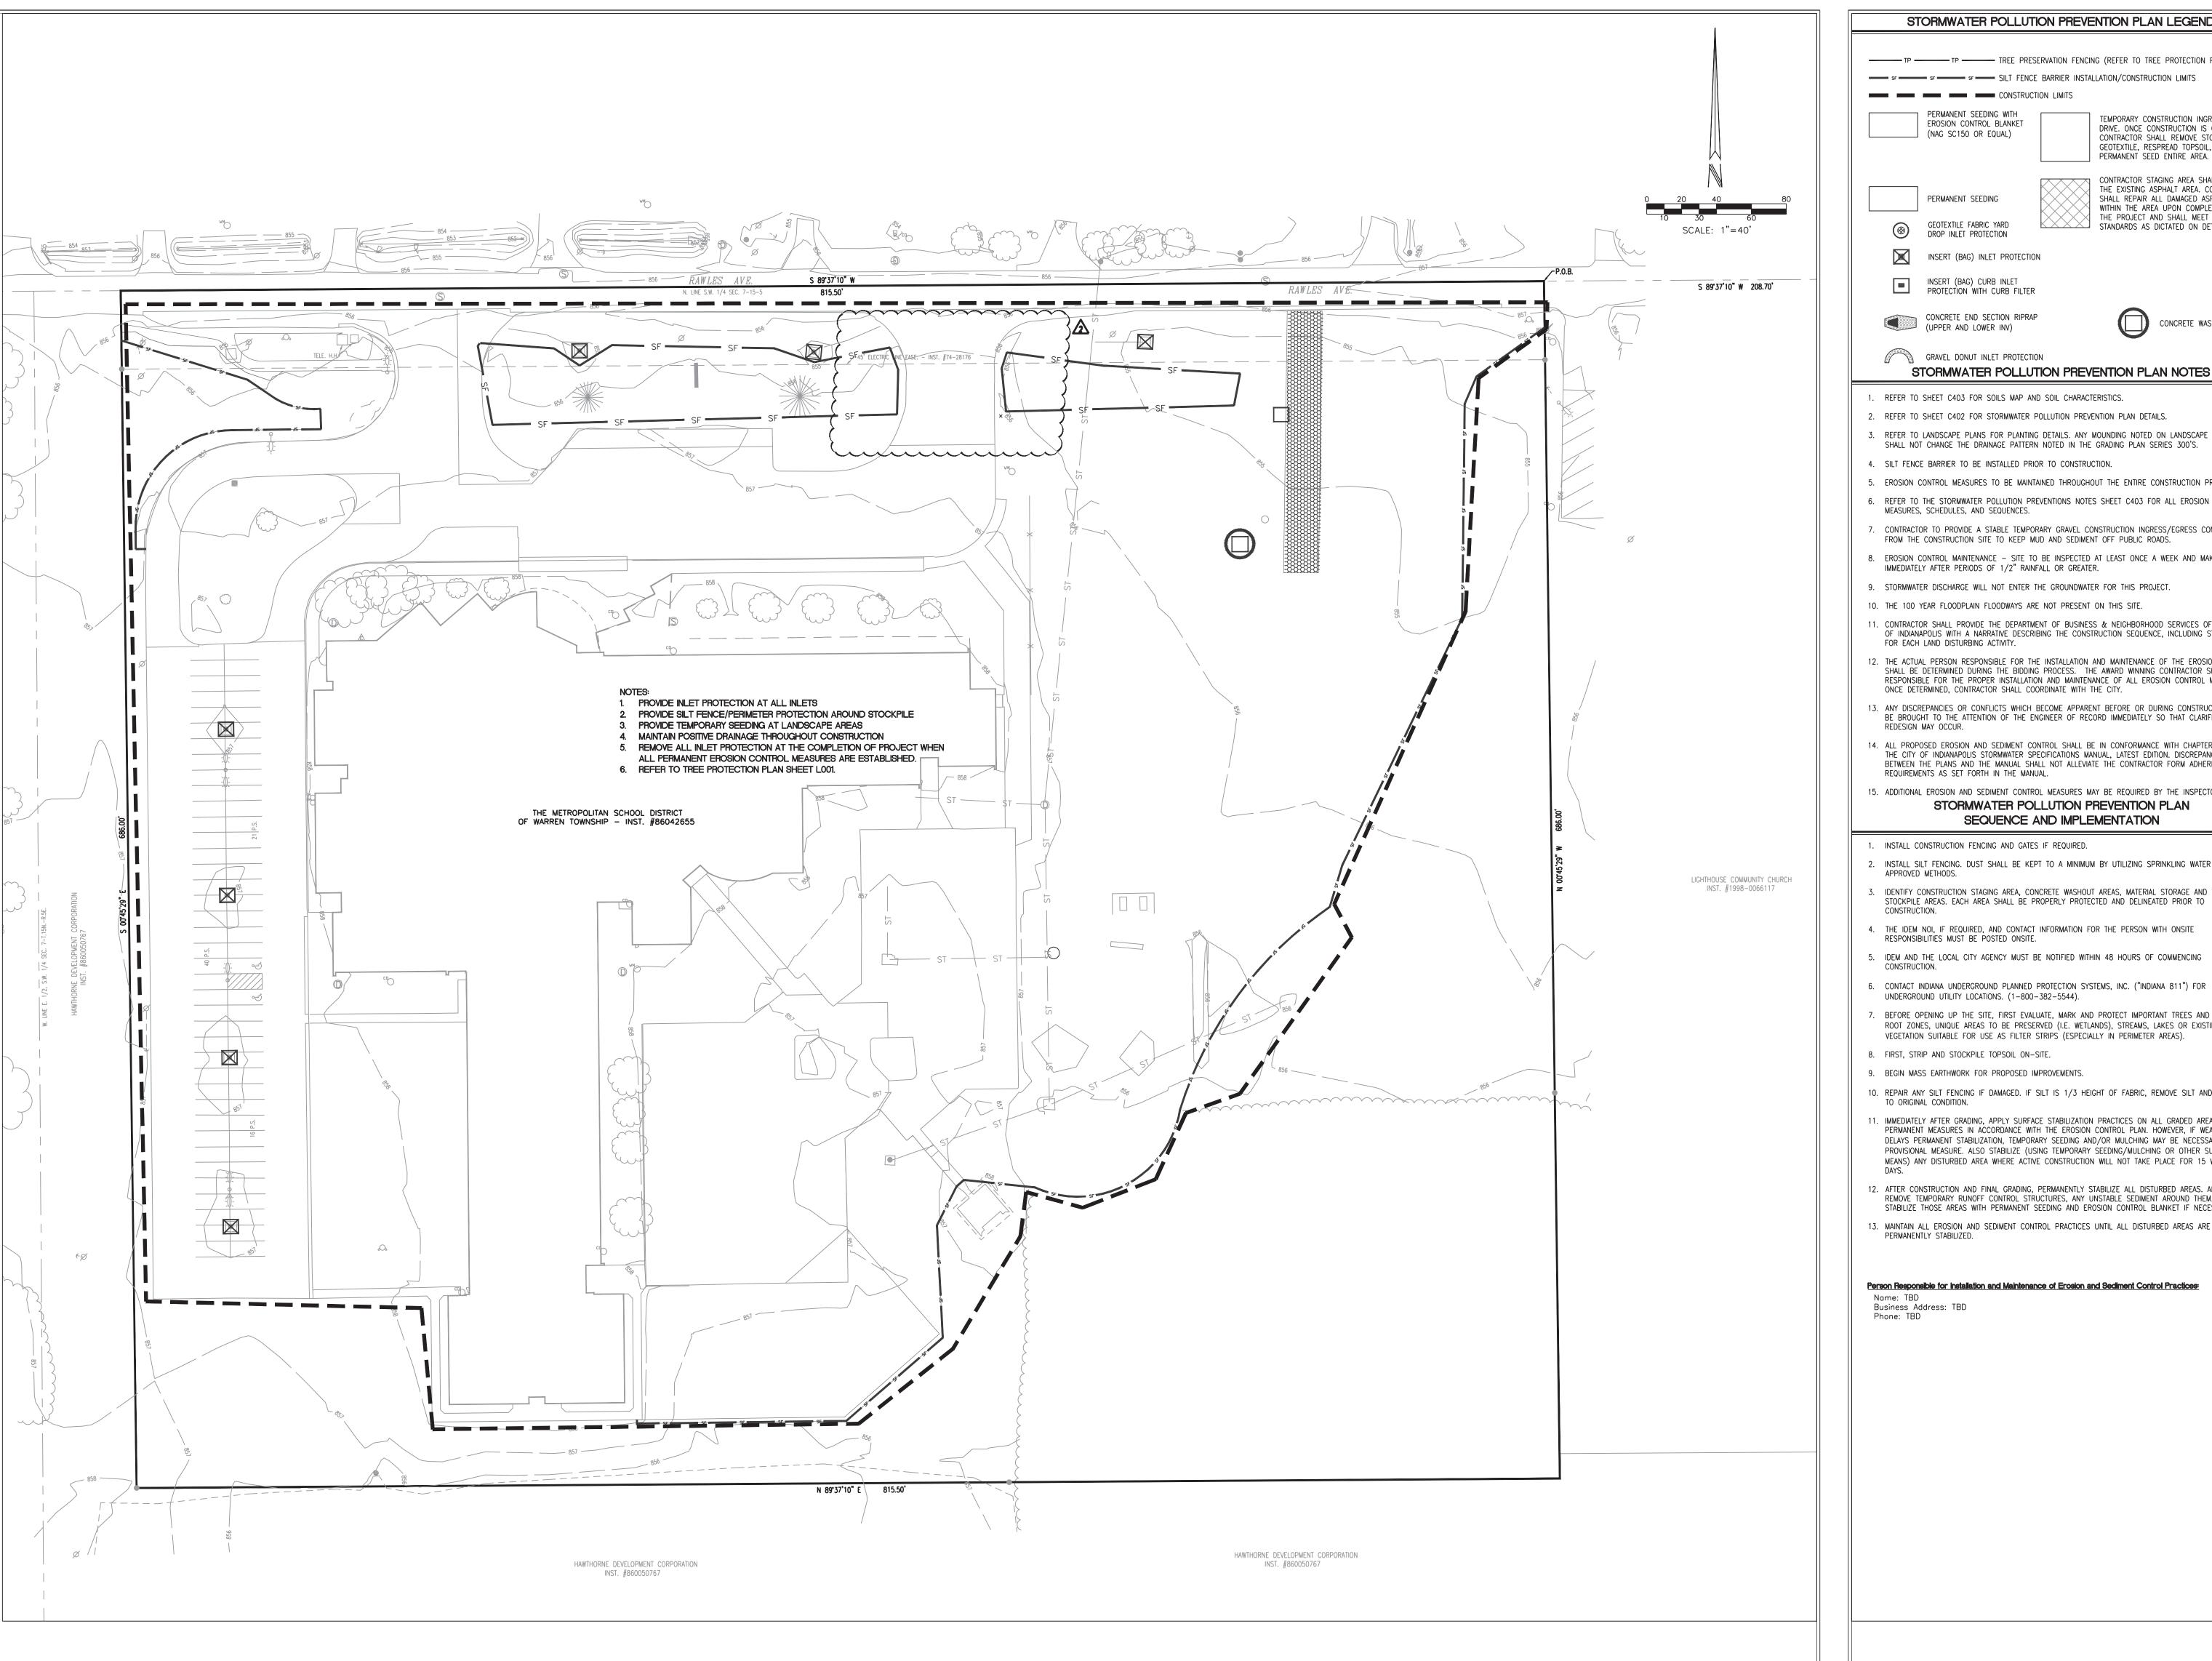

STORMWATER POLLUTION PREVENTION PLAN LEGEND

TP TP TP TREE PRESERVATION FENCING (REFER TO TREE PROTECTION PLAN.) sf sf sf sf SILT FENCE BARRIER INSTALLATION/CONSTRUCTION LIMITS

PERMANENT SEEDING WITH EROSION CONTROL BLANKET \_\_\_\_\_ (NAG SC150 OR EQUAL)

TEMPORARY CONSTRUCTION INGREES/EGRESS DRIVE. ONCE CONSTRUCTION IS COMPLETE, CONTRACTOR SHALL REMOVE STONE, GEOTEXTILE, RESPREAD TOPSOIL, AND PERMANENT SEED ENTIRE AREA.

PERMANENT SEEDING GEOTEXTILE FABRIC YARD

CONTRACTOR STAGING AREA SHALL UTILIZE THE EXISTING ASPHALT AREA. CONTRACTOR SHALL REPAIR ALL DAMAGED ASPHALT WITHIN THE AREA UPON COMPLETION OF THE PROJECT AND SHALL MEET THE STANDARDS AS DICTATED ON DETAILS.

INSERT (BAG) INLET PROTECTION

DROP INLET PROTECTION

INSERT (BAG) CURB INLE:
PROTECTION WITH CURB FILTER CONCRETE END SECTION RIPRAP
(UPPER AND LOWER INV)



GRAVEL DONUT INLET PROTECTION STORMWATER POLLUTION PREVENTION PLAN NOTES

1. REFER TO SHEET C403 FOR SOILS MAP AND SOIL CHARACTERISTICS.

- 3. REFER TO LANDSCAPE PLANS FOR PLANTING DETAILS. ANY MOUNDING NOTED ON LANDSCAPE PLANS SHALL NOT CHANGE THE DRAINAGE PATTERN NOTED IN THE GRADING PLAN SERIES 300'S.
- 4. SILT FENCE BARRIER TO BE INSTALLED PRIOR TO CONSTRUCTION.
- 5. EROSION CONTROL MEASURES TO BE MAINTAINED THROUGHOUT THE ENTIRE CONSTRUCTION PROCESS. 6. REFER TO THE STORMWATER POLLUTION PREVENTIONS NOTES SHEET C403 FOR ALL EROSION CONTROL MEASURES, SCHEDULES, AND SEQUENCES.
- . CONTRACTOR TO PROVIDE A STABLE TEMPORARY GRAVEL CONSTRUCTION INGRESS/EGRESS CONDITION FROM THE CONSTRUCTION SITE TO KEEP MUD AND SEDIMENT OFF PUBLIC ROADS.
- 8. EROSION CONTROL MAINTENANCE SITE TO BE INSPECTED AT LEAST ONCE A WEEK AND MAKE REPAIRS IMMEDIATELY AFTER PERIODS OF 1/2" RAINFALL OR GREATER.
- 9. STORMWATER DISCHARGE WILL NOT ENTER THE GROUNDWATER FOR THIS PROJECT.
- 10. THE 100 YEAR FLOODPLAIN FLOODWAYS ARE NOT PRESENT ON THIS SITE.
- 11. CONTRACTOR SHALL PROVIDE THE DEPARTMENT OF BUSINESS & NEIGHBORHOOD SERVICES OF THE CITY OF INDIANAPOLIS WITH A NARRATIVE DESCRIBING THE CONSTRUCTION SEQUENCE, INCLUDING START DATES FOR EACH LAND DISTURBING ACTIVITY.
- 12. THE ACTUAL PERSON RESPONSIBLE FOR THE INSTALLATION AND MAINTENANCE OF THE EROSION CONTROL SHALL BE DETERMINED DURING THE BIDDING PROCESS. THE AWARD WINNING CONTRACTOR SHALL BE RESPONSIBLE FOR THE PROPER INSTALLATION AND MAINTENANCE OF ALL EROSION CONTROL MEASURES. ONCE DETERMINED, CONTRACTOR SHALL COORDINATE WITH THE CITY.
- 13. ANY DISCREPANCIES OR CONFLICTS WHICH BECOME APPARENT BEFORE OR DURING CONSTRUCTION SHALL BE BROUGHT TO THE ATTENTION OF THE ENGINEER OF RECORD IMMEDIATELY SO THAT CLARIFICATION OR
- 14. ALL PROPOSED EROSION AND SEDIMENT CONTROL SHALL BE IN CONFORMANCE WITH CHAPTER 600 OF THE CITY OF INDIANAPOLIS STORMWATER SPECIFICATIONS MANUAL, LATEST EDITION. DISCREPANCIES BETWEEN THE PLANS AND THE MANUAL SHALL NOT ALLEVIATE THE CONTRACTOR FORM ADHERING TO THE REQUIREMENTS AS SET FORTH IN THE MANUAL.

15. ADDITIONAL EROSION AND SEDIMENT CONTROL MEASURES MAY BE REQUIRED BY THE INSPECTOR. STORMWATER POLLUTION PREVENTION PLAN SEQUENCE AND IMPLEMENTATION

- 1. INSTALL CONSTRUCTION FENCING AND GATES IF REQUIRED.
- 2. INSTALL SILT FENCING. DUST SHALL BE KEPT TO A MINIMUM BY UTILIZING SPRINKLING WATER OR OTHER APPROVED METHODS.
- . IDENTIFY CONSTRUCTION STAGING AREA, CONCRETE WASHOUT AREAS, MATERIAL STORAGE AND TOPSOIL STOCKPILE AREAS. EACH AREA SHALL BE PROPERLY PROTECTED AND DELINEATED PRIOR TO
- 4. THE IDEM NOI, IF REQUIRED, AND CONTACT INFORMATION FOR THE PERSON WITH ONSITE RESPONSIBILITIES MUST BE POSTED ONSITE.
- 5. IDEM AND THE LOCAL CITY AGENCY MUST BE NOTIFIED WITHIN 48 HOURS OF COMMENCING CONSTRUCTION.
- UNDERGROUND UTILITY LOCATIONS. (1-800-382-5544). 7. BEFORE OPENING UP THE SITE, FIRST EVALUATE, MARK AND PROTECT IMPORTANT TREES AND ASSOCIATED
- ROOT ZONES, UNIQUE AREAS TO BE PRESERVED (I.E. WETLANDS), STREAMS, LAKES OR EXISTING VEGETATION SUITABLE FOR USE AS FILTER STRIPS (ESPECIALLY IN PERIMETER AREAS).
- 8. FIRST, STRIP AND STOCKPILE TOPSOIL ON-SITE.
- 9. BEGIN MASS EARTHWORK FOR PROPOSED IMPROVEMENTS.
- 10. REPAIR ANY SILT FENCING IF DAMAGED. IF SILT IS 1/3 HEIGHT OF FABRIC, REMOVE SILT AND REPLACE TO ORIGINAL CONDITION.
- 1. IMMEDIATELY AFTER GRADING, APPLY SURFACE STABILIZATION PRACTICES ON ALL GRADED AREAS, USING PERMANENT MEASURES IN ACCORDANCE WITH THE EROSION CONTROL PLAN. HOWEVER, IF WEATHER DELAYS PERMANENT STABILIZATION, TEMPORARY SEEDING AND/OR MULCHING MAY BE NECESSARY AS A PROVISIONAL MEASURE. ALSO STABILIZE (USING TEMPORARY SEEDING/MULCHING OR OTHER SUITABLE MEANS) ANY DISTURBED AREA WHERE ACTIVE CONSTRUCTION WILL NOT TAKE PLACE FOR 15 WORKING
- 12. AFTER CONSTRUCTION AND FINAL GRADING, PERMANENTLY STABILIZE ALL DISTURBED AREAS. ALSO REMOVE TEMPORARY RUNOFF CONTROL STRUCTURES, ANY UNSTABLE SEDIMENT AROUND THEM, AND
- STABILIZE THOSE AREAS WITH PERMANENT SEEDING AND EROSION CONTROL BLANKET IF NECESSARY. 13. MAINTAIN ALL EROSION AND SEDIMENT CONTROL PRACTICES UNTIL ALL DISTURBED AREAS ARE PERMANENTLY STABILIZED.

Person Responsible for Installation and Maintenance of Erosion and Sediment Control Practices:





ADDITION HORNE

SCOPE DRAWINGS: These drawings indicate the general scope of the in terms of site design concept, the dimensions of the site, the major sitel elements and the type of site, the inajor site reterients and the type of site utility and drainage systems.

The drawings do not necessarily indicate or describe all work required for full performance and completion of the requirements of the Contract.

On the basis of the general scope indicated or described the trade contractors shall furnish all items required for the proper execution and completion of the work.

**REVISIONS:** REV 01 ADDENDUM #01 08/03/22 REV 02 ADDENDUM #03 08/19/22

ISSUE DATE | DRAWN BY | CHECKED BY


2022-06-27 D.KUEHNEN S.PIERRE

**DRAWING TITLE:** STORMWATER **POLLUTION PREVENTION** PLAN

**CERTIFIED BY:** 

DRAWING NUMBER C401A

PROJECT NUMBER CRIPE No. 200085-20000

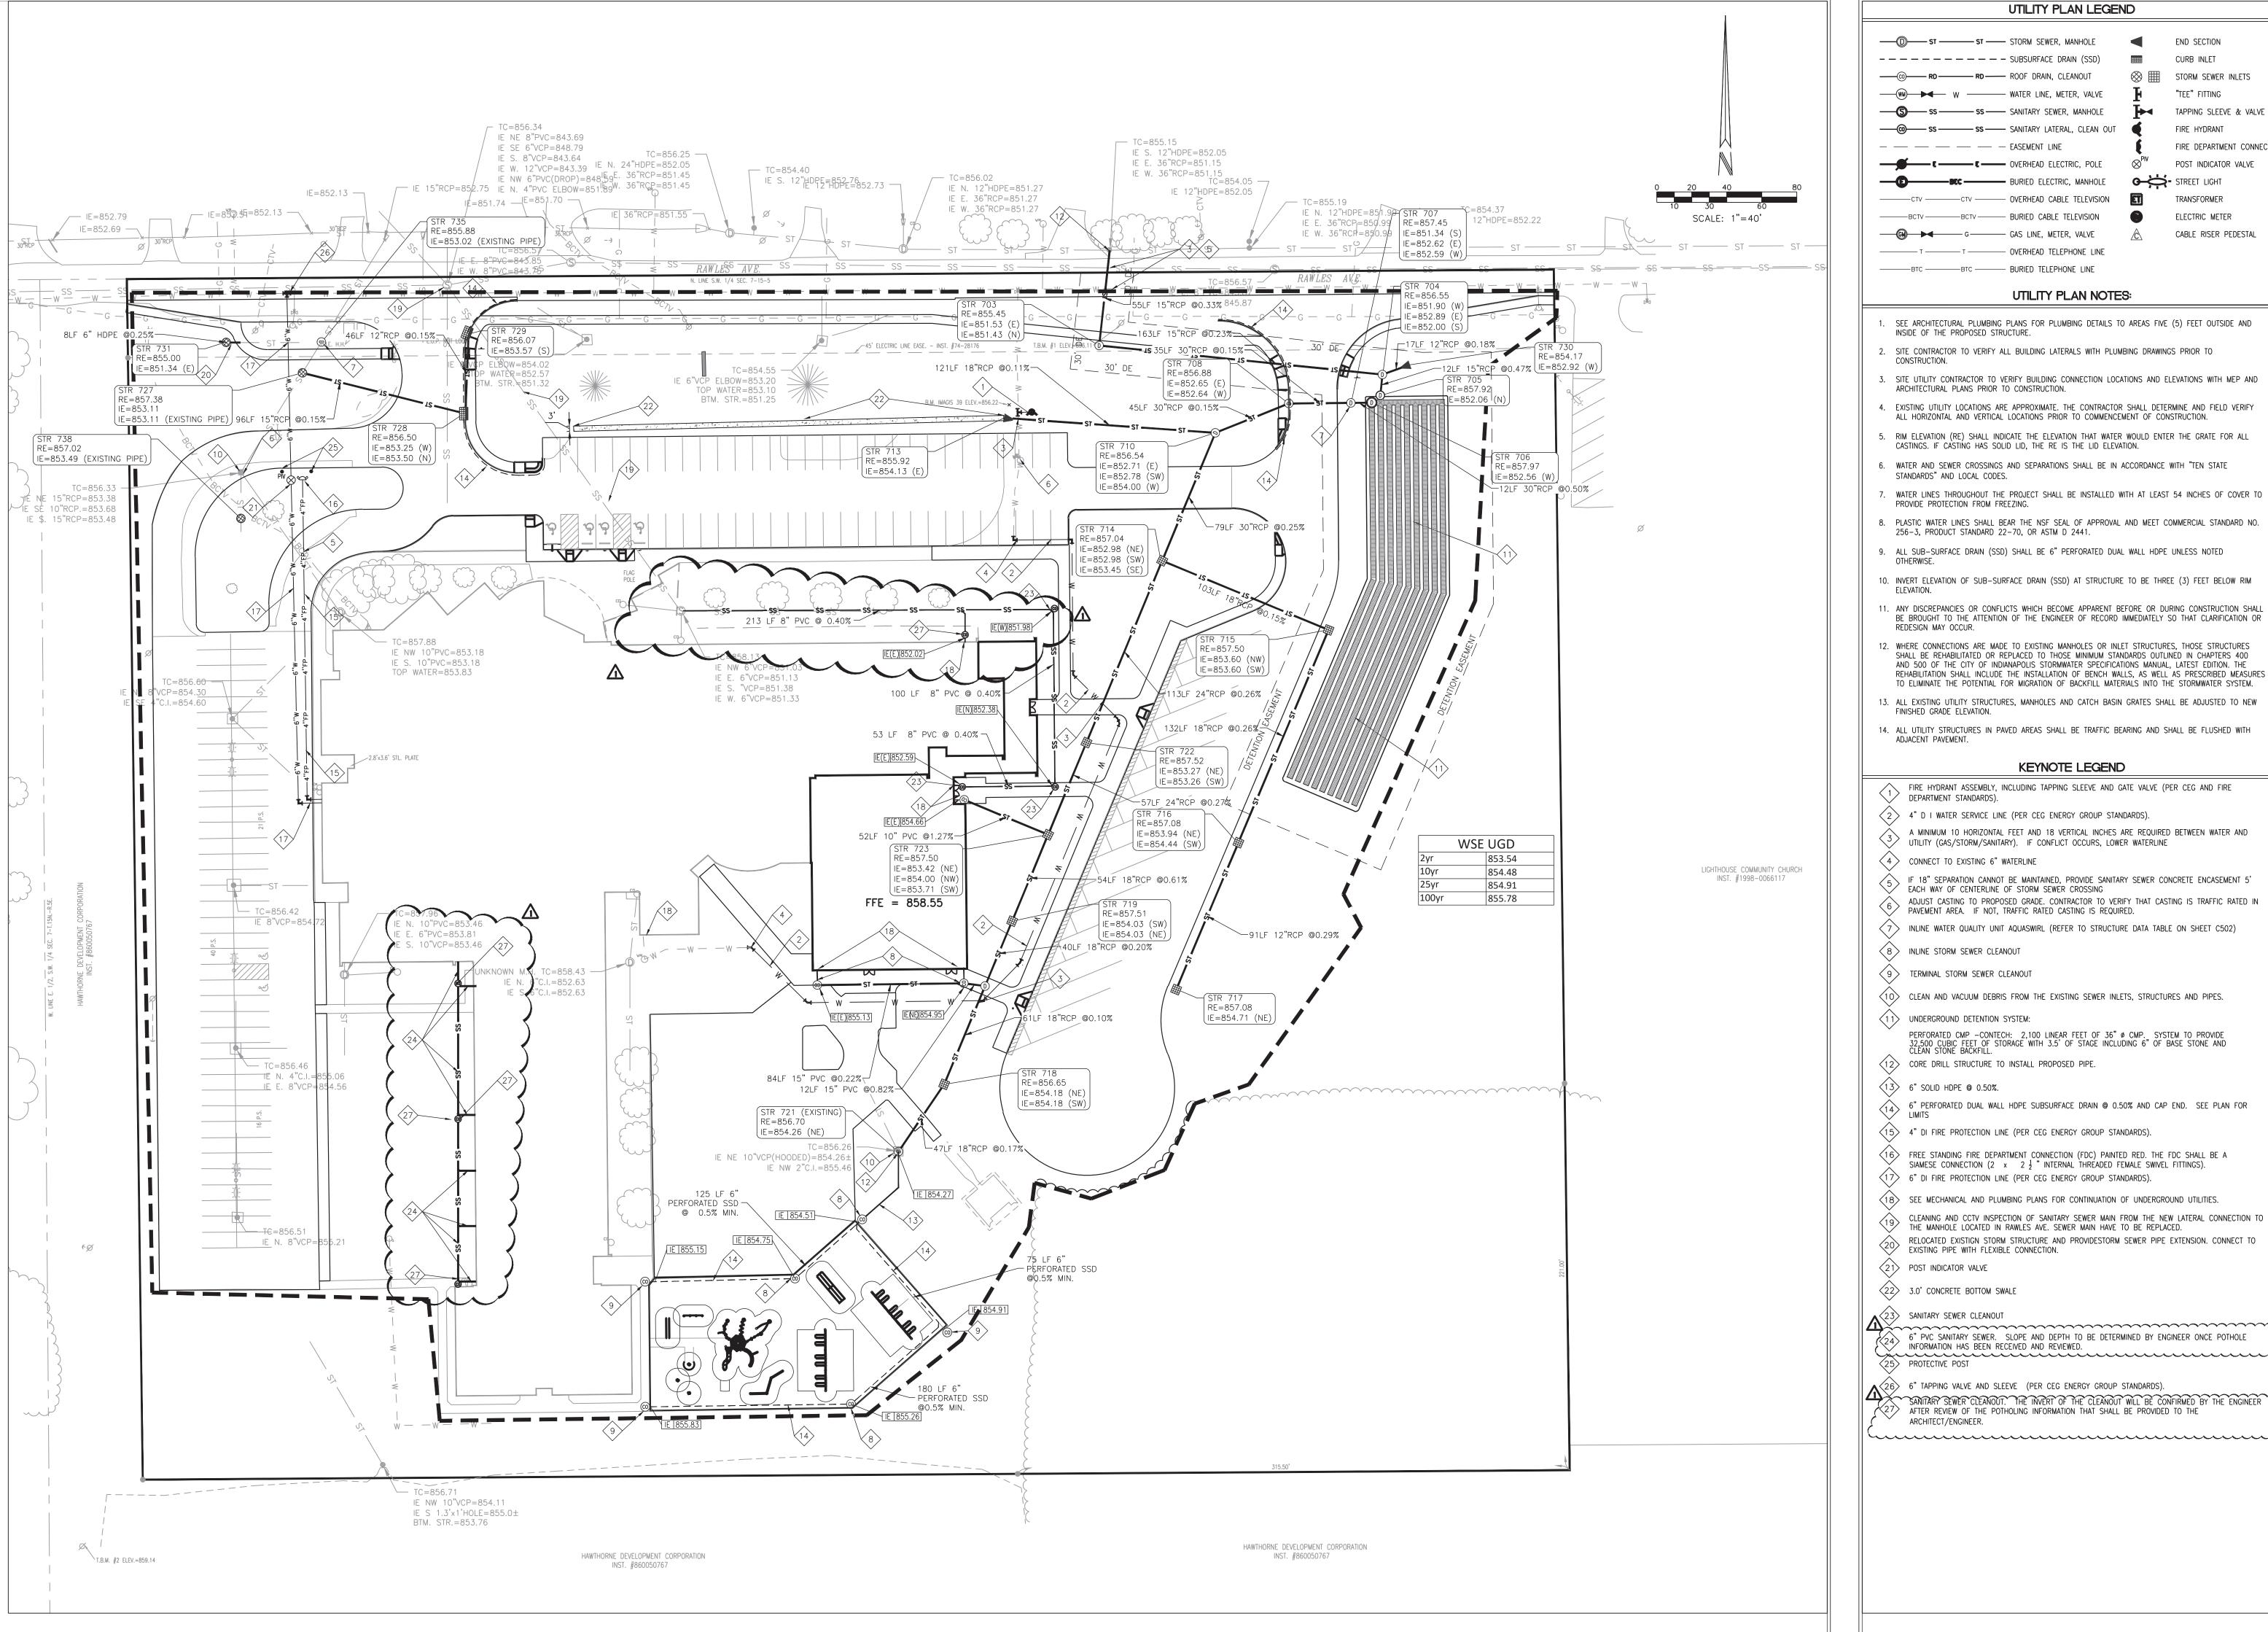

## UTILITY PLAN LEGEND

---- SUBSURFACE DRAIN (SSD) STORM SEWER INLETS — — — — — EASEMENT LINE OVERHEAD ELECTRIC, POLE

TAPPING SLEEVE & VALVE FIRE DEPARTMENT CONNECTION POST INDICATOR VALVE TRANSFORMER ELECTRIC METER

END SECTION

CURB INLET

"TEE" FITTING

BCTV BCTV BURIED CABLE TELEVISION GM → G GAS LINE, METER, VALVE CABLE RISER PEDESTAL 


## **UTILITY PLAN NOTES:**

- SEE ARCHITECTURAL PLUMBING PLANS FOR PLUMBING DETAILS TO AREAS FIVE (5) FEET OUTSIDE AND INSIDE OF THE PROPOSED STRUCTURE.
- 2. SITE CONTRACTOR TO VERIFY ALL BUILDING LATERALS WITH PLUMBING DRAWINGS PRIOR TO CONSTRUCTION.
- 3. SITE UTILITY CONTRACTOR TO VERIFY BUILDING CONNECTION LOCATIONS AND ELEVATIONS WITH MEP AND ARCHITECTURAL PLANS PRIOR TO CONSTRUCTION.
- 4. EXISTING UTILITY LOCATIONS ARE APPROXIMATE. THE CONTRACTOR SHALL DETERMINE AND FIELD VERIFY ALL HORIZONTAL AND VERTICAL LOCATIONS PRIOR TO COMMENCEMENT OF CONSTRUCTION.
- 5. RIM ELEVATION (RE) SHALL INDICATE THE ELEVATION THAT WATER WOULD ENTER THE GRATE FOR ALL CASTINGS. IF CASTING HAS SOLID LID, THE RE IS THE LID ELEVATION.
- 6. WATER AND SEWER CROSSINGS AND SEPARATIONS SHALL BE IN ACCORDANCE WITH "TEN STATE STANDARDS" AND LOCAL CODES.
- WATER LINES THROUGHOUT THE PROJECT SHALL BE INSTALLED WITH AT LEAST 54 INCHES OF COVER TO PROVIDE PROTECTION FROM FREEZING.
- 8. PLASTIC WATER LINES SHALL BEAR THE NSF SEAL OF APPROVAL AND MEET COMMERCIAL STANDARD NO. 256-3, PRODUCT STANDARD 22-70, OR ASTM D 2441.
- 9. ALL SUB-SURFACE DRAIN (SSD) SHALL BE 6" PERFORATED DUAL WALL HDPE UNLESS NOTED
- 10. INVERT ELEVATION OF SUB-SURFACE DRAIN (SSD) AT STRUCTURE TO BE THREE (3) FEET BELOW RIM
- REDESIGN MAY OCCUR. 12. WHERE CONNECTIONS ARE MADE TO EXISTING MANHOLES OR INLET STRUCTURES, THOSE STRUCTURES SHALL BE REHABILITATED OR REPLACED TO THOSE MINIMUM STANDARDS OUTLINED IN CHAPTERS 400 AND 500 OF THE CITY OF INDIANAPOLIS STORMWATER SPECIFICATIONS MANUAL, LATEST EDITION. THE
- REHABILITATION SHALL INCLUDE THE INSTALLATION OF BENCH WALLS, AS WELL AS PRESCRIBED MEASURES TO ELIMINATE THE POTENTIAL FOR MIGRATION OF BACKFILL MATERIALS INTO THE STORMWATER SYSTEM. 13. ALL EXISTING UTILITY STRUCTURES, MANHOLES AND CATCH BASIN GRATES SHALL BE ADJUSTED TO NEW FINISHED GRADE ELEVATION.
- 14. ALL UTILITY STRUCTURES IN PAVED AREAS SHALL BE TRAFFIC BEARING AND SHALL BE FLUSHED WITH ADJACENT PAVEMENT.

### KEYNOTE LEGEND

- FIRE HYDRANT ASSEMBLY, INCLUDING TAPPING SLEEVE AND GATE VALVE (PER CEG AND FIRE DEPARTMENT STANDARDS).
- (2) 4" D I WATER SERVICE LINE (PER CEG ENERGY GROUP STANDARDS).
- A MINIMUM 10 HORIZONTAL FEET AND 18 VERTICAL INCHES ARE REQUIRED BETWEEN WATER AND UTILITY (GAS/STORM/SANITARY). IF CONFLICT OCCURS, LOWER WATERLINE
- 4 CONNECT TO EXISTING 6" WATERLINE
- IF 18" SEPARATION CANNOT BE MAINTAINED, PROVIDE SANITARY SEWER CONCRETE ENCASEMENT 5' EACH WAY OF CENTERLINE OF STORM SEWER CROSSING ADJUST CASTING TO PROPOSED GRADE. CONTRACTOR TO VERIFY THAT CASTING IS TRAFFIC RATED IN
- PAVEMENT AREA. IF NOT, TRAFFIC RATED CASTING IS REQUIRED. 7 INLINE WATER QUALITY UNIT AQUASWIRL (REFER TO STRUCTURE DATA TABLE ON SHEET C502)
- (8) INLINE STORM SEWER CLEANOUT
- (9) TERMINAL STORM SEWER CLEANOUT
- (10) CLEAN AND VACUUM DEBRIS FROM THE EXISTING SEWER INLETS, STRUCTURES AND PIPES.
- (1 1) UNDERGROUND DETENTION SYSTEM:
- PERFORATED CMP —CONTECH: 2,100 LINEAR FEET OF 36" Ø CMP. SYSTEM TO PROVIDE 32,500 CUBIC FEET OF STORAGE WITH 3.5' OF STAGE INCLUDING 6" OF BASE STONE AND CLEAN STONE BACKFILL. (12) CORE DRILL STRUCTURE TO INSTALL PROPOSED PIPE.
- (13) 6" SOLID HDPE @ 0.50%.
- 6" PERFORATED DUAL WALL HDPE SUBSURFACE DRAIN @ 0.50% AND CAP END. SEE PLAN FOR
- (15) 4" DI FIRE PROTECTION LINE (PER CEG ENERGY GROUP STANDARDS). (16) FREE STANDING FIRE DEPARTMENT CONNECTION (FDC) PAINTED RED. THE FDC SHALL BE A
- SIAMESE CONNECTION (2 x 2  $\frac{1}{2}$  " INTERNAL THREADED FEMALE SWIVEL FITTINGS). (17) 6" DI FIRE PROTECTION LINE (PER CEG ENERGY GROUP STANDARDS).
- (18) SEE MECHANICAL AND PLUMBING PLANS FOR CONTINUATION OF UNDERGROUND UTILITIES.
- CLEANING AND CCTV INSPECTION OF SANITARY SEWER MAIN FROM THE NEW LATERAL CONNECTION TO THE MANHOLE LOCATED IN RAWLES AVE. SEWER MAIN HAVE TO BE REPLACED.
- RELOCATED EXISTIGN STORM STRUCTURE AND PROVIDESTORM SEWER PIPE EXTENSION. CONNECT TO EXISTING PIPE WITH FLEXIBLE CONNECTION.
- (21) POST INDICATOR VALVE
- (22) 3.0' CONCRETE BOTTOM SWALE
- 23 SANITARY SEWER CLEANOUT Δ<u>γ</u> 6" PVC SANITARY SEWER. SLOPE AND DEPTH TO BE DETERMINED BY ENGINEER ONCE POTHOLE INFORMATION HAS BEEN RECEIVED AND REVIEWED.
- (25) PROTECTIVE POST 26> 6" TAPPING VALVE AND SLEEVE (PER CEG ENERGY GROUP STANDARDS).
- SANITARY SEWER CLEANOUT. THE INVERT OF THE CLEANOUT WILL BE CONFIRMED BY THE ENGINEER AFTER REVIEW OF THE POTHOLING INFORMATION THAT SHALL BE PROVIDED TO THE



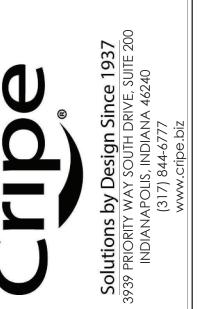

ADDITION **ARY** HORNE

SCOPE DRAWINGS: These drawings indicate the general scope of the in terms of site design concept, the dimensions of the site, the major sitel elements and the type of site utility and drainage systems.

The drawings do not necessarily indicate or describe all the trade contractors shall furnish all items required for the proper execution and completion of the work.


REV 01 ADDENDUM #03 08/19/22

**REVISIONS:** 

ISSUE DATE | DRAWN BY | CHECKED BY

2022-06-27 D.KUEHNEN S.PIERRE

**DRAWING TITLE:** UTILITY PLAN

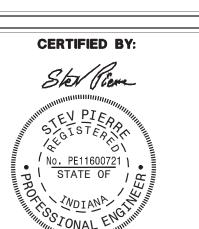

DRAWING NUMBER

PROJECT NUMBER CRIPE No. 200085-20000 August 6, 2020

Mr. Cameron Hull Senior Associate Context LLC 5825 Lawton Loop East Drive Indianapolis, IN 46216



#### **ADDENDUM NO: 3**

PROJECT: Hawthorne Elementary School Renovation & Addition

PROJECT NO: 2021054 DATE: August 19, 2022

This Addendum is issued in accordance with the provisions of "The General Conditions of the Contract for Construction," Article 1, "Contract Documents" and becomes a part of the Contract Documents as provided therein. This Addendum includes:

Attached Documents: L050, L103, L113

#### **PART 0 - GENERAL INFORMATION**

#### **PART 1 - BIDDING REQUIREMENTS**

#### **PART 2 - SPECIFICATIONS**

#### **PART 3 - DRAWINGS**

- 3.1 SHEET L050 TREE PROTECTION AND DEMOLITION PLAN
  - A. Additional Tree Demolition has been added.
- 3.2 SHEET L103 SITE MATERIALS PLAN
  - A. Additional concrete sidewalk replacement has been added.
- 3.3 SHEET L113
  - A. Layout of new concrete addition as been added.

#### **QUESTION AND ANSWER**

#### **END ADDENDUM**



PROTECTION AND DEMOLITION **PLAN** 

CERTIFIED BY: No. STATE OF TO NOIANA LE Fred A. Associa EXPIRES 12-31-2023

> DRAWING NUMBER L050

> > PROJECT NUMBER 2021054



# TREE PRESERVATION LEGEND Tree to be Protected



Tree Protection Fence Locations -

To be installed PRIOR TO DEMOLITION, Refer to Detail on this Sheet — — — Protected Root Zone

## TREE PROTECTION GENERAL NOTES

- Underground utilities, if shown, are based on above ground indications and construction drawings. There is no guarantee that all underground utilities in service or abandoned are shown. Underground utilities are shown as accurately as possible but still may not be exact. No physical underground utility locations were made.
- Contractor to review all trees to be removed on site with Landscape Architect or Owner's Representative prior to demolition.
- 3. Tree Protection Fencing locations are fixed. Install exactly where shown on these plans. Any adjustments to fencing locations must be approved by the Owner. Damages will be assessed if tree protection fence location is adjusted without Owner approval. Fence deviation from this plan or approved change will be corrected by the General Contractor prior to the start of construction.
- All tree pruning and limb restraint will be performed under the direct supervision of a Certified Arborist. Contractor shall not prune trees or restrain limbs.
- 5. No staging, equipment, material storage, or vehicles are allowed on non-paved areas unless indicated otherwise on plan.
- 6. Abandon all utilities to be removed when located within a Protected Root Zone.

Minimum fencing/root protection area


x the caliper (in inches) of the tree,

Refer to plan.

shall extend to a radius (in feet) of 1.5

- 7. Backfill all depressed and void areas with top soil following removal of vegetation. Soil shall be free of debris. Compact soils to ensure settling and sedimentation do not occur.
- 8. Owner is responsible for transplanting identified trees, as noted. Coordinate with Owner if trees to be transplanted remain on site when mobilization begins.
- Cleanly cut all roots encountered during construction. Contractor to Air-knife all roots around trees around all indicated as being essential to the campus landscape vocabulary and any tree over 18" in diameter.
- 10. Coordinate locations of Tree Protection Fencing and Construction Fencing prior to the start of construction activities. In areas where Tree Protection and Construction Fences overlap, the Contractor may elect to install the more restrictive fence type of the two provided that the single fence accommodates the requirements of both fences.



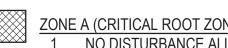

ZONE A (CRITICAL ROOT ZONE)

1. NO DISTURBANCE ALLOWED without site-specific inspection and approval of methods to minimize root damage. 2. Severance of roots larger than 2" diameter requires Landscape Architect's approval.

3. Tunneling or boring required to install utilities 3'-0" below grade or deeper.

Operation of heavy equipment and/or stockpiling of materials subject to Landscape Architect's approval. Surface Protection\* measures required. 2. Trenching allowed as follows:

- Excavation by hand or with hand-driver trencher may be required. - Limit trench width. Do not disturb Zone A, maintain 2/3 or more of Zone B in undisturbed condition.

Tunneling or boring may be required for trenches deeper than 3'-0".

6' high vinyl protection chainlink fence Fence post (6' o.c. max.)

Operation of heavy equipment and/or stockpiling of materials subject to Landscape Architect's approval. Surface Protection\* measures required.

2. Trenching with heavy equipment allowed as follows: - Minimize trench width. - Maintain 2/3 or more of Zone C in undisturbed condition.

4' high vinyl protection fence at the greater of Zone B (Dripline) or to a radius (in feet) of 1.5x the caliper (in inches) of the tree, minimum, and at Zone C (Protected Root Zone) if possible.


Upon Landscape Architect's approval, a plywood box (8' minimum height) may be used where fencing cannot be achieved.

Landscape Architect's approval required for use/access within Zone B. Permission for use/access requires Surface Protection Measures for all unfenced, unpaved surfaces within Zone B.

\*SURFACE PROTECTION MEASURES 1. Mulch Layer, 6"-8" Depth

3/4" Plywood
 Steel Plates

1. Refer to tree protection specifications. 2. Contractor may submit alternate methods of tree protection to Landscape Architect for Consideration Prior to Construction.

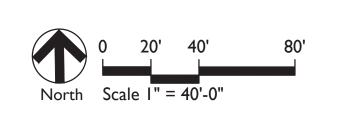

**EXISTING WOODED** 

AREA TO REMAIN

INST. #860050767

**EXISTING BUILDING** 

1 STY. BRICK SCHOOL BLDG.

THE METROPOLITAN SCHOOL DISTRICT OF WARREN TOWNSHIP - INST. #86042655

HAWTHORNE DEVELOPMENT CORPORATION

INST. #860050767

T.B.M. #2 ELEV.=859.14

TREE PROTECTION



MATERIAL LEGEND

(P1.1) Standard Asphalt Pavement, Refer to Detail 4/L501 and Specifications

Standard Concrete Pavement, Refer to Detail 1/L501 and Specifications

(C1.1) Concrete Post Curb, Refer to Detail 8/L501 and Specifications

(C1.4) Wheel Stop, Refer to Detail 7/L502 and Specifications

(C1.5) ROW Curb and Cutter, Refer to Civil Engineering Drawings

S1.0 Signage, (comply with MUTCD Standards)
(VIF Regulatory Signs with City Representative)

S1.1 ADA Parking Striping, Refer to Detail 8/L502 and

Specifications

and Specifications

Specifications

R1.0 Accessible Sidewalk Ramps

Specifications

Specifications

Specifications

S2.0 Playground Protective Surfacing

F1.0 Fencing

PA Planting Area

Area to be Seeded

S1.2 Accessible Parking Symbol, Refer to Detail 6/L502 and

(S1.3) Van Accessible ADA Parking Sign, Refer to Detail 5/L502

S1.4 Accessible ADA Parking Sign, Refer to Detail 5/L502 and

(R1.1) One-Way Directional Perpendicular Curb Ramp, Refer to Detail 1/L503 and

R1.3 Perpendicular Curb Ramp with Flare and Curb, Refer to Detail 3/L503 and

R1.2 Perpendicular Curb Ramp with Flares, Refer to Detail 2/L503 and

R1.4 Parallel Curb Ramp, Refer to Detail 4/L503 and Specifications

R1.5 Depressed Curb Ramp, Refer to Detail 5/L503 and Specifications

S2.1 Engineered Wood Fiber Play Surface, Refer to Detail 2/L502 and

(\$2.2) Resilient Rubber Play Surface, Refer to Detail 1/L502 and Specifications

(F1.1) 30'-0" wide Hoover Z-Series Swing Gate, Double Leaf Barrier,4'-0"

Refer to Details and Specifications for Pavement Striping.

0 10' 20' 40'

HT, Aluminum Tubular, Refer to Specifications

(C1.2) Integral Curb and Walk, Refer to Detail7/L501 and Specifications

C1.3 Post Curb at Play Surface, Refer to Detail 4/L502 and Specifications

ROW Asphalt Paving, Refer to Civil Engineering Drawings

Asphalt Sealcoat and Restripe, Refer to Specifications

Milled and Resurfaced Asphalt Pavement, Refer to Detail 6/L501 and Specifications

Heavy Duty Asphalt Pavement, Refer to Detail 5/L501 and Specifications

P1.0 Pavement, Asphalt

P2.0 Pavement, Concrete

C1.0 Curbing

SCOPE DRAWINGS:

These drawings indicate the general scope of the project in terms of architectural design concept, the dimensions of the building, the major architectural elements and the type of structural, mechanical and electrical systems.

The drawings do not necessarily indicate or describe all work required for full performance and completion of the requirements of the Contract.

On the basis of the general scope indicated or described, the trade contractors shall furnish all items required for the


REVISIONS: 08-19-2022 Addendum 03

ISSUE DATE | DRAWN BY | CHECKED BY 07/25/2022

DRAWING TITLE: MATERIALS AND NOTES PLAN

CERTIFIED BY: 2020-0052 STATE OF EXPIRES 12-31-2023

DRAWING NUMBER L103

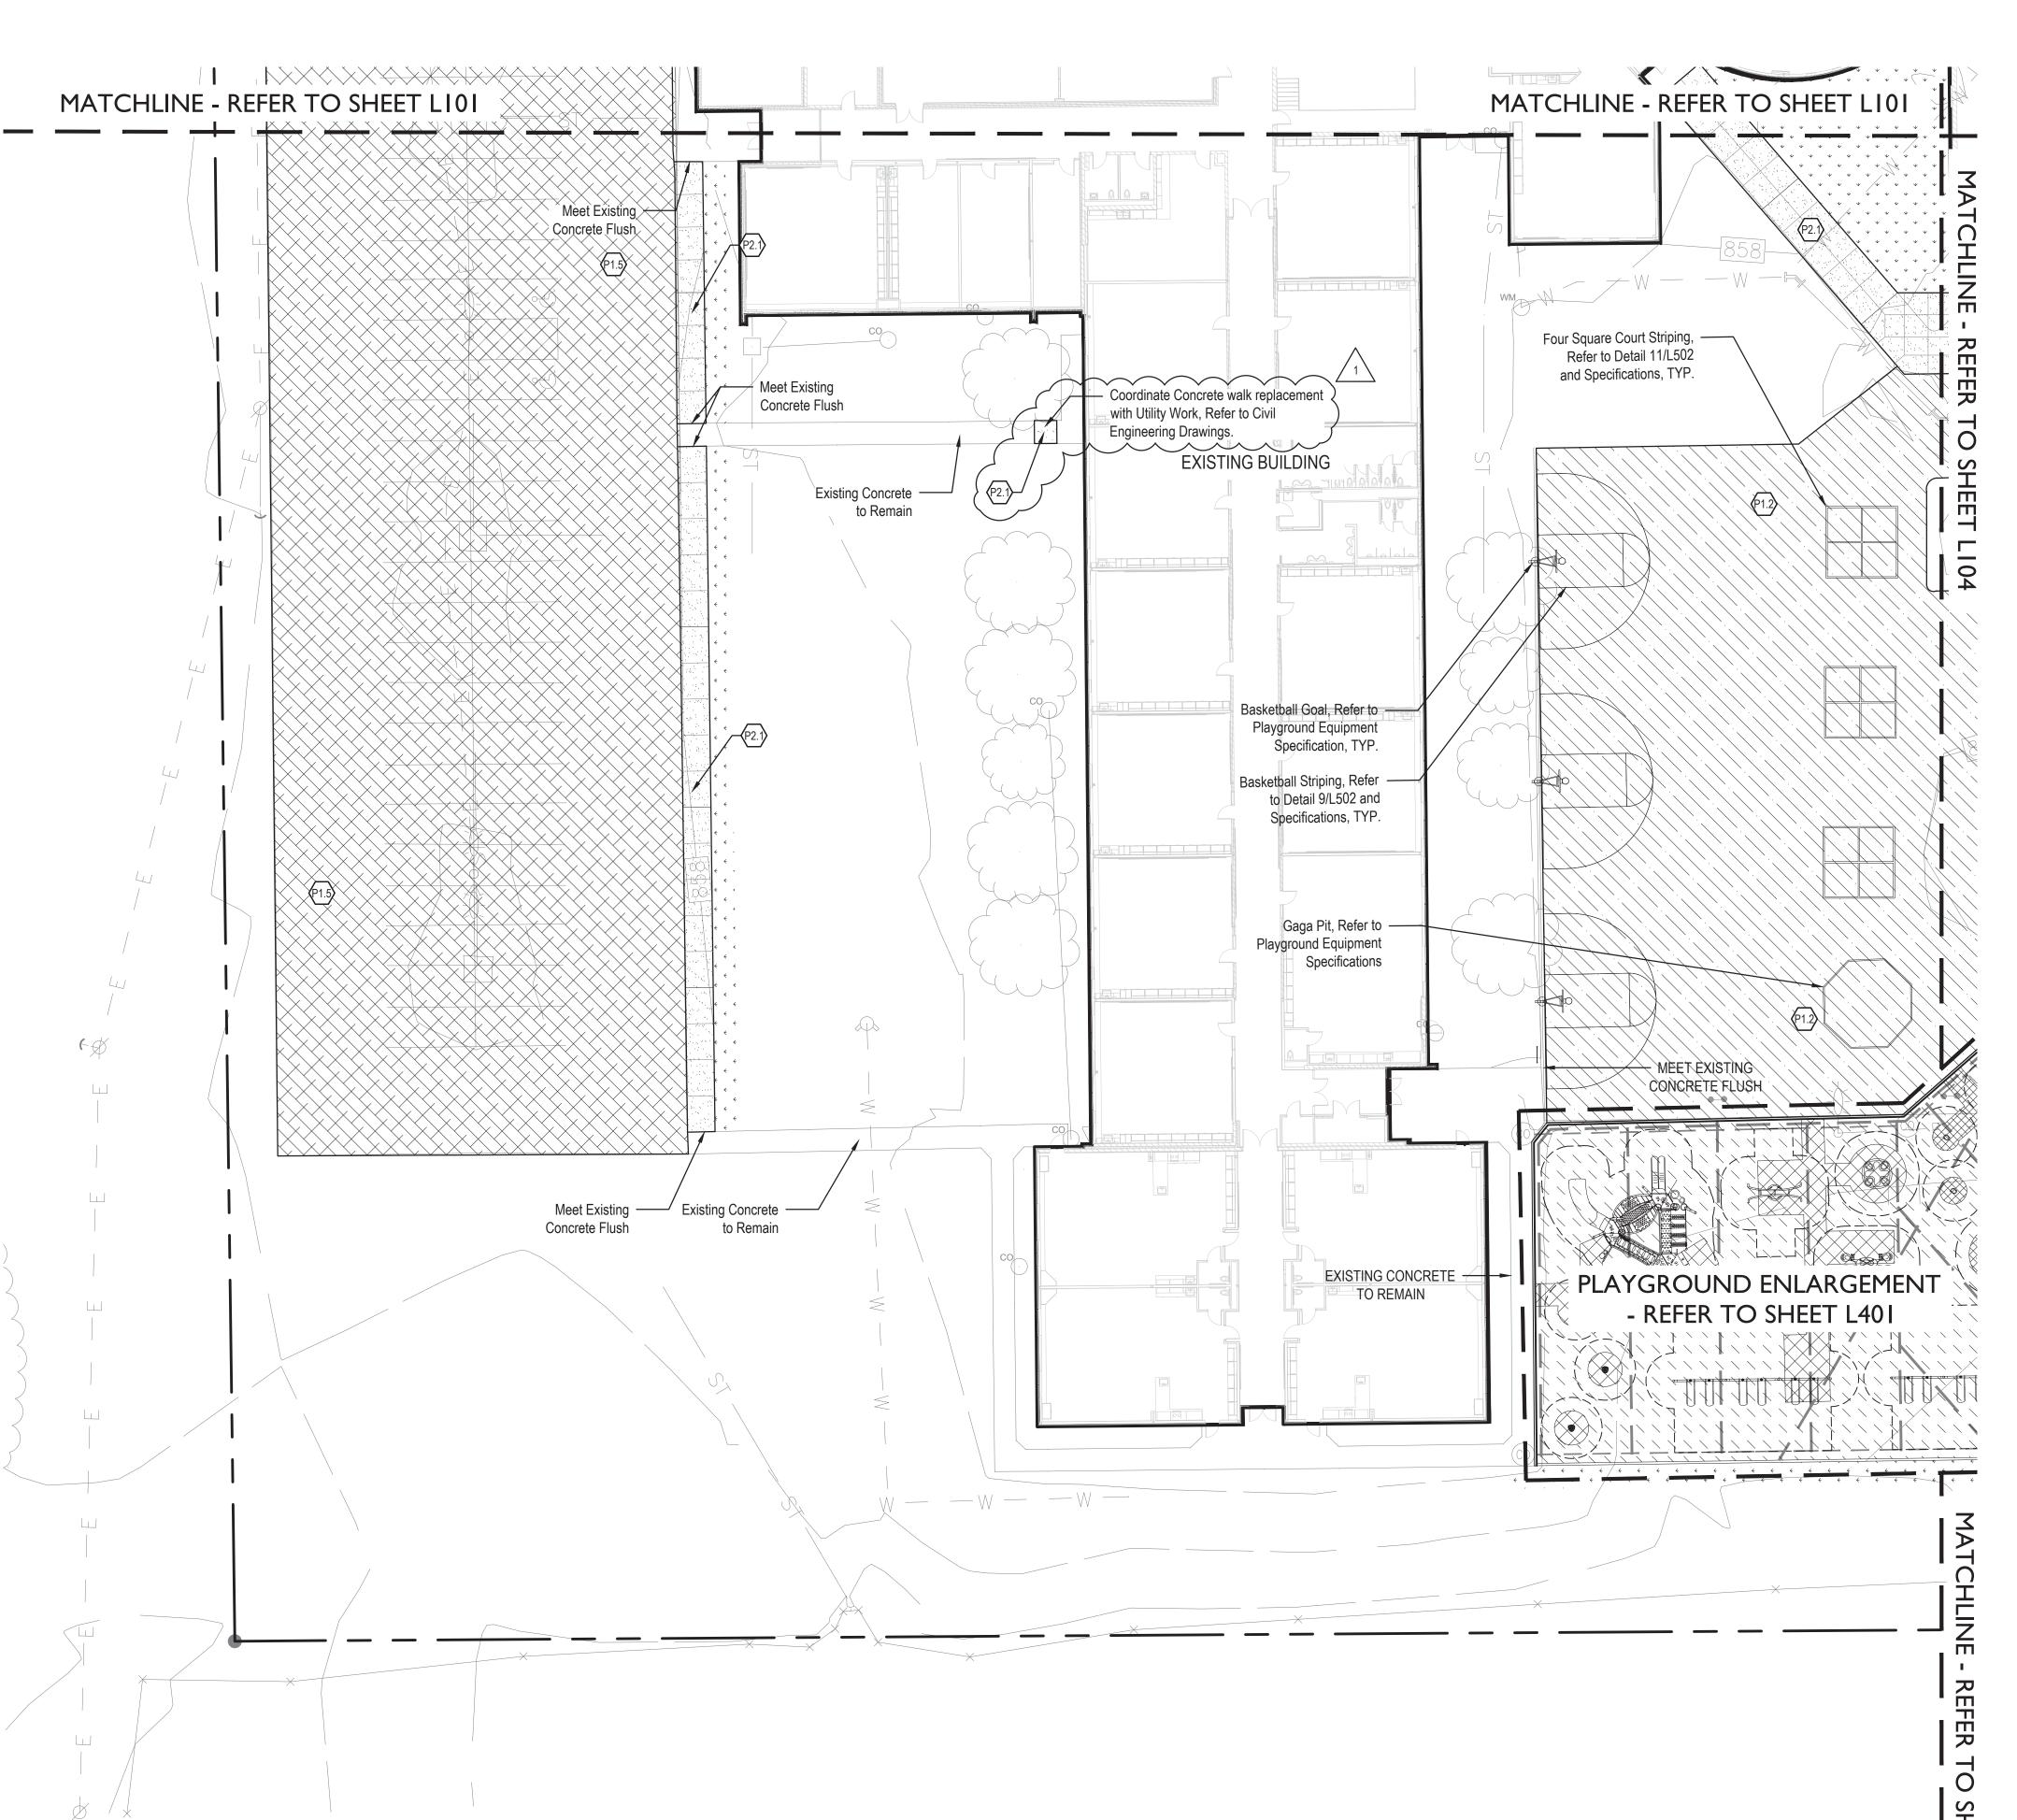





Dimensions are shown to Face of Curb unless otherwise noted.

confirmation of such data.

seeded per Specifications.

the Fire Marshal.

Align to existing conditions when practical, including at building and wall corners, connections to existing work, and to centerlines of doors.

with field layout. The Contractor maintains all responsibility for the use, accuracy, and

in their bid any miscellaneous copy, striping, or curb painting that may be requested by

otherwise dimensioned. Space interim joints equally whenever possible.

ADDITION AND RENOVATIONS TO HAWTHORNE ELEMENTARY SCHOOL

SCOPE DRAWINGS:

These drawings indicate the general scope of the project in terms of architectural design concept, the dimensions of the building, the major architectural elements and the type of structural, mechanical and electrical systems.

The drawings do not necessarily indicate or describe all work required for full performance and completion of the requirements of the Contract.

On the basis of the general scope indicated or described, the trade contractors shall furnish all items required for the proper execution and completion of the work.

**REVISIONS:** 08-19-2022 Addendum 03

ISSUE DATE | DRAWN BY | CHECKED BY

07/25/2022 MA DRAWING TITLE:

PLAN

CERTIFIED BY: No.
2020-0052
STATE OF

WOLANA

Treshar Managan

DRAWING NUMBER



550 Virginia Avenue Indianapolis, IN 46203 P 317.423.1550 F 317.423.1551

www.lhb-eng.com

#### STRUCTURAL ENGINEERS

WILLIAM F. LYNCH, PE, LS (1917-1995) WESLEY B. HARRISON, PE (RETIRED)

PAUL A. BRUMLEVE, PE SCOTT A. CLORE, PE ROBERT M. DEE, PE MARK D. LAVIER, PE

NATHAN M. ASHLEY, PE
DAVID A. CLARK, PE, SE
NICHOLAS H. FELLER, PE
JOSEPH L. HEINSMAN, PE
DANIEL J. LEVITUS, PE
JAMES R. OSBORNE, PE
NICHOLAS R. RITENOUR, PE
SAMUEL B. RUNNINGEN, PE
JESSE R. VALENCOURT, PE, SE

## Hawthorne Elementary Renovation & Addition Addendum 3

August 19, 2022

Amend dimensions on the following structural drawings to accommodate discovered existing construction:

#### **Drawing S101 Foundation Plan**

1. Adjust CMU wall locations at concrete stairs.

#### **Drawing S102 Low Roof Framing Plan**


- 1. Additional steel beam lintel at stage entrance.
- 2. Added note regarding the concrete curb around the perimeter and all openings at the new mechanical mezzanine.

#### **Drawing S711 Framing Sections and Details**

- 1. Modify Section 3/S711.
- 2. Modify Section 4/S711.
- 3. Modify Section 6/S711.

#### **Drawing S712 Framing Sections and Details**

1. Modify Section 1/S712.

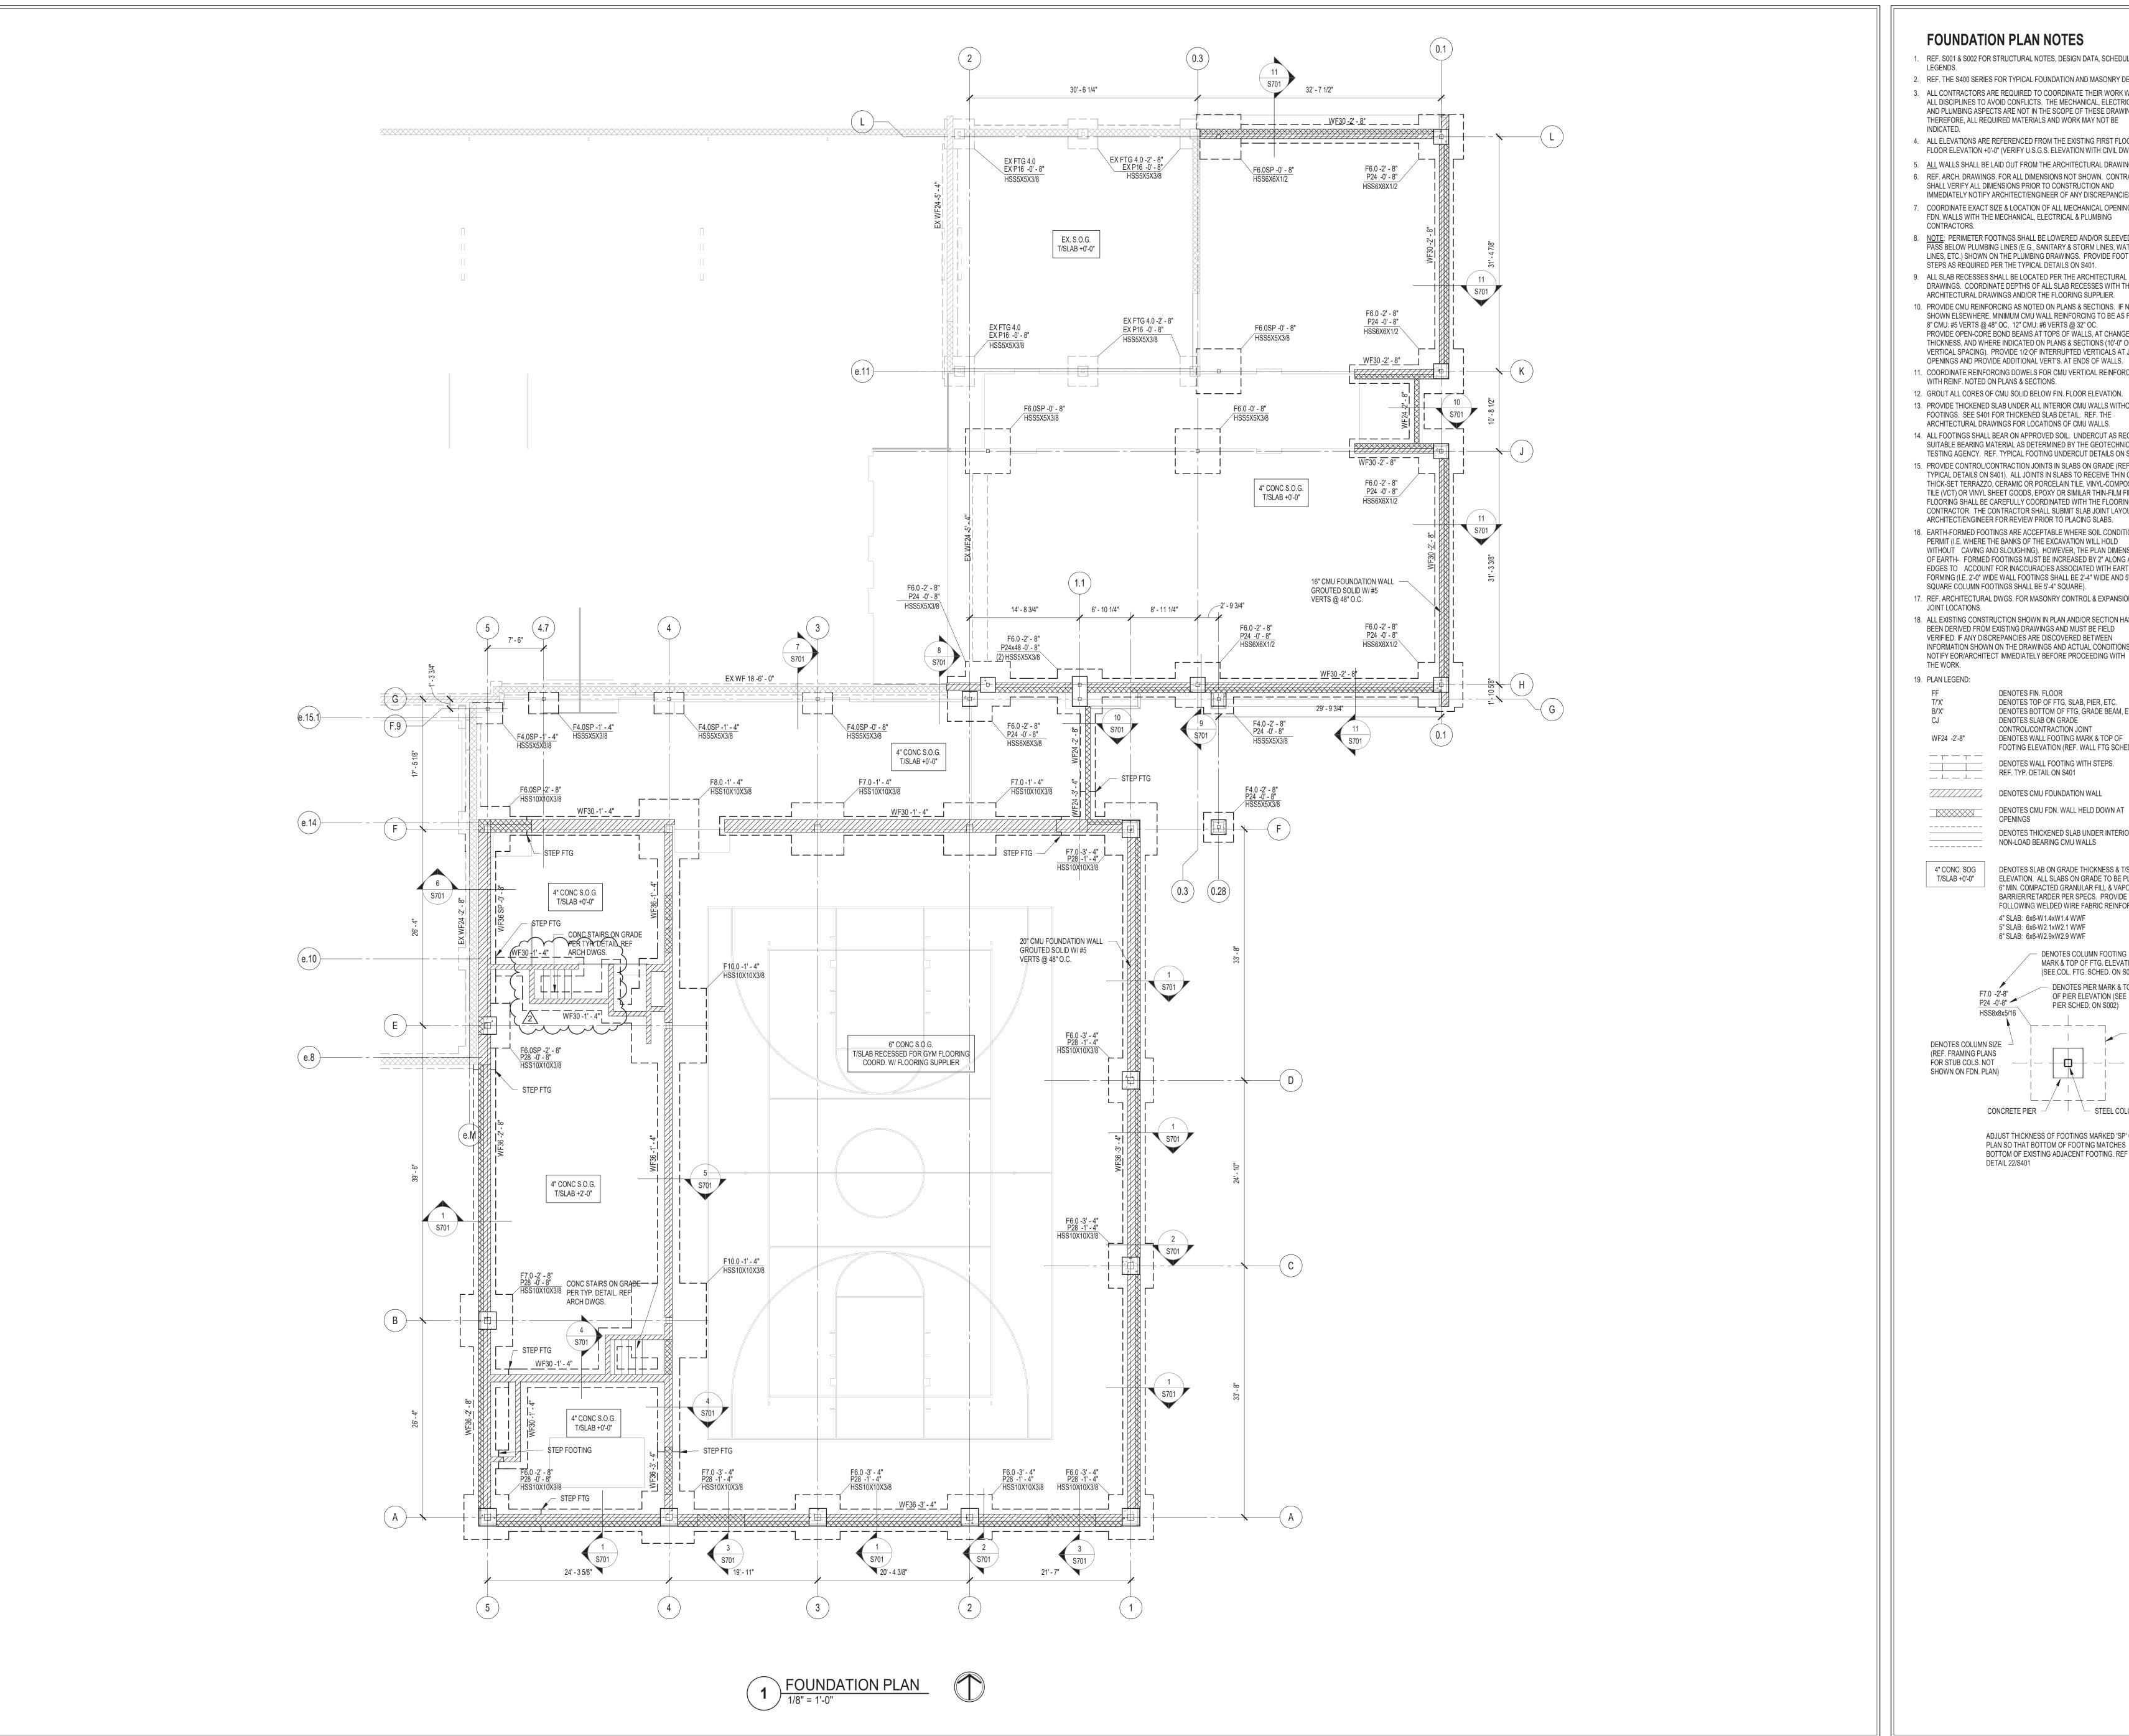

## **FOUNDATION PLAN NOTES**

1. REF. S001 & S002 FOR STRUCTURAL NOTES, DESIGN DATA, SCHEDULES &

- 2. REF. THE S400 SERIES FOR TYPICAL FOUNDATION AND MASONRY DETAILS. 3. ALL CONTRACTORS ARE REQUIRED TO COORDINATE THEIR WORK WITH ALL DISCIPLINES TO AVOID CONFLICTS. THE MECHANICAL, ELECTRICAL, AND PLUMBING ASPECTS ARE NOT IN THE SCOPE OF THESE DRAWINGS. THEREFORE, ALL REQUIRED MATERIALS AND WORK MAY NOT BE
- 4. ALL ELEVATIONS ARE REFERENCED FROM THE EXISTING FIRST FLOOR FIN.
- FLOOR ELEVATION +0'-0" (VERIFY U.S.G.S. ELEVATION WITH CIVIL DWGS) 5. <u>ALL</u> WALLS SHALL BE LAID OUT FROM THE ARCHITECTURAL DRAWINGS. 6. REF. ARCH. DRAWINGS. FOR ALL DIMENSIONS NOT SHOWN. CONTRACTOR SHALL VERIFY ALL DIMENSIONS PRIOR TO CONSTRUCTION AND
- IMMEDIATELY NOTIFY ARCHITECT/ENGINEER OF ANY DISCREPANCIES. 7. COORDINATE EXACT SIZE & LOCATION OF ALL MECHANICAL OPENINGS IN FDN. WALLS WITH THE MECHANICAL, ELECTRICAL & PLUMBING
- 8. NOTE: PERIMETER FOOTINGS SHALL BE LOWERED AND/OR SLEEVED TO PASS BELOW PLUMBING LINES (E.G., SANITARY & STORM LINES, WATER LINES, ETC.) SHOWN ON THE PLUMBING DRAWINGS. PROVIDE FOOTING STEPS AS REQUIRED PER THE TYPICAL DETAILS ON \$401.
- DRAWINGS. COORDINATE DEPTHS OF ALL SLAB RECESSES WITH THE ARCHITECTURAL DRAWINGS AND/OR THE FLOORING SUPPLIER. 10. PROVIDE CMU REINFORCING AS NOTED ON PLANS & SECTIONS. IF NOT SHOWN ELSEWHERE, MINIMUM CMU WALL REINFORCING TO BE AS FOLLOWS: 8" CMU: #5 VERTS @ 48" OC, 12" CMU: #6 VERTS @ 32" OC.
- PROVIDE OPEN-CORE BOND BEAMS AT TOPS OF WALLS, AT CHANGES IN CMU THICKNESS, AND WHERE INDICATED ON PLANS & SECTIONS (10'-0" OC MAX VERTICAL SPACING). PROVIDE 1/2 OF INTERRUPTED VERTICALS AT JAMBS OF OPENINGS AND PROVIDE ADDITIONAL VERT'S. AT ENDS OF WALLS. 11. COORDINATE REINFORCING DOWELS FOR CMU VERTICAL REINFORCING
- WITH REINF. NOTED ON PLANS & SECTIONS. 12. GROUT ALL CORES OF CMU SOLID BELOW FIN. FLOOR ELEVATION. 13. PROVIDE THICKENED SLAB UNDER ALL INTERIOR CMU WALLS WITHOUT
- FOOTINGS. SEE S401 FOR THICKENED SLAB DETAIL. REF. THE ARCHITECTURAL DRAWINGS FOR LOCATIONS OF CMU WALLS. 14. ALL FOOTINGS SHALL BEAR ON APPROVED SOIL. UNDERCUT AS REQ'D. TO SUITABLE BEARING MATERIAL AS DETERMINED BY THE GEOTECHNICAL
- TESTING AGENCY. REF. TYPICAL FOOTING UNDERCUT DETAILS ON \$401. 15. PROVIDE CONTROL/CONTRACTION JOINTS IN SLABS ON GRADE (REF. TYPICAL DETAILS ON S401). ALL JOINTS IN SLABS TO RECEIVE THIN OR THICK-SET TERRAZZO, CERAMIC OR PORCELAIN TILE, VINYL-COMPOSITION TILE (VCT) OR VINYL SHEET GOODS, EPOXY OR SIMILAR THIN-FILM FINISH FLOORING SHALL BE CAREFULLY COORDINATED WITH THE FLOORING
- CONTRACTOR. THE CONTRACTOR SHALL SUBMIT SLAB JOINT LAYOUT TO ARCHITECT/ENGINEER FOR REVIEW PRIOR TO PLACING SLABS. 16. EARTH-FORMED FOOTINGS ARE ACCEPTABLE WHERE SOIL CONDITIONS PERMIT (I.E. WHERE THE BANKS OF THE EXCAVATION WILL HOLD WITHOUT CAVING AND SLOUGHING). HOWEVER, THE PLAN DIMENSION OF EARTH- FORMED FOOTINGS MUST BE INCREASED BY 2" ALONG ALL EDGES TO ACCOUNT FOR INACCURACIES ASSOCIATED WITH EARTH-FORMING (I.E. 2'-0" WIDE WALL FOOTINGS SHALL BE 2'-4" WIDE AND 5'-0"
- SQUARE COLUMN FOOTINGS SHALL BE 5'-4" SQUARE). 17. REF. ARCHITECTURAL DWGS. FOR MASONRY CONTROL & EXPANSION JOINT LOCATIONS.
- 18. ALL EXISTING CONSTRUCTION SHOWN IN PLAN AND/OR SECTION HAS BEEN DERIVED FROM EXISTING DRAWINGS AND MUST BE FIELD VERIFIED. IF ANY DISCREPANCIES ARE DISCOVERED BETWEEN INFORMATION SHOWN ON THE DRAWINGS AND ACTUAL CONDITIONS, NOTIFY EOR/ARCHITECT IMMEDIATELY BEFORE PROCEEDING WITH THE WORK.


DENOTES FIN. FLOOR DENOTES TOP OF FTG, SLAB, PIER, ETC. DENOTES BOTTOM OF FTG, GRADE BEAM, ETC. DENOTES SLAB ON GRADE CONTROL/CONTRACTION JOINT DENOTES WALL FOOTING MARK & TOP OF FOOTING ELEVATION (REF. WALL FTG SCHEDULE)

> DENOTES CMU FOUNDATION WALL DENOTES CMU FDN. WALL HELD DOWN AT

REF. TYP. DETAIL ON S401

DENOTES THICKENED SLAB UNDER INTERIOR NON-LOAD BEARING CMU WALLS

4" CONC. SOG DENOTES SLAB ON GRADE THICKNESS & T/SLAB ELEVATION. ALL SLABS ON GRADE TO BE PLACED ON 6" MIN. COMPACTED GRANULAR FILL & VAPOR BARRIER/RETARDER PER SPECS. PROVIDE THE FOLLOWING WELDED WIRE FABRIC REINFORCING: 4" SLAB: 6x6-W1.4xW1.4 WWF 5" SLAB: 6x6-W2.1xW2.1 WWF 6" SLAB: 6x6-W2.9xW2.9 WWF

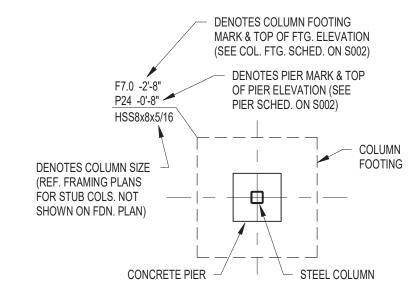

ADJUST THICKNESS OF FOOTINGS MARKED 'SP' ON PLAN SO THAT BOTTOM OF FOOTING MATCHES BOTTOM OF EXISTING ADJACENT FOOTING. REF DETAIL 22/S401




SCOPE DRAWINGS: equirements of the Contract.
On the basis of the general scope indicated or descr proper execution and completion of the work.

REVISIONS:


Addendum 3 8/19/2022

ISSUE DATE | DRAWN BY | CHECKED BY 07/25/2022 JAW

DRAWING TITLE:

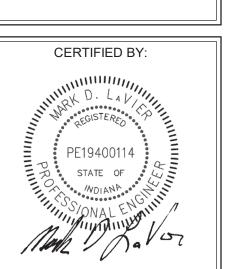


DRAWING NUMBER S101

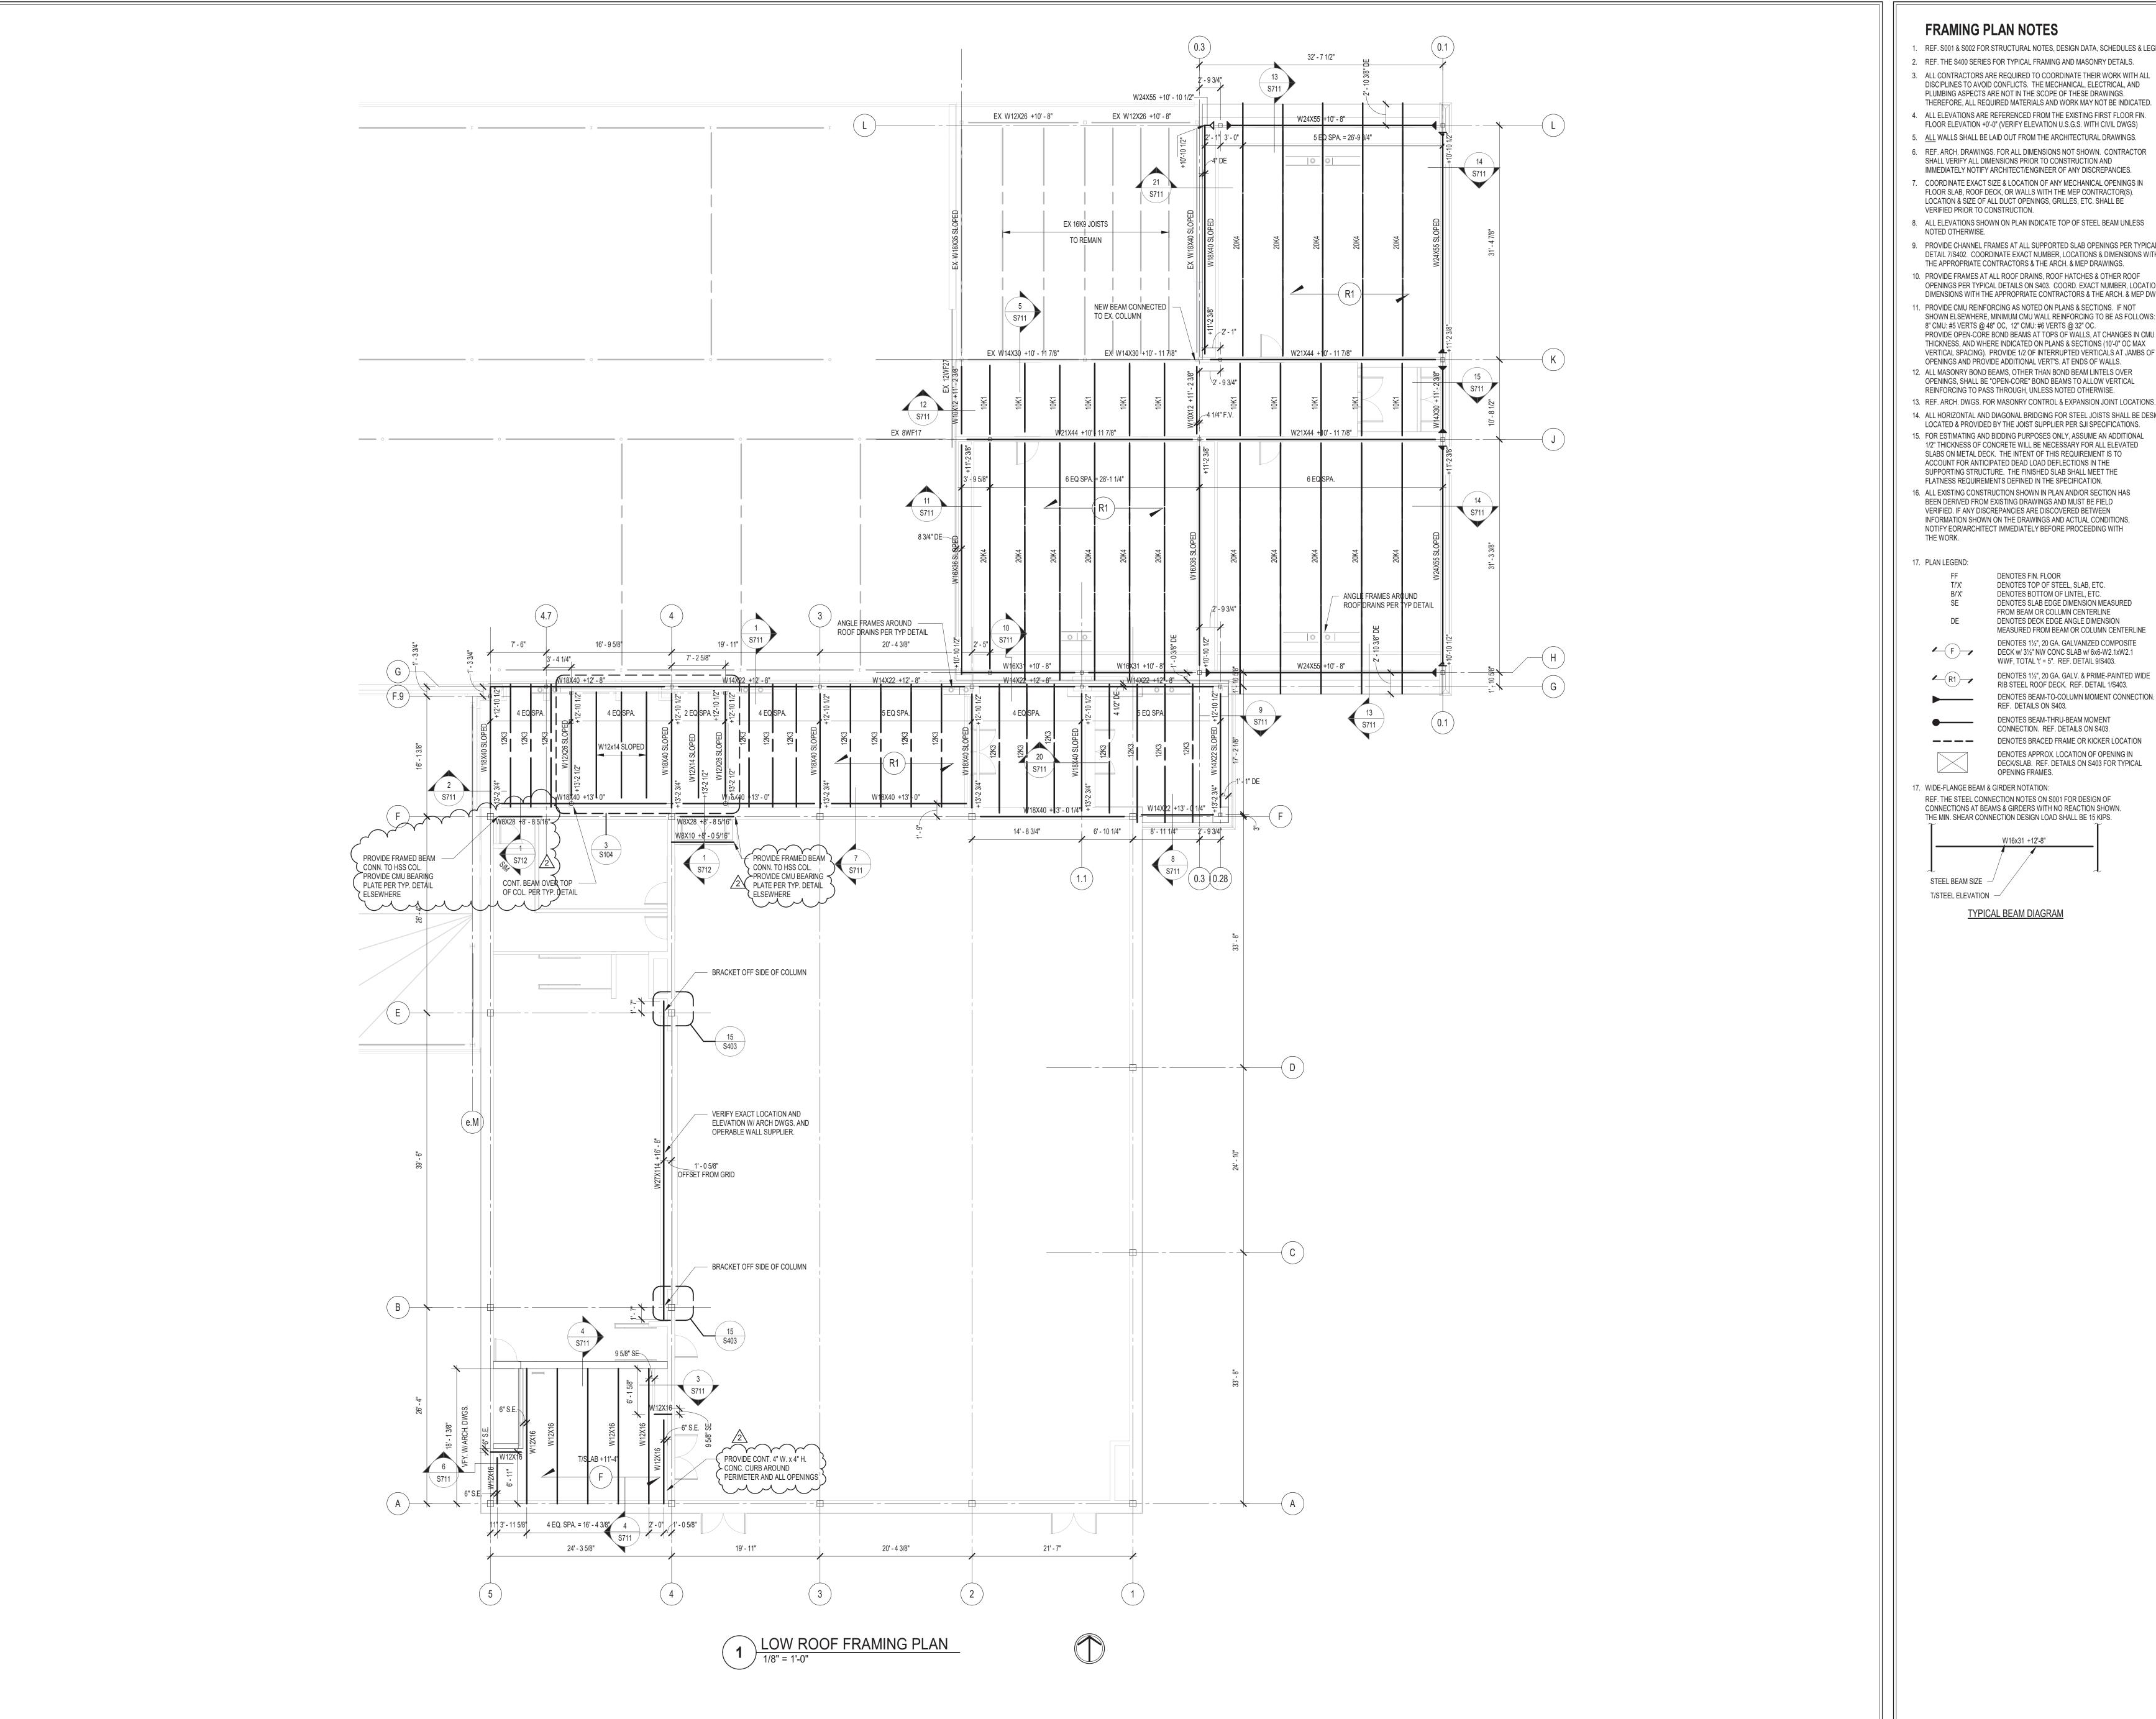



## FRAMING PLAN NOTES

- 1. REF. S001 & S002 FOR STRUCTURAL NOTES, DESIGN DATA, SCHEDULES & LEGENDS.
- 3. ALL CONTRACTORS ARE REQUIRED TO COORDINATE THEIR WORK WITH ALL DISCIPLINES TO AVOID CONFLICTS. THE MECHANICAL, ELECTRICAL, AND PLUMBING ASPECTS ARE NOT IN THE SCOPE OF THESE DRAWINGS.
- THEREFORE, ALL REQUIRED MATERIALS AND WORK MAY NOT BE INDICATED. 4. ALL ELEVATIONS ARE REFERENCED FROM THE EXISTING FIRST FLOOR FIN. FLOOR ELEVATION +0'-0" (VERIFY ELEVATION U.S.G.S. WITH CIVIL DWGS)
- 5. <u>ALL</u> WALLS SHALL BE LAID OUT FROM THE ARCHITECTURAL DRAWINGS. 6. REF. ARCH. DRAWINGS. FOR ALL DIMENSIONS NOT SHOWN. CONTRACTOR
- SHALL VERIFY ALL DIMENSIONS PRIOR TO CONSTRUCTION AND IMMEDIATELY NOTIFY ARCHITECT/ENGINEER OF ANY DISCREPANCIES. 7. COORDINATE EXACT SIZE & LOCATION OF ANY MECHANICAL OPENINGS IN FLOOR SLAB, ROOF DECK, OR WALLS WITH THE MEP CONTRACTOR(S).
- VERIFIED PRIOR TO CONSTRUCTION. 8. ALL ELEVATIONS SHOWN ON PLAN INDICATE TOP OF STEEL BEAM UNLESS NOTED OTHERWISE.
- 9. PROVIDE CHANNEL FRAMES AT ALL SUPPORTED SLAB OPENINGS PER TYPICAL
- DETAIL 7/S402. COORDINATE EXACT NUMBER, LOCATIONS & DIMENSIONS WITH THE APPROPRIATE CONTRACTORS & THE ARCH. & MEP DRAWINGS.
- 10. PROVIDE FRAMES AT ALL ROOF DRAINS, ROOF HATCHES & OTHER ROOF OPENINGS PER TYPICAL DETAILS ON S403. COORD. EXACT NUMBER, LOCATIONS & DIMENSIONS WITH THE APPROPRIATE CONTRACTORS & THE ARCH. & MEP DWGS.
- SHOWN ELSEWHERE, MINIMUM CMU WALL REINFORCING TO BE AS FOLLOWS: 8" CMU: #5 VERTS @ 48" OC, 12" CMU: #6 VERTS @ 32" OC. PROVIDE OPEN-CORE BOND BEAMS AT TOPS OF WALLS, AT CHANGES IN CMU THICKNESS, AND WHERE INDICATED ON PLANS & SECTIONS (10'-0" OC MAX OPENINGS AND PROVIDE ADDITIONAL VERT'S. AT ENDS OF WALLS.
- VERTICAL SPACING). PROVIDE 1/2 OF INTERRUPTED VERTICALS AT JAMBS OF 12. ALL MASONRY BOND BEAMS, OTHER THAN BOND BEAM LINTELS OVER OPENINGS, SHALL BE "OPEN-CORE" BOND BEAMS TO ALLOW VERTICAL REINFORCING TO PASS THROUGH, UNLESS NOTED OTHERWISE.
- 14. ALL HORIZONTAL AND DIAGONAL BRIDGING FOR STEEL JOISTS SHALL BE DESIGNED, LOCATED & PROVIDED BY THE JOIST SUPPLIER PER SJI SPECIFICATIONS.
- 15. FOR ESTIMATING AND BIDDING PURPOSES ONLY, ASSUME AN ADDITIONAL 1/2" THICKNESS OF CONCRETE WILL BE NECESSARY FOR ALL ELEVATED SLABS ON METAL DECK. THE INTENT OF THIS REQUIREMENT IS TO ACCOUNT FOR ANTICIPATED DEAD LOAD DEFLECTIONS IN THE
- 16. ALL EXISTING CONSTRUCTION SHOWN IN PLAN AND/OR SECTION HAS BEEN DERIVED FROM EXISTING DRAWINGS AND MUST BE FIELD VERIFIED. IF ANY DISCREPANCIES ARE DISCOVERED BETWEEN INFORMATION SHOWN ON THE DRAWINGS AND ACTUAL CONDITIONS, NOTIFY EOR/ARCHITECT IMMEDIATELY BEFORE PROCEEDING WITH




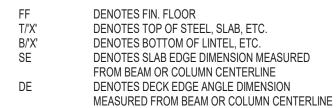


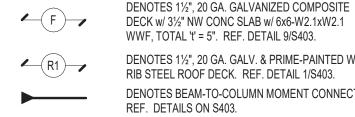

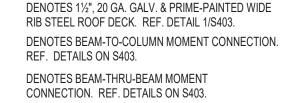

DENOTES BRACED FRAME OR KICKER LOCATION DENOTES APPROX. LOCATION OF OPENING IN

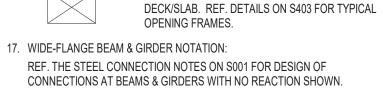

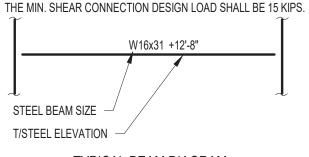

TYPICAL BEAM DIAGRAM




SCOPE DRAWINGS:


REVISIONS: Addendum 3 8/19/2022

ISSUE DATE | DRAWN BY | CHECKED BY 07/25/2022 JAW

DRAWING TITLE: FRAMING PLAN

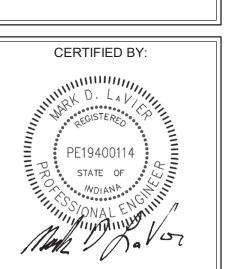


DRAWING NUMBER

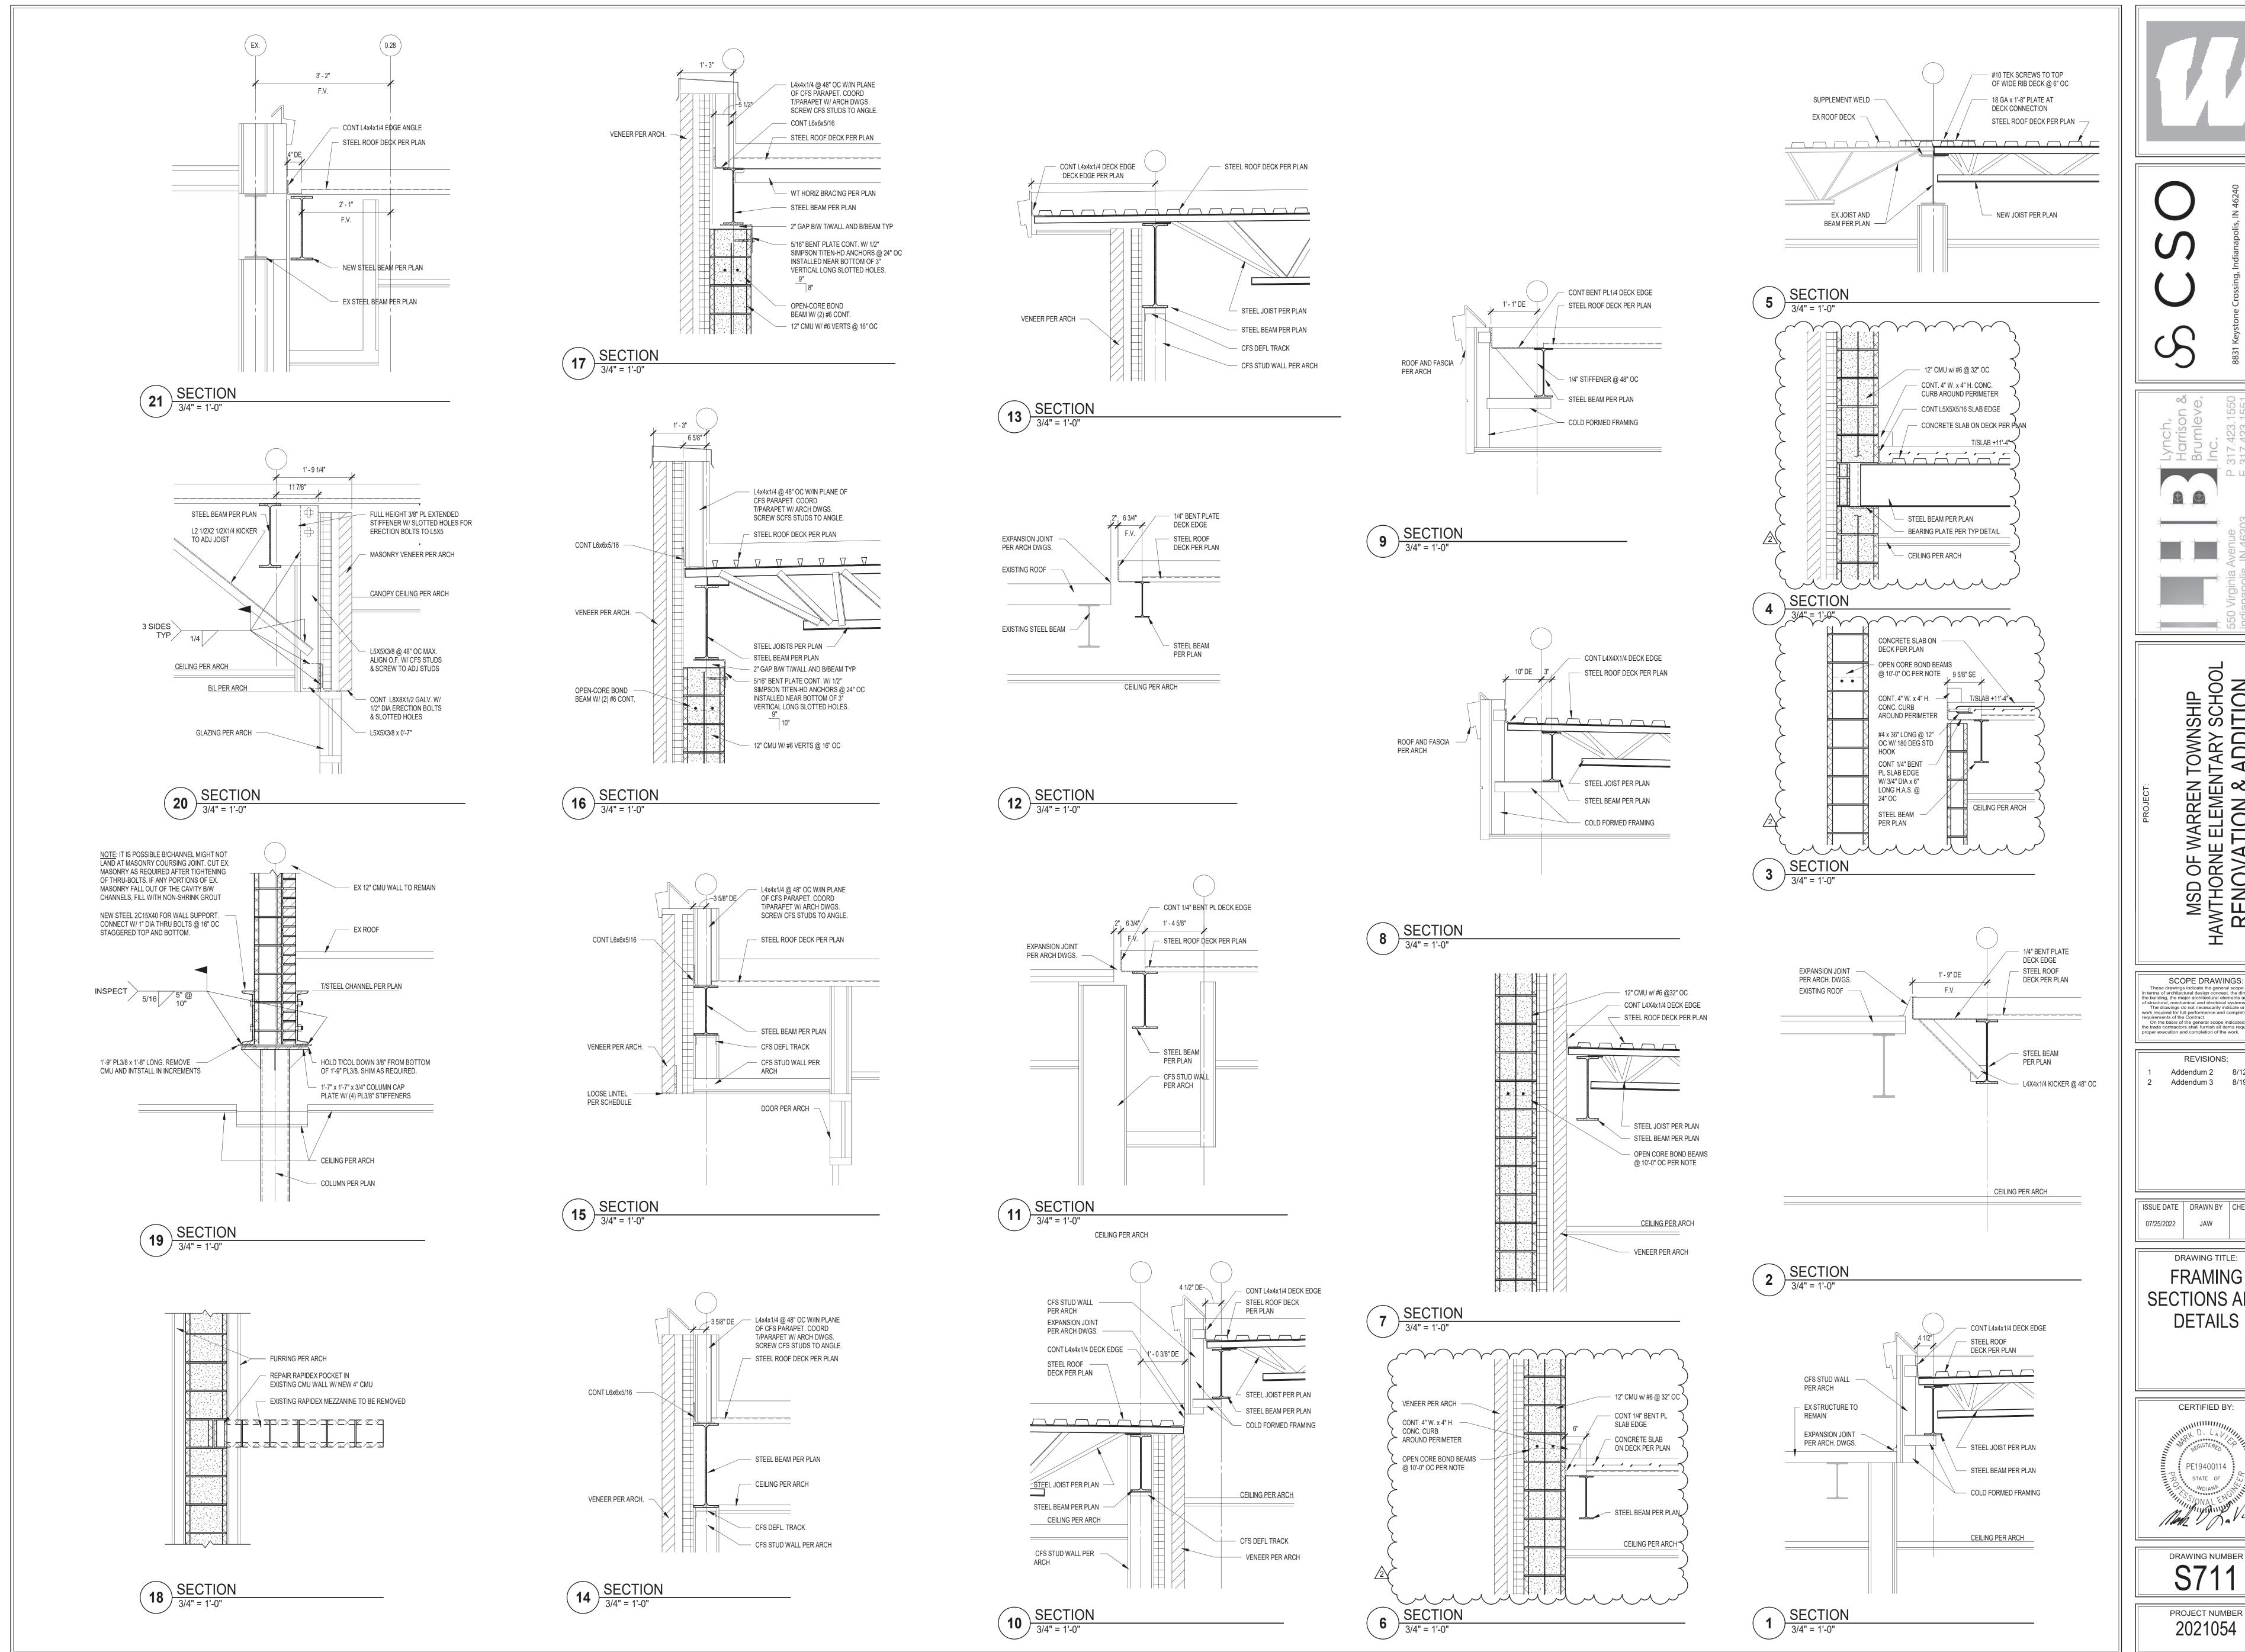





PROJECT NUMBER


2021054

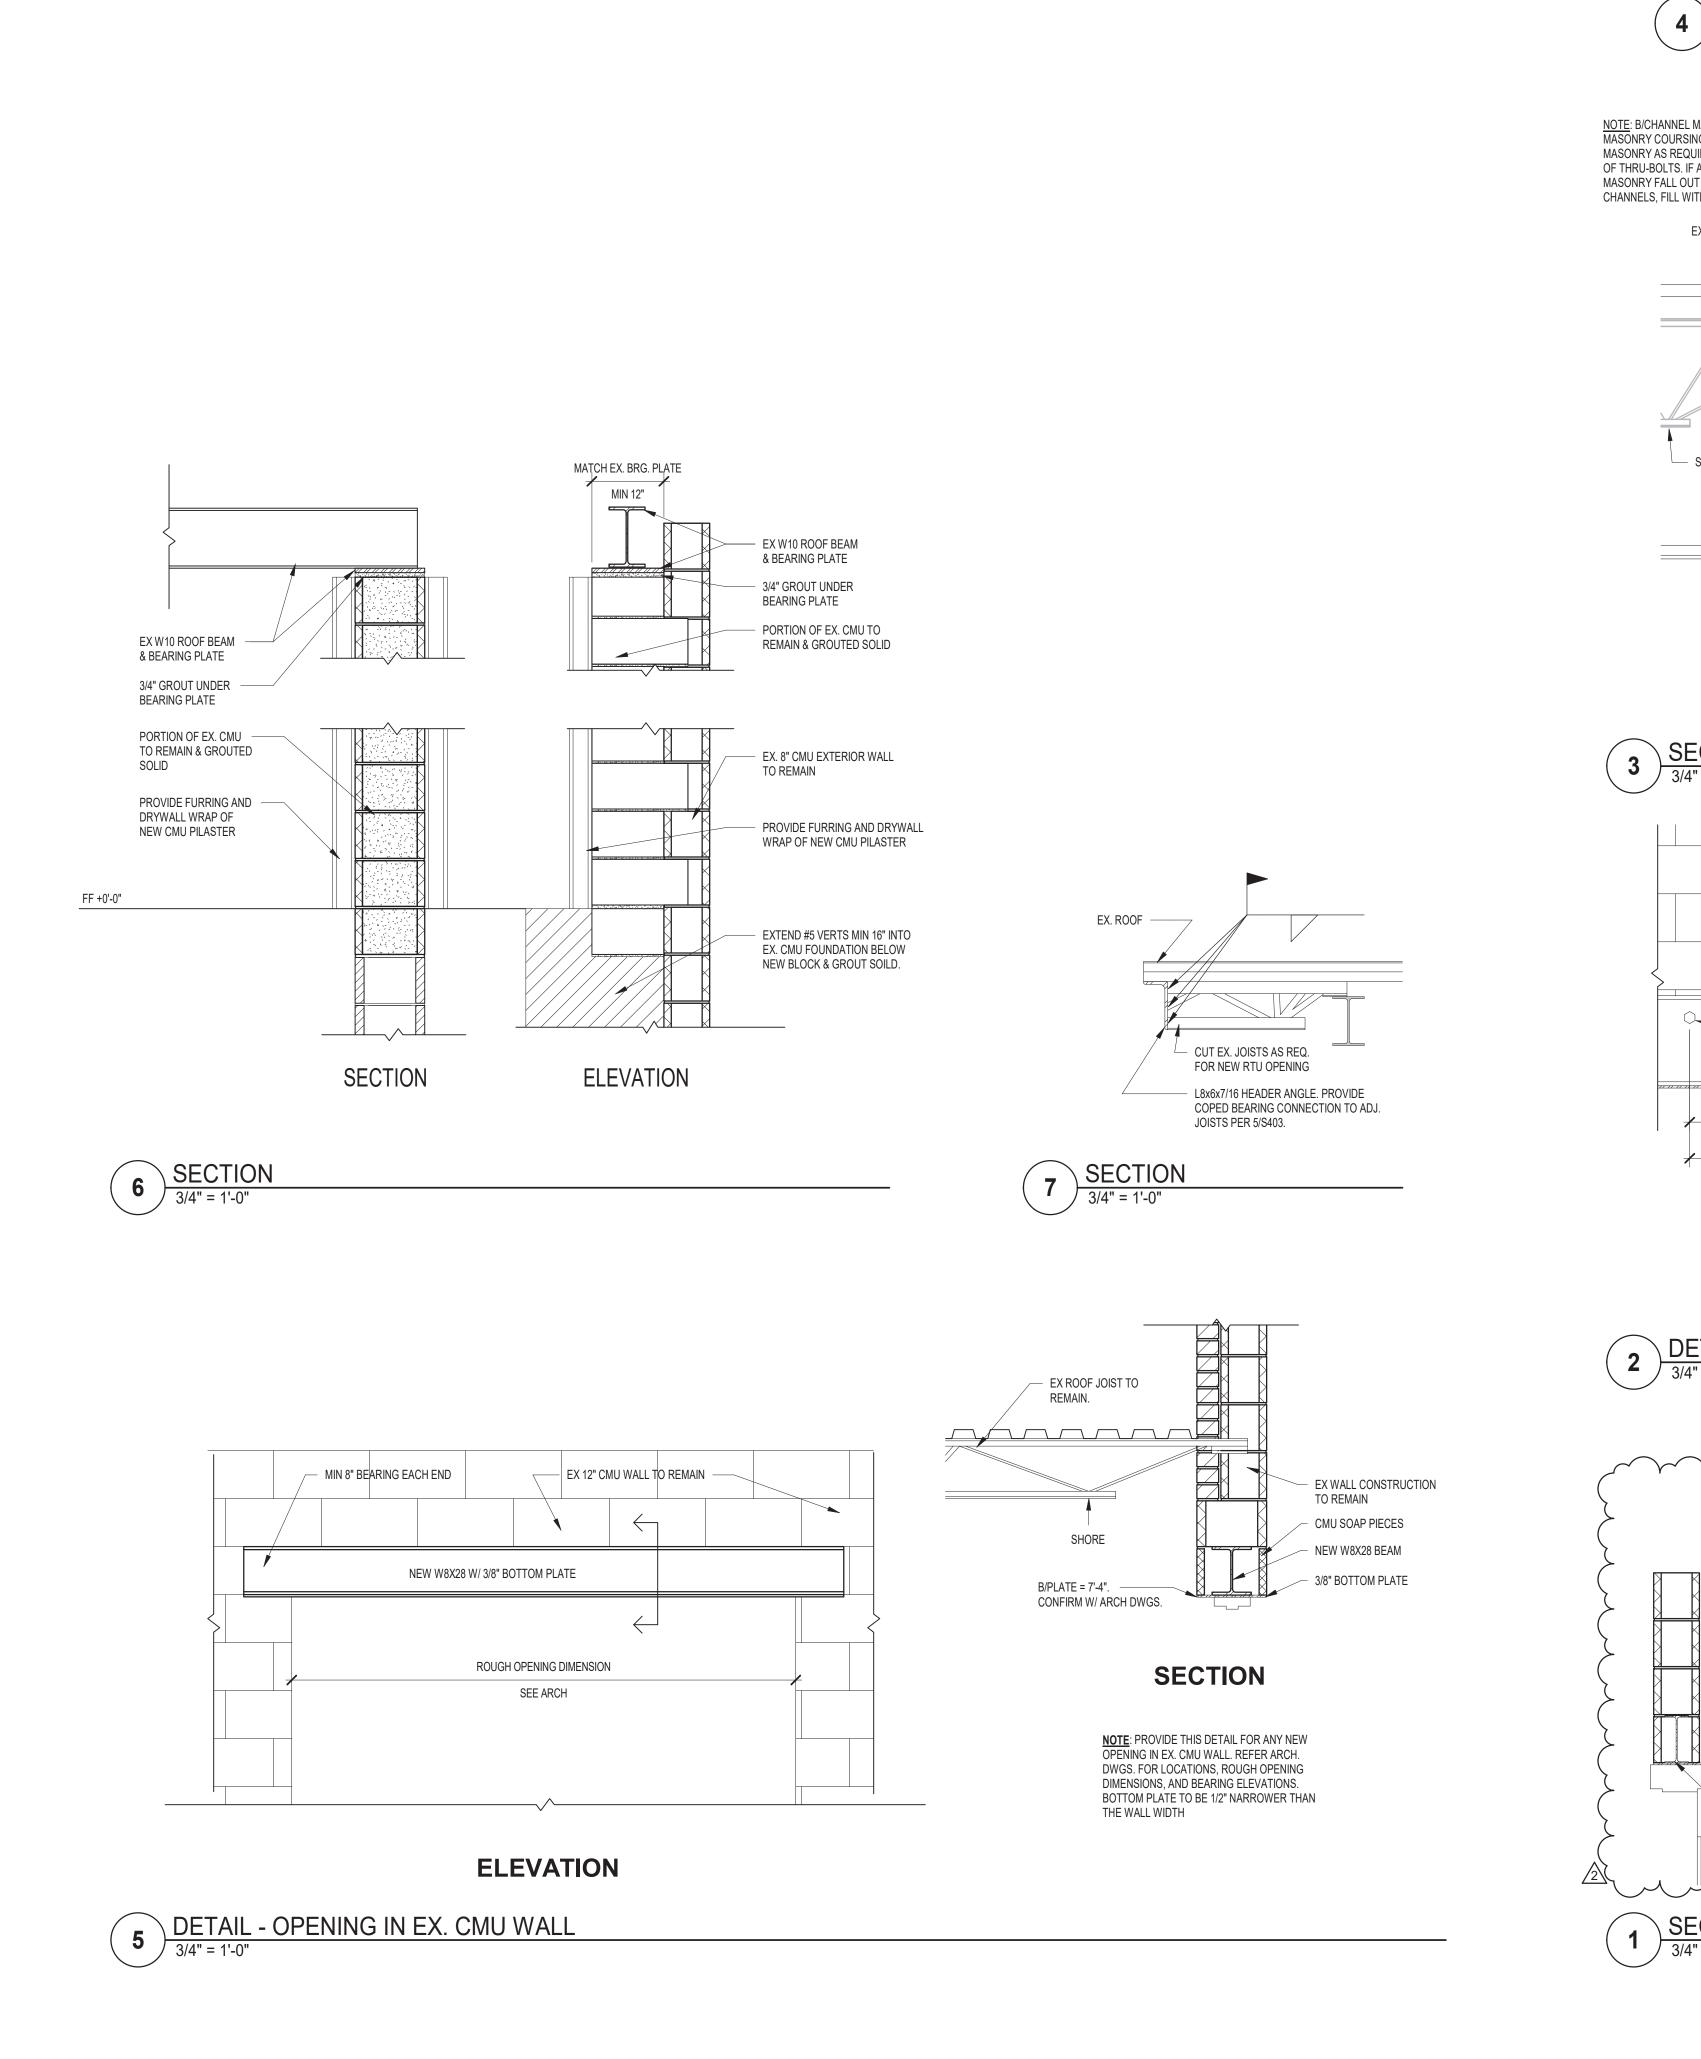


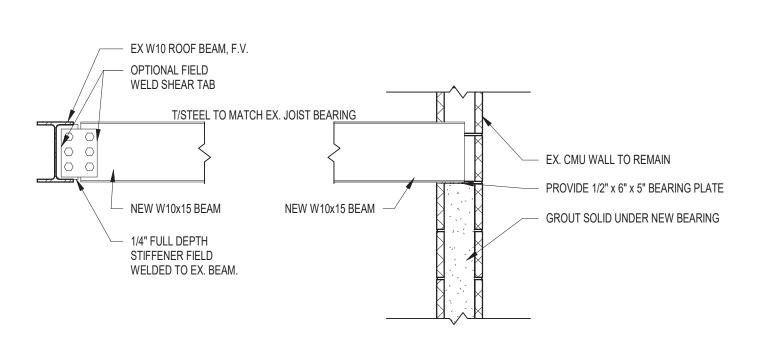




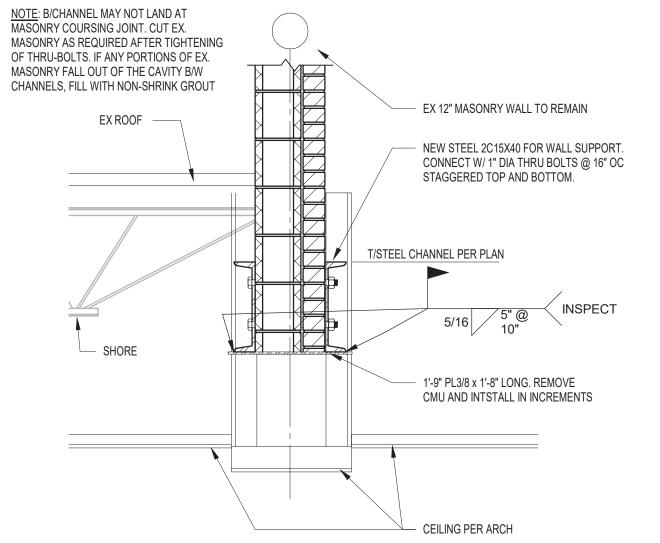

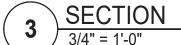

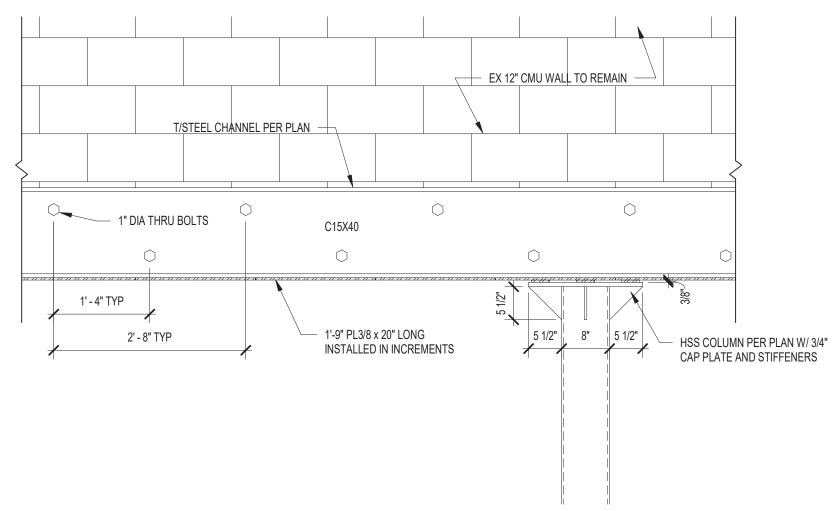

## DETAIL - DOUBLE CHANNEL ELEVATION 3/4" = 1'-0"

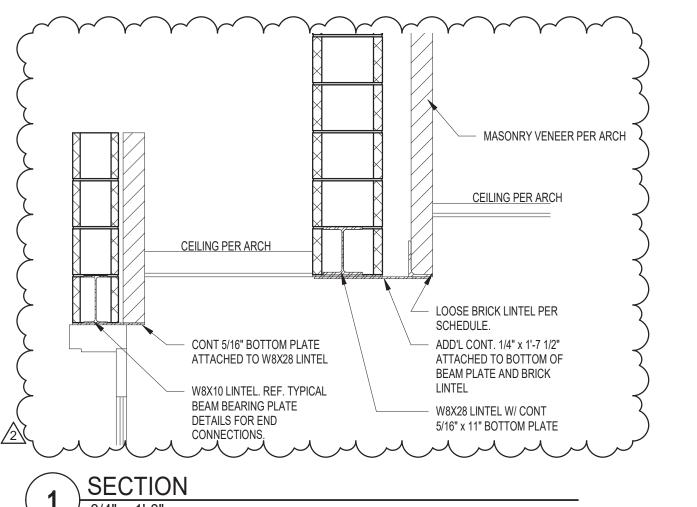

MSD OF WARREN TOWNSHIP
HAWTHORNE ELEMENTARY SCHOOL
RENOVATION & ADDITION
8301 RAWLES AVE, INDIANAPOLIS, IN 46219

SCOPE DRAWINGS:

These drawings indicate the general scope of the project in terms of architectural design concept, the dimensions of the building, the major architectural elements and the type of structural, mechanical and electrical systems.


The drawings do not necessarily indicate or describe all work required for full performance and completion of the requirements of the Contract.

On the basis of the general scope indicated or described, the trade contractors shall furnish all items required for the proper execution and completion of the work.

**REVISIONS:** Addendum 3 8/19/2022

ISSUE DATE | DRAWN BY | CHECKED BY 07/25/2022 JAW

DRAWING TITLE: FRAMING **DETAILS** 

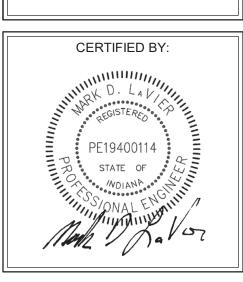

DRAWING NUMBER

2021054
Addition and Renovation
Hawthorne Elementary School
MSD of Warren Township

#### Addendum #3

To: All Bidders of Record

This addendum forms a part of and modifies the Bidding Requirements, Contract Forms, Contract Conditions, the Specifications and Drawings. This addendum is issued in accordance with the provision of "The General Conditions of the Contract for Construction, "Article 1, "Contract Documents" and becomes a part of the Contract Documents as provided therein. All Contractors shall incorporate into the contract documents and into their bid the following changes and clarifications to the drawings, specifications and scope of work.

Acknowledge receipt of this addendum in the location provided on the bid form.

#### **Plumbing**

Specifications: N/A

Drawings: N/A

#### **Mechanical**

Specifications:

Item 1. Section 23 63 13 Air Cooled Condensing Unit

Paragraph 1.02: Add York as an acceptable manufacturer.

Item 2. Section 23 73 13 Air-Handling Units

Paragraph 2.01 A: Add York as an acceptable manufacturer.

Item 3. Section 23 75 33 Packaged Make-Up Air Units

Paragraph 2.01 B: Add York as an acceptable manufacturer.

Item 4. Section 23 82 19 Fan Coil Units

Paragraph 2.01 G: Add Johnson Controls as an acceptable manufacturer.

2021054 Addition and Renovation Hawthorne Elementary School MSD of Warren Township

#### Drawings:

## Item 1. Sheet M302, MECHANICAL PIPING DETAILS Modify the EQUIPMENT SCHEDULE as follows:

Add Wessels NLA Series as acceptable manufacturer for ET-1.

Add Wessels SPA-S Series as acceptable manufacturer for AS-1.

#### **Electrical**

#### Specifications:

#### Item 1. Specification 260519 Wires and Cables

Add the following: 260519.2.01.A.3 Power and Control Signal Cable.

Southwire MC-PCS Duo (or equal from manufacturer listed under 260519.2.01.A.1) may be used within classrooms as fixture/switch whips only. A EMT homerun from panel to room is still required.

Item 2. Specification Section 260925 Occupancy Sensors 260925.1.04.A add Sensor Worx as an acceptable manufacture.

#### Drawings:


- Item 1. Sheet E102 Electrical Site Demolition Plan Replace with attached drawing.
- Item 2. Sheet E103 Electrical Site Plan Replace with attached drawing.
- Item 3. Sheet ED201A First Floor Power and Systems Demolition Plan Unit A
  Remove existing buss tap, raceway and fused disconnect located adjacent to Main Distribution
  Panel to make room for new 1200A/3P fused disconnect switch.
- Item 4. Electrical Demolition Plan Notes (Sheets ED201A,B,C,D)

Revise plan note #5 to read as follows.

Existing devices to remain that are installed into walls that are to be furred out are to be adjusted for new wall depth and provide new receptacle and coverplate. Typical of all. Other electrical devices are to be reinstalled with existing coverplates.

#### Attachments:

E102 - Electrical Site Demolition Plan E103 - Electrical Site Plan

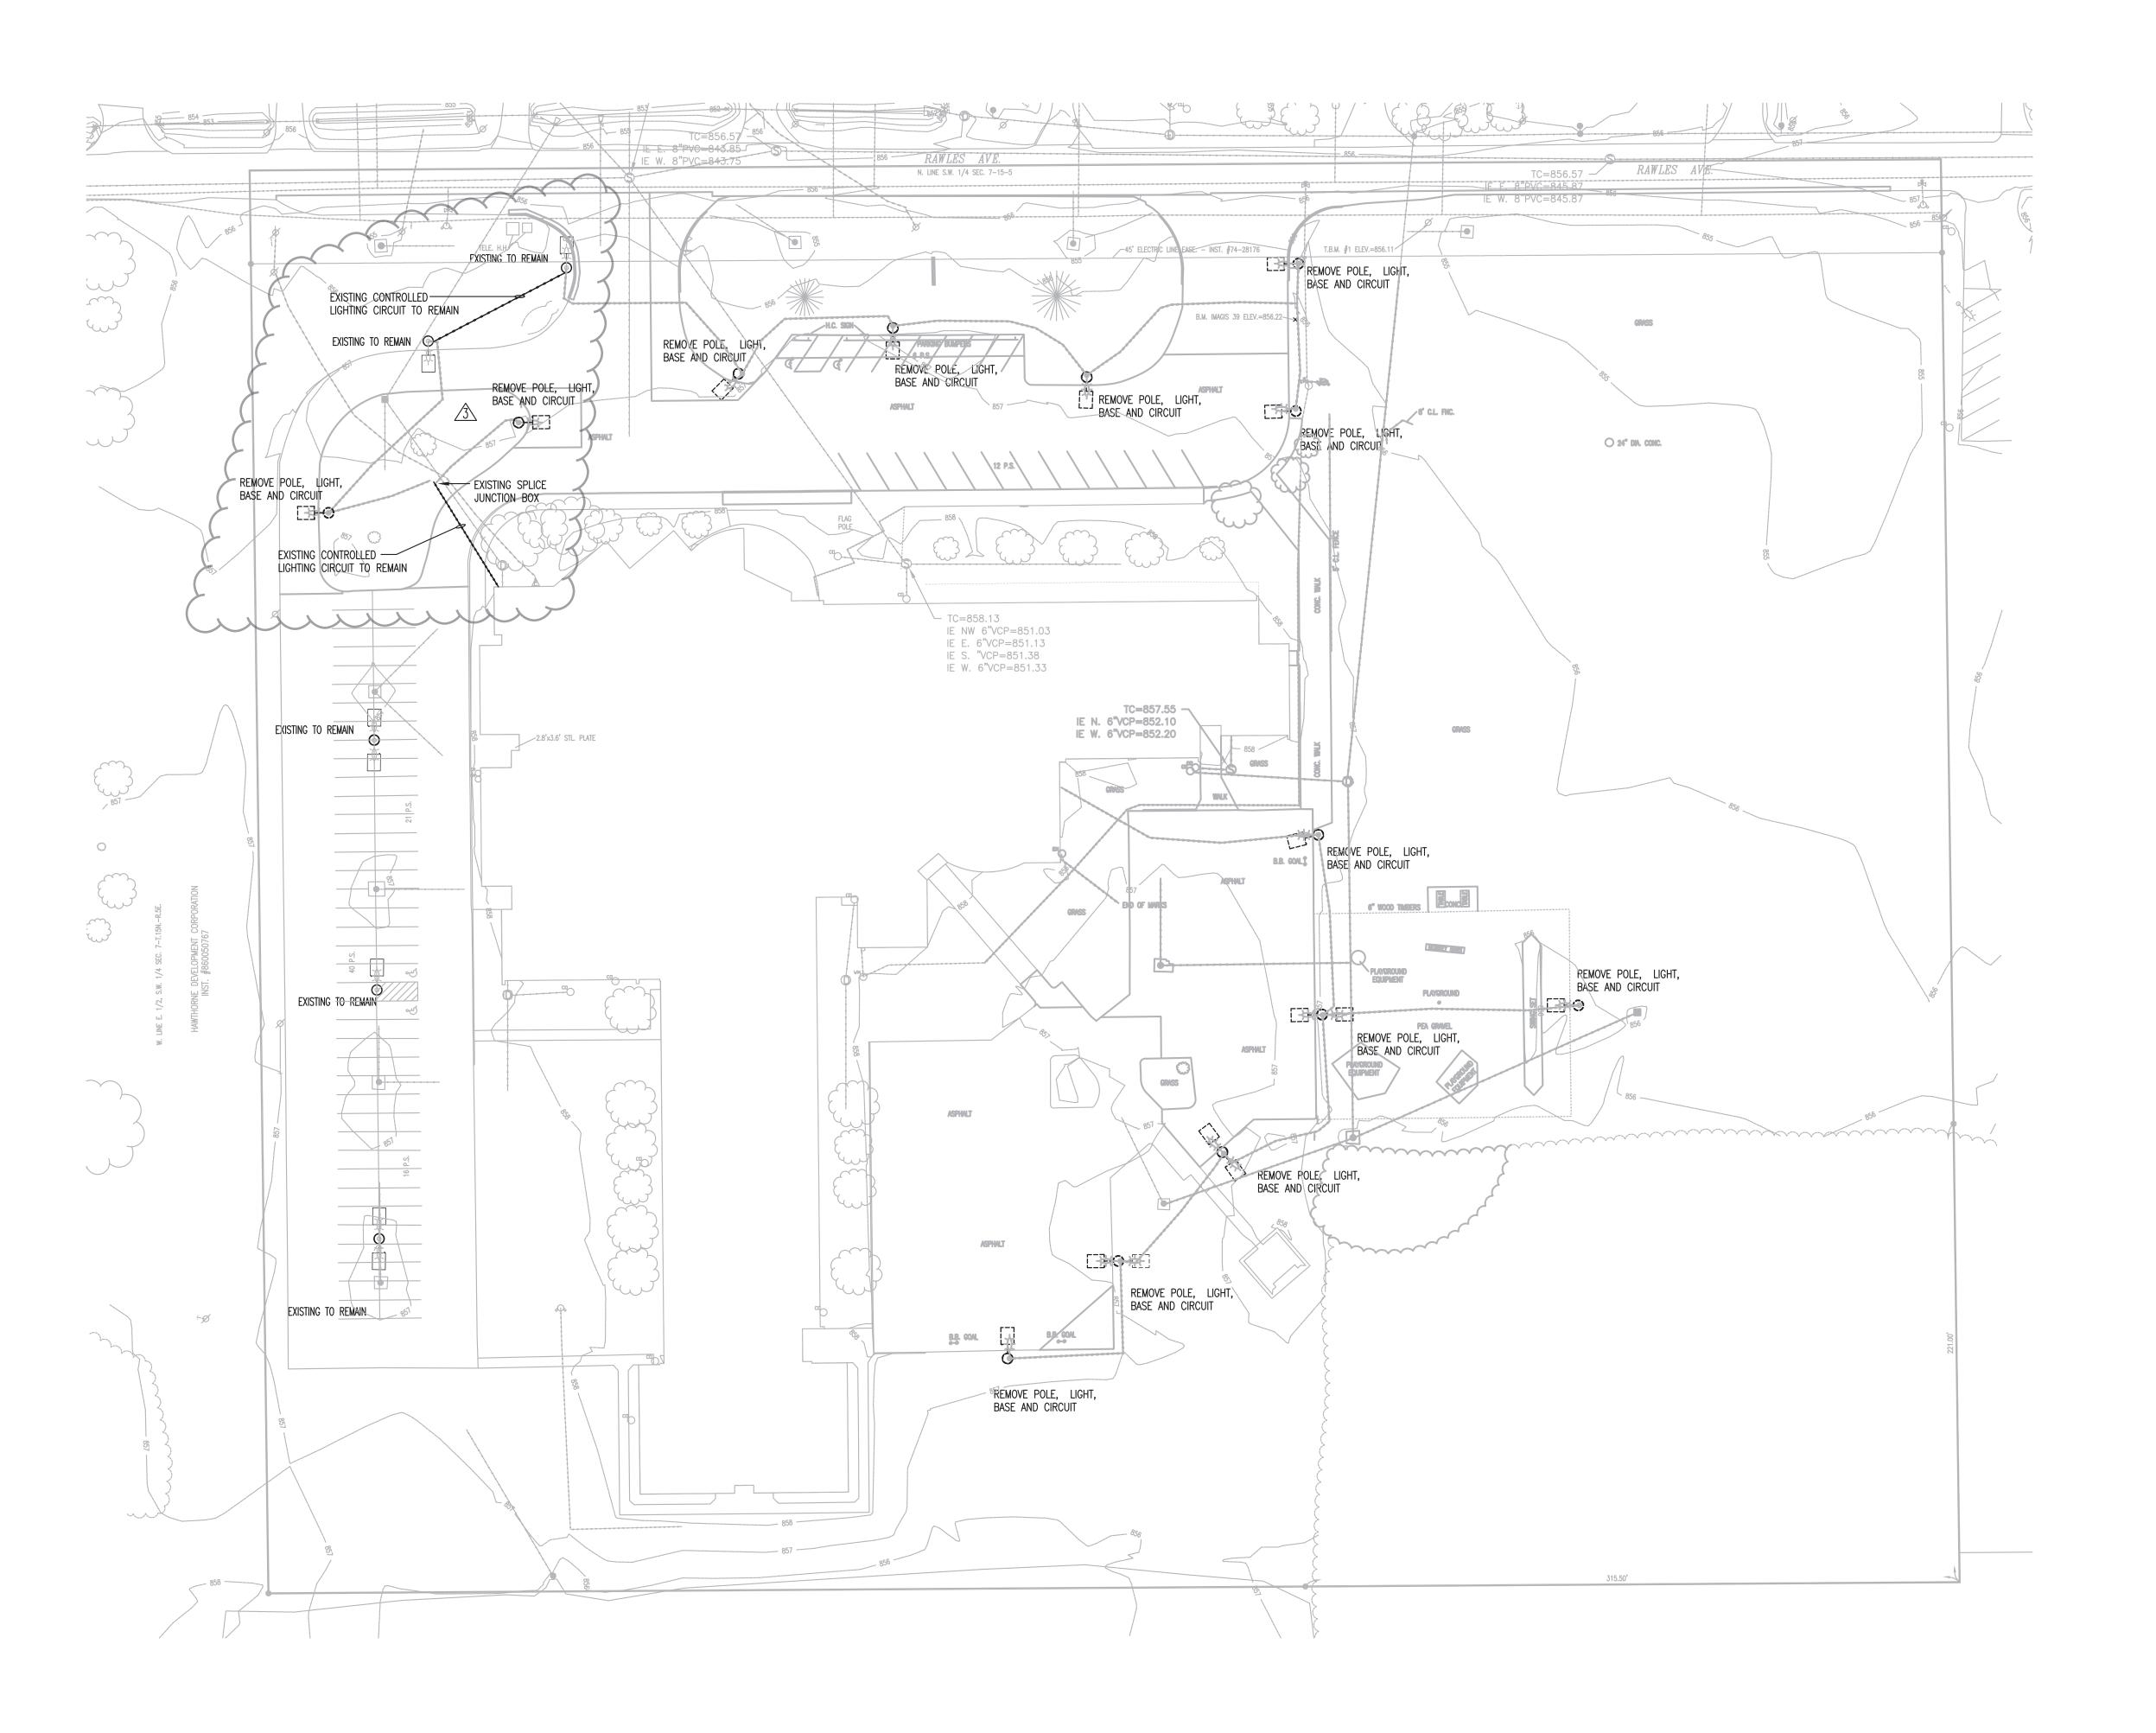

ELECTRICAL SITE DEMOLITION PLAN
SCALE: 1" = 40'-0"



S831 Keystone Crossing, Indianapolis, IN 4624

ADDITIONS AND RENOVATIONS
AWTHORNE ELEMENTARY SC
8301 RAWLES AVE, INDIANAPOLIS, IN 46

T0 100L 319

SCOPE DRAWINGS.

These drawings indicate the general scope of the project stress of architectural design concept, the dimensions of building, the major architectural elements and the type tructural, mechanical and electrical systems.

The drawings do not necessarily indicate or describe all required for full performance and completion of the irements of the Contract.

On the basis of the general scope indicated or described, trade contractors shall furnish all items required for the er execution and completion of the work.

REVISIONS.

ADDENDUM #3 8/19/22


ISSUE DATE DRAWN BY CHECKED
7/25/22 SQD WWH

ELECTRICAL SITE DEMOLITION



E102

PROJECT NUMBER 2021054/1404

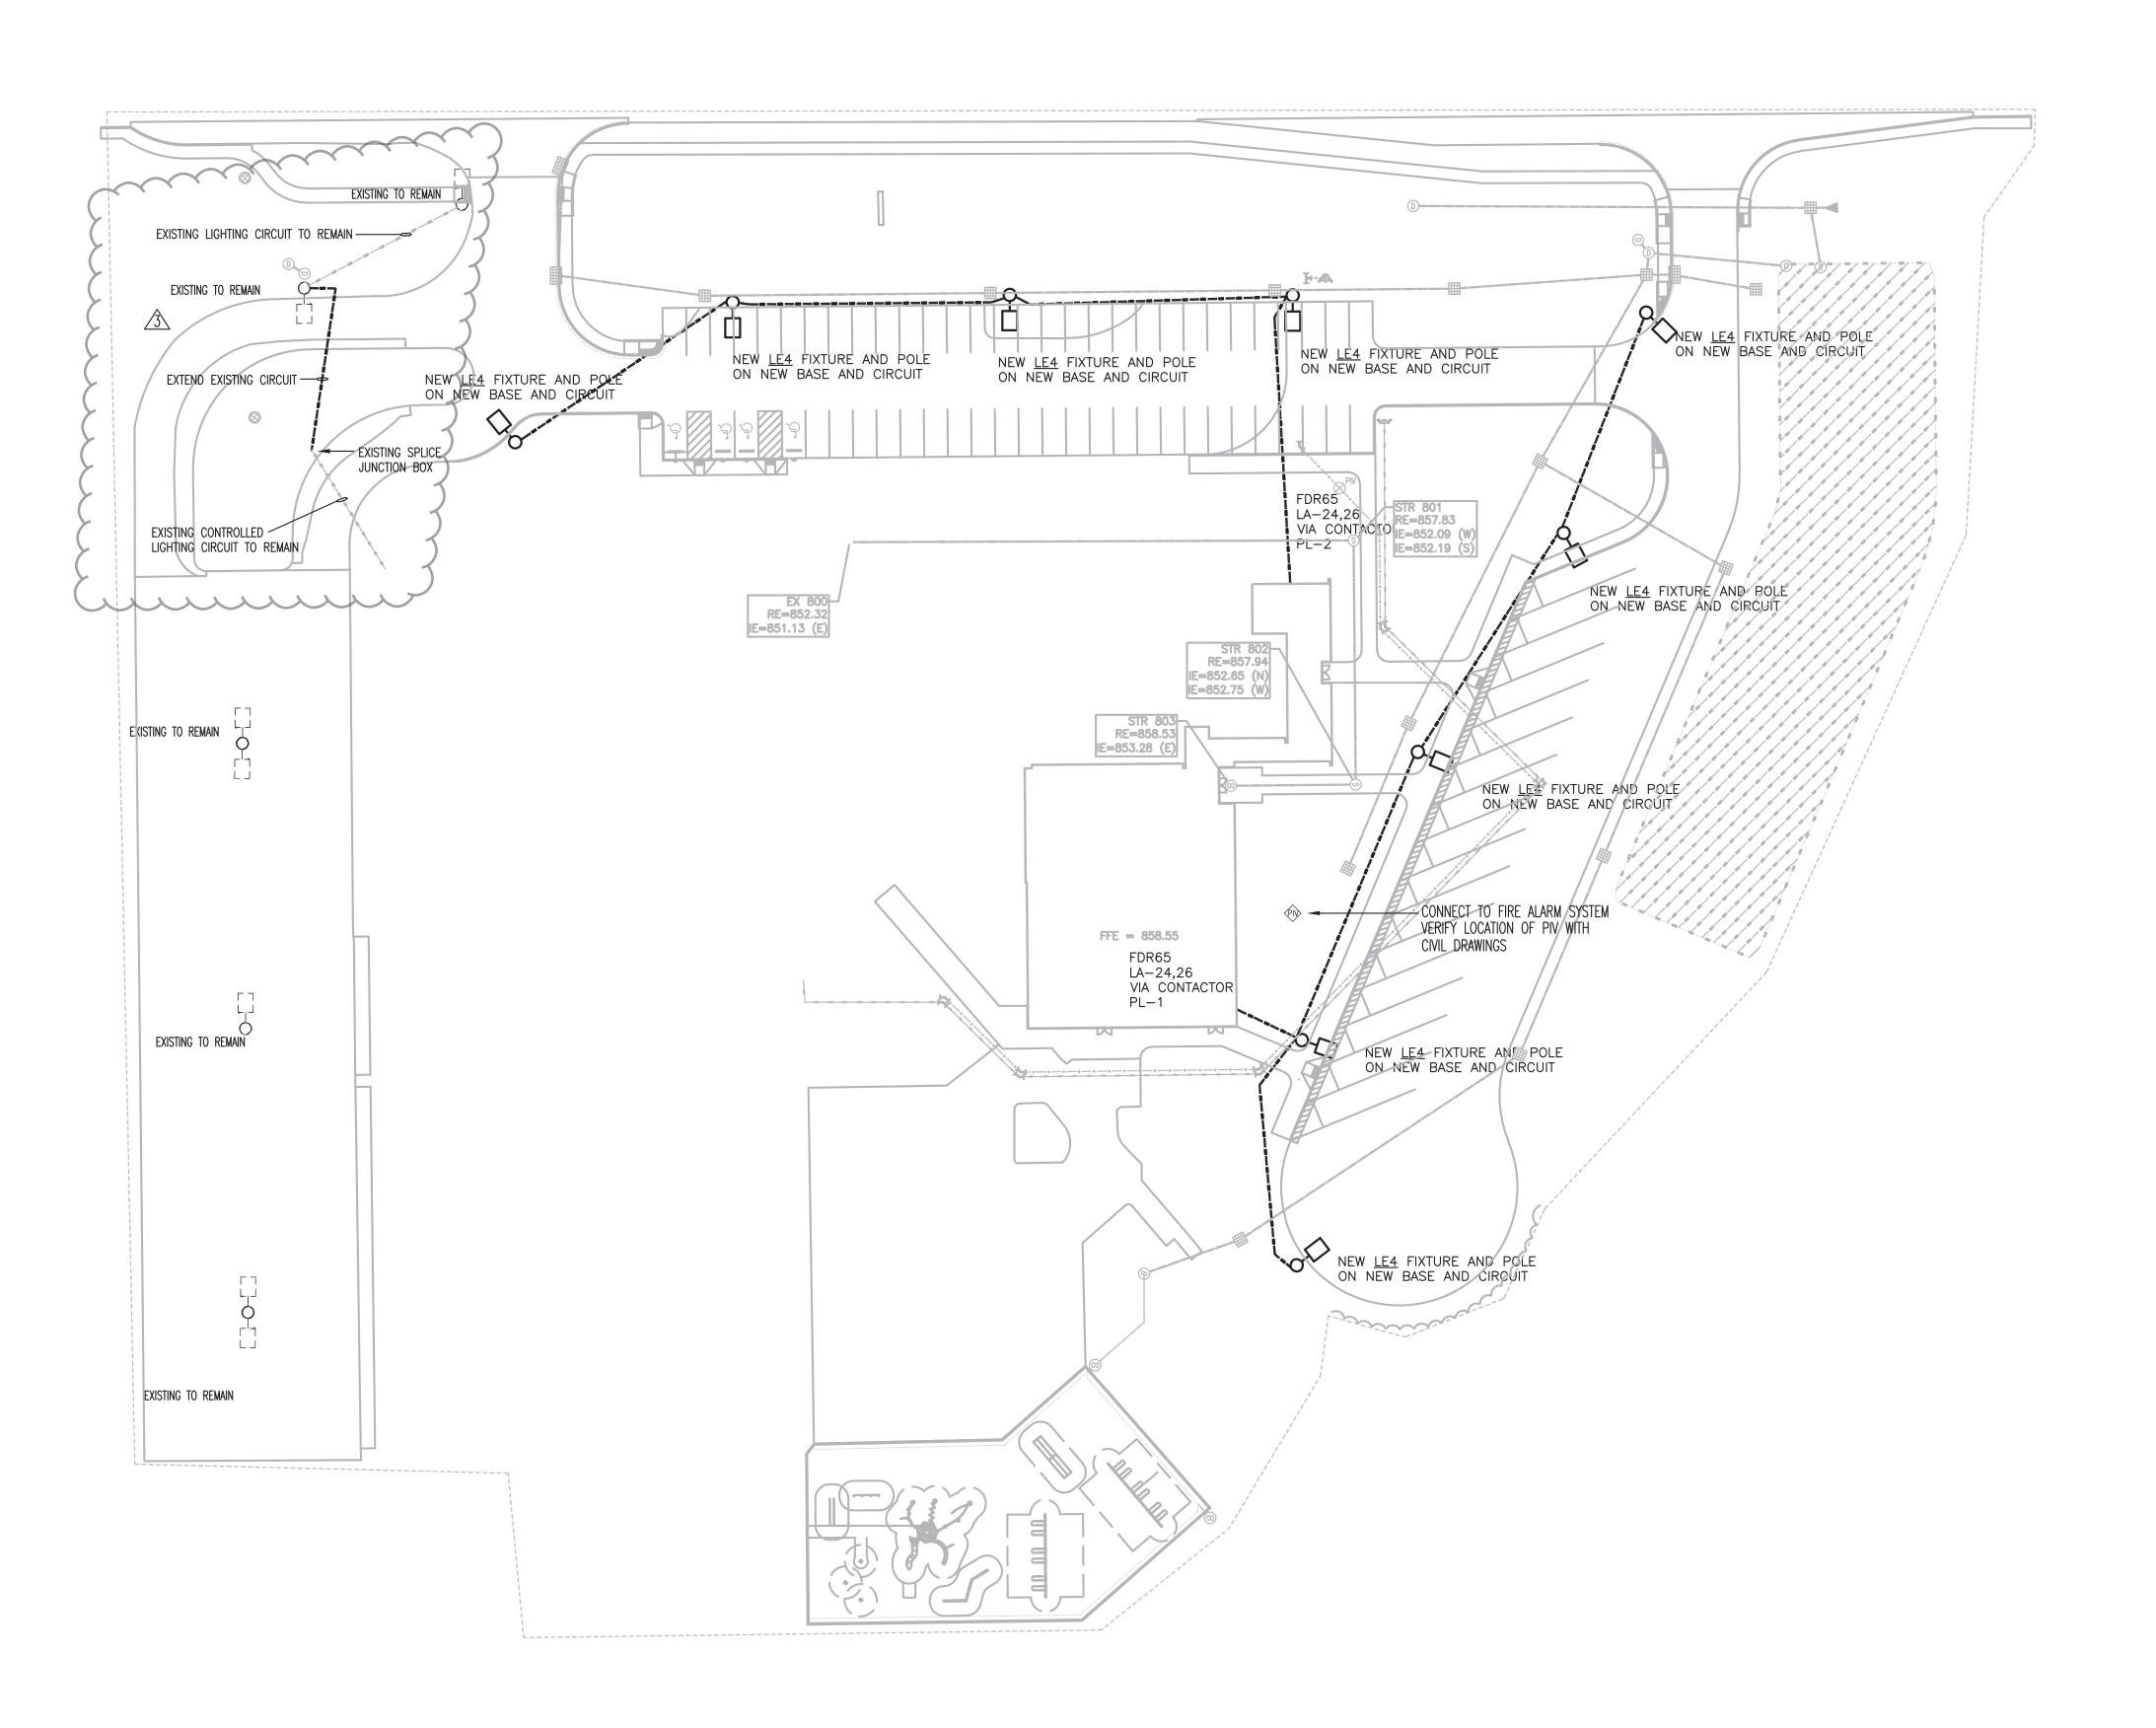

# ELECTRICAL SITE PLAN SCALE: 1" = 40'-0"

CONTACTOR	LOAD	TYPE	CONTACT RATING	POLE QTY	COIL VOLTAGE	COIL CIRCUIT	CIRCUITS CONTROLLED	NOTE
PL-1	PARKING LOT	ELECTRICALY HELD	30A	3	120V	LA24	LA24,26	1,2
PL-2	PARKING LOT	ELECTRICALY HELD	30A	3	120V	LA24	LA24,26	1,2

EXTERIOR LED LIGHT FIXTURE SCHEDULE											
TYPE	DESCRIPTION	VOLT	LAMP NO. and TYPE	MOUNT	LENS	REMARKS	MANUFACTURER				
LE4	PARKING/AREA LIGHT, DIE CAST ALUMINUM HOUSING 3 MIL TGIC POWDER COAT FACTORY STANDARD COLOR IP65 BODY AND IP66 LIGHT ENGINE RATING L99 @ 100,000 HOURS LUMEN OUTPUT 10KV SURGE PROTECTION BLACK FIXTURE COLOR	208	(1) 21000 LUMEN LED @4000K	30' SQUARE BLACK POLE 100MPH EPA RATED BASE TYPE "A"	TYPE 3 DISTRIBUTION	COLD WEATHER DRIVER	LITHONIA D SERIES KIM KLF MCGRAW EDISON GALLEON LUMENCON DETRIOT SERIES				

- 1. LIGHT FIXTURE DESIGNATIONS ARE THE SAME FOR LAY-IN CEILING AND DRY WALL CEILING. CONTRACTOR TO VERIFY CEILING TYPE PRIOR TO ORDERING FIXTURES.
- 2. ELECTRICAL CONTRACTOR IS TO PROVIDE ALL NECESSARY HARDWARE AND ACCESSORIES FOR COMPLETE INSTALLATION OF LIGHT FIXTURES ACCORDING TO MANUFACTURER'S RECOMMENDATIONS.
- 3. ALL FIXTURES TO BE LISTED IN THESE CONFIGURATIONS BY DESIGN LIGHT CONSORTIUM.

4. ALL FIXTURES REQUIRED TO INCLUDE "LIGHTING FACTS" SHEET.

3 ADDENDUM #3 8/19/22

DRAWING TITLE: **ELECTRICAL PLAN** 

**CERTIFIED BY:** 

DRAWING NUMBER E103

PROJECT NUMBER 2021054/1404

