ADDENDUM NO. 1

September 23, 2022

TIPPECANOE VALLEY HIGH SCHOOL ADDITIONS & RENOVATIONS Akron, IN 46910

TO: ALL BIDDERS OF RECORD

This Addendum forms a part of and modifies the Bidding Requirements, Contract Forms, Contract Conditions, the Specifications, and the Drawings dated September 9, 2022 by Fanning Howey Associates, Inc. Acknowledge receipt of the Addendum in the space provided on the Bid Form. Failure to do so may subject the Bidder to disqualification.

This Addendum consists of pages ADD 1-1 and attached Addendum No. 1 from Fanning Howey Associates, Inc. dated September 23, 2022 and consisting of 2 pages and 4 drawings.

ADDENDUM NO.1

Tippecanoe Valley High School Additions and Renovations

Project No. 220158.00


Tippecanoe Valley School Corporation Akron, Indiana

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Addendum No. 1, 1 item, 1 page New Drawing Sheets: FP2.01, FP2.02, FP.02, and FP.03

Date: September 23, 2022

FANNING/HOWEY ASSOCIATES, INC. ARCHITECTS/ENGINEERS/CONSULTANTS

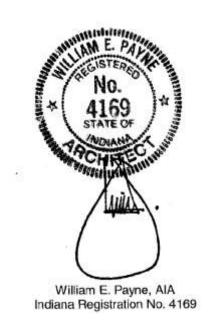

TO: ALL BIDDERS OF RECORD

ADDENDUM NO. 1 to Drawings and Project Manual, dated September 6, 2022 for Tippecanoe Valley High School Additions and Renovations for Tippecanoe Valley School Corporation, 8343 South State Road 19, Akron, Indiana 46910; as prepared by Fanning/Howey Associates, Inc., Indianapolis, Indiana.

This Addendum shall hereby be and become a part of the Contract Documents the same as if originally bound thereto.

The following clarifications, amendments, additions, revisions, changes, and modifications change the original Contract Documents only in the amount and to the extent hereinafter specified in this Addendum.

Each bidder shall acknowledge receipt of this Addendum in his proposal or bid.

NOTE: Bidders are responsible for becoming familiar with every item of this Addendum. (This includes miscellaneous items at the very end of this Addendum.)

RE: ALL BIDDERS

ITEM NO. 1. <u>NEW DRAWING SHEETS</u>

A. Drawing Sheet No's: FP2.01 – First Floor Fire Protection Plan, FP2.02 – Second Floor Fire Protection Plan, FP.02 – Fire Suppression Details and Notes, and FP.03 – Fire Suppression Site Plan and Details, dated 9/23/2022 are included with and hereby made a part of this Addendum.

END OF ADDENDUM

FIRE PROTECTION EQUIPMENT SCHEDULE								
ITEM	MAKE & MODEL NUMBER (OR APPROVED EQUAL)	DESCRIPTION	CAPACITY	ELECTRICAL CHARACTERISTICS	NOTES			
FIRE PUMP (FP-1)	ARMSTRONG 8 X 12 M VTF - 100 HP	CONSTANT SPEED DRIVE W/SOFT START CONTROLLER (SKID MOUNTED) VERTICAL TURBINE	750 GPM AT 100 PSI RISE	100 HP 460V/3PH	-			
JOCKEY PUMP (JP-1)	ARMSTRONG VMS-01:16B	MULTISTAGE VERTICAL TURBINE	7.5 GPM AT 110 PSI RISE	2 HP 480V 3 PH	-			
					-			

FIRE PUMP ASSEMBLY PIPING


DETAIL

N.T.S.

INDICATING TYPE FLOOR CONTROL VALVE WITH SUPERVISORY SWITCH (TYP.)-TEST AND DRAIN-VALVE ASSEMBLY FIRE MAIN TO-(TYP.) FLOW SWITCH ZONE (TYP.)-FIRE MAIN TO — ZONE FIRE MAIN TO **ZONE** TEST AND DRAIN-VALVE ASSEMBLY CHECK VALVE SIGHT GLASS SIGHT GLASS TS COMBINE ALL SYSTEM-DRAINS AND TERMINATE THRU EXTERIOR WALL WITH ESCUTCHEON AND SPLASH BLOCK. -CHECK VALVE WITH DRIP PIPE SUPPORT (TYP.) VALVE FINISHED FLOOR FROM BELOW FROM FIRE DEPT. CONNECTION

PLAN NOTES

- CONNECT TO EXISTING 4" WATER SERVICE PIPING DOWN STREAM OF SERVICE BACKFLOW, EXTEND THROUGH REDUCED PRESSURE ZONE DETECTOR ASSEMBLY, — - — -THROUGH AUTOMATIC FILL CONTROL VALVE, BELOW FLOOR SLAB AND THROUGH EXTERIOR BUILDING WALL TO FILL CONNECTION AT FIRE SUPPRESSION STORAGE TANK. SLEEVE PIPE PENETRATION ACROSS FOOTER AND ALL REQUIRED BEDDING, BACKFILL AND SURFACE RESTORATION.
- 2 4" UL/FM AUTOMATIC CONTROL AND FILL VALVE. WIRE ACTUATOR TO TANK MONITORING AND CONTROL PANEL ON WALL. PROVIDE 4" MANUAL SUPERVISED FILL BYPASS VALVE. AUTOMATIC CONTROL VALVE EQUAL TO WATTS LF930GC. AUTOMATIC CONTROL VALVE SOLENOID SHALL BE 120 VAC OR 24 V, COMPATIBLE WITH TANK LEVEL MONITOR AND CONTROL PANEL OUTPUT CAPABILITIES. SOLENOID SHALL BE POWERED-OPEN, NORMALLY CLOSED. VALVE ASSEMBLY SHALL INCLUDE VISIBLE POSITION INDICATOR AND DRY CONTACT LIMIT SWITCH TO NOTIFY VALVE POSITION TO THE FIRE ALARM SYSTEM.
- TANK LEVEL MONITORING AND CONTROL PANEL. EXTEND CONTROL WIRING TO FILL CONTROL VALVE. EXTEND LEVEL MONITORING WIRING AND CONDUIT TO EXTERIOR BELOW GRADE FIRE SUPPRESSION TANK LEVEL MONITORS. REFER TO DETAILS, SHEET FP.03 AND SPECS FOR ADDITIONAL REQUIREMENTS. BASIS OF DESIGN TANK LEVEL MONITORING PANEL IS PRECISION DIGITAL "CONSOLIDATOR" PD9000 SERIES OR FLOWLINE "COMMANDER MULTITANK CONTROLLER".
- 4 FILL PIPING DROPS BELOW GRADE.

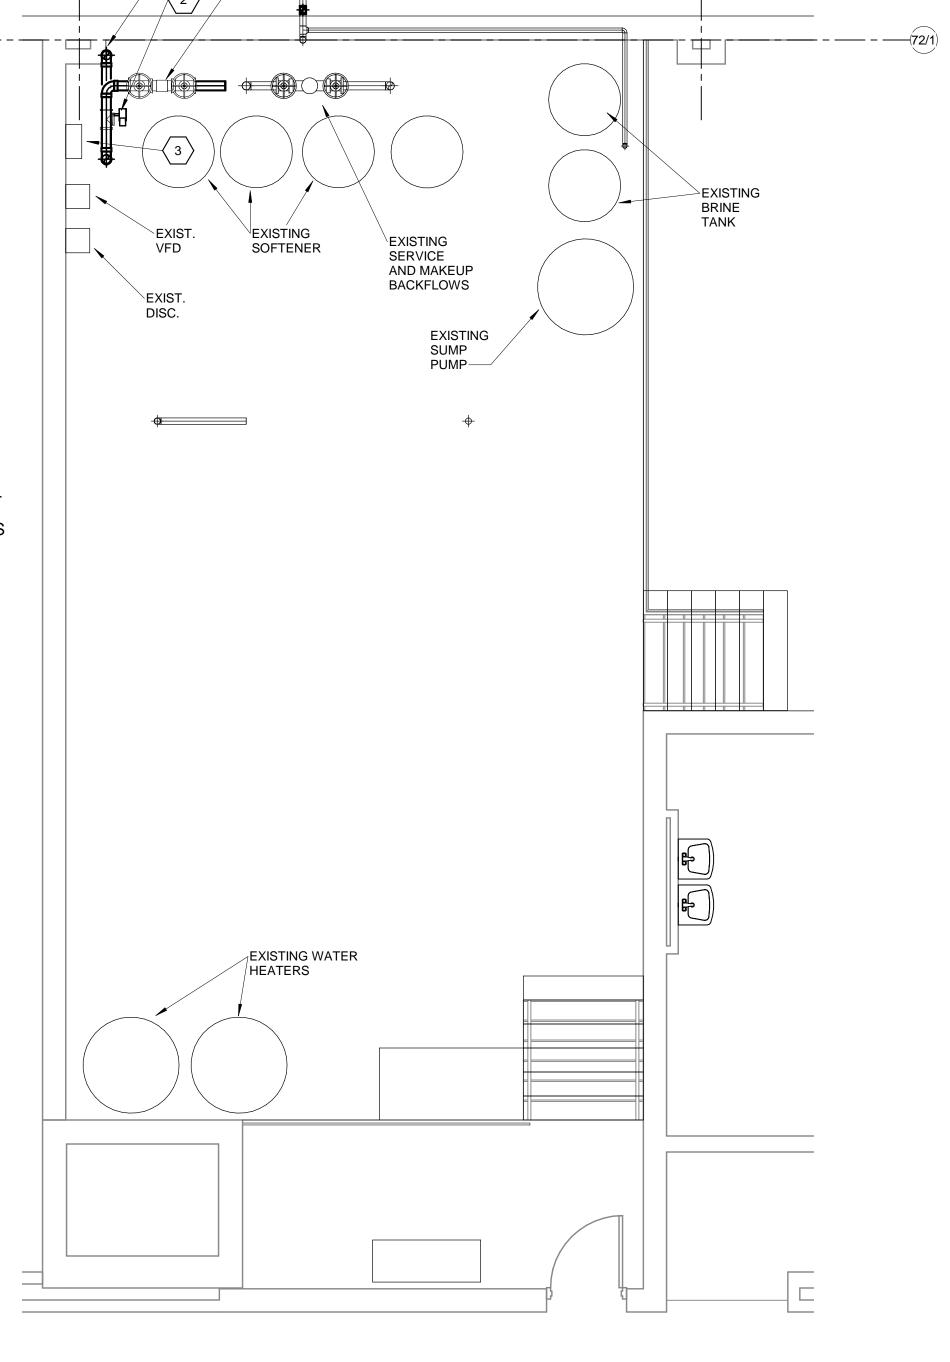

01-FIRE SUPPRESSION - FIRST FLOOR MECHANICAL ROOM SCALE: 1/4" = 1'-0"

TIPPECANOE VALLEY HIGH SCHOOL A & R

8345 STATE ROUTE 19, AKRON, IN

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TIPPECANOE VALLEY SCHOOL CORPORATION



ARCHITECT

FANNING HOWEY

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KEY PLAN

CONSTRUCTION DOCUMENTS





PROJECT MANAGER: MKS DRAWN BY: CSS PROJECT NUMBER: 220158.00 PROJECT ISSUE DATE: 9/6/2022

REV. NO.	DESCRIPTION	DATE


VERIFICATION NOTE

CONTRACTOR SHALL VERIFY ALL DIMENSIONS AND CLEARANCES AND ALL EXISTING FIELD CONDITIONS BEFORE STARTING CONSTRUCTION. COMMENCEMENT OF WORK CONSTITUTES ACCEPTANCE OF CONDITIONS SHOULD DIFFERENT CONDITIONS BE ENCOUNTERED, CONTACT THE ARCHITECT BEFORE PROCEEDING WITH WORK.

FIRE SUPPRESSION DETAILS AND **NOTES**


REFER TO ADDITIONAL DETAILS AND
EQUIPMENT SUPPLIER DOCUMENTS
FOR ADDITIONAL VALVES AND PIPING.


PROVIDE VALVED FIRE PUMP TEST FLOW METER BYPASS
AND ASSOCIATED PIPING AND PENETRATION BACK INTO
WATER STORAGE TANK.

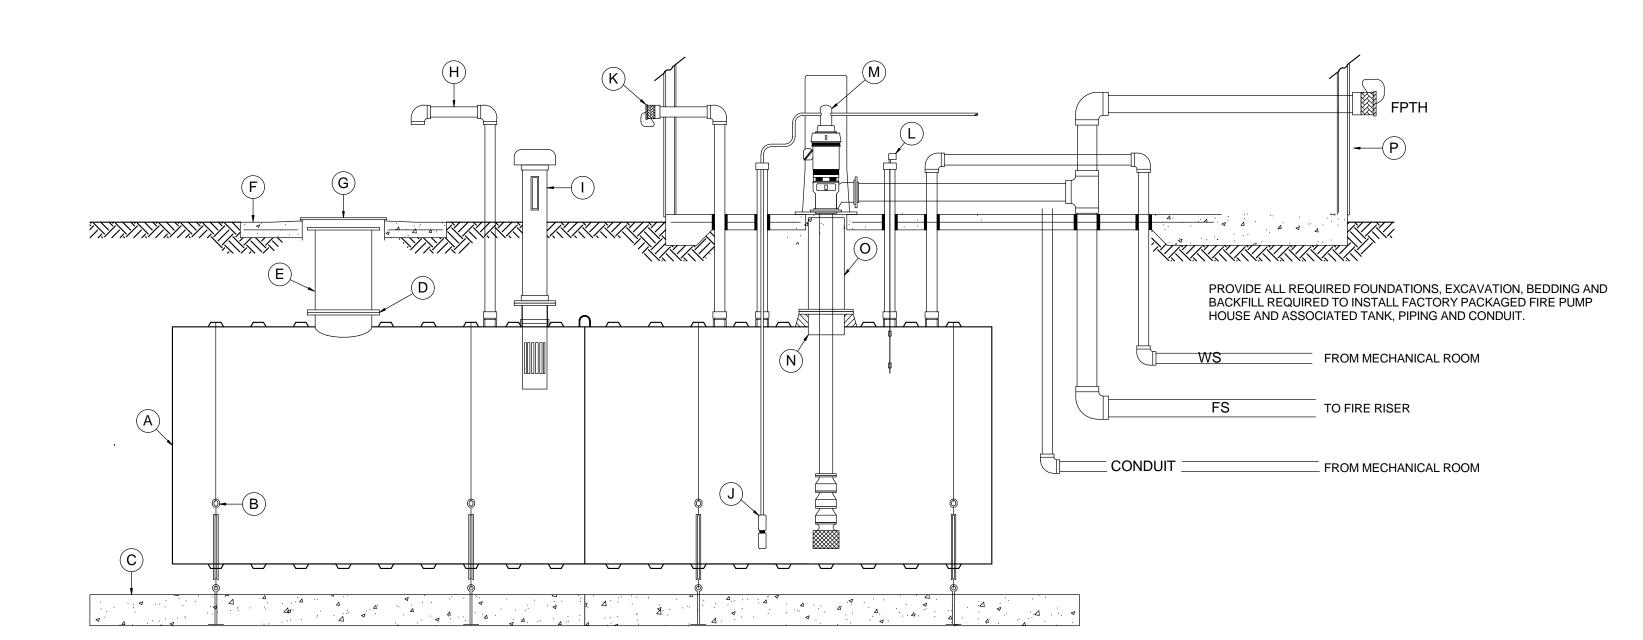


QTY		1			
	TANK MONITORING AND CONTROL POINTS	FA	FA & TANK	TANK MONITORING	NOTES
2	TANK WATER LEVEL RESTORED (ELEV. SETPOINT) - CLOSE FILL VALVE		Х		
1	TANK WATER LEVEL 6" BELOW SETPOINT - ACTUATE FILL VALVE			X	
2	TANK WATER LEVEL 12" BELOW SETPOINT		Х		
1	PUMP HOUSE TEMPERATURE BELOW 40 DEGREE F.		Х		
2	TANK OUTLET SHUT OFF VALVE SUPERVISION		X		
2	MANUAL TANK FILL BYPASS SHUT OFF VALVE SUPERVISION		Х		

GENERAL NOTES
ALARM POINTS INDICATED TO BE DISTRIBUTED TO THE FIRE ALARM
SYSTEM SHALL BE BY MODULE/RELAY ATTACHMENT THAT IS LISTED
AND COMPATIBLE WITH BUILDING FIRE ALARM SYSTEM.
ALARM POINTS INDICATED TO BE DISTRIBUTED TO THE TANK
MONITORING SYSTEM SHALL BE BY SENSORS AND/OR AQUASTATS
COMPATIBLE WITH THE TANK MONITORING SYSTEM.
CONTROL WIRING, CONDUIT, BEDDING, BACKFILL TO TANK FILL VALVE
FROM TANK MONITORING SYSTEM SHALL BE INCLUDED IN SCOPE.

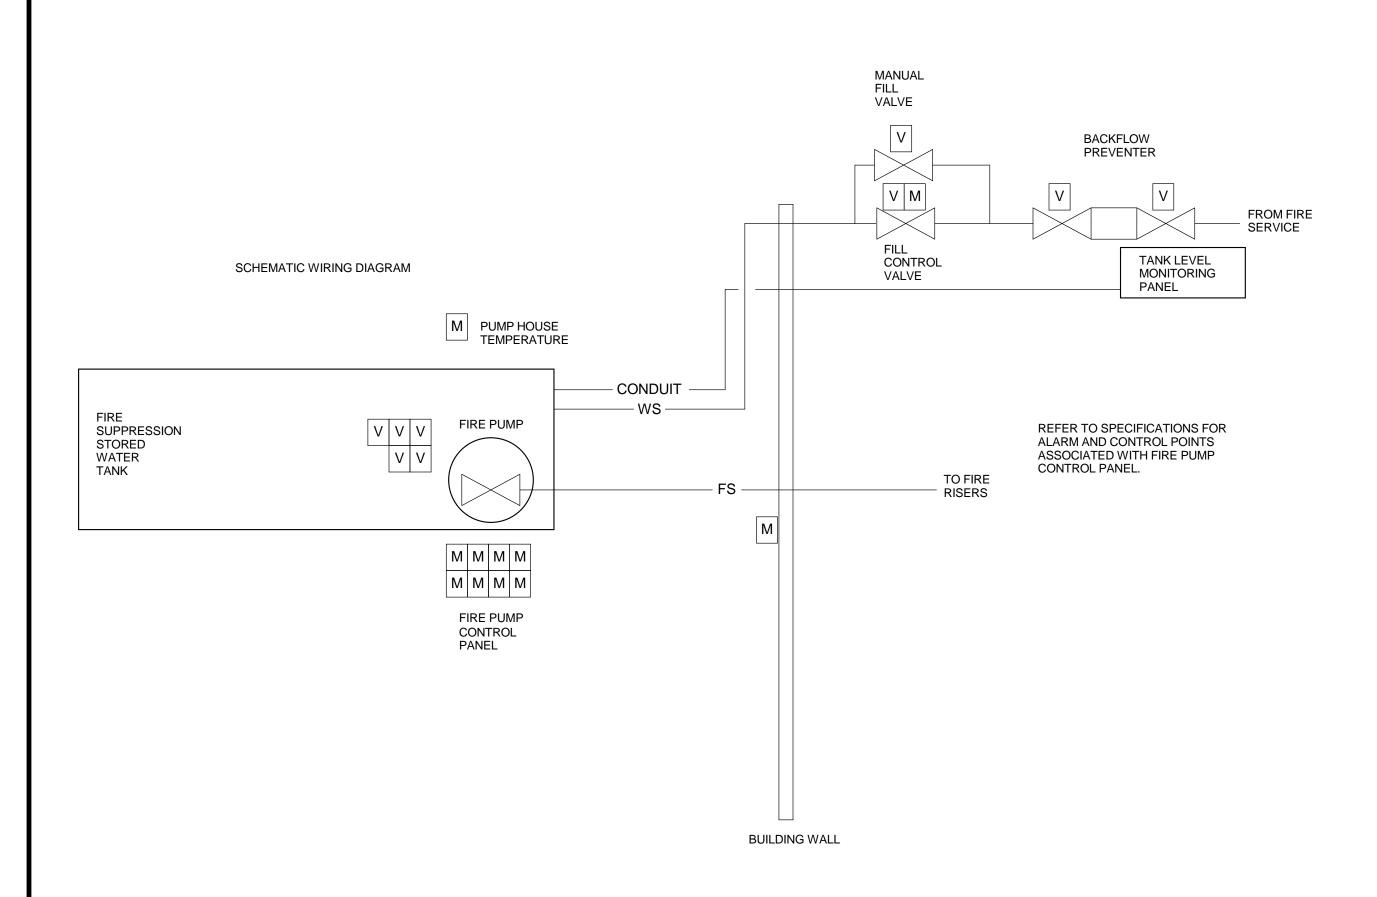

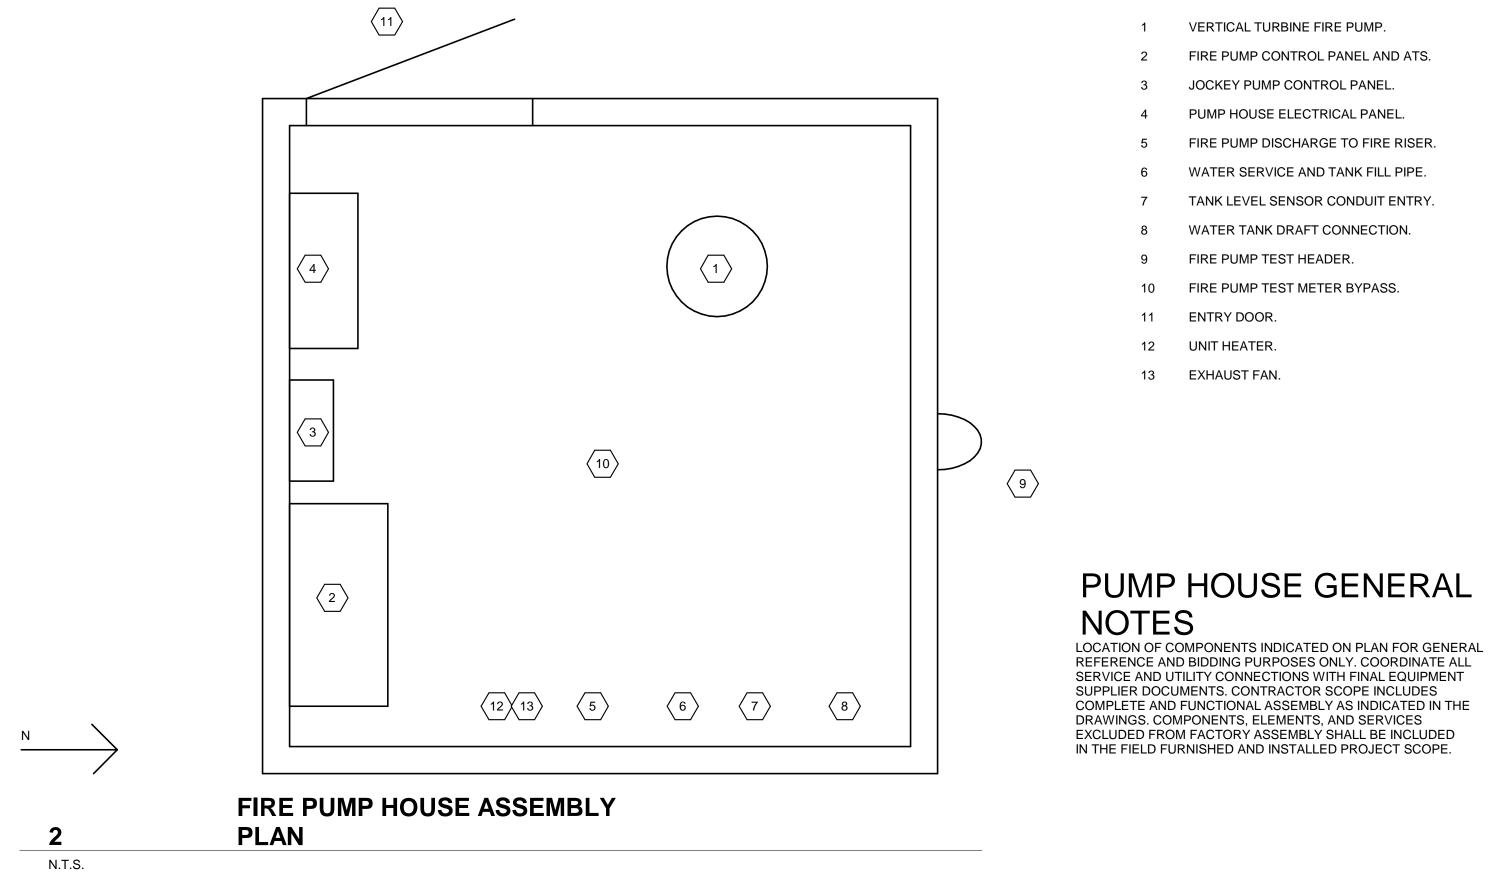

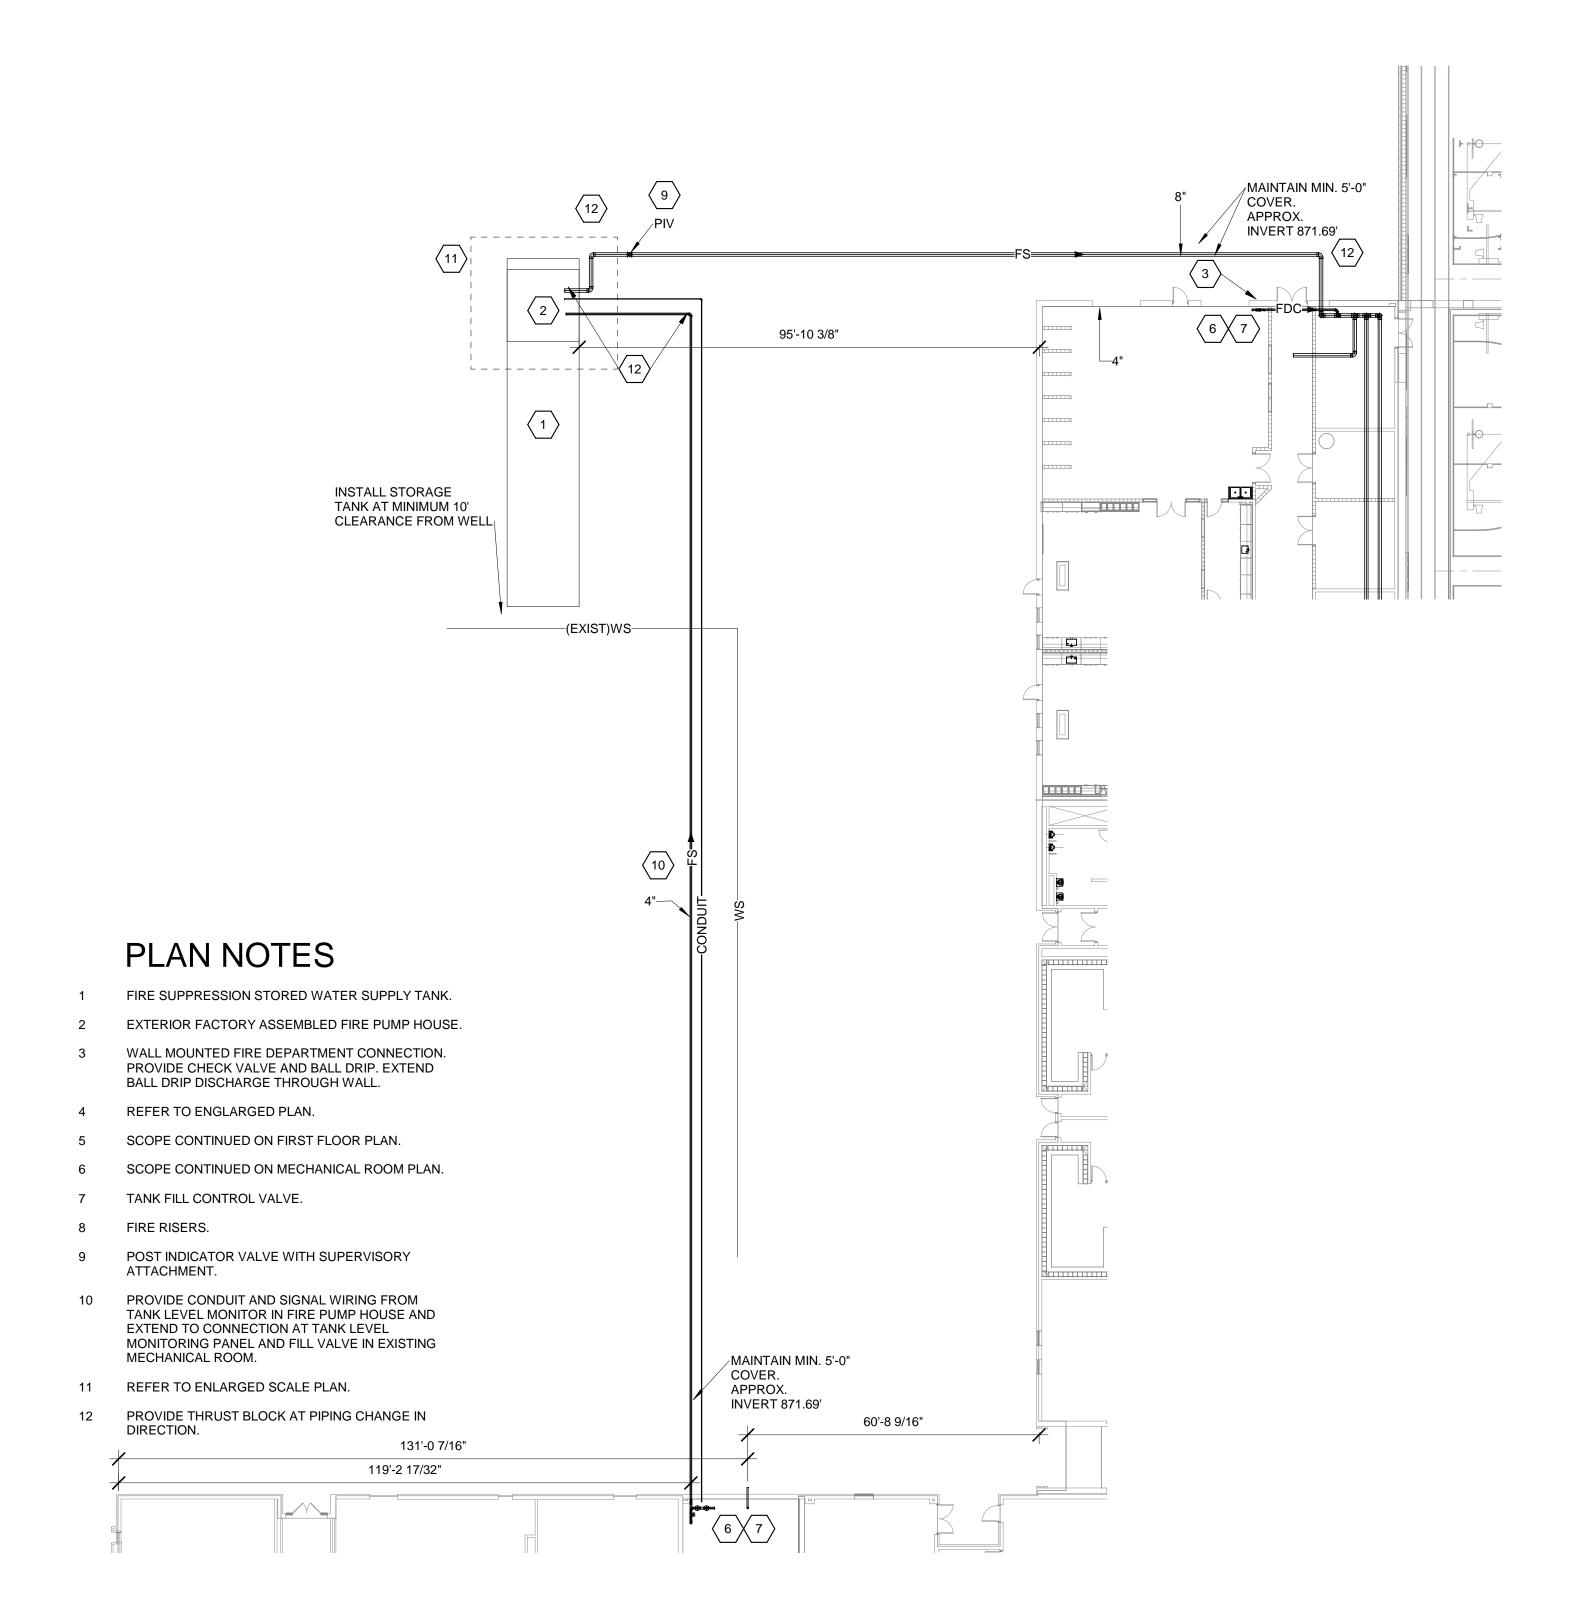

PUMP HOUSE NOTES

TIPPECANO

TIPPECANOE
VALLEY HIGH
SCHOOL A & R

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TIPPECANOE VALLEY
SCHOOL CORPORATION



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B
C
D
F

KEY PLAN

CONSTRUCTION DOCUMENTS

PE 12000601

PROJECT MANAGER: MKS
DRAWN BY: CSS
PROJECT NUMBER: 220158.00

PROJECT ISSUE DATE: 9/6/2022

REV. NO. DESCRIPTION DATE


VERIFICATION NOTE


CONTRACTOR SHALL VERIFY ALL DIMENSIONS AND CLEARANCES AND ALL EXISTING FIELD CONDITIONS BEFORE STARTING CONSTRUCTION. COMMENCEMENT OF WORK CONSTITUTES ACCEPTANCE OF CONDITIONS.

SHOULD DIFFERENT CONDITIONS BE ENCOUNTERED, CONTACT THE ARCHITECT BEFORE PROCEEDING WITH WORK.

FIRE SUPPRESSION SITE PLAN AND DETAILS

FP.03

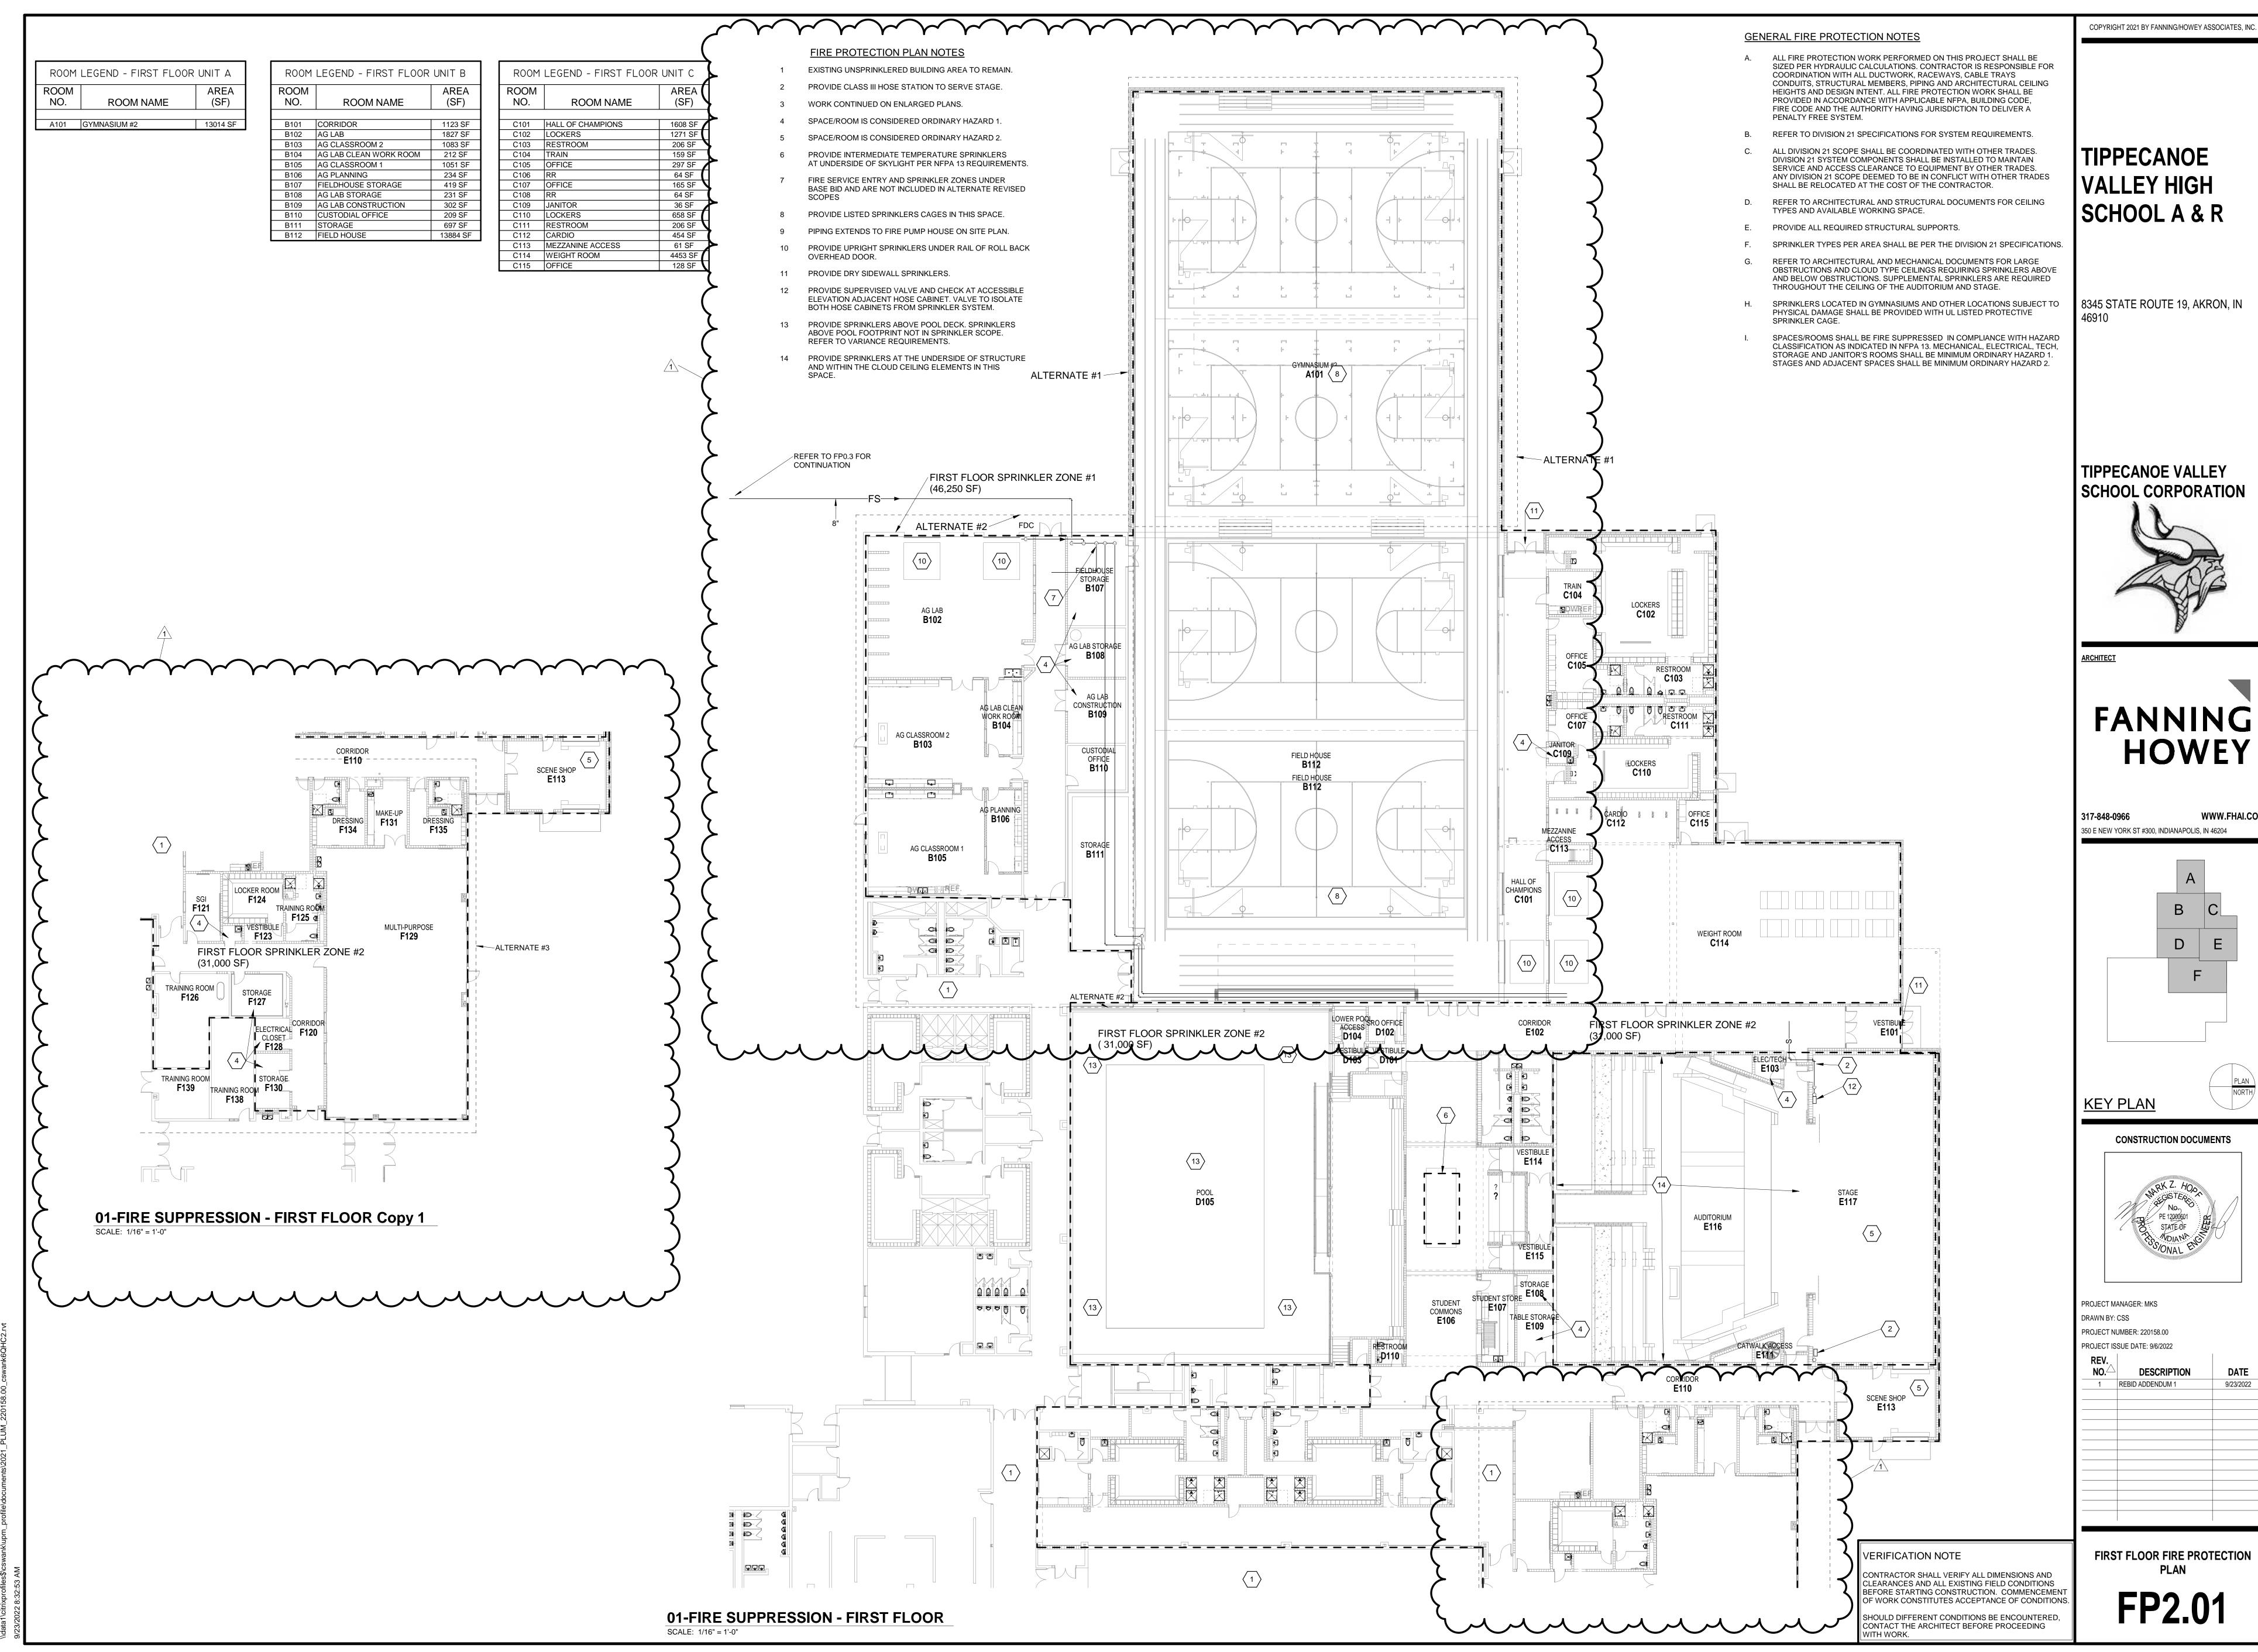

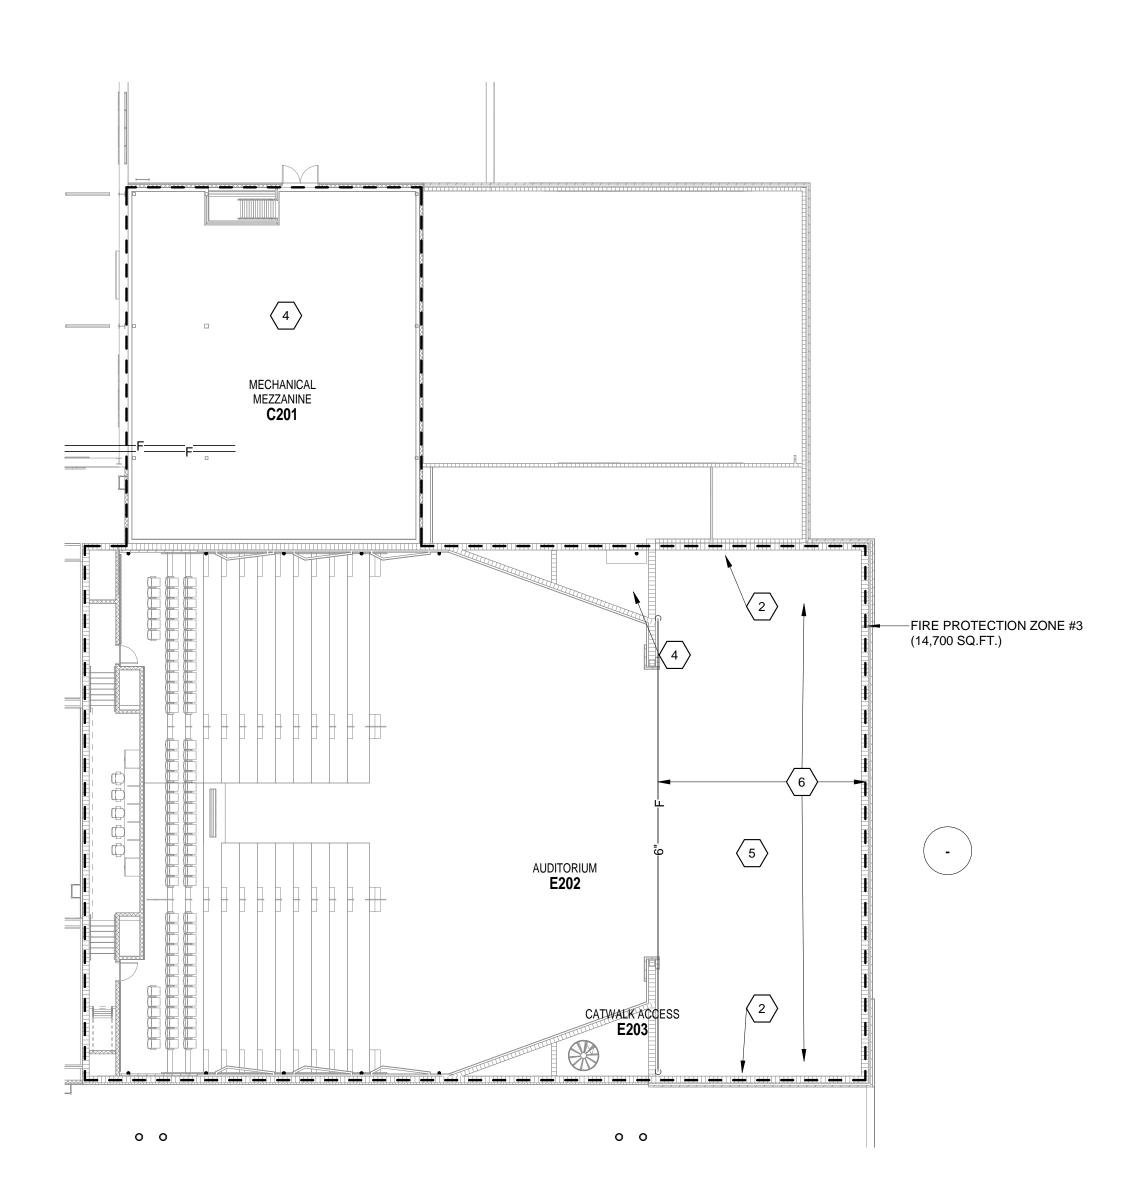

02-FIRE SUPPRESSION - SECOND FLOOR SCALE: 1/16" = 1'-0"

FIRE PROTECTION PLAN NOTES

- 1 EXISTING UNSPRINKLERED BUILDING AREA TO REMAIN.

VENTS PRESENT.

- WORK CONTINUED ON ENLARGED PLANS.
- 4 SPACE/ROOM IS CONSIDERED ORDINARY HAZARD 1. 5 SPACE/ROOM IS CONSIDERED ORDINARY HAZARD 2.
- INSTALL SPRINKLER PIPING IN JOIST SPACE ABOVE STEEL RIGGING BEAMS FOR THE CEILING AREA ABOVE THE STAGE. SPRINKLERS AND PIPING LOCATIONS SHALL AVOID RIGGING BEAMS AND ANY SMOKE/HEAT

2 PROVIDE CLASS III HOSE STATION TO SERVE STAGE.

GENERAL FIRE PROTECTION NOTES

- ALL FIRE PROTECTION WORK PERFORMED ON THIS PROJECT SHALL BE COORDINATION WITH ALL DUCTWORK, RACEWAYS, CABLE TRAYS CONDUITS, STRUCTURAL MEMBERS, PIPING AND ARCHITECTURAL CEILING HEIGHTS AND DESIGN INTENT. ALL FIRE PROTECTION WORK SHALL BE PROVIDED IN ACCORDANCE WITH APPLICABLE NFPA, BUILDING CODE, FIRE CODE AND THE AUTHORITY HAVING JURISDICTION TO DELIVER A PENALTY FREE SYSTEM.
- REFER TO DIVISION 21 SPECIFICATIONS FOR SYSTEM REQUIREMENTS.
- ALL DIVISION 21 SCOPE SHALL BE COORDINATED WITH OTHER TRADES. DIVISION 21 SYSTEM COMPONENTS SHALL BE INSTALLED TO MAINTAIN SERVICE AND ACCESS CLEARANCE TO EQUIPMENT BY OTHER TRADES. ANY DIVISION 21 SCOPE DEEMED TO BE IN CONFLICT WITH OTHER TRADES SHALL BE RELOCATED AT THE COST OF THE CONTRACTOR.
- REFER TO ARCHITECTURAL AND STRUCTURAL DOCUMENTS FOR CEILING TYPES AND AVAILABLE WORKING SPACE.
- PROVIDE ALL REQUIRED STRUCTURAL SUPPORTS.
- F. SPRINKLER TYPES PER AREA SHALL BE PER THE DIVISION 21 SPECIFICATIONS.
- G. REFER TO ARCHITECTURAL AND MECHANICAL DOCUMENTS FOR LARGE OBSTRUCTIONS AND CLOUD TYPE CEILINGS REQUIRING SPRINKLERS ABOVE AND BELOW OBSTRUCTIONS.
- H. SPRINKLERS LOCATED IN GYMNASIUMS AND OTHER LOCATIONS SUBJECT TO PHYSICAL DAMAGE SHALL BE PROVIDED WITH UL LISTED PROTECTIVE SPRINKLER CAGE.
- SPACES/ROOMS SHALL BE FIRE SUPPRESSED IN COMPLIANCE WITH HAZARD CLASSIFICATION AS INDICATED IN NFPA 13. MECHANICAL, ELECTRICAL, TECH, STORAGE AND JANITOR'S ROOMS SHALL BE MINIMUM ORDINARY HAZARD 1. STAGES AND ADJACENT SPACES SHALL BE MINIMUM ORDINARY HAZARD 2.

SIZED PER HYDRAULIC CALCULATIONS. CONTRACTOR IS RESPONSIBLE FOR

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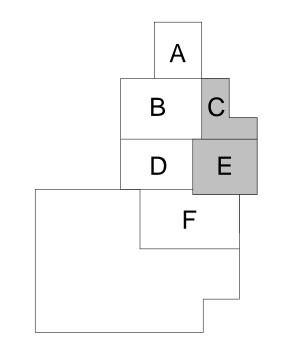
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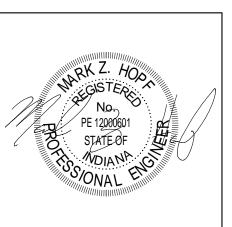
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KEY PLAN

CONSTRUCTION DOCUMENTS



PROJECT MANAGER: MKS DRAWN BY: CSS PROJECT NUMBER: 220158.00 PROJECT ISSUE DATE: 9/6/2022

REV. NO.	DESCRIPTION	DATE

SECOND FLOOR FIRE PROTECTION PLAN

FP2.02