ADDENDUM NO. 1

February 26, 2024

Cherry Tree Elementary School Additions & Renovations 13989 Hazel Dell Parkway Carmel, IN 46033

TO: ALL BIDDERS OF RECORD

This Addendum forms a part of and modifies the Bidding Requirements, Contract Forms, Contract Conditions, the Specifications and the Drawings dated February 9, 2024, by Fanning/Howey. Acknowledge receipt of the Addendum in the space provided on the Bid Form. Failure to do so may subject the Bidder to disqualification.

This Addendum consists of Pages ADD 1-1 and attached Fanning/Howey Addendum No. 1 dated February 23, 2024, consisting of 19 items, 4 pages, Revised Drawing Sheets: G1.0, G1.2, S1.03, AD0.01, A0.01, A1.02, A3.02, A6.03, A7.01, A7.02, A7.03, A7.04, A7.10, A7S.01, A8.10, A8S.01, M2.01, M2.02, M4.01, M5.01, M6.01, E2.01, E4.02, E4.03, E5.01, E7.01, E8.01, T1.05, T3.03, T3.04, T3.10, and T5.01.

ADDENDUM NO. 1

Cherry Tree Elementary School Additions and Renovations

Carmel Clay Schools Carmel, Indiana

Project No. 222011.00

Index of Contents

Addendum No. 1, 19 items, 4 pages
Revised Drawing Sheets: G1.0, G1.2, S1.03, AD0.01, A0.01, A1.02, A3.02, A6.03, A7.01, A7.02, A7.03, A7.04, A7.10, A7S.01, A8.10, A8S.01, M2.01, M2.02, M4.01, M5.01, M6.01, E2.01, E4.02, E4.03, E5.01, E7.01, E8.01, T1.05, T3.03, T3.04, T3.10, and T5.01

February 23, 2024

I hereby certify that this Addendum was prepared by me or under my direct supervision and that I am a duly registered Architect/Engineer under the Laws of the State of Indiana.

FANNING/HOWEY ASSOCIATES, INC. ARCHITECTS/ENGINEERS/CONSULTANTS



Paul A. Miller, License No. AR10800161 Expiration Date: 12/31/2025

TO: ALL BIDDERS OF RECORD

ADDENDUM NO. 1 to Drawings and Project Manual, dated February 9, 2024, for the Cherry Tree Elementary School Additions and Renovations for Carmel Clay Schools, 5201 E. 131st St., Carmel, Indiana 46033; as prepared by Fanning/Howey Associates, Inc., Indianapolis, Indiana.

This Addendum shall hereby be and become a part of the Contract Documents the same as if originally bound thereto.

The following clarifications, amendments, additions, revisions, changes, and modifications change the original Contract Documents only in the amount and to the extent hereinafter specified in this Addendum.

Each bidder shall acknowledge receipt of this Addendum in his proposal or bid.

NOTE: Bidders are responsible for becoming familiar with every item of this Addendum. (This includes miscellaneous items at the very end of this Addendum.)

RE: ALL BIDDERS

ITEM NO. 1. PROJECT MANUAL, SECTION 03 30 00 - CAST-IN-PLACE CONCRETE

- A. Delete 2.10, A., and F., in their entirety.
- B. Delete 3.14, C., 3., e., in its entirety.
- C. Delete 3.14, D., 2., c., in its entirety.

ITEM NO. 2. PROJECT MANUAL, SECTION 04 20 00 - UNIT MASONRY

- A. Article 2.6, B., 6., a., 1): Add "Refer to List of Finishes" after "Color A".
- B. Article 2,6, B., 6., b., 1): Add "Refer to List of Finishes" after "Color B".

ITEM NO. 3. PROJECT MANUAL, SECTION 07 27 26.02 - VAPOR-PERMEABLE-FLUID-APPLIED MEMBRANE AIR BARRIER

A. Delete 2.3, A., 1., in its entirety.

ITEM NO. 4. PROJECT MANUAL, SECTION 08 41 13 - ALUMINUM-FRAMED ENTRANCES AND STOREFRONTS

- A. Add 2.4, I., 4., as follows:
 - "4. Deflection Closure/Clip: Formed aluminum "C" shape or continuous angles at top of interior storefront system to conceal deflection gap and allow for deflection of roof structure above storefront framing. No connection to storefront framing required."

ITEM NO. 5. PROJECT MANUAL, SECTION 08 87 23 - SAFETY AND SECURITY FILM

A. Article 1.1, A., 1.: Delete "(DFO)" at end of paragraph.

ITEM NO. 6. PROJECT MANUAL, SECTION 09 30 00 - TILING

- A. Replace 1.6, A., as follows:
 - "A. Leave, at Project where directed, any remaining full size pieces of each type, color, pattern, and size for Owner's maintenance."
- B. Add 2.8, B., 2., as follows:
 - "2. Where indicated on Drawings, provide factory colored metallic trim shapes and profiles for tile terminations, edges and transitions similar to Laticrete "AnyColor" Profiles and Trims."

ITEM NO. 7. PROJECT MANUAL, SECTION 09 54 23 - LINEAR METAL CEILINGS.

- A. Add 2.2, J., as follows:
 - "J. Suspension (Perimeter) Trim: 4 inch wide face, 9/16-inch horizontal legs with hems formed for attachment to the mounting clip; commercial quality cold-rolled 24-gauge steel, factory finished in based enamel paint finish, on all exposed surfaces.
 - 1. Manufacturers: Subject to compliance with requirements, provide products by one of the manufacturers specified.
 - a. Axiom Trims and Transitions; Armstrong World Industries.
 - b. Compasso Standard; USG Interior Systems.
 - c. Cloud Perimeter Trim; CertainTeed Ceilings.
 - d. Infinity; Rockfon.
 - 2. Splice Plate: Steel in finish to match trim pans; formed for snap-fit into pan ends.
 - 3. Attachment Clips: Hot-dipped galvanized steel in finish to match pans formed for snap-fit into pan and attached to suspension system members.
 - 4. Corner Trim Pieces: To match trim.
 - 5. Trim shall be straight and/or curved as indicated.
 - 6. Color: Match adjacent linear metal pans"
- B. Replace 2.3, A., 1., c., as follows:
 - "c. CertainTeed Metals"

ITEM NO. 8. PROJECT MANUAL, SECTION 09 65 13 - RESILIENT BASE AND ACCESSORIES

- A. Delete 1.4, A. in its entirety.
- B. Add 2.3, J., as follows:
 - "J. Vented Resilient Wall Base (VRB): Molded, vented, rubber or vinyl cove base; 4 by 3 by 48 inches; with premolded outside corners.
 - 1. Color: Black, unless otherwise noted."

ITEM NO. 9. PROJECT MANUAL, SECTION 09 65 16 - RESILIENT SHEET FLOORING

- A. Replace 1.4, A., as follows:
 - "A. Leave, at Project where directed, any remaining full size pieces of each type, color, pattern, and size for Owner's maintenance."
- B. Article 2.3: Add <u>"(RSF-1)"</u> after Article title.

ITEM NO. 10. PROJECT MANUAL, SECTION 09 65 19 - RESILIENT TILE FLOORING

- A. Replace 1.5, A., as follows:
 - "A. Leave, at Project where directed, any remaining full size pieces of each type, color, pattern, and size for Owner's maintenance."

ITEM NO. 11. PROJECT MANUAL, SECTION 09 65 43 - LINOLEUM FLOORING

- A. Article 1.1, A., 1: Add "(LSF)" at end of sentence.
- B. Replace 1.5, A., as follows:
 - "A. Leave, at Project where directed, any remaining full size pieces of each type, color, pattern, and size for Owner's maintenance."

ITEM NO. 12. PROJECT MANUAL, SECTION 09 72 00 - WALL COVERINGS

- A. Replace 1.5, A., as follows:
 - "A. Leave, at Project where directed, any remaining full or partial rolls or sheets of each type, color, pattern, and size for Owner's maintenance."
- B. Add 2.5, C., as follows:
 - "C. Trim and Moldings: Extruded rigid plastic "J" shape material matching the Type III Wall Covering color to finish top of wainscot height materials."

ITEM NO. 13. PROJECT MANUAL, SECTION 09 77 13 - STRETCHED-FABRIC WALL SYSTEMS

A. Delete Article 1.6 in its entirety.

ITEM NO. 14. PROJECT MANUAL, SECTION 09 91 23.61 - INTERIOR PAINTING/REPAINTING

A. Delete Article 1.10 in its entirety.

ITEM NO. 15. PROJECT MANUAL, SECTION 09 96 00 - HIGH PERFORMANCE COATINGS

A. Delete Article 1.8 in its entirety.

ITEM NO. 16. PROJECT MANUAL, SECTION 10 11 00 - VISUAL DISPLAY UNITS

- A. Add 2.5, B., 5., as follows:
 - "5. Where indicated in the "List of Finishes", provide unbacked acoustically transparent Xorel surfacing. Fabric shall be 12 oz per linear yard, 100% IFR Xorel by Carnegie."

ITEM NO. 17. PROJECT MANUAL, SECTION 11 51 23 - LIBRARY STACK SYSTEMS

A. Article 1.1, A., 1: Add "<u>Discovery Center Casework</u>" after "case" at end of paragraph.


ITEM NO. 18. PROJECT MANUAL, SECTION 12 24 13 - ROLLER WINDOW SHADES


- A. Article 2.2, E: Add "(RWS-1)" after "(exposed/between jamb installations)" at beginning of paragraph.
- B. Article 2.2, F., 1: Add "(RWS-2)" after "Recessed Shade Pocket" at beginning of paragraph.
- C. Add 2.2, I., as follows:
 - "I. Installation Accessories:
 - 1. Exposed Headbox (RWS-3): Rectangular, extruded-aluminum enclosure including front fascia, top, back covers, endcaps, and removable bottom closure.
 - a. Height: Manufacturer's standard height required to enclose roller and shadeband assembly when shade is fully open, but not less than 4 inches.
 - b. Conceal fasteners to attach headbox to wall construction."
- D. Article 2.3, B: Add "(RWS-1)" after "Light-Filtering Fabric" at beginning of paragraph.
- E. Article 2.3, C: Add "(RWS-2 and RWS-3)" after "Light-Blocking Fabric" at beginning of paragraph.
- F. Article 2.4, B., 2: Add "and recessed ceiling mounted" after "Outside Jamb Installation".

ITEM NO. 19. REVISED DRAWING SHEETS

A. Drawing Sheets: G1.0, G1.2, S1.03, AD0.01, A0.01, A1.02, A3.02, A6.03, A7.01, A7.02, A7.03, A7.04, A7.10, A7S.01, A8.10, A8S.01, M2.01, M2.02, M4.01, M5.01, M6.01, E2.01, E4.02, E4.03, E5.01, E7.01, E8.01, T1.05, T3.03, T3.04, T3.10, and T5.01 have been revised, dated 2/23/24, and is included with and hereby made a part of this Addendum. These Drawings supersede the original documents.

END OF ADDENDUM

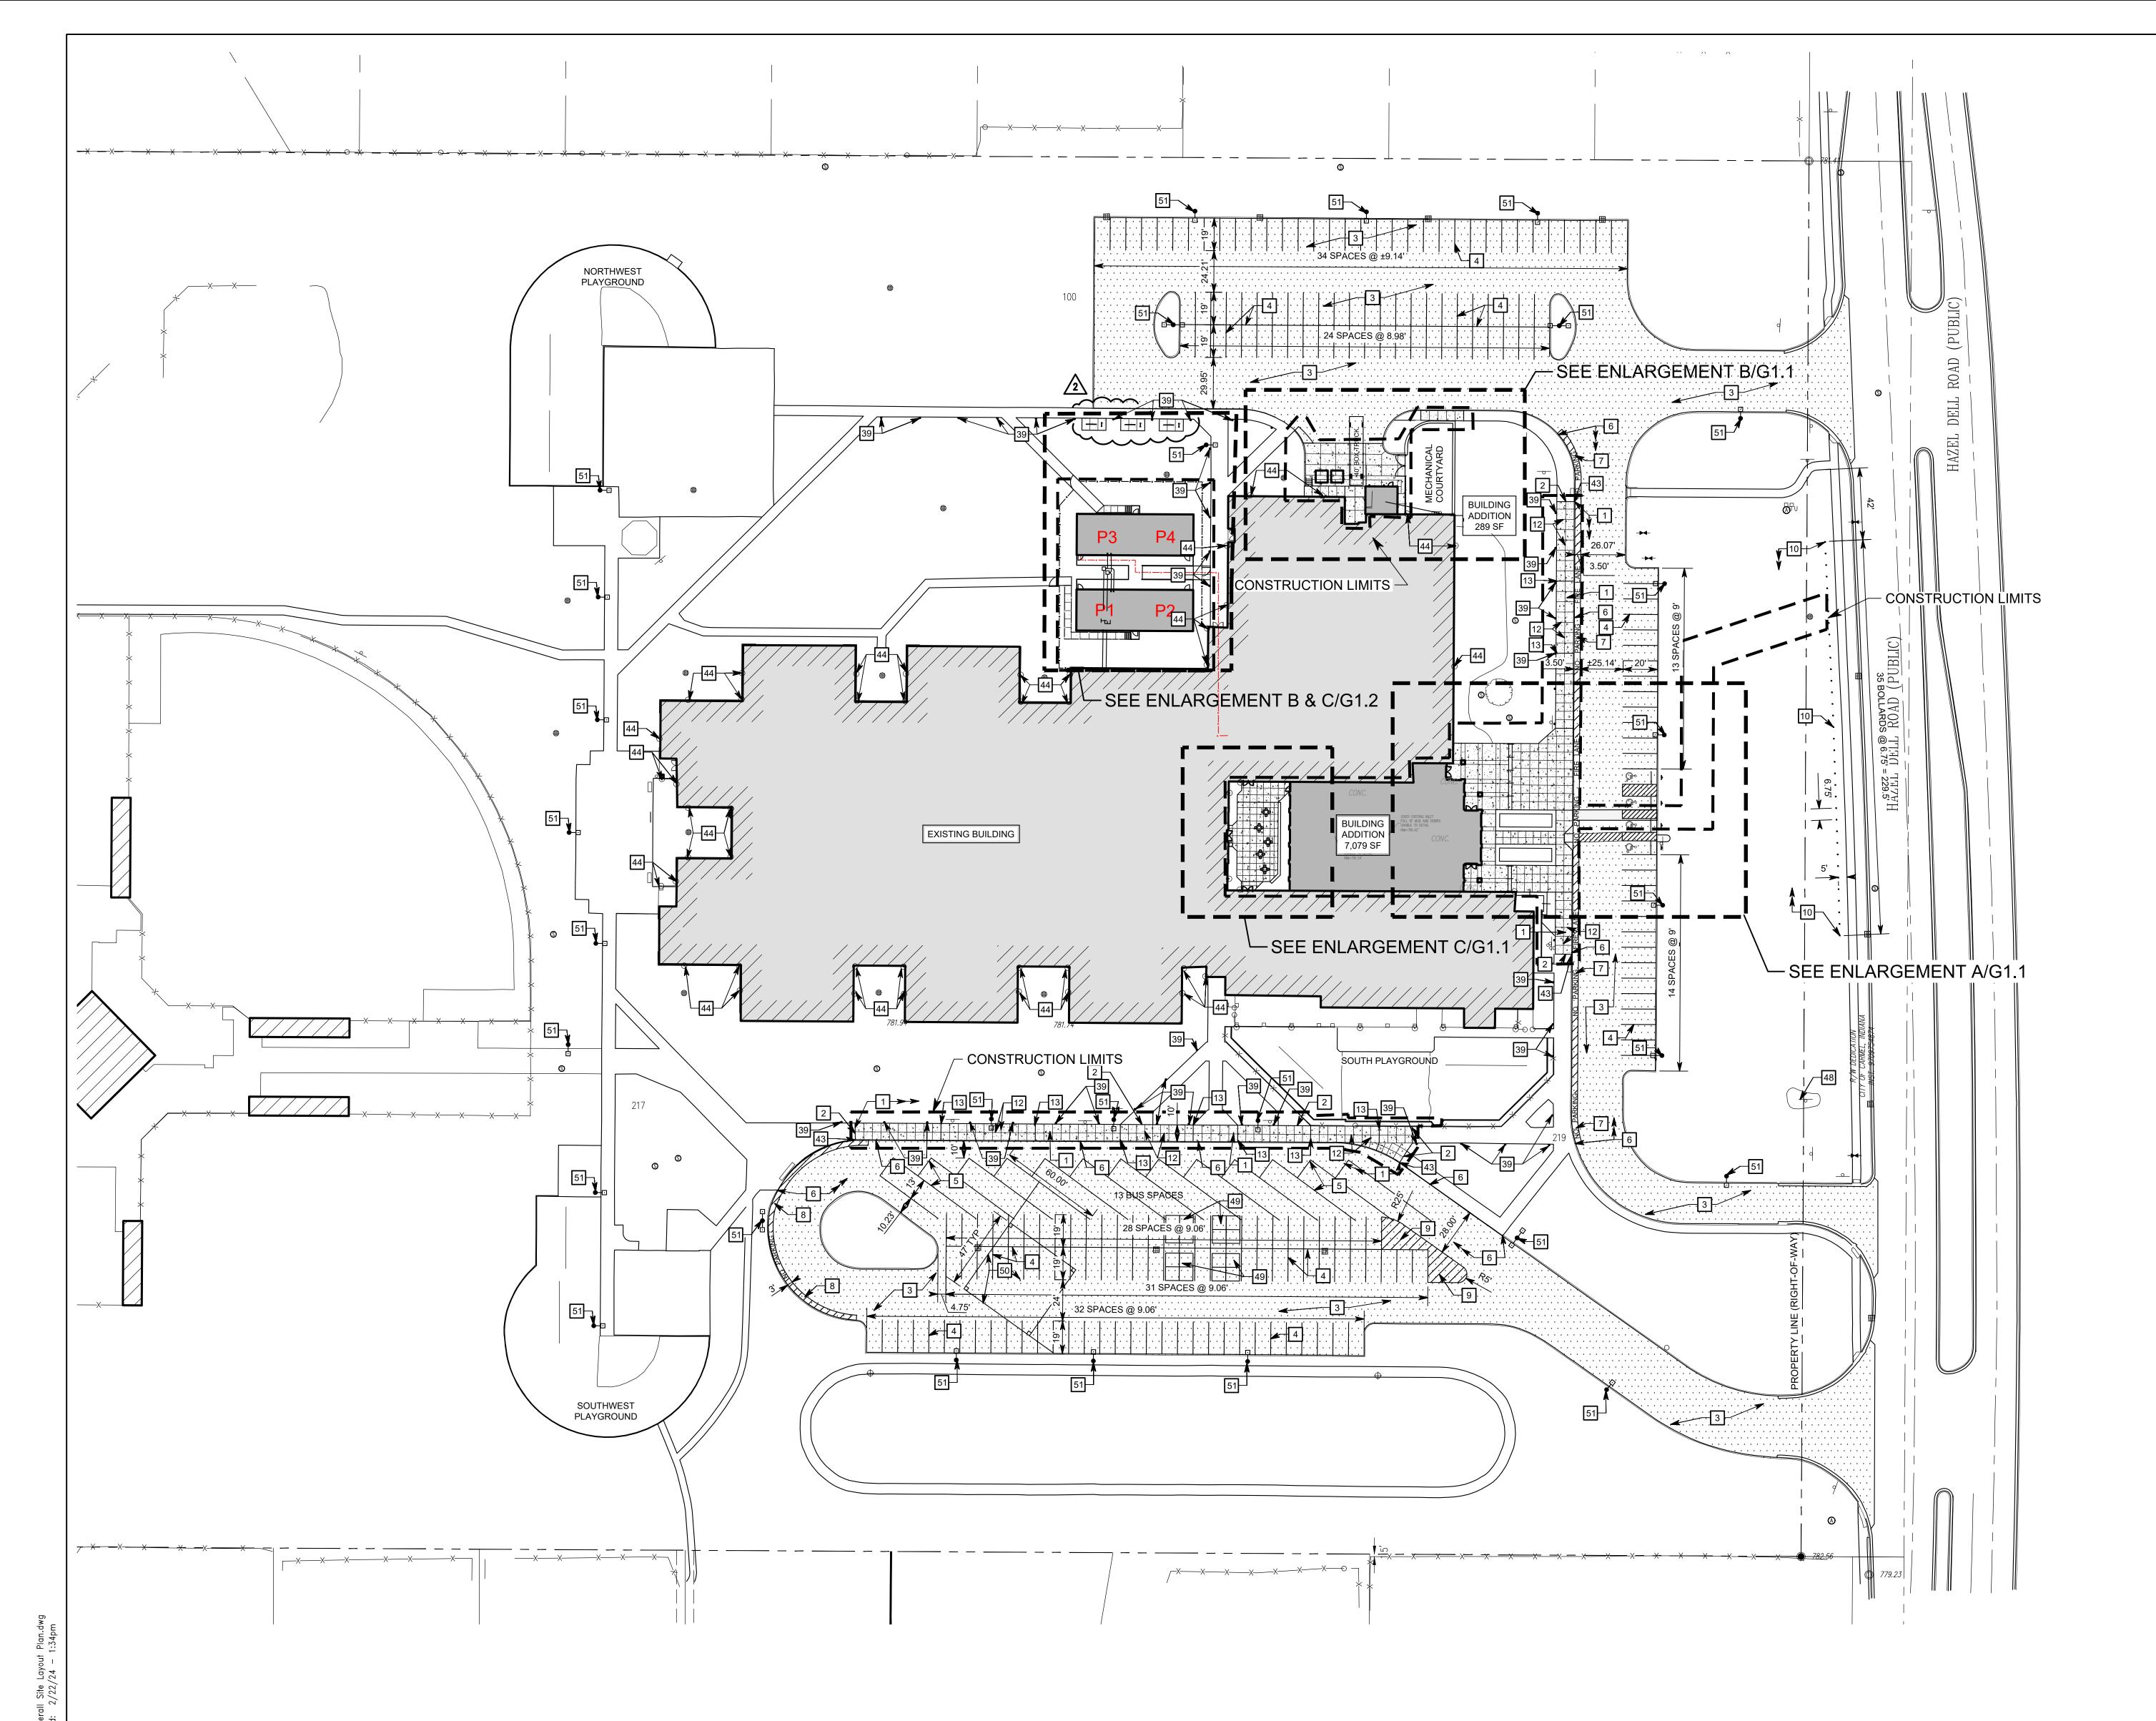

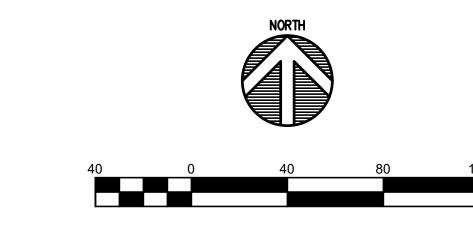

GENERAL NOTES

- 1. SEE DRAWING G0.1 FOR GENERAL NOTES AND ADDITIONAL LEGEND
- TOPOGRAPHIC CONDITIONS AND EXISTING UTILITIES SHOWN WERE PROVIDED BY SCHNEIDER GEOMATICS DATED 09/05/2023. THE ENGINEER MAKES NO GUARANTEES THAT THE UNDERGROUND UTILITIES SHOWN COMPRISE ALL SUCH UTILITIES IN THE AREA, EITHER IN SERVICE OR ABANDONED.
- CONTRACTOR SHALL VERIFY ALL EXISTING CONDITIONS IN THE PROJECT AREA INCLUDING UNDERGROUND UTILITY CONDITIONS, LOCATION AND DEPTH PRIOR TO ANY OTHER SITE CONSTRUCTION. REPORT ANY DISCREPANCIES TO
- 4. THE PROPOSED STORM SEWER SYSTEM FOR THIS PROJECT WILL BE PRIVATE
- 5. FLOOD ROUTING PATH FROM BUILDING ADDITION AND PARKING LOT WHEN 100 YEAR FLOOD IS EXCEEDED. PATH TRAVELS IN A EASTERLY DIRECTION TO EXISTING INLETS LOCATED ON THE WEST SIDE OF HAZEL DELL PARKWAY. THESE INLETS FLOW TO FREEMONT RANDALL DRAIN (VEST - KIRKENDALL DRAINAGE AREA) ULTIMATELY DISCHARGING TO THE WHITE RIVER.
- NO EARTH DISTURBING ACTIVITY MAY COMMENCE WITHOUT AN APPROVED STORM WATER MANAGEMENT PERMIT.
- UTILITY RELOCATIONS REQUIRED BY THE PROJECT SHALL BE THE RESPONSIBILITY OF THE DEVELOPER. UTILITY LINE RELOCATIONS REQUIRED FOR ROAD PROJECTS THAT RESULT IN A CONFLICT WITH PROPOSED DEVELOPMENT SHALL BE THE DEVELOPERS RESPONSIBILITY TO RESOLVE WITH THE UTILITY. EXISTING POLE LINES REQUIRED TO BE RELOCATED TO WITHIN ONE FOOT OF PROPOSED RIGHT-OF-WAY LINE.
- DAMAGE TO THE EXISTING RIGHT-OF-WAY SHALL RESTORED/REPAIRED TO THE SATISFACTION OF THE CITY AT THE COMPLETION OF THE PROJECT. THE CONTRACTOR IS ENCOURAGED TO INSPECT THE RIGHT-OF-WAY WITH THE CITY PRIOR TO THE START OF CONSTRUCTION TO DOCUMENT THE EXISTING CONDITION OF THE RIGHT-OF-WAY.
- 8. REFER TO SHEET E2.01 FOR LIGHT BOLLARD AND LIGHPOLE INFORMATION.
- 9. REFER TO SHEET SU1.0 FOR DOWNSPOUT BOOT DETAIL REPLACEMENT.
- 10. ALL EXISTING PERIMETER ROAD DRAINAGE STRUCTURES AND BRIDGES ACROSS THE FRONTAGE OF THIS DEVELOPMENT ARE INDICATED ON THE PLANS. PROVISIONS HAVE BEEN MADE TO IMPROVE OR REPLACE ANY DRAINAGE STRUCTURES AND BRIDGES AS NECESSARY OR AS REQUEST BY MULTI-USE PATH, AND ANY OTHER REQUIRED IMPROVEMENTS TO THE PROPERTY OR THE ROADWAY. THE COST TO IMPROVE OR REPLACE ANY DRAIANGE STRUCTURES AND BRIDGES WILL BE BORNE BY THE DEVELOPER.
- ALL PAVING WITHIN THE EXISTING AND PROPOSED CITY RIGHT -OF-WAY SHALL CONFORM TO THE REQUIREMENTS OF THE DEPARTMENT OF ENGINEERING. THE CONTRACTOR SHALL CONTACT THE DEPARTMENT OF ENGINEERING TO SCHEDULE A PRE-CONSTRUCTION MEETING TO REVIEW THE DEPARTMENT'S CONSTRUCTION REQUIREMENTS, STAFF NOTIFICATION REQUIREMENTS, REQUIRED INSPECTIONS FOR CERTAIN STAGES OF THE WORK AND TO REVIEW THE AUTHORITY OF THE DEPARTMENT AS IT RELATES TO WORK WITHIN THE EXISTING AND PROPOSED RIGHT-OF-WAY.

SITE KEYNOTES

- 1 CONCRETE MONOLITHIC CURB & WALK PER DETAIL B/G4.1
- CONCRETE CONNECTION PER DETAIL F/G4.1
- 1 1/2" ASPHALT SURFACE OVERLAY PER DETAIL F/G4.2 4" WIDE WHITE PAVEMENT MARKING - PER SPECIFICATIONS
- 4" WIDE YELLOW PAVEMENT MARKING PER SPECIFICATIONS
- 6 PAINT CURB YELLOW PER SPECIFICATIONS
- 7 4" WIDE YELLOW PAVEMENT STRIPE AT 3'-0" O.C. AT 45° ANGLE W/ NO PARKING FIRE LANE TEXT PER DETAIL C/G4.2
- 8 4" WIDE WHITE PAVEMENT STRIPE AT 3'-0" O.C. AT 45° ANGLE W/ NO PARKING TEXT - PER DETAIL C/G4.2
- 9 4" WIDE WHITE PAVEMENT STRIPE AT 3'-0" O.C. AT 45° ANGLE PER DETAIL
- 10 WOOD BOLLARD PER DETAIL L/G4.2
- 12 CONCRETE CONTROL JOINT SEE DETAIL PER DETAIL C/G4.1
- CONCRETE EXPANSION JOINT SEE DETAIL PER DETAIL C/G4.1
- SEE SHEET E2.01 FOR LIGHT BOLLARD INFORMATION AND SPECIFICATIONS & DETAIL 8/E1.02 FOR FOUNDATION DETAIL
- CURB TO CURB CONNECTION PER DETAIL K/G4.1
- REMOVE EXISTING DOWNSPOUT BOOT AND REPLACE WITH NEW DOWNSPOUT BOOT - PER DETAIL I/SU2.1, SUCH THAT BOTTOM FLANGE OF BOOT IS 1" ABOVE CONCRETE SIDEWALK. PROVIDE EXPANSION JOINT AND CAULKING AROUND DOWNSPOUT BOOT, REPAIR SIDEWALK AND ADJACENT GROUND TO ORIGINAL OR BETTER CONDITION
- CLEAN AND TUCK POINT MASONRY JOINTS ON EXISTING MONUMENTAL SIGN SEE MASONRY SPECIFICATIONS AND DETAIL H/G4.2
- 16' X 16' PAINTED 4 SQUARE COURT THE QUADRANTS ARE TO BE PAINTED GREEN, BLUE, RED & YELLOW W/ A 1" WHITE BORDERS
- 2" WIDE PAINTED LINES FOR KICKBALL FIELD W/ 2' X 2' PAINTED BASES AT EACH CORNER AND 2' LONG PAINTED PITCHERS MOUND
- 51 SEE SHEET E2.01 FOR LIGHT POLE INFORMATION, SPECIFICATIONS & DETAIL 8/E1.02 FOR FOUNDATION DETAIL (FOR NEW LIGHT POLES)

PROPOSED SITE LEGEND

BUILDING ADDITION

EXISTING BUILDING

CONCRETE SIDEWALK

ASPHALT PAVEMENT 1 1/2" ASPHALT SURFACE OVERLAY

— CONSTRUCTION LIMITS

Know what's below. Call before you dig. Call 811 or 1-800-382-5544 Before You Begin Any Digging Project.

It's Fast, It's Easy and It's the Law in the state of Indiana!

CAUTION!!

THE LOCATIONS OF ALL EXISTING UNDERGROUND UTILITIES SHOWN ON THE PLAN ARE BASED UPON ABOVE GROUND EVIDENCE (INCLUDING, BUT NOT LIMITED TO, MANHOLES, INLETS, VALVES, AND MARKS MADE UPON THE GROUND BY OTHERS) AND ARE SPECULATIVE IN NATURE. THERE MAY ALSO BE OTHER EXISTING UNDERGROUND UTILITIES FOR WHICH THERE IS NO ABOVE GROUND EVIDENCE OR FOR WHICH NO ABOVE GROUND EVIDENCE WAS OBSERVED. THE EXACT LOCATIONS OF EXISTING UNDERGROUND UTILITIES SHALL BE VERIFIED BY CONTRACTOR PRIOR TO ANY AND

ALL CONSTRUCTION.

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CHERRY TREE ELEMENTARY SCHOOL **ADDITION AND** RENOVATION

13989 HAZEL DELL PARKWAY CARMEL, IN 46033

CARMEL CLAY SCHOOLS





350 E NEW YORK ST# 300. INDIANAPOLIS. IN 46204

CONSULTANT



3901 WEST 86TH STREET, ST# 200, INDIANAPOLIS, IN 46268

ADDENDUM #1




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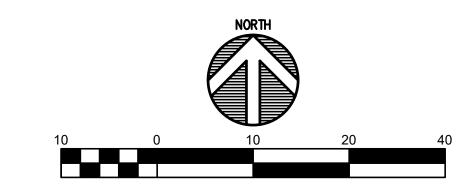
PROJECT NUMBER: 222011.00

PROJECT ISSUE DATE: 2.23.2024

IXE V.		
NO.	DESCRIPTION	DATE
1	TAC REVIEW	12-15-2023
2	ADDENDUM #1	2-23-2024

OVERALL SITE LAYOUT PLAN



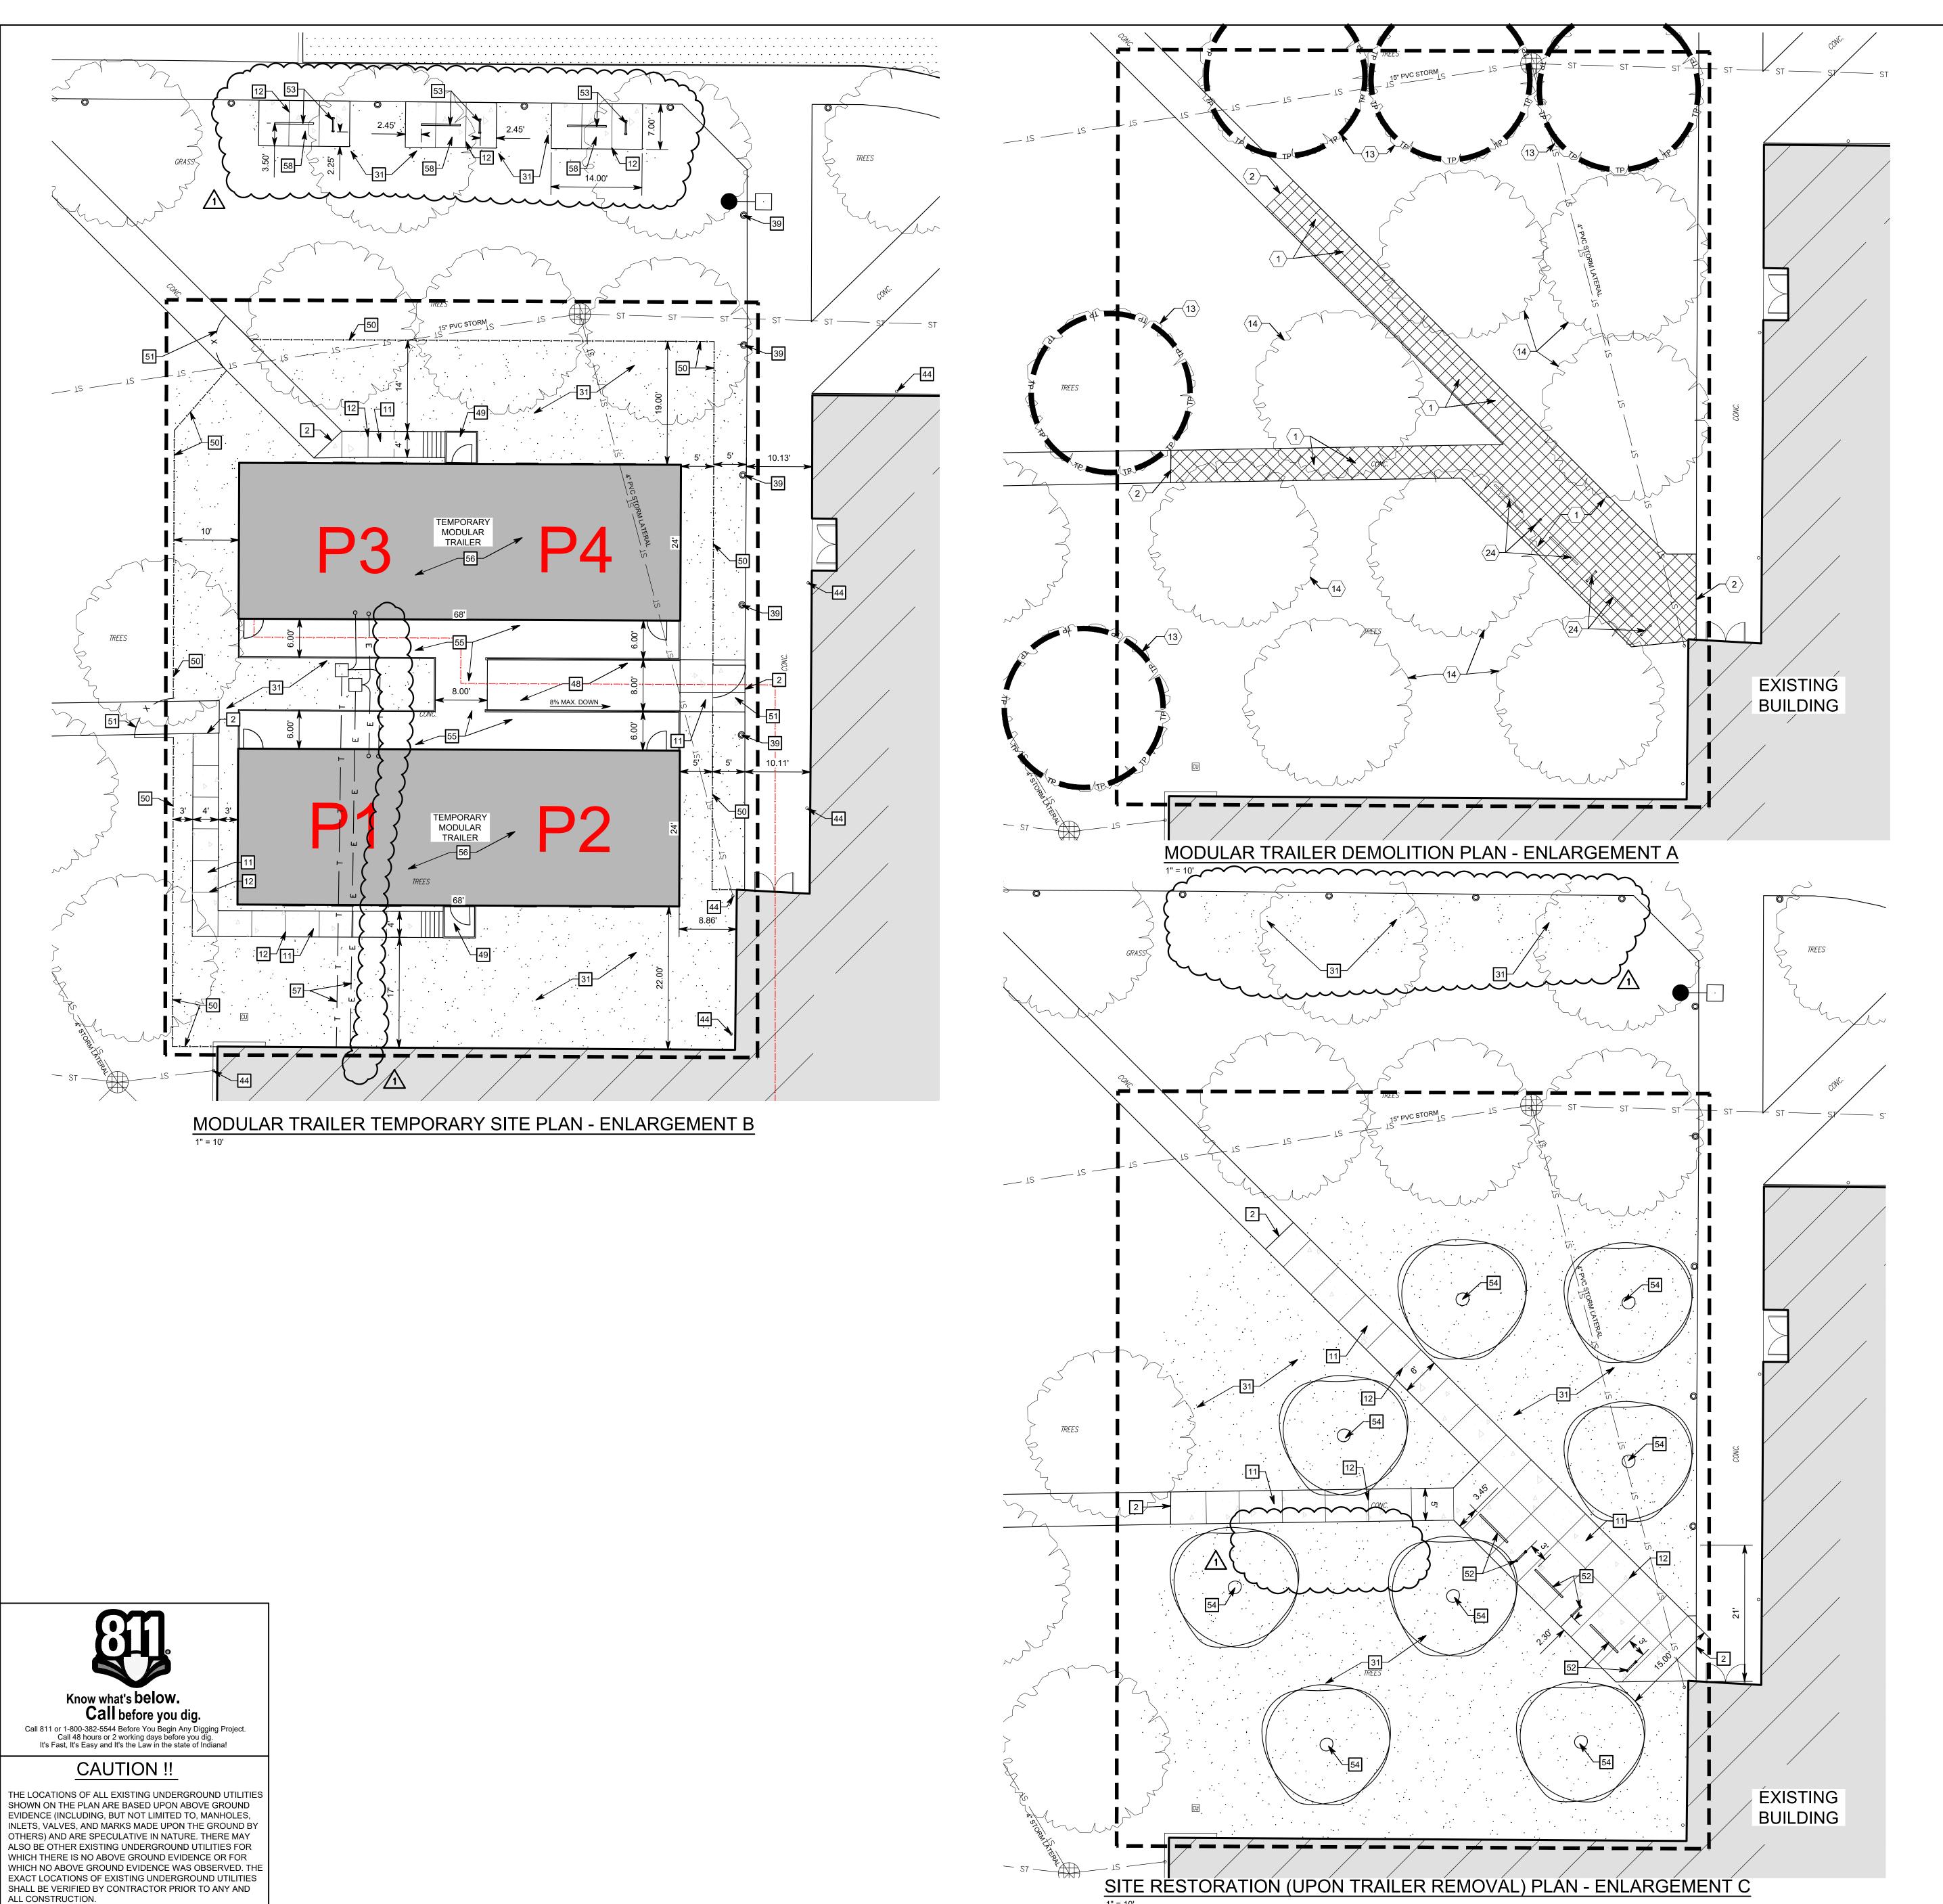

GENERAL NOTES

DISCHARGING TO THE WHITE RIVER.

- 1. SEE DRAWING G0.1 FOR GENERAL NOTES AND ADDITIONAL LEGEND.
- TOPOGRAPHIC CONDITIONS AND EXISTING UTILITIES SHOWN WERE PROVIDED BY SCHNEIDER GEOMATICS DATED 09/05/2023. THE ENGINEER MAKES NO GUARANTEES THAT THE UNDERGROUND UTILITIES SHOWN COMPRISE ALL SUCH UTILITIES IN THE AREA, EITHER IN SERVICE OR ABANDONED.
- 3. CONTRACTOR SHALL VERIFY ALL EXISTING CONDITIONS IN THE PROJECT AREA INCLUDING UNDERGROUND UTILITY CONDITIONS, LOCATION AND DEPTH PRIOR TO ANY OTHER SITE CONSTRUCTION. REPORT ANY DISCREPANCIES TO THE ENGINEER.\
- FLOOD ROUTING PATH FROM BUILDING ADDITION AND PARKING LOT WHEN 100 YEAR FLOOD IS EXCEEDED. PATH TRAVELS IN A EASTERLY DIRECTION TO EXISTING INLETS LOCATED ON THE WEST SIDE OF HAZEL DELL PARKWAY. THESE INLETS FLOW TO FREEMONT RANDALL DRAIN (VEST - KIRKENDALL DRAINAGE AREA) ULTIMATELY
- 6. NO EARTH DISTURBING ACTIVITY MAY COMMENCE WITHOUT AN APPROVED STORM
- 7. UTILITY RELOCATIONS REQUIRED BY THE PROJECT SHALL BE THE RESPONSIBILITY OF THE DEVELOPER. UTILITY LINE RELOCATIONS REQUIRED FOR ROAD PROJECTS THAT RESULT IN A CONFLICT WITH PROPOSED DEVELOPMENT SHALL BE THE DEVELOPERS RESULT IN A CONFLICT WITH PROPOSED DEVELOPMENT SHALL BE THE DEVELOPERS
 RESPONSIBILITY TO RESOLVE WITH THE UTILITY. EXISTING POLE LINES REQUIRED TO BE

 CARMEL CLAY SCHOOLS RELOCATED TO WITHIN ONE FOOT OF PROPOSED RIGHT-OF-WAY LINE.
- DAMAGE TO THE EXISTING RIGHT-OF-WAY SHALL RESTORED/REPAIRED TO THE SATISFACTION OF THE CITY AT THE COMPLETION OF THE PROJECT. THE CONTRACTOR IS ENCOURAGED TO INSPECT THE RIGHT-OF-WAY WITH THE CITY PRIOR TO THE START OF CONSTRUCTION TO DOCUMENT THE EXISTING CONDITION OF THE RIGHT-OF-WAY.
- 8. REFER TO SHEET E2.01 FOR LIGHT BOLLARD AND LIGHT POLE IMPROVEMENTS.
- 9. ALL EXISTING PERIMETER ROAD DRAINAGE STRUCTURES AND BRIDGES ACROSS THE FRONTAGE OF THIS DEVELOPMENT ARE INDICATED ON THE PLANS. PROVISIONS HAVE BEEN MADE TO IMPROVE OR REPLACE ANY DRAINAGE STRUCTURES AND BRIDGES AS NECESSARY OR AS REQUEST BY THE CITY OT ACCOMMODATE THE PAVEMENT WIDENING, AUXILIARY LANES, MULTI-USE PATH, AND ANY OTHER REQUIRED IMPROVEMENTS TO THE PROPERTY OR THE ROADWAY. THE COST TO IMPROVE OR REPLACE ANY DRAIANGE STRUCTURES AND BRIDGES WILL BE BORNE BY THE
- 10. ALL PAVING WITHIN THE EXISTING AND PROPOSED CITY RIGHT -OF-WAY SHALL CONFORM TO THE REQUIREMENTS OF THE DEPARTMENT OF ENGINEERING. THE CONTRACTOR SHALL CONTACT THE DEPARTMENT OF ENGINEERING TO SCHEDULE A PRE-CONSTRUCTION MEETING TO REVIEW THE DEPARTMENT'S CONSTRUCTION REQUIREMENTS, STAFF NOTIFICATION REQUIREMENTS, REQUIRED INSPECTIONS FOR CERTAIN STAGES OF THE WORK AND TO REVIEW THE AUTHORITY OF THE DEPARTMENT AS IT RELATES TO WORK WITHIN THE EXISTING AND PROPOSED RIGHT-OF-WAY.

DEMOLITION KEYNOTES

- REMOVE CONCRETE SIDEWALK
- 2. SAWCUT EXISTING PAVEMENT
- 13. PROTECT EXISTING TREE TO REMAIN
- 14. REMOVE EXISTING TREE AS REQUIRED
- 24. RELOCATE BIKE RACKS TO LOCATION SHOWN ON ENLARGEMENT C THIS

SITE KEYNOTES

- 2 CONCRETE CONNECTION PER DETAIL F/G4.1
- 11 CONCRETE SIDEWALK PER DETAIL A/G4.1
- CONCRETE CONTROL JOINT SEE DETAIL PER DETAIL C/G4.1
- SEEDED DISTURBED LAWN SEE LANDSCAPE PLAN
- SEE SHEET E2.01 FOR LIGHT BOLLARD INFORMATION AND SPECIFICATIONS & DETAIL 8/E1.02 FOR FOUNDATION DETAIL
- REMOVE EXISTING DOWNSPOUT BOOT AND REPLACE WITH NEW DOWNSPOUT BOOT PER DETAIL I/SU2.1, SUCH THAT BOTTOM FLANGE OF BOOT IS 1" ABOVE NEW CONCRETE SIDEWALK. PROVIDE EXPANSION JOINT AND CAULKING AROUND
- RAMP SYSTEM WITH HANDRAIL (BY MODULAR TRAILER SUPPLIER) MAXIMUM RAMP SLOPE SHALL BE 8%, CONTRACTOR TO PROVIDE FOUNDATIONS AND SUPPORTS FOR
- ACCESS SYSTEM STAIR WITH HANDRAIL (BY MODULAR TRAILER SUPPLIER), CONTRACTOR TO PROVIDE FOUNDATIONS AND SUPPORTS FOR ACCESS SYSTEM
- 50 7' HT. BLACK VINYL CHAIN LINK FENCE
- 51 5'-0" SWING GATE (BASTEEL INFINITY STYLE) 7' TALL, PROVIDE DETEX ADVANTEX 40XV WEATHER-PROOF PANIC BAR WITH BATTERY OPERATED LOCAL ALARM MOUNTED. GATE HARDWARE AND LOCKS PER SPECIFICATIONS
- 52 RELOCATED BIKE RACK (FINAL LOCATION), MOVED FROM TEMPORARY LOCATION
- 753 RELOCATED BIKE RACK (TEMPOARY LOCATION WHILE MODULAR TRAILERS ARE PROPOSED DECIDUOUS SHADE TREE - SEE LANDSCAPE PLAN
- ELEVATED WALKWAY WITH HANDRAIL (BY MODULAR TRAILER SUPPLIER), CONTRACTOR TO PROVIDE FOUNDATIONS AND SUPPORTS FOR ACCESS SYSTEM
- TEMPORARY (DURING CONSTRUCTION) MODULAR TRAILER CLASSROOMS, CONTRACTOR TO PROVIDE CONCRETE FOUNDATIONS AND ANCHORS MEETING STATE AND CITY CODES, BASED ON TRAILER TYPE, SIZE AND WEIGHT
- CONTRACTOR TO PROVIDE THE FOLLOWING UTILITIES AT -3' BURIAL DEPTH: A: FIRE PROTECTION LATERIAL
- B. TELECOMM SERVICE
- ALL OF THE ABOVE NOTED UTILITIES SHALL BE ROUTED FROM THE EXISTING BUILDING TOWARD PULL BOXES AND/OR PANELS NEAR THE TRAILERS. (SEE MEP PLANS)
- CONCRETE SIDEWALK PER DETAIL A/G4.1, TO BE REMOVED WHEN BIKE RACKS ARE MOVED TO FINAL LOCATION AFTER TEMPORARY MODULAR TRAILERS ARE REMOVED


LEGEND

EXISTING BUILDING

TEMPORARY MODULAR CLASSROOM

CONCRETE SIDEWALK/PAVEMENT

APPROXIMATE LIMITS OF CONCRETE REMOVAL

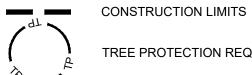

TREE PROTECTION REQUIRED

*** SEE TOPOGRAPHIC SURVEY FOR ADDITIONAL LEGEND SYMBOLS.

CHERRY TREE **ELEMENTARY** SCHOOL **ADDITION AND RENOVATION**

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13989 HAZEL DELL PARKWAY CARMEL, IN 46033





317-848-0966 WWW.FHAI.COM 350 E NEW YORK ST# 300, INDIANAPOLIS, IN 46204

CONSULTANT



TLF-ENGINEERS.COM 3901 WEST 86TH STREET, ST# 200, INDIANAPOLIS, IN 46268

ADDENDUM #1




REV.

DRAWN BY: ARS PROJECT NUMBER: 222011.00 PROJECT ISSUE DATE: 2.23.2024

NO.	DESCRIPTION	DATE
1	ADDENDUM #1	2-23-2024

ENLARGED SITE LAYOUT PLANS

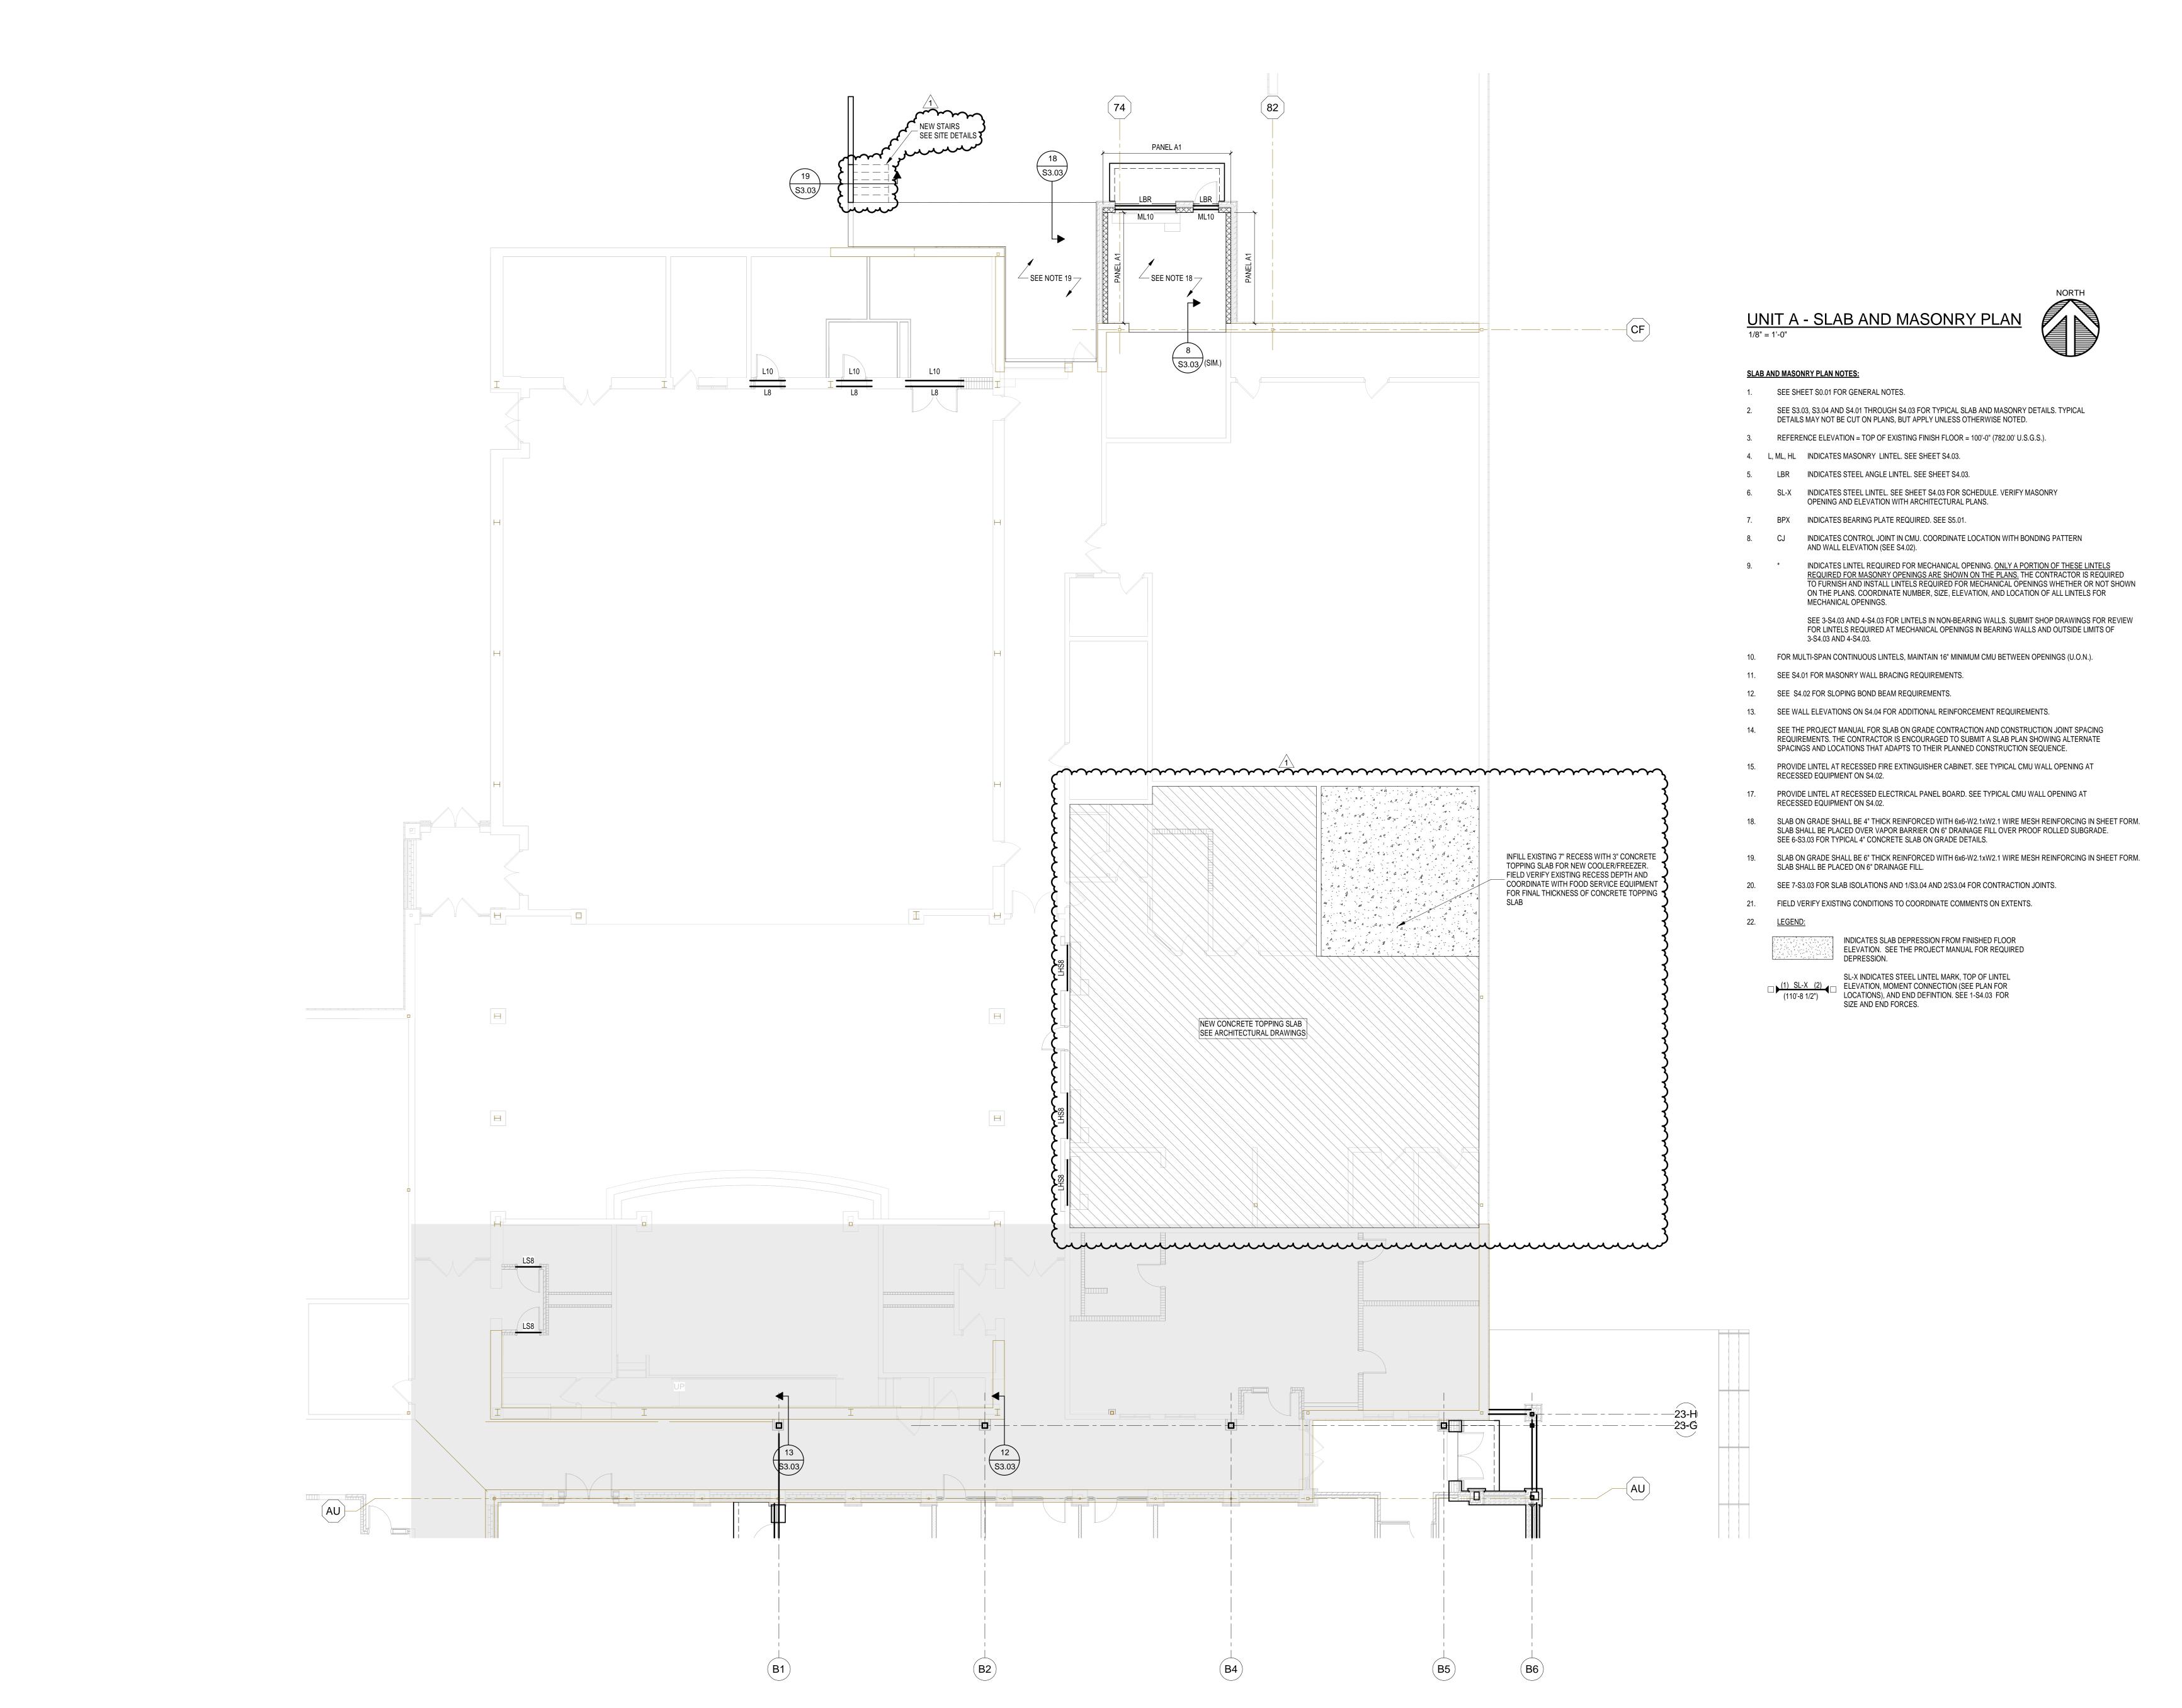

CHERRY TREE ELEMENTARY SCHOOL ADDITIONS AND RENOVATIONS

13989 Hazel Dell Pkwy, Carmel, IN

CARMEL CLAY SCHOOLS



ARCHITECT



317-848-0966 WWW.FHAI.COM 350 E. New York St, Indianapolis IN 46204

CONSULTANT



TLF, INC.


3901 West 86th Street, Suite 200
Indianapolis, Indiana 46268
Phone: 317-334-1500
Fax: 317-334-1552

2023-142

TLF Job No:

D C B

KEY PLAN

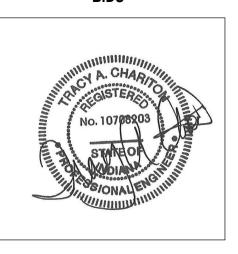

PROJECT MANAGER: SAM

DRAWN BY: TLF

PROJECT NUMBER: 222011.00

PROJECT ISSUE DATE: 02.09.2024

REV.	DESCRIPTION	DATE
1	ADDENDUM 1	02.23.24

UNIT A - SLAB AND MASONRY PLAN

S1.03

INCLUDING BACKINGS, ADHESIVES, BASES, DOWN TO BUT CHERRY TREE SUSPENSION SYSTEMS ADHESIVE RESIDUES, MOLDINGS, WALLS TO BE REMOVED SHALL BE REMOVED TO A POINT 2' (MIN.) BELOW THE EXISTING FLOOR SLAB (UNLESS SETTING ON SLAB). PATCH WITH NEW CONCRETE TO BE FLUSH WITH OPENING SHALL BE A MINIMUM OF 1'-4" LONGER THAN THE

ARCHITECTURAL DEMOLITION GENERAL NOTES

EXCLUSIVE OF FLOOR SLABS AND STRUCTURAL MATERIALS, UNLESS NOTED OTHERWISE. "CEILING" DENOTES CEILING MATERIALS INCLUDING

THE EXISTING FLOOR SLAB.

EXISTING CONDITIONS.

EXISTING STRUCTURES.

NECESSARY MATERIAL.

ELECTRICAL.

NEW CMU TOOTHED-IN AT EDGES.

UP TO BUT EXCLUSIVE OF STRUCTURAL MATERIALS.

FINISHED OPENING REQUIRED TO ALLOW FOR 8" (MIN) OF

EXPOSED SURFACE SHALL BE SMOOTH AND FLUSH WITH

MECHANICAL AND ELECTRICAL ITEMS THAT ARE CAPPED AND ABANDONED SHALL BE LOCATED BEHIND FINAL FINISH

SITE, STRUCTURAL, PLUMBING, MECHANICAL, AND

PROVIDE INTERIOR AND EXTERIOR SHORING, BRACING, OR SUPPORT TO PREVENT MOVEMENT OR SETTLEMENT OF

CONTRACTOR TO FIELD VERIFY PORTIONS OR SECTIONS OF EXISTING WALLS TO BE FILLED IN AND SALVAGE

MATERIALS OF DEMOLITION SHALL BE DISPOSED OF OFF-SITE UNLESS OTHERWISE DIRECTED BY OWNER. OWNER TO REMOVE EXISTING FURNITURE AND MISCELLANEOUS ITEMS NOT SHOWN AND NOT TO BE DEMOLISHED. CONTRACTOR TO NOTIFY OWNER IN ADVANCE WHEN ITEMS NEED TO BE REMOVED.

CONTRACTOR IS RESPONSIBLE FOR OTHER ITEMS TO BE

MATERIAL. REFINISH TO LIKE NEW CONDITION, OR IF

CONDITION WARRANTS REPLACE IN ENTIRETY. THE OWNER SHALL RESERVE RIGHT TO CLAIM ANY MATERIALS THAT ARE BEING DEMOLISHED PRIOR TO THE

CONTRACTOR DISPOSING OF THEM OFF SITE. "TURNED OVER TO THE OWNER" DENOTES: 1) TAG AND IDENTIFY ITEMS: 2) STORE IN AN ORDERLY FASHION IN A

LOCATION DESIGNATED BY THE OWNER.

(ALL NOTES MAY NOT BE INDICATED ON THIS SHEET)

REMOVE EXISTING DOOR AND FRAME

REMOVE EXISTING GWB CEILING/BULHEAD

REMOVE EXISTING CASEWORK AS SHOWN

REMOVE EXISTING EQUIPMENT AS SHOWN

ABOVE AND MASONRY WALL BELOW

REQUIRED FOR LINTEL INSTALLATION

REMOVE EIFS WALL/BULKHEAD IN THIS AREA REMOVE INTERIOR WINDOW AND FRAME

REMOVE ROOF AND STRUCTURE ABOVE IN THIS AREA. COORDINATE EXTENT OF DEMOLITION WITH NEW

HOLES IN MASONRY WALLS TO REMAIN WITH BRICK OR CMU

REMOVE STEEL BEAM AND ANY COLUMNS SUPPORTING

MASTIC FROM ALL CORRIDOR WALLS. REMOVE MASTIC COMPLETE AS REQUIRED VIA SCRAPING OR MECHANICAL

MEANS. WALLS ARE CONCRETE MASONRY UNITS U.N.O.

ADHESIVES AND MECHANICAL FASTENERS; INFILL HOLES IN

TACKABLE WALL SURFACE ON FULL LENGTH OF INDICATED

WALL; REMOVE ADHESIVES AND MECHANICAL FASTENERS; INFILL HOLES IN CONCRETE MASONRY UNITS WITH SEALANT TO CREATE FINISHED APPEARANCE - WHERE NEW DISPLAY

WALL CONSTRUCTION IS GWB ON CMU. REPAIR GWB WALL WHERE VINYL-FACED TACKABLE SURFACE/EQUIPMENT WAS REMOVED AND PREPARE FOR NEW VINYL WALLCOVERING

LOUVERS. COORDINATE OPENINGS WITH MECHANICAL AND

STRUCTURE FOR SIZE AND LOCATION - SEE EXTERIOR

AS REQUIRED TO PROVIDE NEW OPENINGS

ELEVATION. TOOTH IN SURROUNDING MASONRY OPENING

REMOVE QUARRY TILE FLOOR AND BASE AND SETTING BED. INFILL SLAB RECESS WITH NEW CONCRETE SLAB, SLOPE TO

REMOVE CONCRETE TOPPING SLAB AND INSULATION FROM

COOLER/FREEZER AREA. INFILL SLAB RECESS WITH NEW CONCRETE SLAB AT 4" BELOW FINISHED FLOOR. VERIFY

BOARDS ARE NOT INDICATED, REFER TO A7 PLANS

CONCRETE MASONRY UNITS WITH SEALANT TO CREATE FINISHED APPEARANCE - NO NEW EQUIPMENT TO BE

RESTROOM ACCESSORIES

STRUCTURAL DRAWINGS

TO MATCH EXISTING.

MASONRY OPENING

IN IT'S ENTIRETY.

FRAME ABOVE

INSTALLATION.

DRAINS AS REQUIRED.

WITH COOLER/FREEZER MANUF.

INSTALLED IN THIS LOCATION

ONLY OPERABLE WALL BEAMS.

WALL BELOW

REMOVE EXISTING MASONRY WALL REMOVE EXISTING ACT CEILING

UNDERSLAB PLUMBING WORK

REMOVE EXISTING CARPET FLOOR AND RESILIENT BASE REMOVE EXISTING VCT FLOOR AND RESILIENT BASE

SAWCUT AND REMOVE CONCRETE SLAB AS REQUIRED FOR

CONCRETE FLOOR PATCH TO BE LEVEL WITH ADJACENT

DEMOLITION IS TO FOLLOW ESTABLISHED CONSTRUCTION SEQUENCE. CONTRACTOR IS TO VERIFY THEIR WORK IN THE FIELD WITH THE DEMOLITION DRAWINGS, NEW CONSTRUCTION DRAWINGS, AND THE EXISTING IN-FIELD CONDITIONS. REPORT DISCREPANCIES TO THE ARCHITECT "FLOORING" DENOTES FLOOR COVERING MATERIALS

13989 Hazel Dell Pkwy, Carmel, IN

CARMEL CLAY SCHOOLS



ARCHITECT

WWW.FHAI.COM 350 E. NEW YORK ST, INDIANAPOLIS IN 46204

KEY PLAN

No AR10800161

PROJECT MANAGER: SAM DRAWN BY: TPV PROJECT NUMBER: 222011.00


PROJECT ISSUE DATE: 02.09.2024					
REV.					
NO.	DESCRIPTION	DATE			
1	ADDENDUM #1	2.23.2024			


VERIFICATION NOTE

CONTRACTOR SHALL VERIFY ALL DIMENSIONS AND CLEARANCES AND ALL EXISTING FIELD CONDITIONS BEFORE STARTING CONSTRUCTION. COMMENCEMENT OF WORK CONSTITUTES ACCEPTANCE OF CONDITIONS. SHOULD DIFFERENT CONDITIONS BE ENCOUNTERED,

CONTACT THE ARCHITECT BEFORE PROCEEDING WITH

UNIT A DEMOLITION PLAN

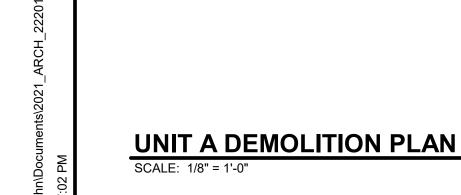


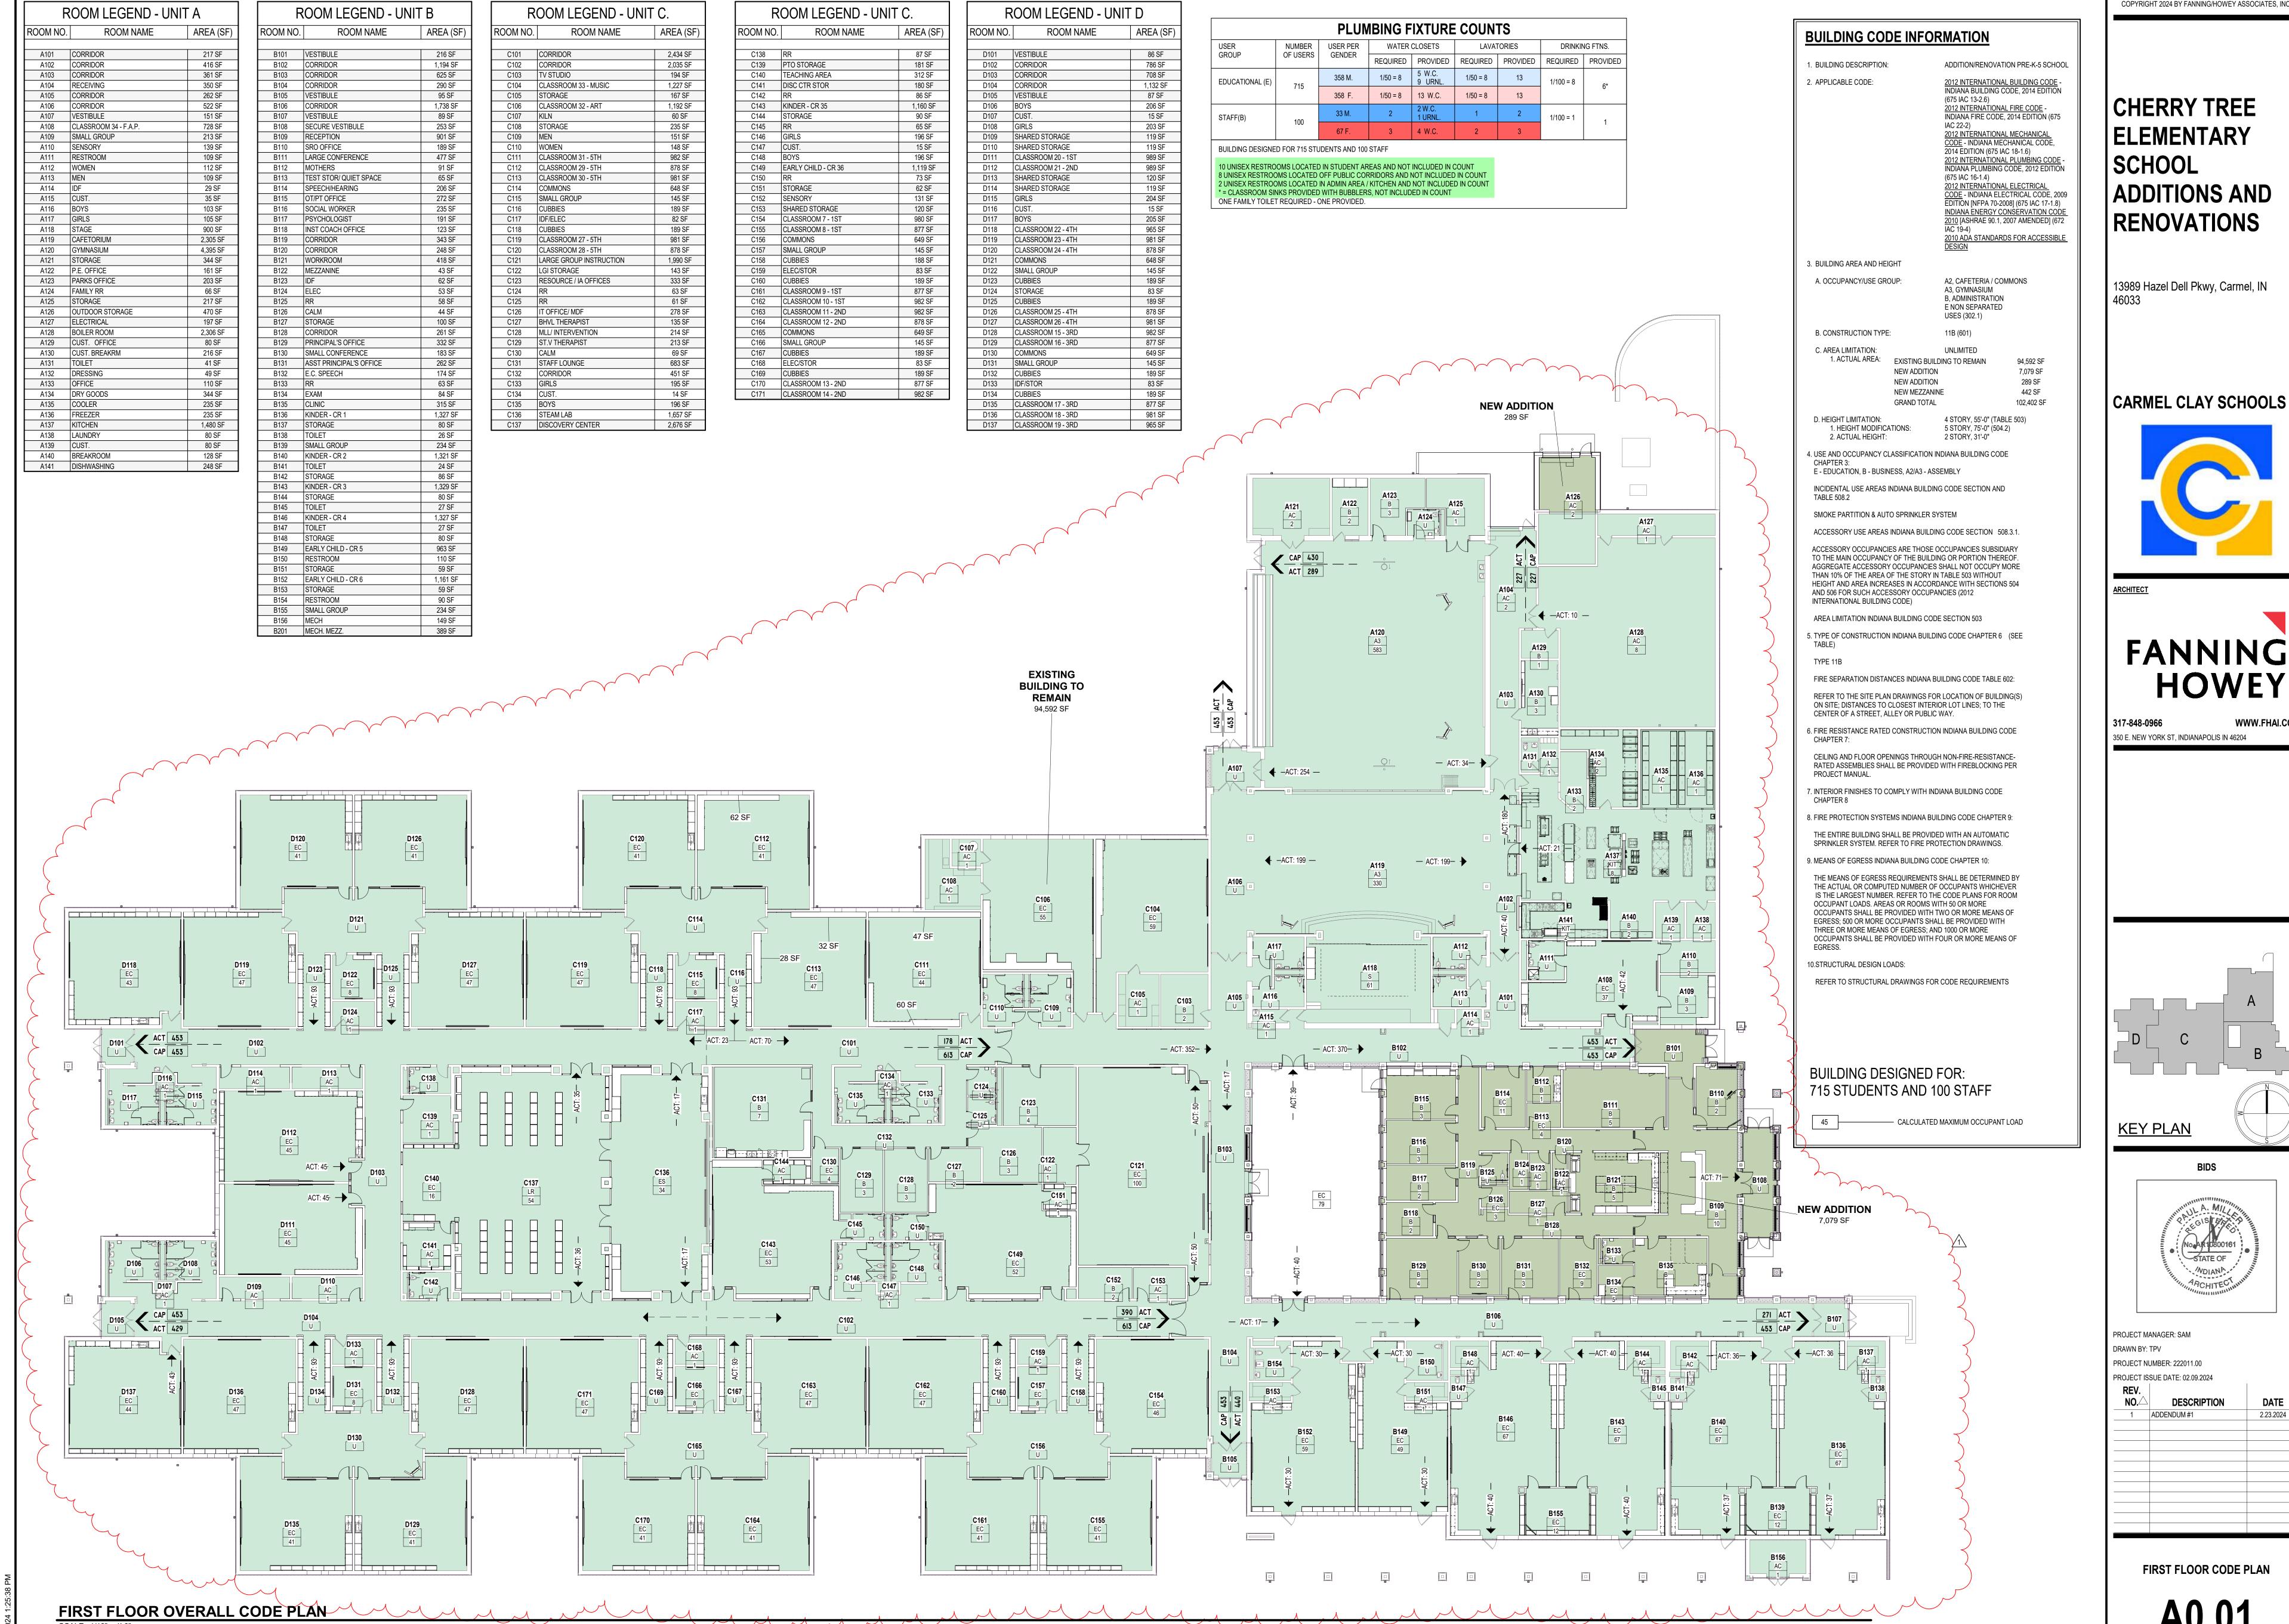






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UNIT B ARCHITECTURAL PLAN
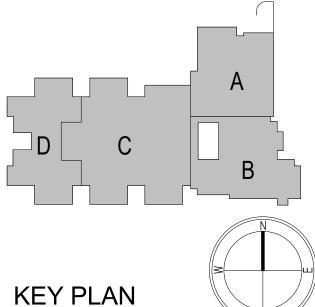
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ELEMENTARY **ADDITIONS AND** RENOVATIONS

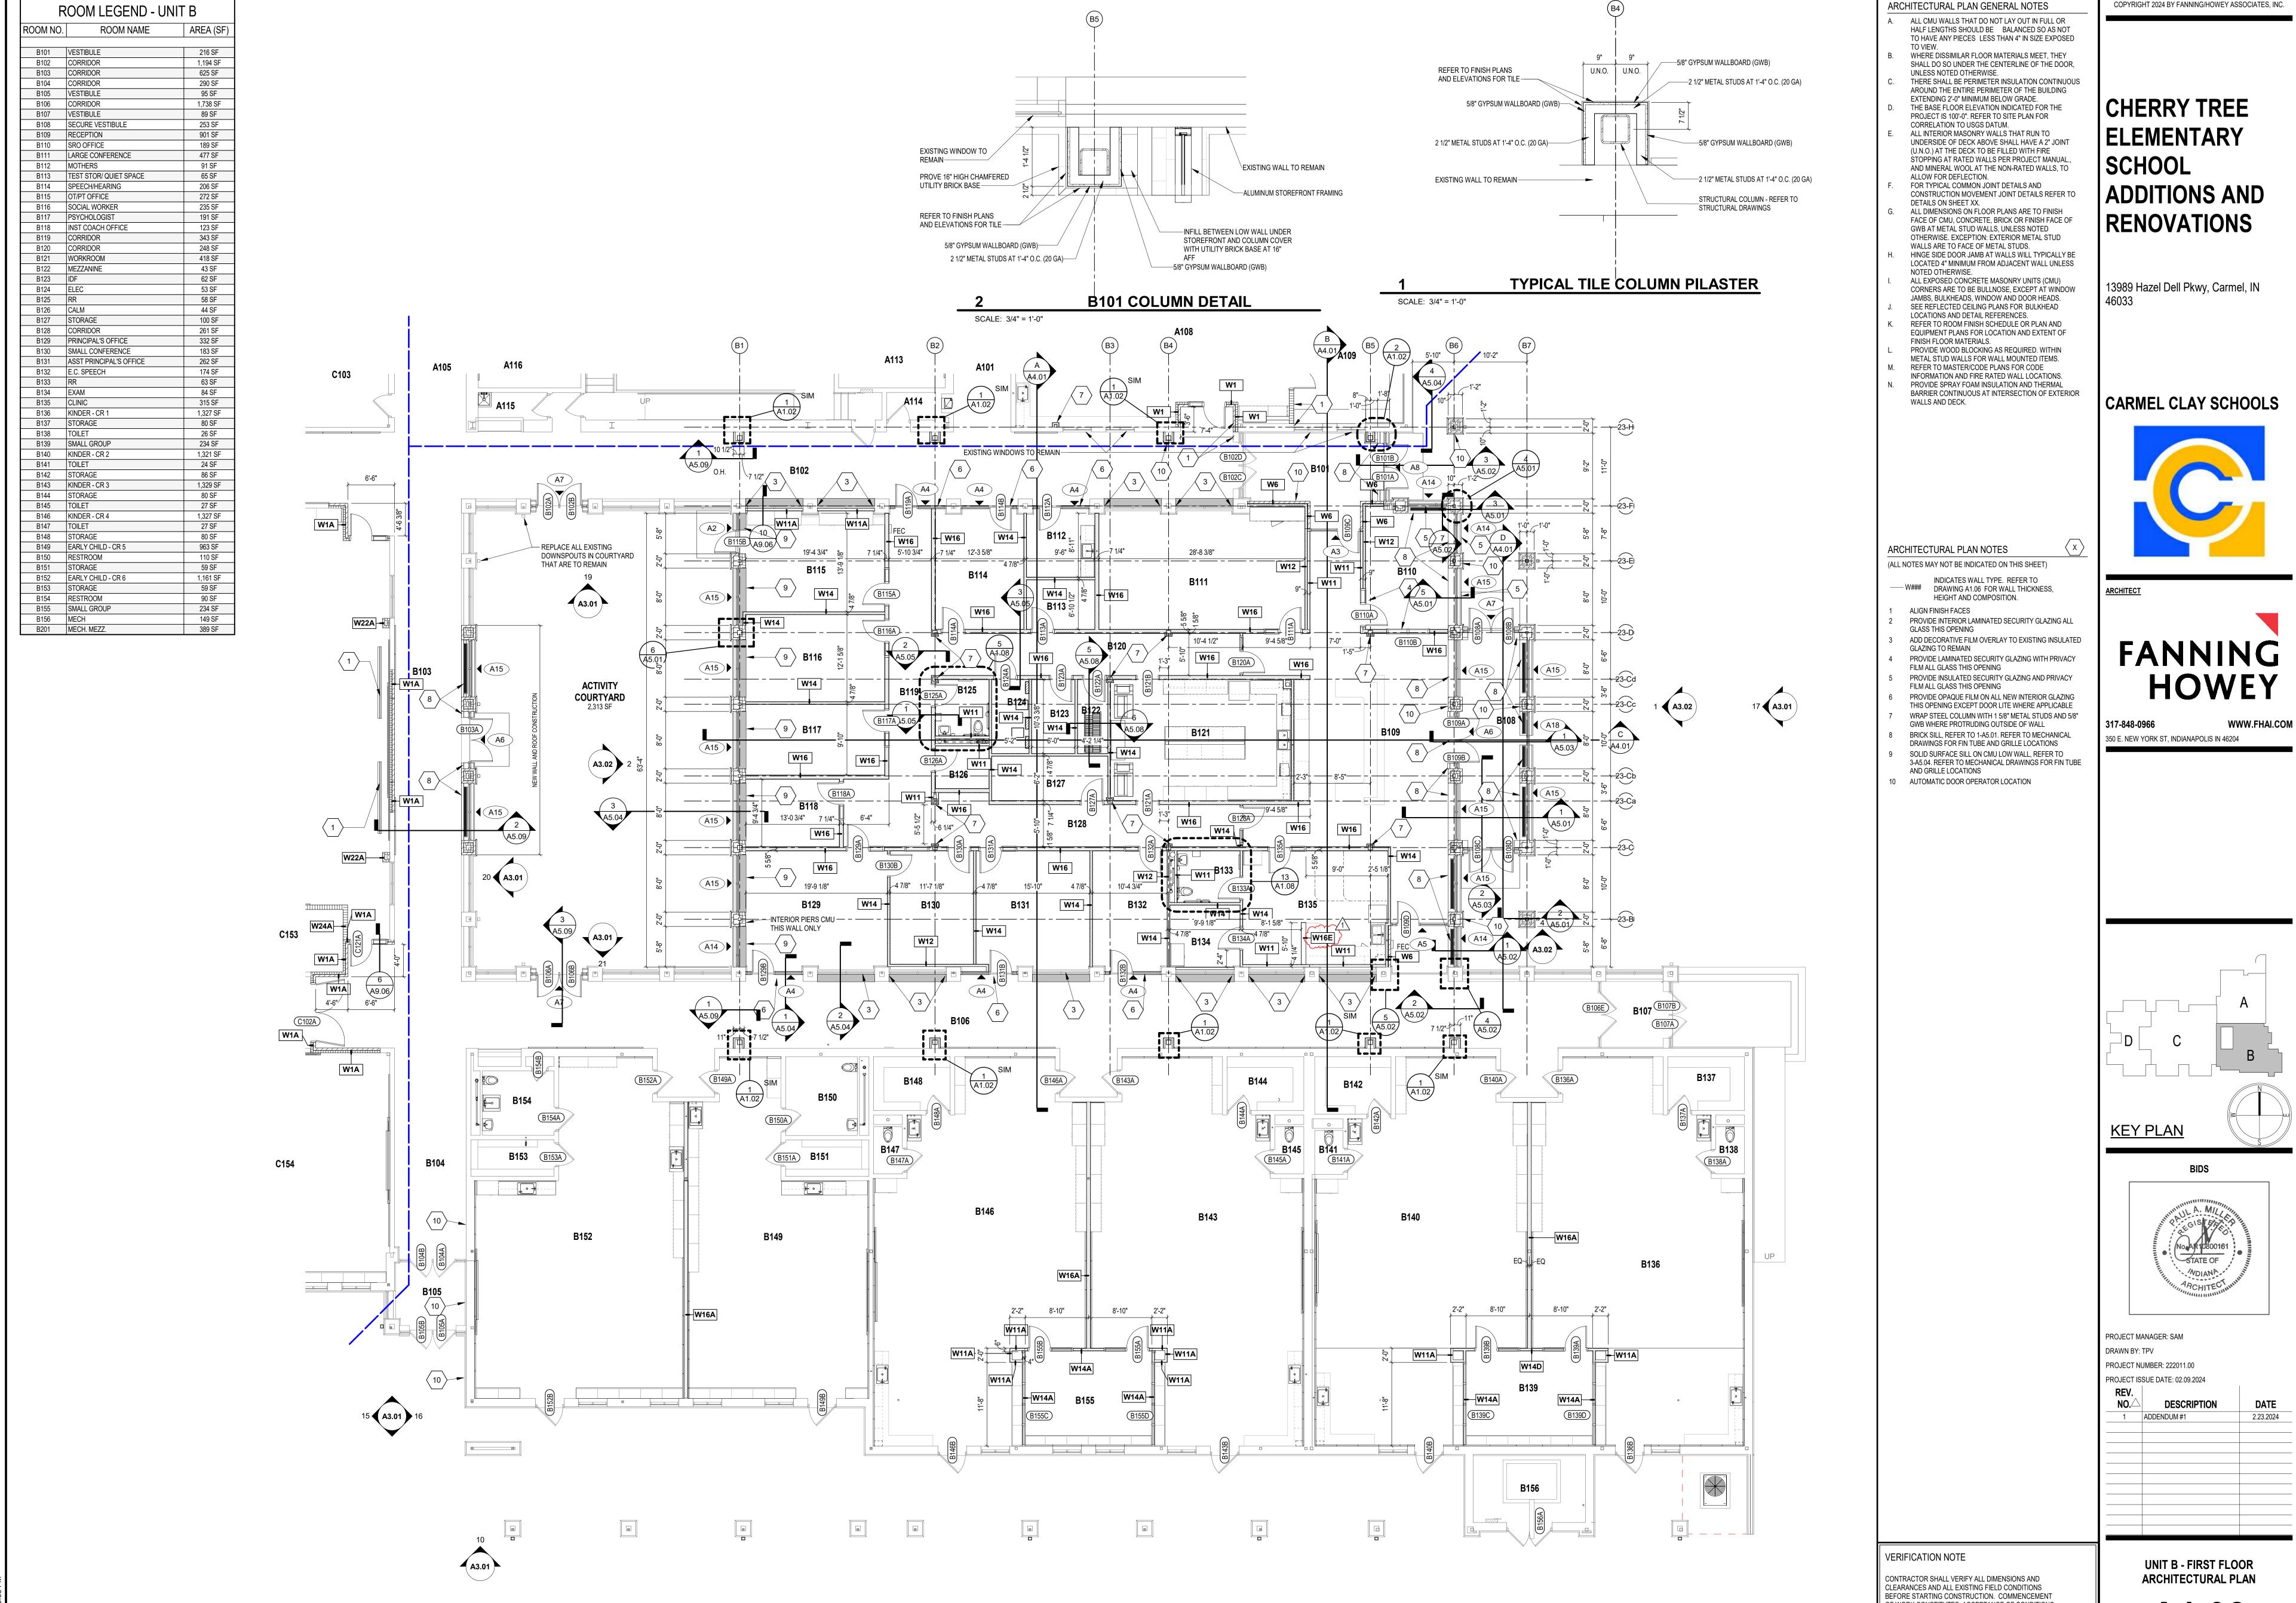


HOWEY


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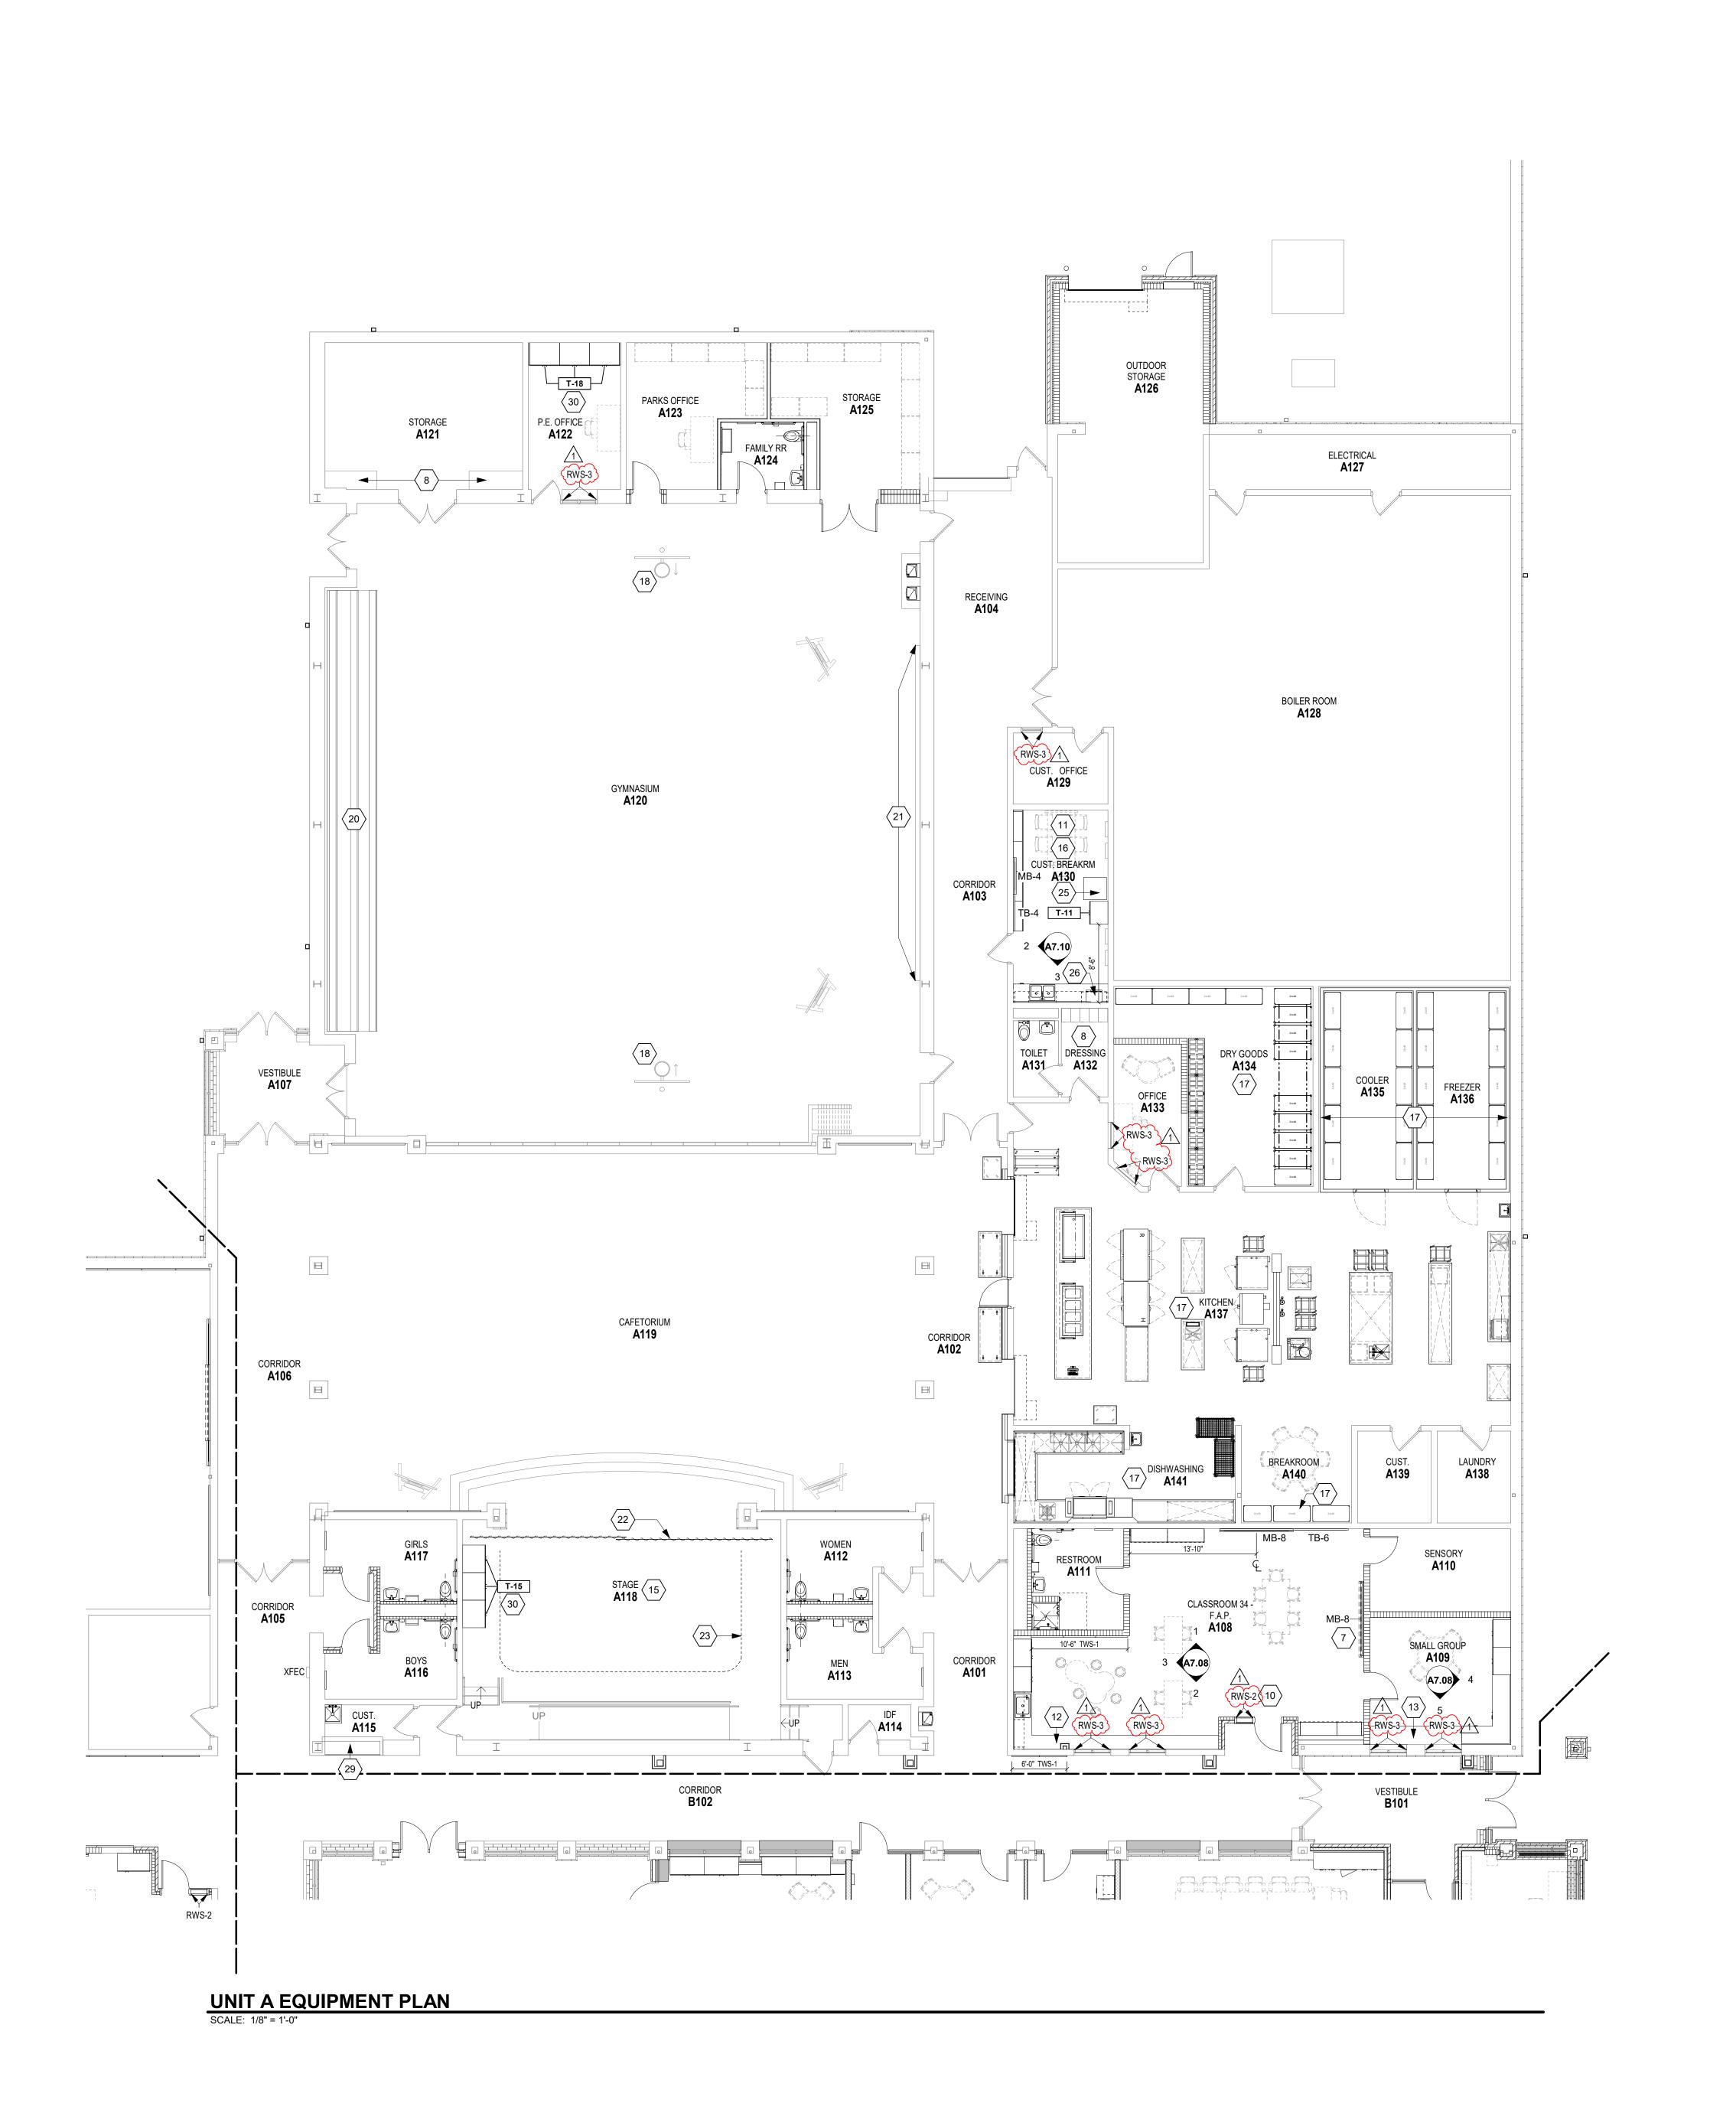
OF WORK CONSTITUTES ACCEPTANCE OF CONDITIONS. SHOULD DIFFERENT CONDITIONS BE ENCOUNTERED, CONTACT THE ARCHITECT BEFORE PROCEEDING WITH

UNIT B - FIRST FLOOR ARCHITECTURAL PLAN

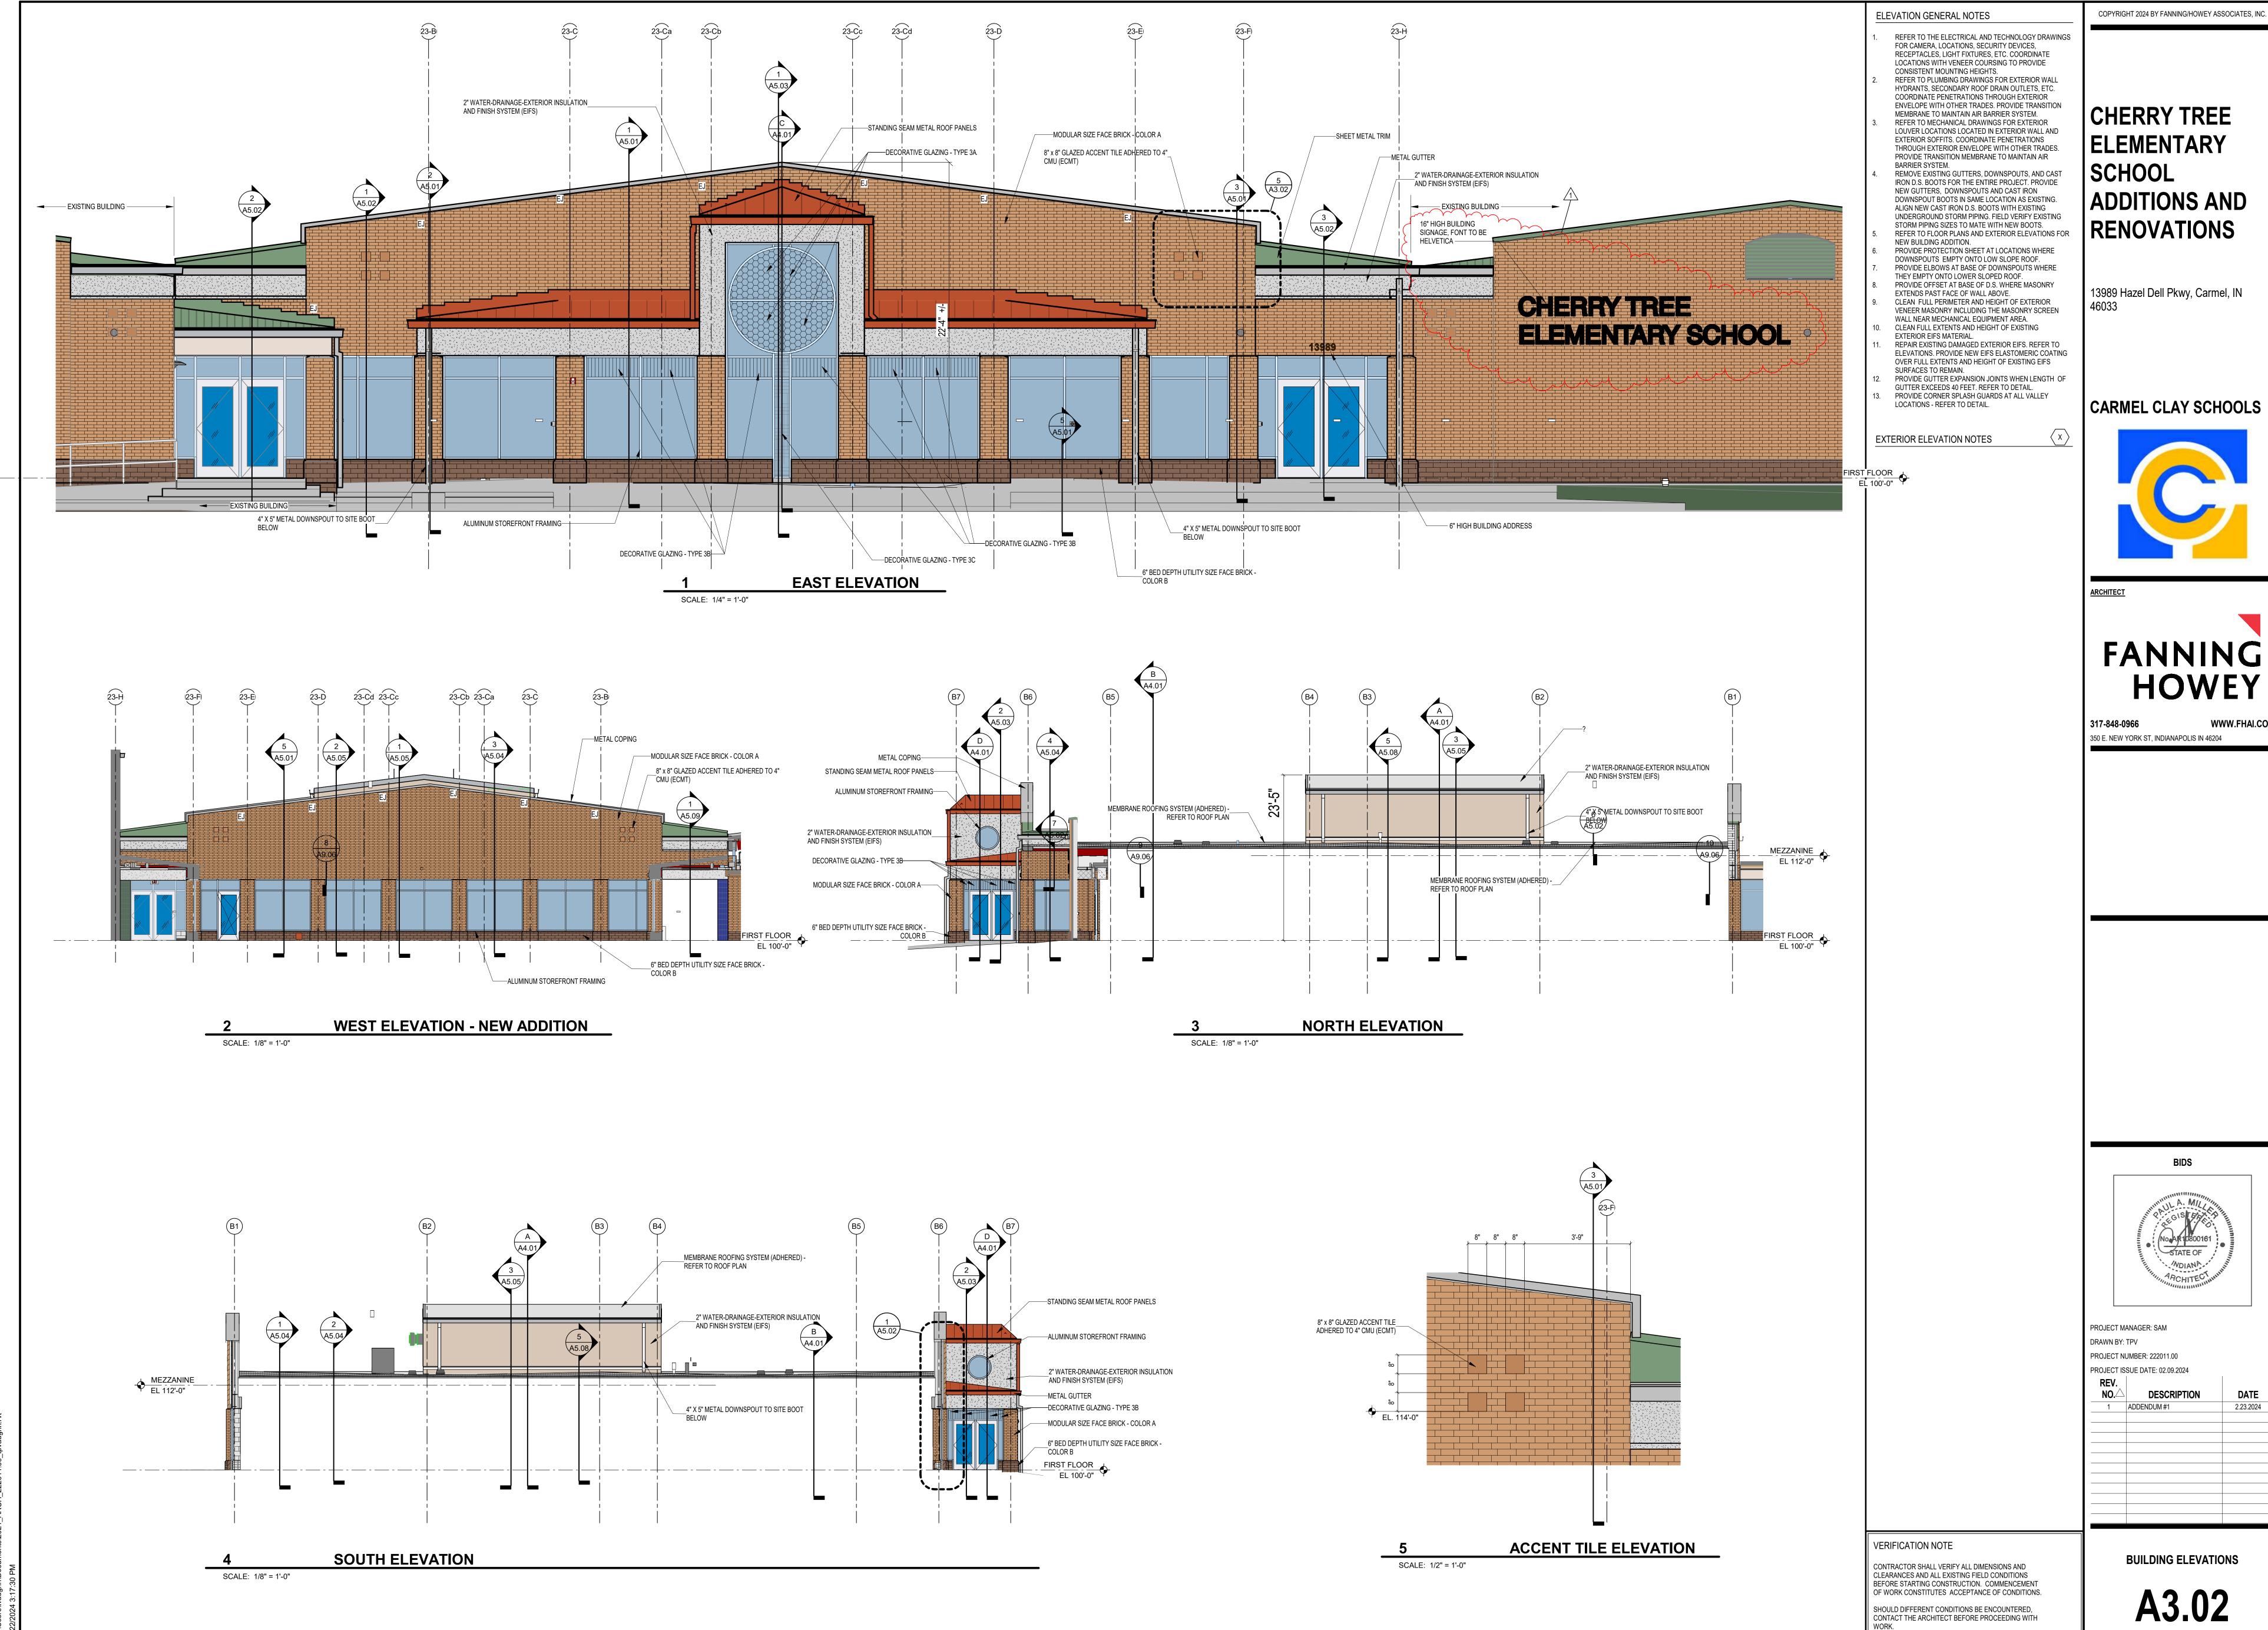

NO.	DESCRIPTION	DATE
1	ADDENDUM #1	2.23.2024



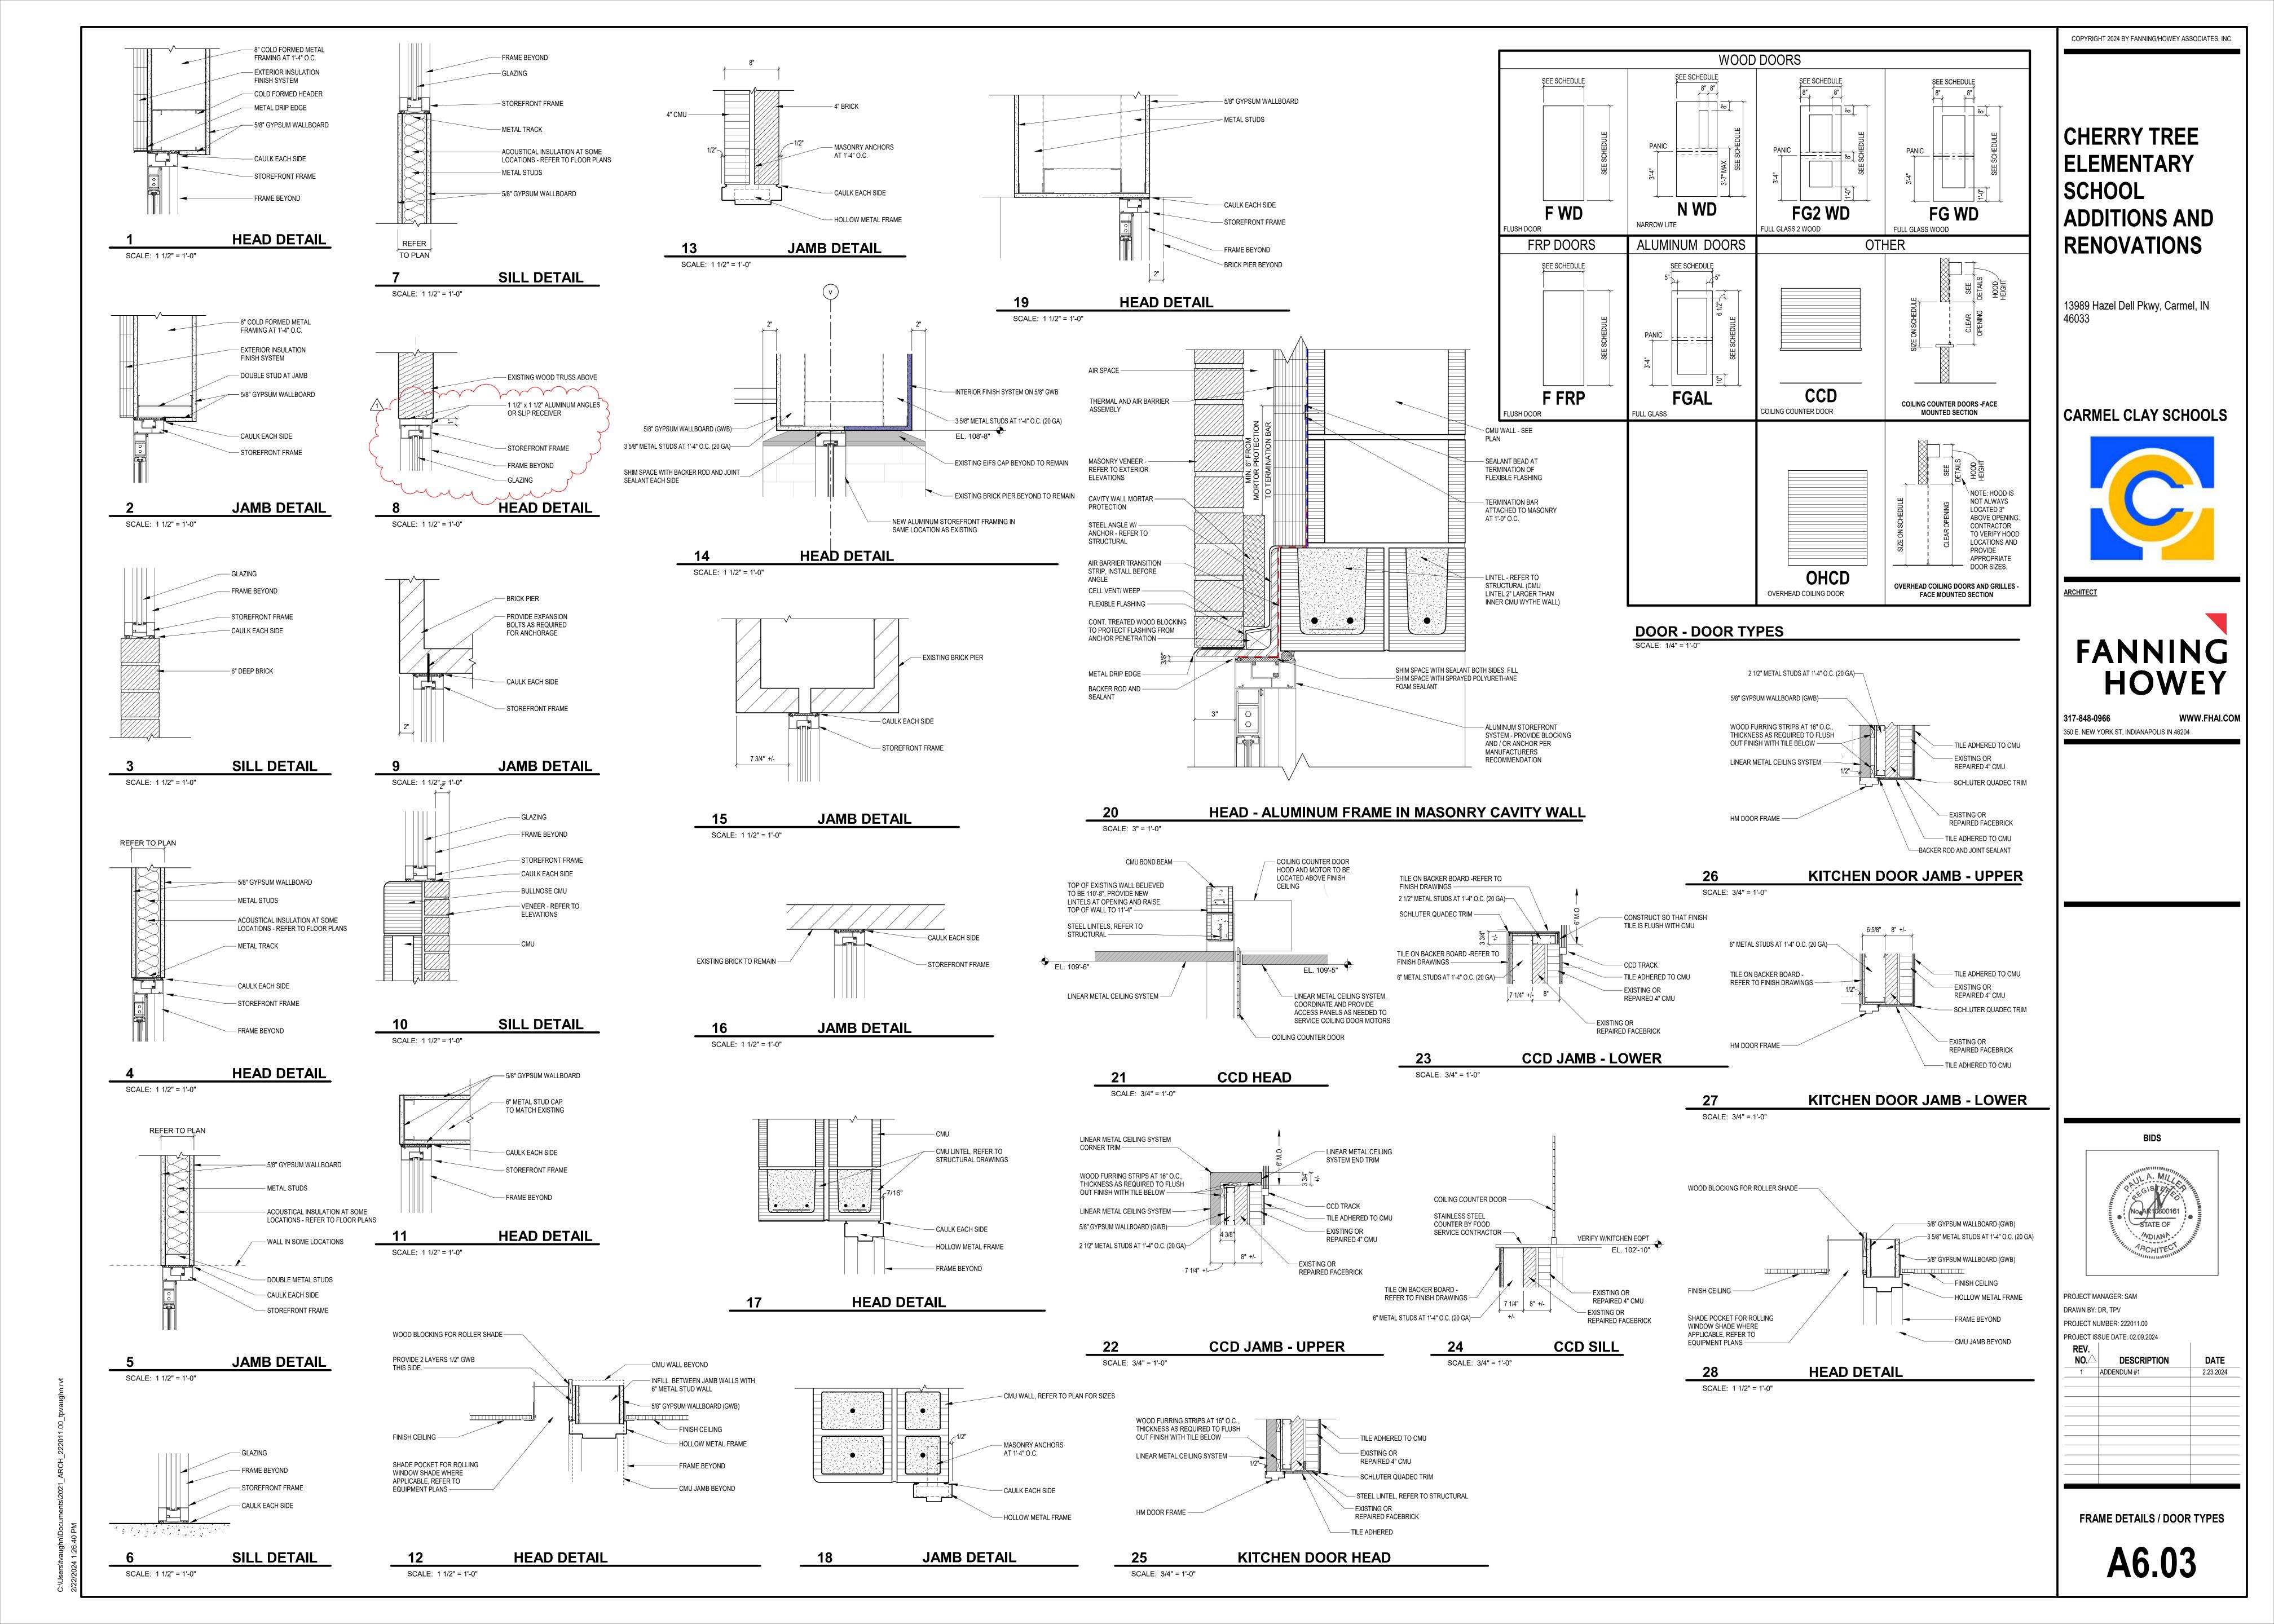

ROOM LEGEND - UNIT A ROOM NO. **ROOM NAME** AREA (SF) A101 CORRIDOR A102 CORRIDOR 416 SF A103 CORRIDOR 361 SF A104 RECEIVING 350 SF A105 CORRIDOR A106 CORRIDOR A107 VESTIBULE A108 CLASSROOM 34 - F.A.P. 728 SF A109 SMALL GROUP A110 SENSORY 139 SF A111 RESTROOM 109 SF A112 WOMEN 112 SF A113 MEN 109 SF A114 A115 (103 SF A116 BOYS A117 GIRLS 105 SF A118 STAGE 900 SF A119 CAFETORIUM 2,305 SF A120 GYMNASIUM 4,395 SF A121 STORAGE A122 P.E. OFFICE A123 PARKS OFFICE A124 FAMILY RR 66 SF A125 STORAGE A126 OUTDOOR STORAGE 470 SF A127 ELECTRICAL 197 SF A128 BOILER ROOM 2,306 SF A129 CUST. OFFICE A130 CUST. BREAKRM A131 TOILET A132 DRESSING 49 SF A133 OFFICE 110 SF A134 DRY GOODS 344 SF A135 COOLER 235 SF A136 FREEZER A137 KITCHEN A138 LAUNDRY 80 SF A139 CUST. 80 SF

A140 BREAKROOM

A141 DISHWASHING

EQUIPMENT GENERAL NOTES

ALL COUNTERTOPS TO HAVE CONTINUOUS 4" HIGH

BACKSPLASHES AND ENDSPLASHES UNLESS NOTED

HIDDEN LINES (----) INDICATE ITEMS TO BE PART OF LOOSE EQUIPMENT PACKAGE OR BY OWNER, NOT INCLUDED IN CONSTRUCTION CONTRACTS. DASHED LINES (---) INDICATE OVERHEAD ITEMS (INCLUDED IN CONSTRUCTION CONTRACTS). (TB) INDICATES 6' HIGH TACK BOARD; LENGTH AS INDICATED. REFER TO MOUNTING HEIGHT DRAWING.

(MB) INDICATES <u>4' HIGH</u> MARKER BOARD; LENGTH AS INDICATED. REFER TO MOUNTING HEIGHT DRAWING. (TWS) INDICATES TACKABLE WALL SURFACE; LENGTH AS DIMENSIONED. REFER TO ELEVATIONS FOR HEIGHTS. PROVIDE FILLER STRIPS BETWEEN CASEWORK UNITS AND WALL OR BETWEEN ANY UNIT AS REQUIRED. EXTEND COUNTER TO FACE OF WALL OR ADJACENT TALL CABINET. ALL CASEWORK DOORS AND DRAWERS WILL NOT BE LOCKABLE UNLESS NOTED OTHERWISE. ALL EXPOSED ENDS AND BACKS OF CASEWORK SHALL BE

FINISHED; ALL EXPOSED BOTTOMS OF CUBBY CABINETS SHALL BE FINISHED. CASEWORK INSTALLER SHALL CUT CASEWORK AS REQUIRED FOR PLUMBING/ELECTRICAL LINES. CASEWORK INSTALLER SHALL CAULK BETWEEN COUNTERS, BACKSPLASHES, AND WALLS. ALL WALL-MOUNTED CASEWORK SHALL BE MOUNTED WITH THE TOP AT 7'-0" AFF UNLESS OTHERWISE NOTED; WC-01 IS

MOUNTED WITH THE TOP AT 7'-3" AFF. (CG) INDICATES CORNER GUARD, REFER TO SPECIFICATIONS FOR ADDITIONAL DETAILS AND A7S.01 FOR COLOR SELECTIONS. (XFEC) INDICATES EXISTING FIRE EXTINGUISHER CABINET (FEC) INDICATES NEW FIRE EXTINGUISHER CABINET. (RWS) INDICATES ROLLER WINDOW SHADE.

REFER TO A7S.01 LIST OF FINISHES FOR EQUIPMENT

COLOR SELECTIONS; REFER TO A8S.01 FOR ALL SELECTIONS NOT NOTED ON THIS SHEET. INTERIOR PANEL SIGNAGE TO BE PROVIDED BY ALLOWANCE.

EQUIPMENT NOTES

128 SF

248 SF

SCHEDULE ON A7S.01

ALL NOTES MAY NOT BE INDICATED ON THIS SHEET) 42"H DOUBLE-SIDED MOBILE UNITS (MBC-01), REFER TO DETAIL ON A7.06 AND MEDIA CENTER CASEWORK

42"H SINGLE-SIDED BOOKSHELVES (MC-2) WITH CONTINUOUS MATCHING PL-3 COUNTERTOP; REFER TO DETAIL 9/A7.07 60"H SINGLE-SIDED BOOKSHELVES (MC-4 OR 5, REFER TO ELEVATIONS)

OPEN KNEESPACE BELOW COUNTERTOP, REFER TO DETAIL BUILT-IN WOOD SHELVING AND NOOK WITH UPHOLSTERED SEAT, REFER TO ELEVATION 3/A8.07 & DETAIL 10/A7.07 RECESSED CEILING-MOUNTED ELECTRIC PROJECTION SCREEN; B.O.D. IS DRAPER LUMA 2 NTSC FORMAT 150"

DIAGONAL SCREEN WALL-MOUNTED MANUAL PROJECTION SCREEN; B.O.D. IS DRAPER LUMA 2 NTSC FORMAT 10' DIAGONAL SCREEN WITH 6" EXTENSION MOUNTING BRACKET

10 RWS HOUSING TO BE RECESSED INTO CEILING, REFER TO DETAIL ON A7.06 11 MONITOR, BY OWNER

SOLID SURFACE KNEE WALL CAP, SSM-2, REFER TO DETAIL

EXISTING EQUIPMENT TO REMAIN IN THIS ROOM

12 PL-1 CABINETRY WITH SSM-1 COUNTERTOP/BACKSPLASH 13 PL-1 CABINETRY WITH PL-2 COUNTERTOP 14 WALL-MOUNTED MANUAL PROJECTION SCREEN; B.O.D. IS DRAPER LUMA 2 NTSC FORMAT 150" DIAGONAL SCREEN

EXISTING PROJECTION SCREEN AND PROJECTOR TO

16 ALL CASEWORK IN THIS ROOM TO BE PL-4 CABINETRY WITH SSM-3 COUNTERTOP/BACKSPLASH REFER TO FOOD SERVICE DRAWINGS FOR KITCHEN

EQUIPMENT SCOPE AND INFORMATION 18 INSTALL MOTORIZED HEIGHT ADJUSTER CONVERSION KIT ON EXISTING MANUAL BASKETBALL GOAL 19 A-8 & A-9: SLIDE-IN ELECTRIC RANGE WITH RECIRCULATING HOOD ABOVE; REFER TO APPLIANCE SCHEDULE ON A7S.01

20 EXISTING BLEACHERS TO REMAIN EXISTING CLIMBING WALL AND PADDING TO REMAIN 22 INSTALL NEW STAGE CURTAIN (SC-1) ON EXISTING TRACK 23 INSTALL NEW TRAVELING BACK STAGE CURTAIN (SC-2) ON EXISTING TRACKS

24 A-6 & A-7: UNDER-COUNTER ICE MAKER WITH RO SYSTEM; HOUSE RO SYSTEM IN ADJACENT BASE CABINET; REFER TO APPLIANCE SCHEDULE ON A7S.01

25 A-1: REFRIGERATOR, REFER TO APPLIANCE SCHEDULE ON 26 A-3: MICROWAVE, REFER TO APPLIANCE SCHEDULE ON

27 A-5: ADA-COMPLIANT UNDER-COUNTER REFRIGERATOR, REFER TO APPLIANCE SCHEDULE ON A7S.01 28 A-4: UNDER-COUNTER REFRIGERATOR, REFER TO APPLIANCE SCHEDULE ON A7S.01 29 EXISTING DISPLAY CASE TO REMAIN, REFER TO FINISH

PLANS FOR ADDITIONAL INFORMATION 30 PL-1 CABINETRY, REFER TO A7S.01 FOR CASEWORK 31 PL-1 PLASTIC LAMINATE CUBBIES (WC-01) WITH HOOKS MOUNTED BELOW; REFER TO TYPICAL ELEVATION 8/A7.09

AND DETAILS ON A7.07 32 9"H DIMENSIONAL LETTERS, REFER TO ELEVATIONS FOR DESIGNATION

33 CUBICLE CURTAINS AND TRACK, REFER TO A7.06 FOR TRACK DETAIL 34 RECESSED CEILING-MOUNTED ELECTRIC PROJECTION SCREEN; B.O.D. IS DRAPER LUMA 2 NTSC FORMAT 10'

DIAGONAL SCREEN - INCLUDE 30" DROP 35 EXISTING ROLLER WINDOW SHADES TO REMAIN 36 EXISTING SCOREBOARD TO REMAIN

37 A-2: REFRIGERATOR, REFER TO APPLIANCE SCHEDULE ON 38 VENDING MACHINE, BY OWNER

39 60"H SINGLE-SIDED BOOKSHELVES (MC-3) BUILT IN TO RECESS, REFER TO ELEVATIONS 40 ALL CASEWORK IN THIS ROOM TO BE PL-3 CABINETRY WITH SSM-3 COUNTERTOP/BACKSPLASH

CHERRY TREE SCHOOL **ADDITIONS AND** RENOVATIONS

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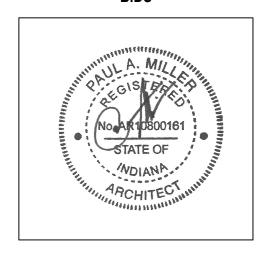
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KEY PLAN




PROJECT MANAGER: SAM DRAWN BY: AML PROJECT NUMBER: 222011.00

PROJECT ISSUE DATE: 02.09.2024

REV. NO.△	DESCRIPTION	DATE
1	ADDENDUM #1	2.23.202

VERIFICATION NOTE

CONTRACTOR SHALL VERIFY ALL DIMENSIONS AND CLEARANCES AND ALL EXISTING FIELD CONDITIONS BEFORE STARTING CONSTRUCTION. COMMENCEMENT OF WORK CONSTITUTES ACCEPTANCE OF CONDITIONS. SHOULD DIFFERENT CONDITIONS BE ENCOUNTERED, CONTACT THE ARCHITECT BEFORE PROCEEDING WITH **UNIT A - FIRST FLOOR EQUIPMENT PLAN**

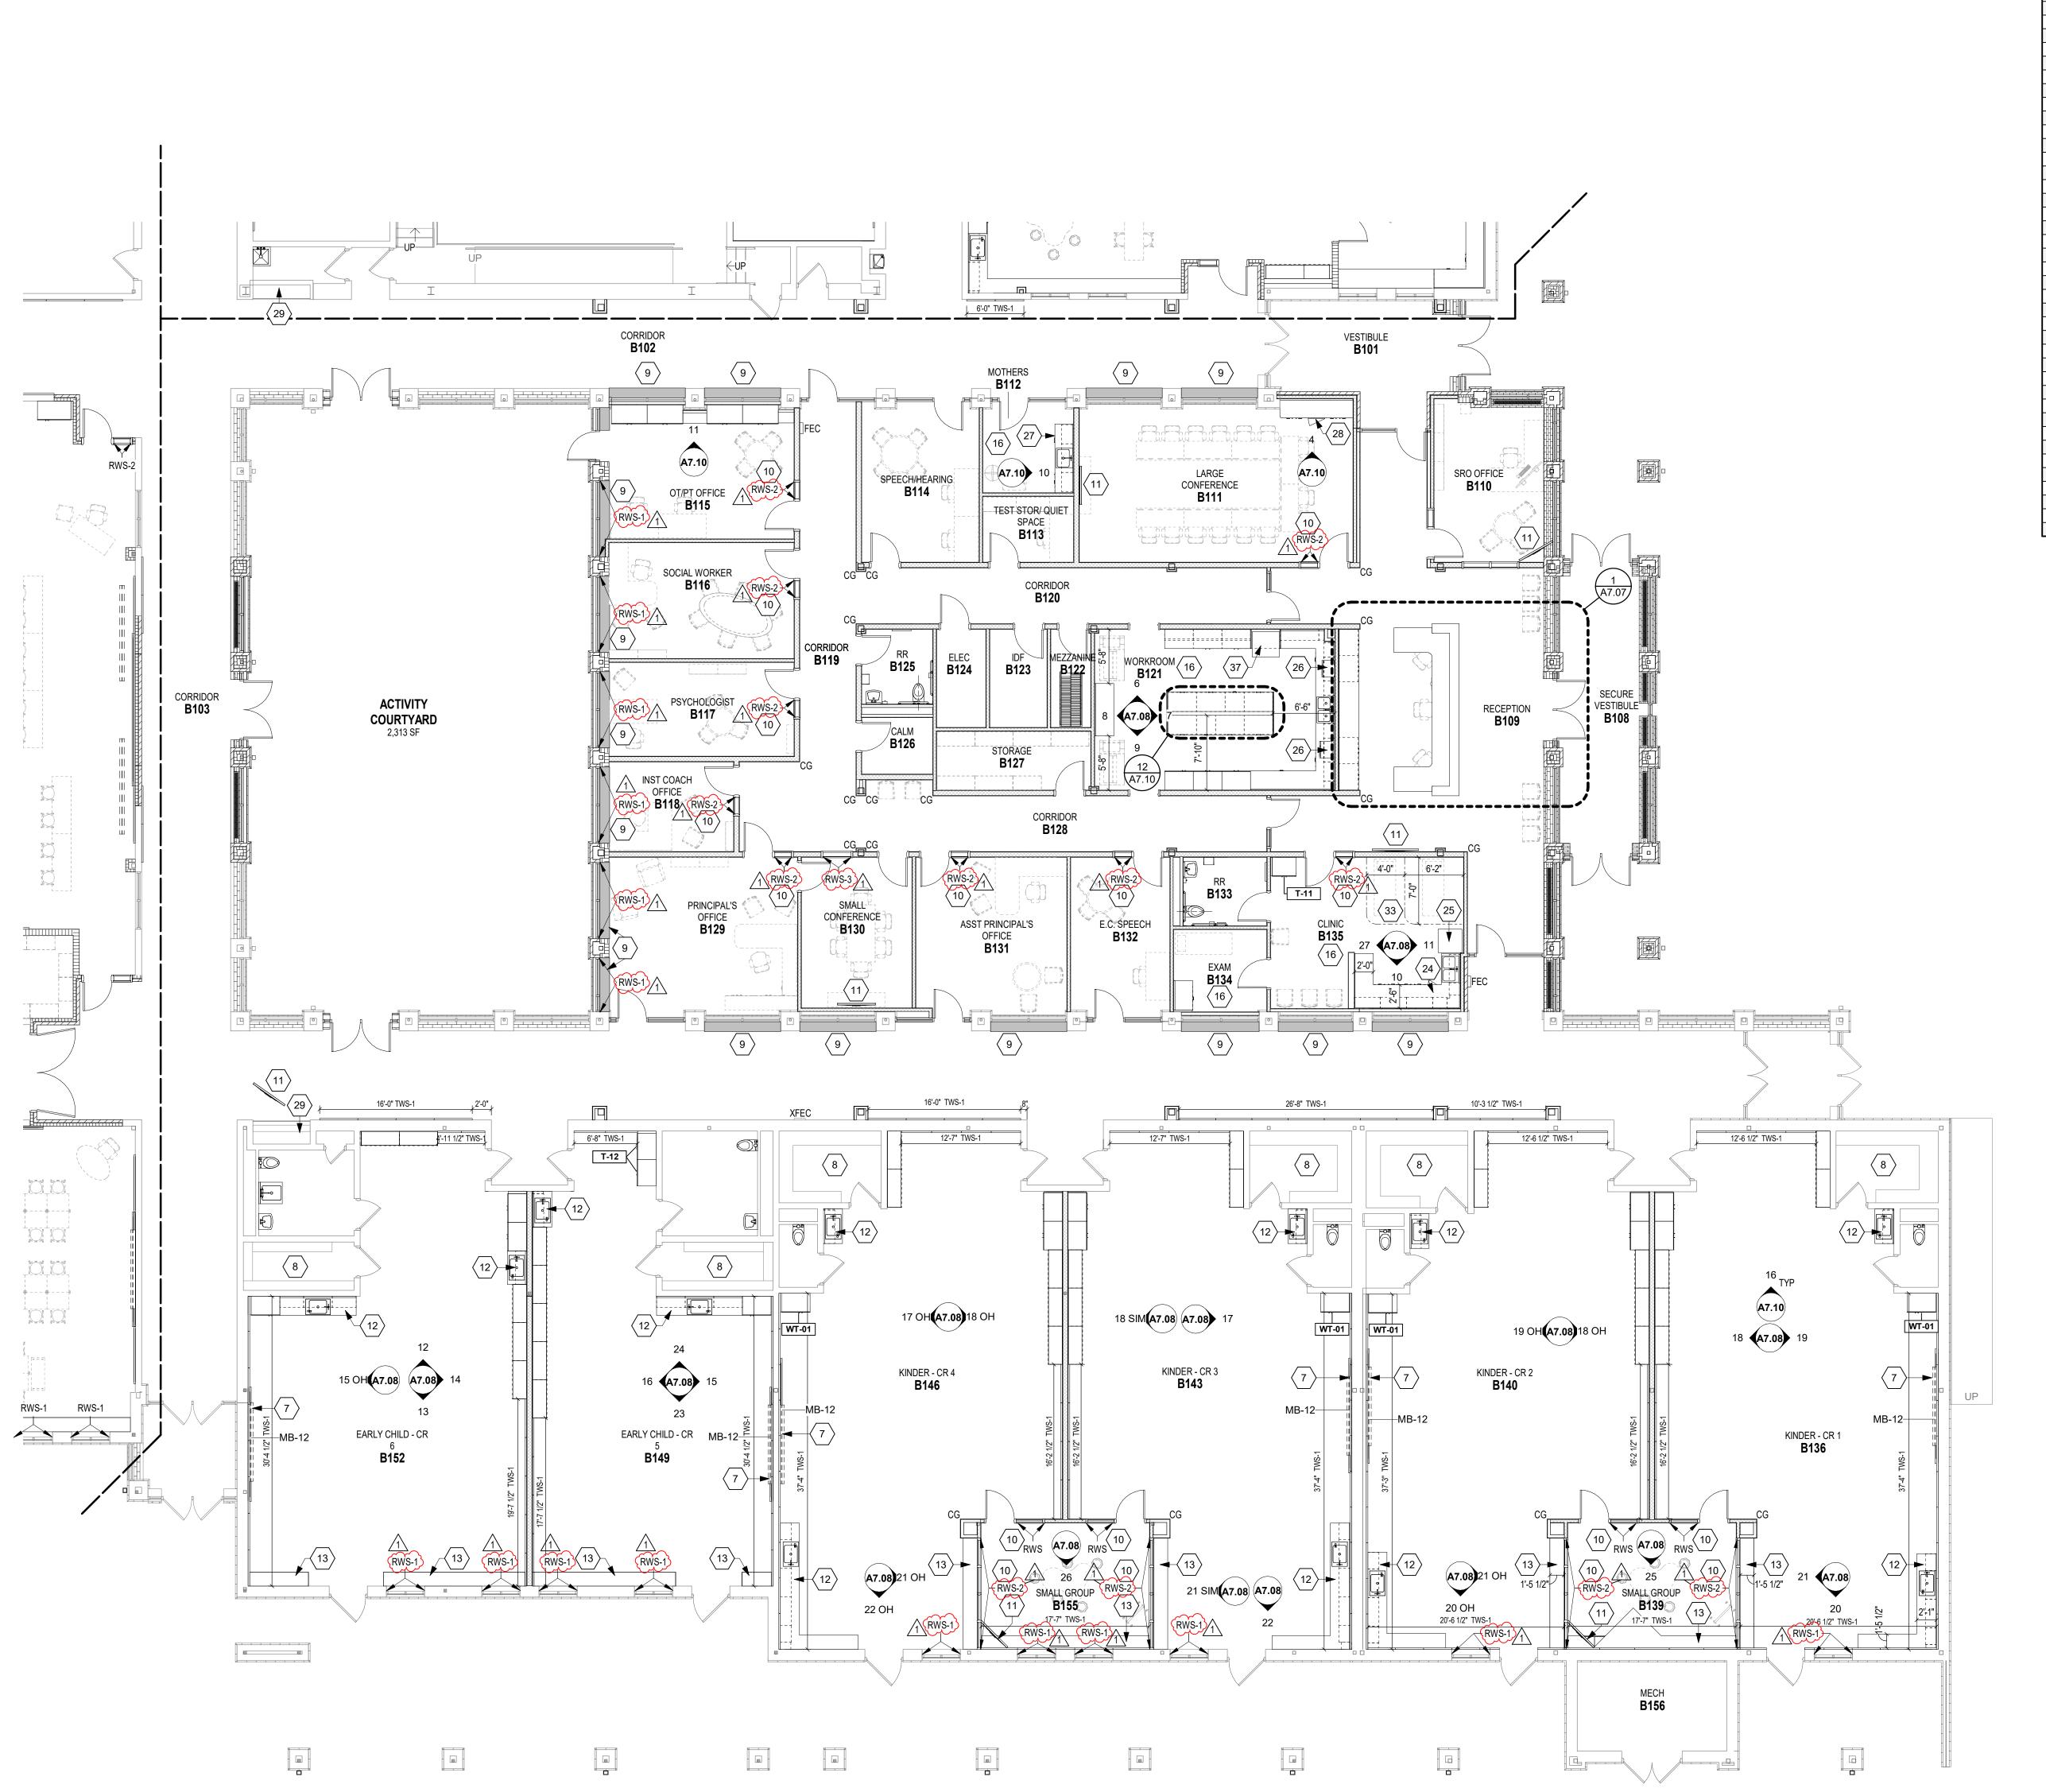

UNIT B EQUIPMENT PLAN

ROOM LEGEND - UNIT B ROOM NO. **ROOM NAME** AREA (SF B101 VESTIBULE B102 CORRIDOR 1,194 SF B103 CORRIDOR 625 SF B104 CORRIDOR 290 SF B105 VESTIBULE 95 SF B106 CORRIDOR 1,738 SF B107 VESTIBULE B108 SECURE VESTIBULE 253 SF B109 RECEPTION 901 SF B110 SRO OFFICE 189 SF 477 SF B111 LARGE CONFERENCE B112 MOTHERS 91 SF B113 TEST STOR/ QUIET SPACE 65 SF B114 SPEECH/HEARING 206 SF B115 OT/PT OFFICE B116 SOCIAL WORKER 235 SF B117 PSYCHOLOGIST 191 SF B118 INST COACH OFFICE 123 SF B119 CORRIDOR 343 SF 248 SF B121 WORKROOM 418 SF MEZZANINE B124 ELEC 53 SF 58 SF B125 RR B126 CALM 44 SF B127 STORAGE 100 SF B128 CORRIDOR 261 SF B129 PRINCIPAL'S OFFICE B130 SMALL CONFERENCE B131 ASST PRINCIPAL'S OFFICE 262 SF B132 E.C. SPEECH 174 SF 63 SF B133 RR B134 EXAM 84 SF B135 CLINIC B136 KINDER - CR 1 B137 STORAGE B138 TOILET 26 SF B139 SMALL GROUP 234 SF B140 KINDER - CR 2 1,321 SF B141 TOILET 24 SF 86 SF B142 STORAGE B143 KINDER - CR 3 1,329 SF B144 STORAGE 80 SF B146 KINDER - CR 4 B147 TOILET B148 STORAGE 80 SF 963 SF B149 EARLY CHILD - CR 5 B150 RESTROOM 110 SF B151 STORAGE 59 SF B152 EARLY CHILD - CR 6 1,161 SF B153 STORAGE B154 RESTROOM 90 SF

B155 SMALL GROUP

B201 MECH. MEZZ.

B156 MECH

EQUIPMENT GENERAL NOTES

ALL COUNTERTOPS TO HAVE CONTINUOUS 4" HIGH

LOOSE EQUIPMENT PACKAGE OR BY OWNER, NOT

CONSTRUCTION CONTRACTS). (TB) INDICATES 6' HIGH TACK BOARD; LENGTH AS INDICATED. REFER TO MOUNTING HEIGHT DRAWING. (MB) INDICATES <u>4' HIGH</u> MARKER BOARD; LENGTH AS INDICATED. REFER TO MOUNTING HEIGHT DRAWING. DIMENSIONED. REFER TO ELEVATIONS FOR HEIGHTS. WALL OR BETWEEN ANY UNIT AS REQUIRED. EXTEND ALL CASEWORK DOORS AND DRAWERS WILL NOT BE

LOCKABLE UNLESS NOTED OTHERWISE. ALL EXPOSED ENDS AND BACKS OF CASEWORK SHALL B FINISHED; ALL EXPOSED BOTTOMS OF CUBBY CABINETS SHALL BE FINISHED. CASEWORK INSTALLER SHALL CUT CASEWORK AS REQUIRED FOR PLUMBING/ELECTRICAL LINES. CASEWORK INSTALLER SHALL CAULK BETWEEN

ALL WALL-MOUNTED CASEWORK SHALL BE MOUNTED WITH THE TOP AT 7'-0" AFF UNLESS OTHERWISE NOTED; WC-01 IS MOUNTED WITH THE TOP AT 7'-3" AFF. (CG) INDICATES CORNER GUARD, REFER TO SPECIFICATIONS FOR ADDITIONAL DETAILS AND A7S.01 FOR COLOR SELECTIONS. (XFEC) INDICATES EXISTING FIRE EXTINGUISHER CABINET

EQUIPMENT NOTES

234 SF

149 SF

389 SF

SCHEDULE ON A7S.01

(ALL NOTES MAY NOT BE INDICATED ON THIS SHEET) 42"H DOUBLE-SIDED MOBILE UNITS (MBC-01), REFER TO DETAIL ON A7.06 AND MEDIA CENTER CASEWORK

- 42"H SINGLE-SIDED BOOKSHELVES (MC-2) WITH CONTINUOUS MATCHING PL-3 COUNTERTOP; REFER TO DETAIL 9/A7.07 60"H SINGLE-SIDED BOOKSHELVES (MC-4 OR 5, REFER TO ELEVATIONS) OPEN KNEESPACE BELOW COUNTERTOP, REFER TO DETAIL
- BUILT-IN WOOD SHELVING AND NOOK WITH UPHOLSTERED SEAT, REFER TO ELEVATION 3/A8.07 & DETAIL 10/A7.07 RECESSED CEILING-MOUNTED ELECTRIC PROJECTION SCREEN; B.O.D. IS DRAPER LUMA 2 NTSC FORMAT 150" DIAGONAL SCREEN
- DRAPER LUMA 2 NTSC FORMAT 10' DIAGONAL SCREEN WITH 6" EXTENSION MOUNTING BRACKET EXISTING EQUIPMENT TO REMAIN IN THIS ROOM SOLID SURFACE KNEE WALL CAP, SSM-2, REFER TO DETAIL

WALL-MOUNTED MANUAL PROJECTION SCREEN; B.O.D. IS

- RWS HOUSING TO BE RECESSED INTO CEILING, REFER TO DETAIL ON A7.06 MONITOR, BY OWNER 12 PL-1 CABINETRY WITH SSM-1 COUNTERTOP/BACKSPLASH 13 PL-1 CABINETRY WITH PL-2 COUNTERTOP
- 14 WALL-MOUNTED MANUAL PROJECTION SCREEN; B.O.D. IS DRAPER LUMA 2 NTSC FORMAT 150" DIAGONAL SCREEN EXISTING PROJECTION SCREEN AND PROJECTOR TO
- 16 ALL CASEWORK IN THIS ROOM TO BE PL-4 CABINETRY WITH SSM-3 COUNTERTOP/BACKSPLASH REFER TO FOOD SERVICE DRAWINGS FOR KITCHEN
- EQUIPMENT SCOPE AND INFORMATION INSTALL MOTORIZED HEIGHT ADJUSTER CONVERSION KIT ON EXISTING MANUAL BASKETBALL GOAL 19 A-8 & A-9: SLIDE-IN ELECTRIC RANGE WITH RECIRCULATING
- HOOD ABOVE; REFER TO APPLIANCE SCHEDULE ON A7S.01 20 EXISTING BLEACHERS TO REMAIN 21 EXISTING CLIMBING WALL AND PADDING TO REMAIN INSTALL NEW STAGE CURTAIN (SC-1) ON EXISTING TRACK
- INSTALL NEW TRAVELING BACK STAGE CURTAIN (SC-2) ON EXISTING TRACKS 24 A-6 & A-7: UNDER-COUNTER ICE MAKER WITH RO SYSTEM; HOUSE RO SYSTEM IN ADJACENT BASE CABINET; REFER TO APPLIANCE SCHEDULE ON A7S.01
- 25 A-1: REFRIGERATOR, REFER TO APPLIANCE SCHEDULE ON 26 A-3: MICROWAVE, REFER TO APPLIANCE SCHEDULE ON
- 27 A-5: ADA-COMPLIANT UNDER-COUNTER REFRIGERATOR, REFER TO APPLIANCE SCHEDULE ON A7S.01 28 A-4: UNDER-COUNTER REFRIGERATOR, REFER TO APPLIANCE SCHEDULE ON A7S.01
- 29 EXISTING DISPLAY CASE TO REMAIN, REFER TO FINISH PLANS FOR ADDITIONAL INFORMATION 30 PL-1 CABINETRY, REFER TO A7S.01 FOR CASEWORK
- 31 PL-1 PLASTIC LAMINATE CUBBIES (WC-01) WITH HOOKS MOUNTED BELOW; REFER TO TYPICAL ELEVATION 8/A7.09 AND DETAILS ON A7.07
- 32 9"H DIMENSIONAL LETTERS, REFER TO ELEVATIONS FOR 33 CUBICLE CURTAINS AND TRACK, REFER TO A7.06 FOR TRACK DETAIL
- 34 RECESSED CEILING-MOUNTED ELECTRIC PROJECTION SCREEN; B.O.D. IS DRAPER LUMA 2 NTSC FORMAT 10' DIAGONAL SCREEN - INCLUDE 30" DROP 35 EXISTING ROLLER WINDOW SHADES TO REMAIN
- 36 EXISTING SCOREBOARD TO REMAIN 37 A-2: REFRIGERATOR, REFER TO APPLIANCE SCHEDULE ON
- 38 VENDING MACHINE, BY OWNER 39 60"H SINGLE-SIDED BOOKSHELVES (MC-3) BUILT IN TO RECESS, REFER TO ELEVATIONS

SSM-3 COUNTERTOP/BACKSPLASH

40 ALL CASEWORK IN THIS ROOM TO BE PL-3 CABINETRY WITH

BACKSPLASHES AND ENDSPLASHES UNLESS NOTED OTHERWISE

HIDDEN LINES (----) INDICATE ITEMS TO BE PART OF

INCLUDED IN CONSTRUCTION CONTRACTS. DASHED LINES (---) INDICATE OVERHEAD ITEMS (INCLUDED IN

(TWS) INDICATES TACKABLE WALL SURFACE; LENGTH AS PROVIDE FILLER STRIPS BETWEEN CASEWORK UNITS AND COUNTER TO FACE OF WALL OR ADJACENT TALL CABINET.

COUNTERS, BACKSPLASHES, AND WALLS.

(FEC) INDICATES NEW FIRE EXTINGUISHER CABINET. (RWS) INDICATES ROLLER WINDOW SHADE. REFER TO A7S.01 LIST OF FINISHES FOR EQUIPMENT COLOR SELECTIONS; REFER TO A8S.01 FOR ALL SELECTIONS NOT NOTED ON THIS SHEET. INTERIOR PANEL SIGNAGE TO BE PROVIDED BY ALLOWANCE.

CARMEL CLAY SCHOOLS



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CHERRY TREE

ELEMENTARY

ADDITIONS AND


RENOVATIONS


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PROJECT MANAGER: SAM DRAWN BY: AML PROJECT NUMBER: 222011.00


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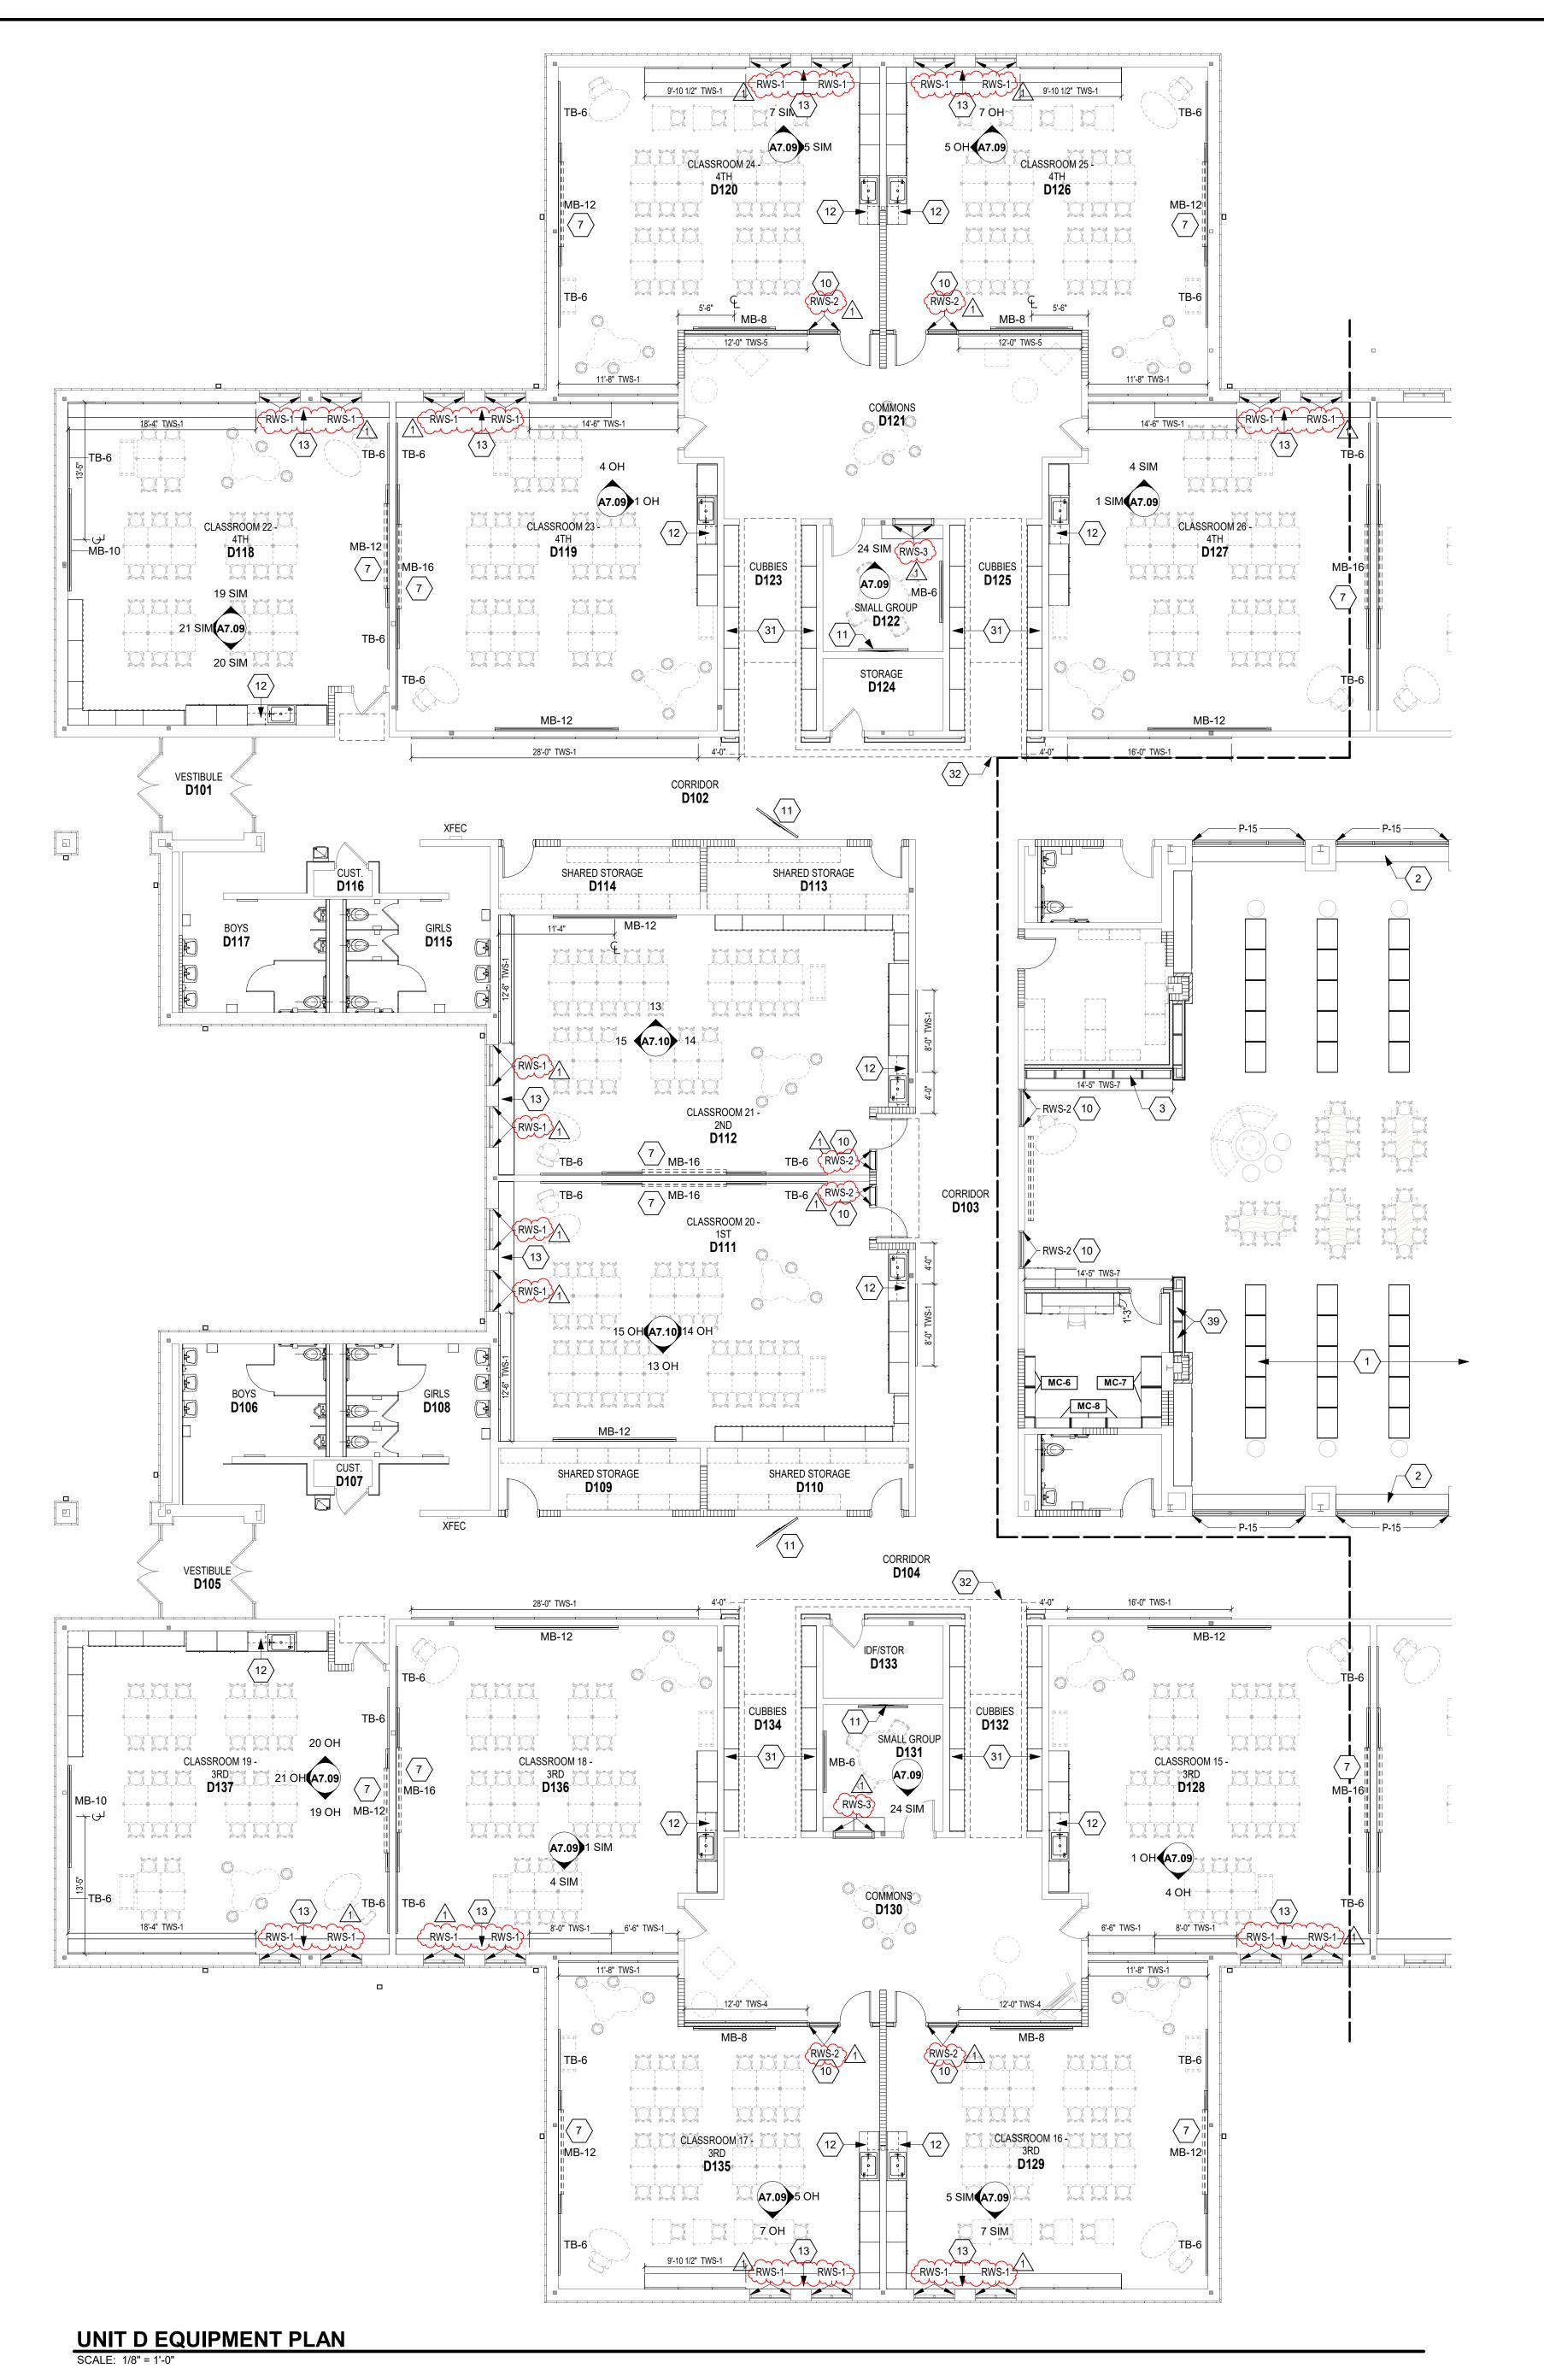
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NO.	DESCRIPTION	DATE
1	ADDENDUM #1	2.23.202

VERIFICATION NOTE

CONTRACTOR SHALL VERIFY ALL DIMENSIONS AND CLEARANCES AND ALL EXISTING FIELD CONDITIONS BEFORE STARTING CONSTRUCTION. COMMENCEMENT OF WORK CONSTITUTES ACCEPTANCE OF CONDITIONS. SHOULD DIFFERENT CONDITIONS BE ENCOUNTERED, CONTACT THE ARCHITECT BEFORE PROCEEDING WITH **UNIT B - FIRST FLOOR EQUIPMENT** PLAN

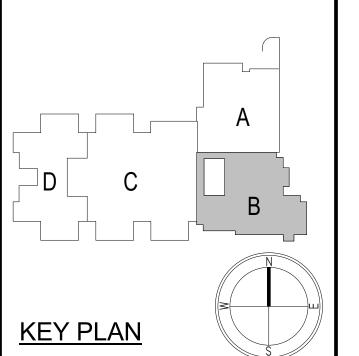

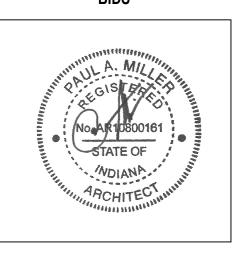

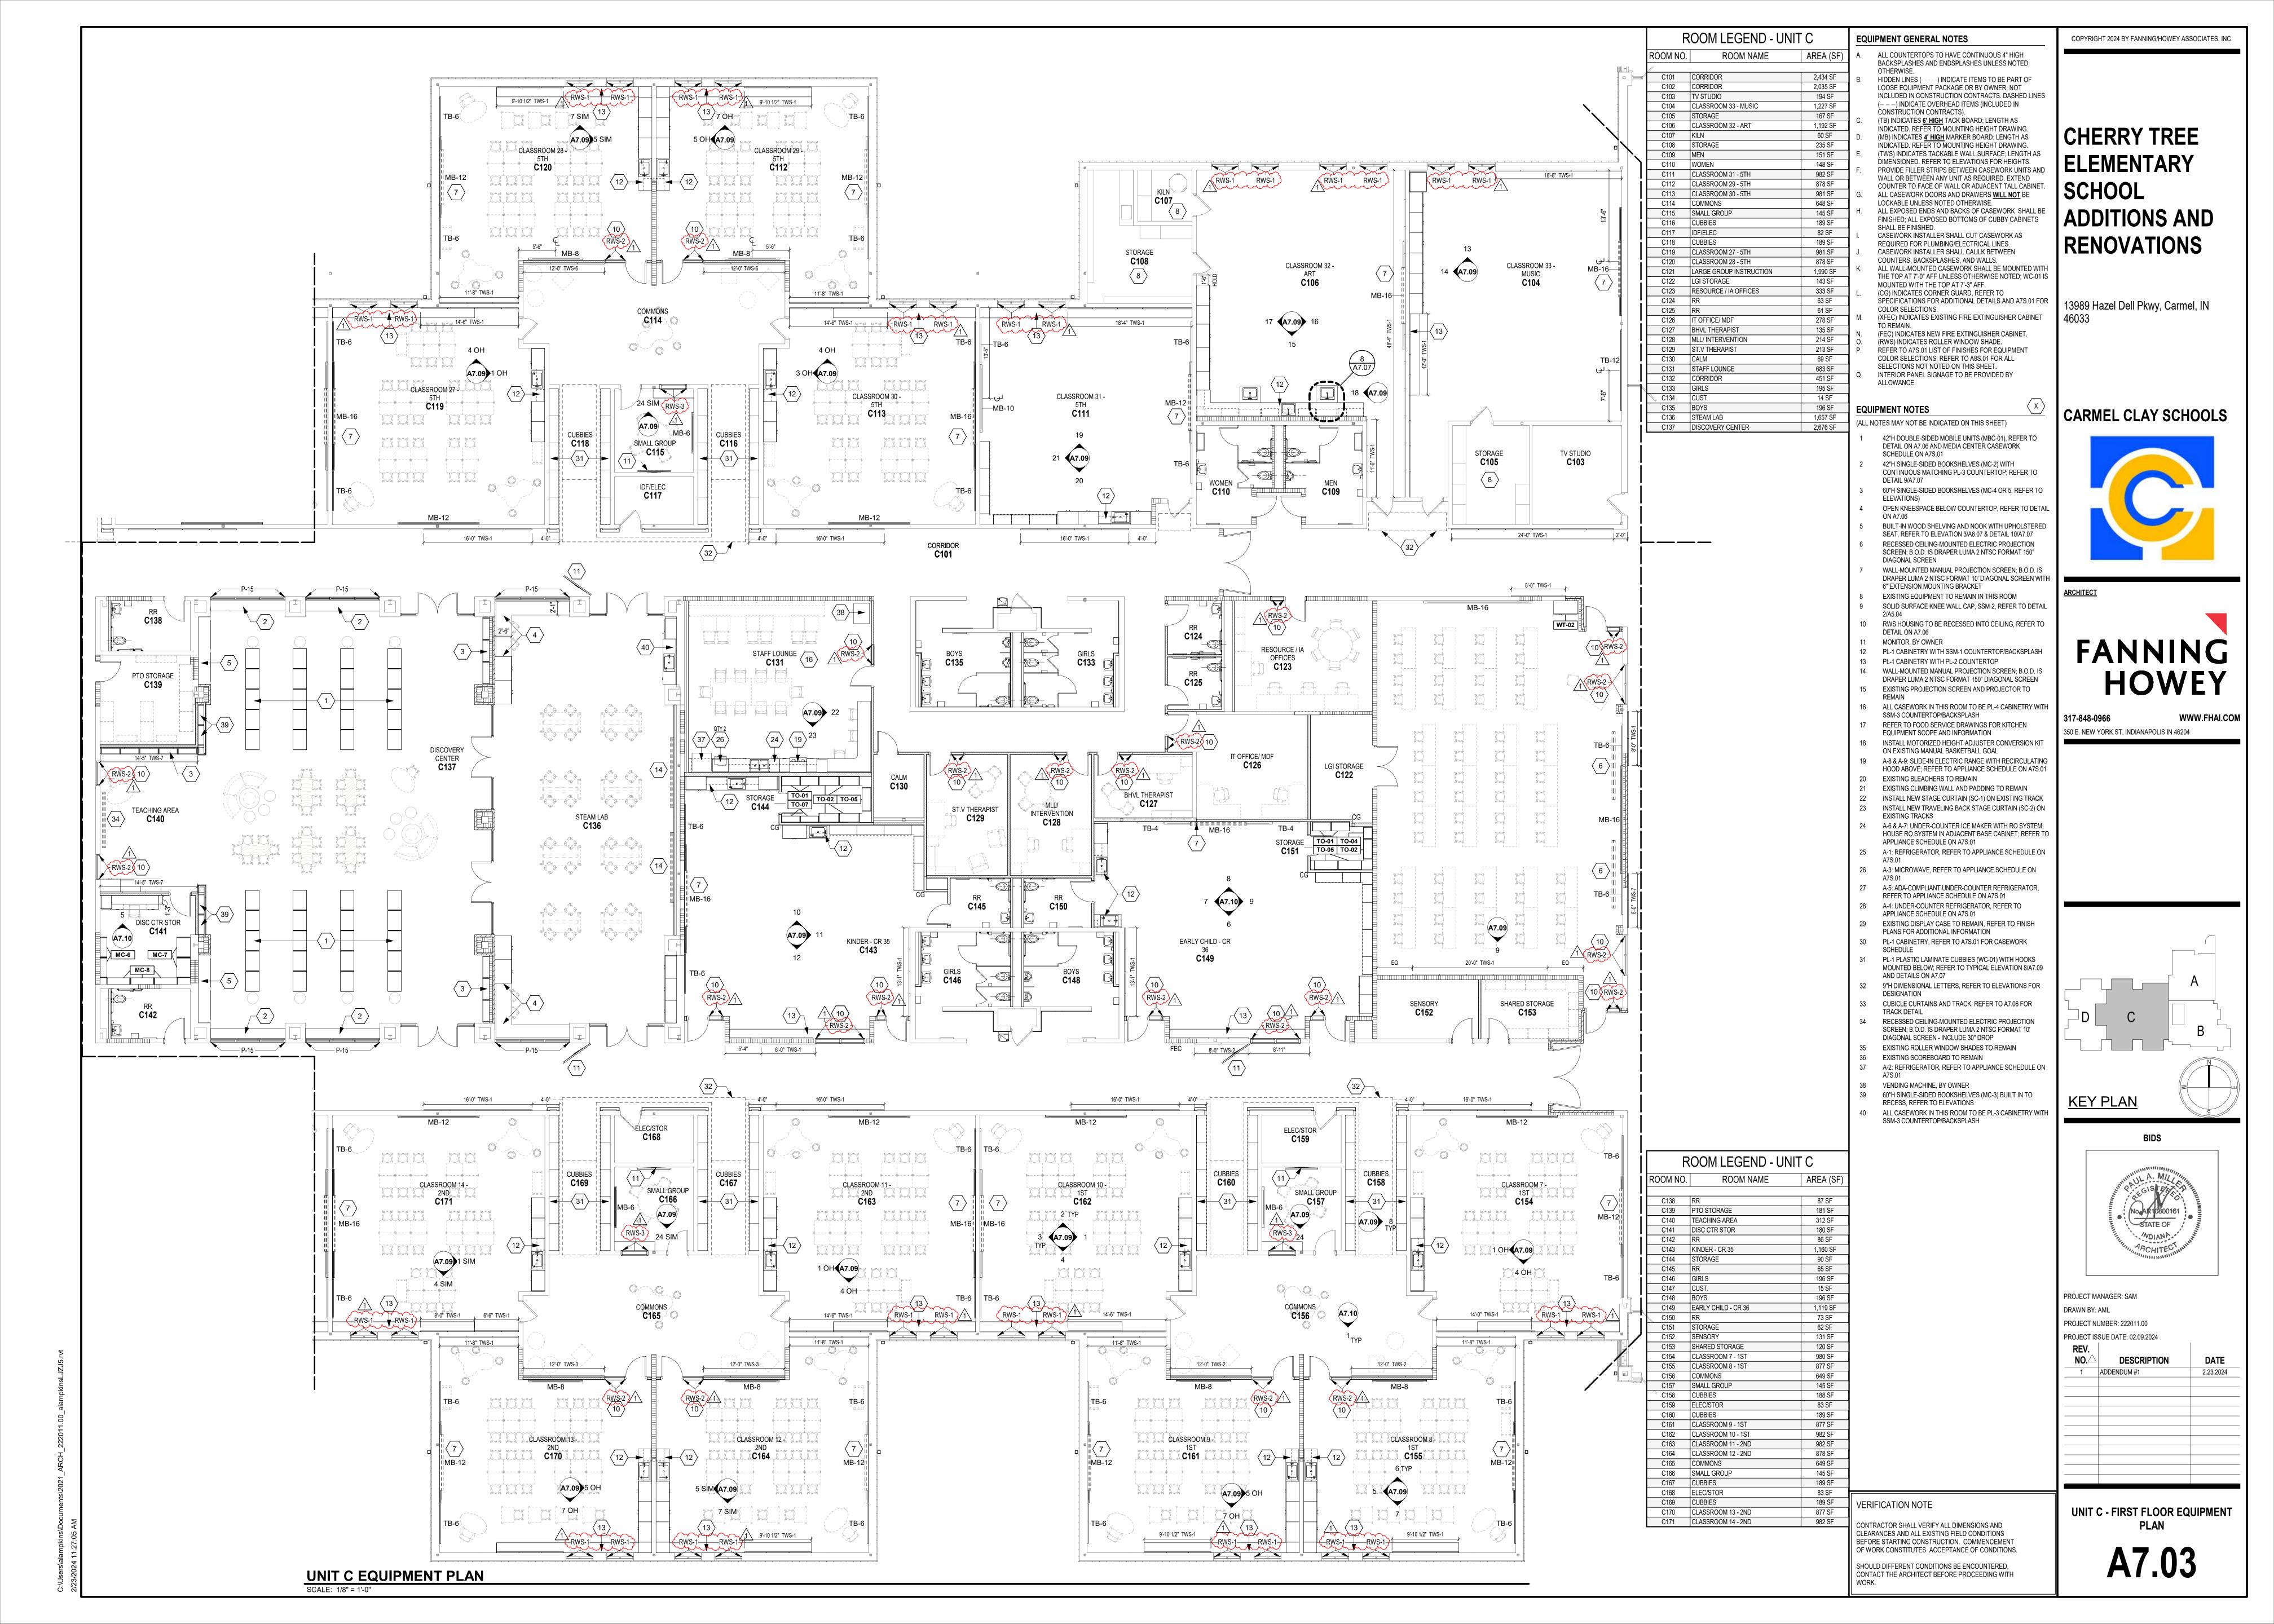ROOM LEGEND - UNIT D **ROOM NAME** AREA (SF) ROOM NO. D101 VESTIBULE
D102 CORRIDOR 86 SF 786 SF D103 CORRIDOR 708 SF D104 CORRIDOR 1,132 SF D105 VESTIBULE 87 SF 206 SF 15 SF D109 SHARED STORAGE 119 SF D110 SHARED STORAGE 119 SF CLASSROOM 20 - 1ST 989 SF CLASSROOM 21 - 2ND 989 SF 120 SF SHARED STORAGE 119 SF SHARED STORAGE 15 SF D117 BOYS D118 CLASSROOM 22 - 4TH 965 SF D119 CLASSROOM 23 - 4TH 981 SF 878 SF CLASSROOM 24 - 4TH COMMONS 648 SF 145 SF SMALL GROUP 189 SF 83 SF D124 STORAGE D125 CUBBIES 189 SF 878 SF D126 CLASSROOM 25 - 4TH CLASSROOM 26 - 4TH 981 SF CLASSROOM 15 - 3RD 982 SF CLASSROOM 16 - 3RD D130 COMMONS D131 SMALL GROUP 145 SF D132 CUBBIES 189 SF D133 IDF/STOR 83 SF D134 CUBBIES 189 SF

D135 CLASSROOM 17 - 3RD

D137 CLASSROOM 19 - 3RD

CLASSROOM 18 - 3RD

EQUIPMENT GENERAL NOTES

- ALL COUNTERTOPS TO HAVE CONTINUOUS 4" HIGH
 - HIDDEN LINES (----) INDICATE ITEMS TO BE PART OF LOOSE EQUIPMENT PACKAGE OR BY OWNER, NOT
 - INDICATED. REFER TO MOUNTING HEIGHT DRAWING.
 - DIMENSIONED. REFER TO ELEVATIONS FOR HEIGHTS. PROVIDE FILLER STRIPS BETWEEN CASEWORK UNITS AND WALL OR BETWEEN ANY UNIT AS REQUIRED. EXTEND
 - FINISHED; ALL EXPOSED BOTTOMS OF CUBBY CABINETS SHALL BE FINISHED. CASEWORK INSTALLER SHALL CUT CASEWORK AS REQUIRED FOR PLUMBING/ELECTRICAL LINES. CASEWORK INSTALLER SHALL CAULK BETWEEN
 - ALL WALL-MOUNTED CASEWORK SHALL BE MOUNTED WITH THE TOP AT 7'-0" AFF UNLESS OTHERWISE NOTED; WC-01 IS MOUNTED WITH THE TOP AT 7'-3" AFF. (CG) INDICATES CORNER GUARD, REFER TO SPECIFICATIONS FOR ADDITIONAL DETAILS AND A7S.01 FOR
 - COLOR SELECTIONS. (XFEC) INDICATES EXISTING FIRE EXTINGUISHER CABINET (FEC) INDICATES NEW FIRE EXTINGUISHER CABINET.
 - SELECTIONS NOT NOTED ON THIS SHEET. INTERIOR PANEL SIGNAGE TO BE PROVIDED BY

(ALL NOTES MAY NOT BE INDICATED ON THIS SHEET) 42"H DOUBLE-SIDED MOBILE UNITS (MBC-01), REFER TO DETAIL ON A7.06 AND MEDIA CENTER CASEWORK

SCHEDULE ON A7S.01

42"H SINGLE-SIDED BOOKSHELVES (MC-2) WITH DETAIL 9/A7.07

OPEN KNEESPACE BELOW COUNTERTOP, REFER TO DETAIL

DIAGONAL SCREEN WALL-MOUNTED MANUAL PROJECTION SCREEN; B.O.D. IS 6" EXTENSION MOUNTING BRACKET

SOLID SURFACE KNEE WALL CAP, SSM-2, REFER TO DETAIL

12 PL-1 CABINETRY WITH SSM-1 COUNTERTOP/BACKSPLASH 13 PL-1 CABINETRY WITH PL-2 COUNTERTOP 14 WALL-MOUNTED MANUAL PROJECTION SCREEN; B.O.D. IS DRAPER LUMA 2 NTSC FORMAT 150" DIAGONAL SCREEN

16 ALL CASEWORK IN THIS ROOM TO BE PL-4 CABINETRY WITH SSM-3 COUNTERTOP/BACKSPLASH

REFER TO FOOD SERVICE DRAWINGS FOR KITCHEN

18 INSTALL MOTORIZED HEIGHT ADJUSTER CONVERSION KIT ON EXISTING MANUAL BASKETBALL GOAL A-8 & A-9: SLIDE-IN ELECTRIC RANGE WITH RECIRCULATING

EXISTING BLEACHERS TO REMAIN EXISTING CLIMBING WALL AND PADDING TO REMAIN

A-6 & A-7: UNDER-COUNTER ICE MAKER WITH RO SYSTEM; HOUSE RO SYSTEM IN ADJACENT BASE CABINET; REFER TO APPLIANCE SCHEDULE ON A7S.01

27 A-5: ADA-COMPLIANT UNDER-COUNTER REFRIGERATOR, REFER TO APPLIANCE SCHEDULE ON A7S.01

29 EXISTING DISPLAY CASE TO REMAIN, REFER TO FINISH PLANS FOR ADDITIONAL INFORMATION 30 PL-1 CABINETRY, REFER TO A7S.01 FOR CASEWORK

AND DETAILS ON A7.07

TRACK DETAIL 34 RECESSED CEILING-MOUNTED ELECTRIC PROJECTION SCREEN; B.O.D. IS DRAPER LUMA 2 NTSC FORMAT 10' DIAGONAL SCREEN - INCLUDE 30" DROP

36 EXISTING SCOREBOARD TO REMAIN 37 A-2: REFRIGERATOR, REFER TO APPLIANCE SCHEDULE ON

40 ALL CASEWORK IN THIS ROOM TO BE PL-3 CABINETRY WITH

39 60"H SINGLE-SIDED BOOKSHELVES (MC-3) BUILT IN TO RECESS, REFER TO ELEVATIONS

SSM-3 COUNTERTOP/BACKSPLASH

- BACKSPLASHES AND ENDSPLASHES UNLESS NOTED
- INCLUDED IN CONSTRUCTION CONTRACTS. DASHED LINES (---) INDICATE OVERHEAD ITEMS (INCLUDED IN CONSTRUCTION CONTRACTS). (TB) INDICATES 6' HIGH TACK BOARD; LENGTH AS
- (MB) INDICATES <u>4' HIGH</u> MARKER BOARD; LENGTH AS INDICATED. REFER TO MOUNTING HEIGHT DRAWING. (TWS) INDICATES TACKABLE WALL SURFACE; LENGTH AS
- COUNTER TO FACE OF WALL OR ADJACENT TALL CABINET ALL CASEWORK DOORS AND DRAWERS WILL NOT BE LOCKABLE UNLESS NOTED OTHERWISE. ALL EXPOSED ENDS AND BACKS OF CASEWORK SHALL B
- COUNTERS, BACKSPLASHES, AND WALLS.
- (RWS) INDICATES ROLLER WINDOW SHADE. REFER TO A7S.01 LIST OF FINISHES FOR EQUIPMENT COLOR SELECTIONS; REFER TO A8S.01 FOR ALL
- ALLOWANCE.

EQUIPMENT NOTES

877 SF

CONTINUOUS MATCHING PL-3 COUNTERTOP; REFER TO 60"H SINGLE-SIDED BOOKSHELVES (MC-4 OR 5, REFER TO

BUILT-IN WOOD SHELVING AND NOOK WITH UPHOLSTERED SEAT, REFER TO ELEVATION 3/A8.07 & DETAIL 10/A7.07 RECESSED CEILING-MOUNTED ELECTRIC PROJECTION SCREEN; B.O.D. IS DRAPER LUMA 2 NTSC FORMAT 150"

DRAPER LUMA 2 NTSC FORMAT 10' DIAGONAL SCREEN WITH EXISTING EQUIPMENT TO REMAIN IN THIS ROOM

RWS HOUSING TO BE RECESSED INTO CEILING, REFER TO DETAIL ON A7.06 MONITOR, BY OWNER

15 EXISTING PROJECTION SCREEN AND PROJECTOR TO

EQUIPMENT SCOPE AND INFORMATION

HOOD ABOVE; REFER TO APPLIANCE SCHEDULE ON A7S.01

22 INSTALL NEW STAGE CURTAIN (SC-1) ON EXISTING TRACK 23 INSTALL NEW TRAVELING BACK STAGE CURTAIN (SC-2) ON EXISTING TRACKS

25 A-1: REFRIGERATOR, REFER TO APPLIANCE SCHEDULE ON

26 A-3: MICROWAVE, REFER TO APPLIANCE SCHEDULE ON

28 A-4: UNDER-COUNTER REFRIGERATOR, REFER TO APPLIANCE SCHEDULE ON A7S.01

31 PL-1 PLASTIC LAMINATE CUBBIES (WC-01) WITH HOOKS MOUNTED BELOW; REFER TO TYPICAL ELEVATION 8/A7.09

32 9"H DIMENSIONAL LETTERS, REFER TO ELEVATIONS FOR DESIGNATION 33 CUBICLE CURTAINS AND TRACK, REFER TO A7.06 FOR

35 EXISTING ROLLER WINDOW SHADES TO REMAIN

38 VENDING MACHINE, BY OWNER

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CHERRY TREE ELEMENTARY SCHOOL **ADDITIONS AND** RENOVATIONS


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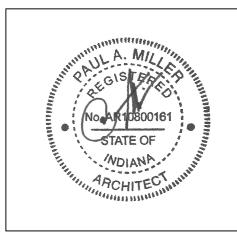
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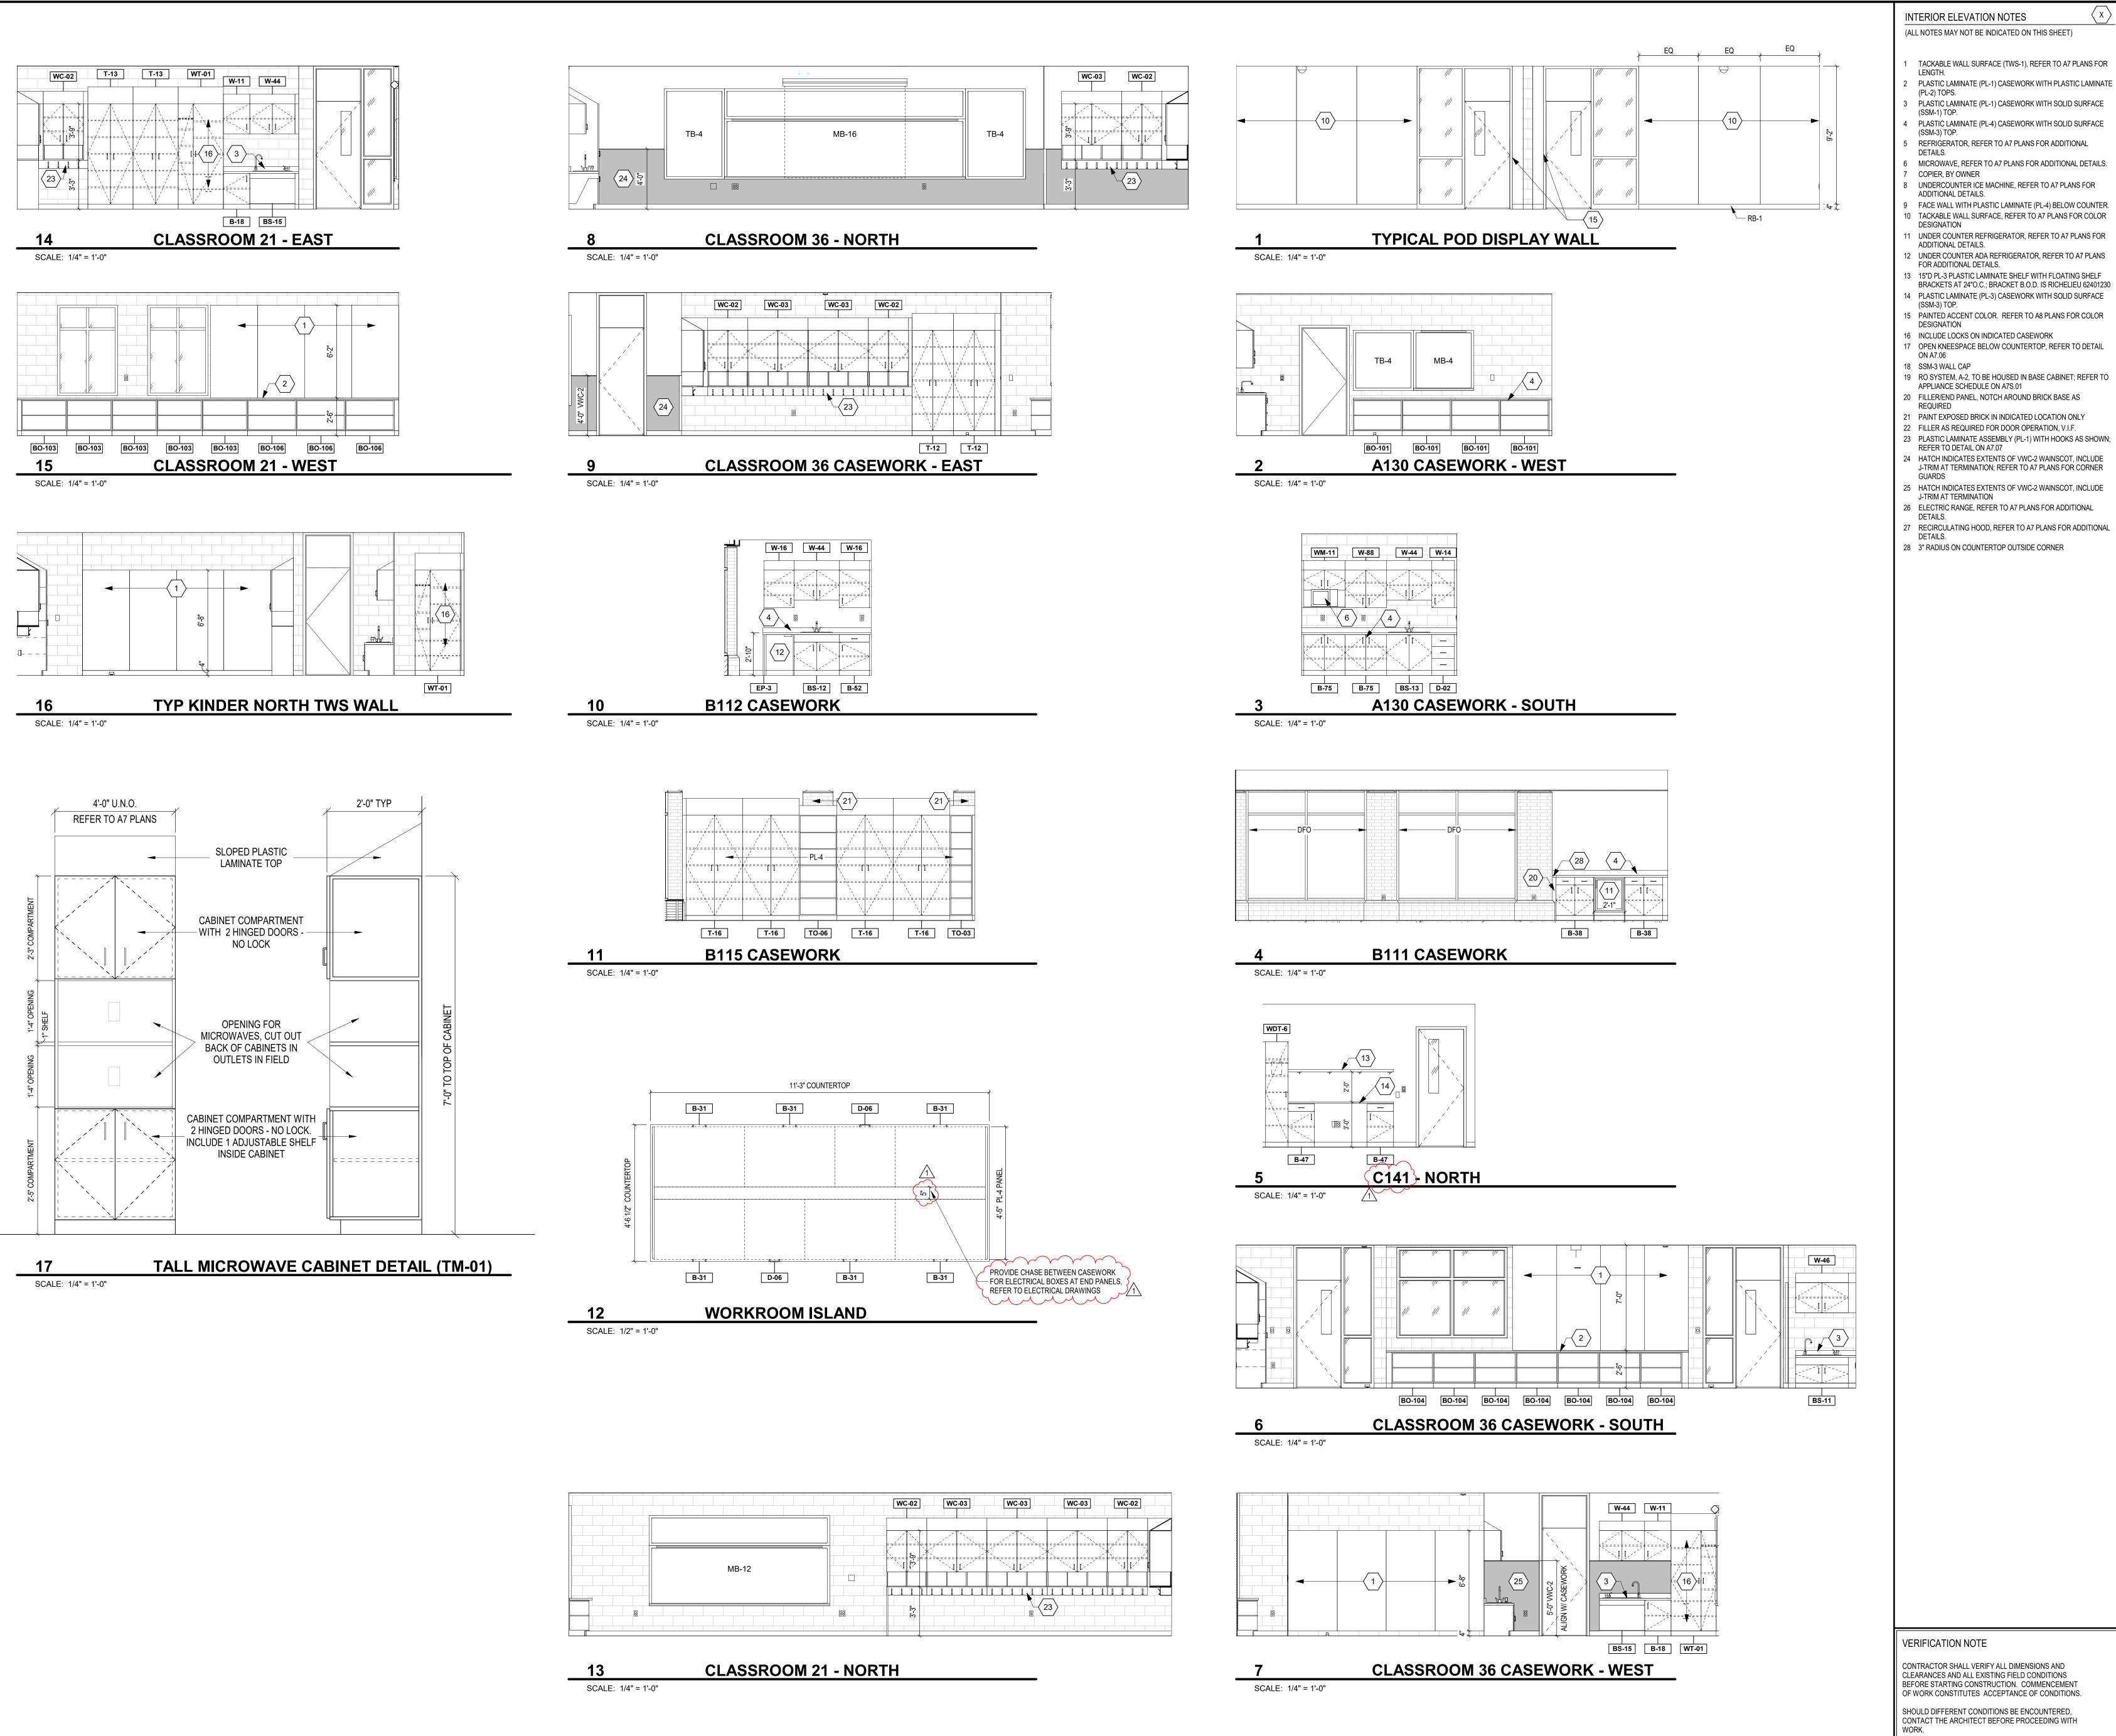
PROJECT MANAGER: SAM DRAWN BY: AML PROJECT NUMBER: 222011.00

PROJECT ISSUE DATE: 02.09.2024

REV. NO.△	DESCRIPTION	DATE
1	ADDENDUM #1	2.23.202

VERIFICATION NOTE

CONTRACTOR SHALL VERIFY ALL DIMENSIONS AND CLEARANCES AND ALL EXISTING FIELD CONDITIONS BEFORE STARTING CONSTRUCTION. COMMENCEMENT OF WORK CONSTITUTES ACCEPTANCE OF CONDITIONS. SHOULD DIFFERENT CONDITIONS BE ENCOUNTERED, CONTACT THE ARCHITECT BEFORE PROCEEDING WITH **UNIT D - FIRST FLOOR EQUIPMENT** PLAN

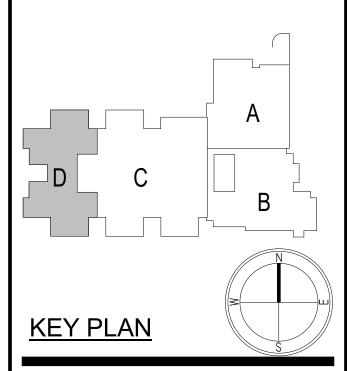

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TACKABLE WALL SURFACE (TWS-1), REFER TO A7 PLANS FOR

REFRIGERATOR, REFER TO A7 PLANS FOR ADDITIONAL

UNDER COUNTER REFRIGERATOR, REFER TO A7 PLANS FOR

2 UNDER COUNTER ADA REFRIGERATOR, REFER TO A7 PLANS

BRACKETS AT 24"O.C.; BRACKET B.O.D. IS RICHELIEU 62401230

ADDITIONAL DETAILS.

ADDITIONAL DETAILS.

FOR ADDITIONAL DETAILS.

APPLIANCE SCHEDULE ON A7S.01

REFER TO DETAIL ON A7.07

J-TRIM AT TERMINATION

DESIGNATION

DESIGNATION

CHERRY TREE **ELEMENTARY** SCHOOL **ADDITIONS AND** RENOVATIONS

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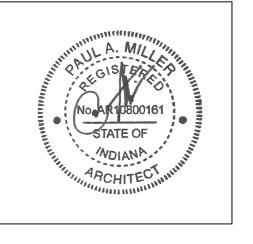
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ARCHITECT



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PROJECT MANAGER: SAM DRAWN BY: AML PROJECT NUMBER: 222011.00

PROJECT ISSUE DATE: 02.09.2024

REV.

DESCRIPTION DATE 2.23.2024 1 ADDENDUM #1

VERIFICATION NOTE

CONTRACTOR SHALL VERIFY ALL DIMENSIONS AND CLEARANCES AND ALL EXISTING FIELD CONDITIONS BEFORE STARTING CONSTRUCTION. COMMENCEMENT OF WORK CONSTITUTES ACCEPTANCE OF CONDITIONS. SHOULD DIFFERENT CONDITIONS BE ENCOUNTERED, CONTACT THE ARCHITECT BEFORE PROCEEDING WITH

CASEWORK & EQUIPMENT ELEVATIONS

RESIDENTIAL EQUIPMENT SCHEDULE

RESIDENTIAL EQUIPMENT SCHEDULE							
ITEM NO.	ITEM DESCRIPTION	ELEC. FIELD CONNECTION	MECH. FIELD CONNECTION				
A-1)	REFRIGERATOR WITH TOP FREEZER 18.3 CU.FT. REVERSIBLE HINGES DOES NOT INCLUDE ICE MAKER ADA-COMPLIANT AND ENERGY STAR CERTIFIED BASIS OF DESIGN IS FRIGIDAIRE FFHT1835VS 66.375"H x 30"W x 30.375"D COLOR: STAINLESS STEEL	15AMPS					
(A-2)	REFRIGERATOR WITH BOTTOM FREEZER 28.8 CU.FT. DOUBLE DOOR FRIDGE INCLUDES ICE MAKER ENERGY STAR CERTIFIED BASIS OF DESIGN IS FRIGIDAIRE FRFN2823AS 70"H x 36"W x 35.75"D COLOR: STAINLESS STEEL	15AMPS	X				
(A-3)	MICROWAVE • 2.0 CU.FT. • EXTRA-LARGE TURNTABLE • ELECTRONIC DIGITAL DISPLAY WITH CLOCK • ENERGY STAR QUALIFIED • BASIS OF DESIGN IS GE JES2051SNSS • 24.125"W x 13.625"H X 19.25"D • COLOR: STAINLESS STEEL	1200W					
(A-4)	UNDER-COUNTER REFRIGERATOR - STANDARD HEIGHT • 5.6 CU.FT. • SMALL FREEZER AREA • REVERSIBLE HINGES • ENERGY STAR QUALIFIED • BASIS OF DESIGN IS GE GCE06GSHSB • 34.125"H x 23.625"W x 23.75"D • COLOR: STAINLESS STEEL						
(A-5)	UNDER-COUNTER REFRIGERATOR - ADA HEIGHT 1. 3.87 CU.FT. 1. REVERSIBLE HINGES 1. INCLUDES VISIBLE TEMPERATURE GAUGE 1. ENERGY STAR QUALIFIED 1. BASIS OF DESIGN IS HOSHIZAKI HR24C 1. 31.5"H x 23.375"W x 26.5"D (INCLUDING HANDLE) 1. COLOR: STAINLESS STEEL	115V/60/1					
(A-6)	UNDER-COUNTER ICE MAKER - ADA HEIGHT • 55LB MAX ICE PRODUCTION PER 24 HOURS • INCLUDES 22LB STORAGE CAPACITY • AIR-COOLED ADA-COMPLIANT ICE MAKER • INCLUDE DOOR REVERSAL PART • BASIS OF DESIGN IS HOSHIZAKI AM-50BAJ-AD • 31.5"H x 14.875"W x 22.625"D • COLOR: STAINLESS STEEL	115V/60/1	X				
(A-7)	REVERSE OSMOSIS SYSTEM FOR ICE MAKER INTEGRATED NON-ELECTRIC PUMP FILTERS WATER TO AID IN ICE MAKER OPERATION QUICK CHANGE CARTRIDGE SYSTEM BASIS OF DESIGN IS 3M WATER FILTRATION PRODUCT SGLP-RO OVERALL SIZE: 15.375"H x 9.375"W x 12.25"D COLOR: STAINLESS STEEL		X				
(A-8)	SLIDE-IN ELECTRIC RANGE 5.3CU FT SELF-CLEANING SLIDE IN ELECTRIC RANGE FOUR GLASS-TOP ELECTRIC BURNERS ADA-COMPLIANT KNOBS AT FRONT OF COOKTOP BOTTOM STORAGE DRAWER BASIS OF DESIGN IS GE JS645SLSS 36"H x 29.875"W x 25.875"D COLOR: STAINLESS STEEL	208V OR 240V 40AMPS					
(A-9)	RECIRCULATING HOOD UNDER-CABINET, RECIRCULATING DUCTLESS HOOD ADA-COMPLIANT CONTROLS BASIS OF DESIGN IS BROAN BXT130SS OVERALL SIZE: 6"H x 29.875"W x 18"D COLOR: STAINLESS STEEL	120V/60Hz					

	CASEWORK SCHEDULE					
TYPE	NO.	W	SIZE H		DESCRIPTION	
B B	10 15	1'-6" 2'-9"	2'-0" 2'-6"	2'-6" 2'-10"	BASE UNIT WITH ONE ADJUSTABLE SHELF AND ONE HINGED DOOR. BASE UNIT WITH TWO DRAWERS, ONE ADJUSTABLE SHELF AND TWO HINGED DOORS.	
В	18	1'-9"	2'-0"	2'-6"	BASE UNIT WITH ONE ADJUSTABLE SHELF AND ONE HINGED DOOR.	
B B	23 26	2'-6" 2'-0"	2'-0" 2'-0"	2'-10" 2'-6"	BASE UNIT WITH TWO DRAWERS, ONE ADJUSTABLE SHELF AND TWO HINGED DOORS. BASE UNIT WITH ONE ADJUSTABLE SHELF AND ONE HINGED DOOR.	
В	27	2'-0"	2'-0"	2'-10"	BASE UNIT WITH TWO ADJUSTABLE SHELVES AND ONE HINGED DOOR.	
B B	31 34	3'-0" 1'-3"	2'-0" 2'-0"	2'-10" 2'-10"	BASE UNIT WITH TWO ADJUSTABLE SHELVES AND TWO HINGED DOORS. BASE UNIT WITH ONE DRAWER, ONE ADJUSTABLE SHELF AND ONE HINGED DOOR.	
В	38	2'-6"	2'-0"	3'-0"	BASE UNIT WITH TWO DRAWERS, ONE ADJUSTABLE SHELF AND TWO HINGED DOORS.	
В	40	1'-6"	2'-0"	2'-10"	BASE UNIT WITH ONE DRAWER, ONE ADJUSTABLE SHELF AND ONE HINGED DOOR.	
B B	41 46	1'-6" 1'-9"	2'-0" 2'-0"	3'-0" 2'-10"	BASE UNIT WITH ONE DRAWER, ONE ADJUSTABLE SHELF AND ONE HINGED DOOR. BASE UNIT WITH ONE DRAWER, ONE ADJUSTABLE SHELF AND ONE HINGED DOOR.	
В	47	1'-9"	2'-0"	3'-0"	BASE UNIT WITH ONE DRAWER, ONE ADJUSTABLE SHELF AND ONE HINGED DOOR.	
B B	52 55	2'-0" 2'-6"	2'-0" 2'-0"	2'-10" 2'-10"	BASE UNIT WITH ONE DRAWER, ONE ADJUSTABLE SHELF AND ONE HINGED DOOR. BASE UNIT WITH TWO DRAWERS AND TWO HINGED DOORS. DO NOT INCLUDE SHELVES.	
В	63	3'-0"	2'-0"	2'-10"	BASE UNIT WITH TWO DRAWERS, ONE ADJUSTABLE SHELF AND TWO HINGED DOORS.	
B B	67 74	2'-6" 2'-9"	2'-0" 2'-0"	2'-10" 2'-6"	BASE UNIT WITH TWO ADJUSTABLE SHELVES AND TWO HINGED DOORS. BASE UNIT WITH ONE ADJUSTABLE SHELF AND TWO HINGED DOORS.	
В	75	2'-9"	2'-0"	2'-10"	BASE UNIT WITH ONE ADJUSTABLE SHELF AND TWO HINGED DOORS. BASE UNIT WITH ONE ADJUSTABLE SHELF AND TWO HINGED DOORS.	
В	77	2'-6"	2'-0"	2'-6"	BASE UNIT WITH ONE ADJUSTABLE SHELF AND TWO HINGED DOORS.	
B B	80 82	3'-0" 3'-0"	2'-0" 2'-0"	2'-6" 2'-6"	BASE UNIT WITH ONE ADJUSTABLE SHELF AND TWO HINGED DOORS. INCLUDE CUTOUT FOR TECH/ELEC, COORDINATE IN FIELD BASE UNIT WITH ONE ADJUSTABLE SHELF AND TWO HINGED DOORS.	
ВО	101	3'-3"	1'-1"	2'-6"	OPEN BASE UNIT WITH ONE ADJUSTABLE SHELF.	
BO BO	102 103	3'-0" 3'-0"	1'-11" 1'-5"	2'-6" 2'-6"	OPEN BASE UNIT WITH ONE ADJUSTABLE SHELF. OPEN BASE UNIT WITH ONE ADJUSTABLE SHELF.	
ВО	103	2'-9"	1'-5"	2'-6"	OPEN BASE UNIT WITH ONE ADJUSTABLE SHELF. OPEN BASE UNIT WITH ONE ADJUSTABLE SHELF.	
ВО	105	3'-6"	1'-5"	2'-6"	OPEN BASE UNIT WITH ONE VERTICAL DIVIDER AND TWO ADJUSTABLE SHELVES.	
BO BS	106 10	3'-3" 3'-0"	1'-5" 2'-0"	2'-6" 2'-6"	OPEN BASE UNIT WITH ONE ADJUSTABLE SHELF. SINK BASE UNIT WITH TWO HINGED DOORS.	
BS	11	3'-6"	2'-0"	2'-2"	SINK BASE UNIT WITH TWO HINGED DOORS AND ONE BLANK DRAWER PANEL.	
BS	12	3'-0" 3'-0"	2'-0" 2'-0"	2'-10"	SINK BASE UNIT WITH TWO HINGED DOORS AND ONE BLANK DRAWER PANEL.	
BS BS	13 14	3'-0"	2'-6"	2'-10" 2'-6"	SINK BASE UNIT WITH TWO HINGED DOORS. SINK BASE UNIT WITH TWO HINGED DOORS AND ONE BLANK DRAWER PANEL.	
BS	15	3'-0"	2'-0"	2'-0"	CHILD ADA SINK BASE UNIT WITH A REMOVABLE ACCESS PANEL.	
BS D	16 01	3'-0" 2'-6"	2'-0" 2'-0"	2'-0" 2'-10"	ADULT ADA SINK BASE UNIT WITH A REMOVABLE ACCESS PANEL. DRAWER UNIT WITH THREE EQUAL DRAWERS. 6-1/2 INCHES DEEP INSIDE.	
D	02	1'-6"	2'-0"	2'-10"	DRAWER UNIT WITH THREE EQUAL DRAWERS. 6-1/2 INCHES DEEP INSIDE.	
D	03 04	1'-9" 3'-0"	2'-0"	2'-6"	DRAWER UNIT WITH THREE EQUAL DRAWERS. 5-1/2 INCHES DEEP INSIDE.	
D D	05	1'-6"	2'-0" 2'-0"	2'-10" 3'-0"	DRAWER UNIT WITH THREE EQUAL DRAWERS. 6-1/2 INCHES DEEP INSIDE. DRAWER UNIT WITH THREE EQUAL DRAWERS. 7-1/2 INCHES DEEP INSIDE.	
D	06	2'-0"	2'-0"	2'-10"	DRAWER UNIT WITH FOUR EQUAL DRAWERS. 4-1/2 INCHES DEEP INSIDE.	
D EP	07 1	2'-6" 3/4"	2'-0" 1'-5"	2'-10" 2'-9"	DRAWER UNIT WITH FOUR EQUAL DRAWERS. 4-1/2 INCHES DEEP INSIDE. 3/4" THICK END PANEL TO COVER DISTANCE FROM FLOOR TO BOTTOM OF CUBBY CABINET	
EP	2	3/4"	2'-0"	7'-0"	3/4" THICK END PANEL TO COVER SIDES OF REFRIGERATOR	
EP ED	3	3/4"	2'-0"	2'-10"	3/4" THICK END PANEL TO COVER DISTANCE FROM FLOOR TO BOTTOM OF COUNTERTOP	
EP FX	4 01	3/4" 3'-0"	2'-0" 1'-0 3/4"	3'-0" 2'-6"	3/4" THICK END PANEL TO COVER DISTANCE FROM FLOOR TO BOTTOM OF COUNTERTOP MAILBOX UNIT WITH 33 OPENINGS, REFER TO DETAIL ON A7.06	
Т	10	1'-6"	2'-0"	7'-0"	TALL UNIT WITH FIVE ADJUSTABLE SHELVES AND ONE HINGED DOOR. INCLUDE SLOPED TOP.	
T	11 12	2'-6" 2'-9"	2'-0" 2'-0"	7'-0" 7'-0"	TALL UNIT WITH FIVE ADJUSTABLE SHELVES AND TWO HINGED DOORS. INCLUDE SLOPED TOP. TALL UNIT WITH FIVE ADJUSTABLE SHELVES, TWO HINGED DOORS, AND SLOPED TOP.	
T	13	3'-0"	2'-0"	7'-0"	TALL UNIT WITH FIVE ADJUSTABLE SHELVES, TWO HINGED DOORS, AND SLOPED TOP.	
T	14 15	3'-6" 3'-0"	2'-0" 2'-6"	7'-0" 7'-0"	TALL UNIT WITH FIVE ADJUSTABLE SHELVES AND TWO HINGED DOORS. INCLUDE SLOPED TOP. TALL UNIT WITH FIVE ADJUSTABLE SHELVES AND TWO HINGED DOORS. INCLUDE SLOPED TOP.	
T	16	3'-9"	2'-0"	7'-0"	TALL UNIT WITH FIVE ADJUSTABLE SHELVES AND TWO HINGED DOORS. INCLUDE SLOPED TOP. TALL UNIT WITH FIVE ADJUSTABLE SHELVES AND TWO HINGED DOORS. INCLUDE SLOPED TOP.	
Т	17	2'-6"	2'-0"	7'-0"	TALL SPLIT DOOR STORAGE WITH ONE FIXED SHELF. AT THE UPPER CABINET, PROVIDE THREE ADJUSTABLE SHELVES AND TWO HINGED DOORS. AT THE LOWER CABINET, PROVIDE ONE ADJUSTABLE SHELF AND TWO HINGED DOORS.	
T	18	3'-3"	2'-6"	7'-0"	TALL UNIT WITH FIVE ADJUSTABLE SHELVES AND TWO HINGED DOORS. INCLUDE SLOPED TOP.	
T	19	3'-3"	1'-9"	7'-0"	TALL UNIT WITH FIVE ADJUSTABLE SHELVES AND TWO HINGED DOORS. INCLUDE SLOPED TOP.	
TO TO	01 02	2'-9" 3'-0"	1'-5" 1'-5"	7'-0" 7'-0"	OPEN TALL UNIT WITH FIVE ADJUSTABLE SHELVES. INCLUDE SLOPED TOP. OPEN TALL UNIT WITH FIVE ADJUSTABLE SHELVES. INCLUDE SLOPED TOP.	
TO	03	1'-6"	1'-2"	7'-0"	OPEN TALL UNIT WITH FIVE ADJUSTABLE SHELVES. INCLUDE SLOPED TOP.	
TO TO	04 05	1'-9" 3'-6"	1'-5" 1'-5"	7'-0" 7'-0"	OPEN TALL UNIT WITH FIVE ADJUSTABLE SHELVES. INCLUDE SLOPED TOP. OPEN TALL UNIT WITH FIVE ADJUSTABLE SHELVES, INCLUDE SLOPED TOP.	
TO	06	2'-6"	1'-2"	7'-0"	OPEN TALL UNIT WITH FIVE ADJUSTABLE SHELVES, INCLUDE SLOPED TOP. OPEN TALL UNIT WITH FIVE ADJUSTABLE SHELVES. INCLUDE SLOPED TOP.	
TO	07	2'-9"	1'-0"	7'-0"	OPEN TALL UNIT WITH FIVE ADJUSTABLE SHELVES. INCLUDE SLOPED TOP.	
TS	1	3'-0"	2'-6"	7'-0"	TALL SOUND RACK CABINET WITH ONE FIXED SHELF. AT THE UPPER CABINET, PROVIDE THREE ADJUSTABLE SHELVES AND TWO HINGED DOORS. AT THE LOWER CABINET, PROVIDE TWO HINGED DOORS. OPEN TOE KICK. REFER TO DETAIL ON A7.06	
TT TT	10	3'-6"	2'-6"	7'-0"	TOTE TRAY UNIT WITH TWO VERTICAL DIVIDERS TWO HINGED DOORS. FLAT TOP.	
W	12 11	3'-6" 1'-9"	2'-0" 1'-2"	7'-0" 2'-0"	TOTE TRAY UNIT WITH TWO VERTICAL DIVIDERS TWO HINGED DOORS. INCLUDE SLOPED TOP. WALL UNIT WITH ONE ADJUSTABLE SHELF AND ONE HINGED DOOR. INCLUDE SLOPED TOP.	
W	13	1'-3"	1'-2"	2'-6"	WALL UNIT WITH ONE ADJUSTABLE SHELVES, ONE HINGED DOOR AND SLOPED TOP.	
W	14 16	1'-6" 2'-0"	1'-2" 1'-2"	2'-6" 2'-6"	WALL UNIT WITH ONE ADJUSTABLE SHELF, ONE HINGED DOOR, AND SLOPED TOP. WALL UNIT WITH ONE ADJUSTABLE SHELF, ONE HINGED DOOR, AND SLOPED TOP.	
W	43	3'-0"	1'-2"	1'-9"	WALL UNIT WITH ONE ADJUSTABLE SHELF, TWO HINGED DOORS, AND SLOPED TOP.	
W	44	3'-0"	1'-2" 1'-2"	2'-0"	WALL UNIT WITH ONE ADJUSTABLE SHELF, TWO HINGED DOORS, AND SLOPED TOP.	
W	46 47	3'-6" 3'-0"	2'-0"	2'-0" 1'-0"	WALL UNIT WITH ONE VERTICAL DIVIDER, TWO ADJUSTABLE SHELVES AND TWO HINGED DOORS. INCLUDE SLOPED TOP. WALL UNIT WITH TWO HINGED DOORS AND SLOPED TOP.	
W	50	2'-6"	1'-2"	2'-6"	WALL UNIT WITH TWO ADJUSTABLE SHELVES, TWO HINGED DOORS, AND SLOPED TOP.	
W	52 56	3'-0" 4'-0"	1'-2" 1'-2"	2'-6" 2'-6"	WALL UNIT WITH ONE ADJUSTABLE SHELF, TWO HINGED DOORS, AND SLOPED TOP. WALL UNIT WITH ONE VERTICAL DIVIDER, TWO ADJUSTABLE SHELVES AND TWO HINGED DOORS. INCLUDE SLOPED TOP.	
W	60	2'-6"	1'-2"	2'-0"	WALL UNIT WITH ONE VERTICAL DIVIDER, TWO ADJUSTABLE SHELVES AND TWO HINGED DOORS. INCLUDE SLOPED TOP. WALL UNIT WITH ONE ADJUSTABLE SHELF AND TWO HINGED DOORS. INCLUDE SLOPED TOP.	
W	70	2'-6"	1'-2"	1'-9"	WALL UNIT WITH ONE ADJUSTABLE SHELF AND TWO HINGED DOORS. INCLUDE SLOPED TOP.	
W WC	88 01	2'-9" 4'-0"	1'-2" 1'-6"	2'-6" 3'-0"	WALL UNIT WITH TWO ADJUSTABLE SHELVES, TWO HINGED DOORS, AND SLOPED TOP. WALL UNIT WITH TWO ADJUSTABLE SHELVES AND TWO HINGED DOORS ON UPPER COMPARTMENT; 3 OPEN CUBBIES BELOW;	
					INCLUDE SLOPED TOP AND HOOK ASSEMBLY. REFER TO DETAIL ON A7.07.	
WC	02	2'-8"	1'-3"	2'-9"	WALL UNIT WITH ONE ADJUSTABLE SHELF AND TWO HINGED DOORS ON UPPER COMPARTMENT; 2 OPEN CUBBIES BELOW; INCLUDE SLOPED TOP AND HOOK ASSEMBLY. REFER TO DETAIL ON A7.07.	
WC	03	4'-0"	1'-3"	2'-9"	WALL UNIT WITH TWO ADJUSTABLE SHELVES AND TWO HINGED DOORS ON UPPER COMPARTMENT; 3 OPEN CUBBIES BELOW;	
WDT	6	1'-6"	2'-0"	7'-0"	INCLUDE SLOPED TOP AND HOOK ASSEMBLY. REFER TO DETAIL ON A7.07. TALL UNIT WITH FIVE ADJUSTABLE SHELVES AND ONE HINGED DOOR; INCLUDE REMOVABLE COAT ROD AND MIRROR MOUNTED TO	
					BACKSIDE OF DOOR.	
WM WM	10	2'-6" 2'-9"	1'-2" 1'-2"	1'-4" 1'-4"	MICROWAVE CABINET WITH 2 UPPER DOORS AND 22"D OPEN SHELF BELOW. INCLUDE SLOPED TOP AND CUTOUT FOR OUTLET. MICROWAVE CABINET WITH 2 UPPER DOORS AND 22"D OPEN SHELF BELOW. INCLUDE SLOPED TOP AND CUTOUT FOR OUTLET.	
WO	20	3'-0"	1'-2"	1'-6"	OPEN WALL UNIT WITH SLOPED TOP.	
WO WT	44 01	3'-0" 3'-0"	1'-2" 2'-0"	2'-6" 7'-0"	OPEN WALL UNIT WITH ONE ADJUSTABLE SHELF. INCLUDE SLOPED TOP. TALL TEACHER WARDROBE/TECHNOLOGY CABINET WITH ONE FIXED VERTICAL PANEL; INCLUDE 5 ADJUSTABLE SHELVES,	
V V I	J ^U I	J ³⁻⁰	² - ⁰	1, -0	REMOVABLE COAT ROD, MIRROR, AND FILING DRAWERS; INCLUDE SLOPED TOP PANEL. REFER TO DETAIL ON A7.06. INCLUDE LOCK	
WT	02	3'-6"	2'-0"	7'-0"	ON THIS CABINET. TALL TEACHER WARDROBE/TECHNOLOGY CABINET WITH ONE FIXED VERTICAL PANEL; INCLUDE 5 ADJUSTABLE SHELVES.	
* * 1	102		[REMOVABLE COAT ROD, MIRROR, AND FILING DRAWERS; INCLUDE SLOPED TOP PANEL. REFER TO DETAIL ON A7.06. INCLUDE LOCK	
WT	03	3'-0"	1'-9"	7'-0"	ON THIS CABINET. TALL TEACHER WARDROBE/TECHNOLOGY CABINET WITH ONE FIXED VERTICAL PANEL; INCLUDE 5 ADJUSTABLE SHELVES, REMOVABLE COAT ROD, MIRROR, AND FILING DRAWERS; INCLUDE SLOPED TOP PANEL. REFER TO DETAIL ON A7.06. INCLUDE LOCK ON THIS CABINET.	

	DISCOVERY CENTER CASEWORK SCHEDULE					
	SIZE					
TYPE	NO.	W	D	Н	DESCRIPTION	
MBC	1	3'-0"	2'-0"	3'-6"	DOUBLE-SIDED MOBILE BOOKCASE WITH FIXED CENTER DIVIDER AND 1 SHELF ON EACH SIDE.	
MC	2	2'-8 1/2"	1'-0"	3'-6"	SINGLE-SIDED BOOKCASE WITH 2 ADJUSTABLE SHELVES.	
MC	3	3'-0"	1'-0"	5'-0"	SINGLE-SIDED BOOKCASE WITH 3 ADJUSTABLE SHELVES.	
MC	4	2'-10"	1'-0"	5'-0"	SINGLE-SIDED BOOKCASE WITH 3 ADJUSTABLE SHELVES.	
MC	5	3'-3"	1'-0"	5'-0"	SINGLE-SIDED BOOKCASE WITH 3 ADJUSTABLE SHELVES.	
MC	6	3'-0"	1'-0"	7'-0"	SINGLE-SIDED BOOKCASE WITH 5 ADJUSTABLE SHELVES.	
MC	7	3'-0"	2'-0"	7'-0"	SINGLE-SIDED BOOKCASE WITH 5 ADJUSTABLE SHELVES.	
MC.	8	3'-6"	1'-0"	7'-0"	SINGLE-SIDED BOOKCASE WITH 5 AD ILISTABLE SHELVES	

LIST OF FINISHES

REFER TO A7 ARCH. DWG. SHEETS

TRUFFLE CAMBRIC WITH CRISS-CROSS FINISH 5323-L

EQUIPMENT MATERIALS

CORNER GUARDS

 MATERIAL ABBREVIATION
 MATERIAL/MANUFACTURER
 COLOR SELECTION

 CG
 CS ACROVYN / SSM-20AN
 MISSON WHITE #933 / 2" LEGS X 48"H

REFER TO MISCELLANEOUS FINISHES FOR J-TRIM INFORMATION

CUBICLE CURTAIN

MATERIAL ABBREVIATION

MATERIAL/MANUFACTURER

COLOR SELECTION

MAYER FABRICS / SEAQUAL / SERENE 1 TO BE SELECTED

DISCOVERY CENTER NOOK UPHOLSTERY

NOOK SEAT PADDING TO BE UPHOLSTERED IN DESIGNTEX SILICONE ELEMENT IN TIDAL 3919-408

LAMINART

HP PLASTIC LAMINATE

MATERIAL ABBREVIATIONMATERIAL/MANUFACTURERCOLOR SELECTIONPL-1 (CR CASEWORK)FORMICAMUSLIN FABRIC 06127-58PL-2 (CR BOOKCASE TOPS)FORMICANEUTRAL WHITE WITH SCULPTED FINISH 918-SPPL-3 (DC/STEAM)ARBORITENUNO CLAY P388-CAPL-4 (ADMIN CASEWORK)FORMICAOILED LEGNO 8846-58

KICKPLATES

STAINLESS STEEL

PL-5 (RECEPTION)

MARKERBOARD

PLASTIC TOILET PARTITIONS/COMPARTMENTS

MATERIAL ABBREVIATION MATERIAL/MANUFACTURER COLOR SELECTION

REFER TO SPECIFICATIONS STANDARD COLOR TO BE SELECTED

SHOWER CURTAINS

WHITE

SOLID SURFACE MATERIAL

 MATERIAL ABBREVIATION
 MATERIAL/MANUFACTURER
 COLOR SELECTION

 SSM-1 (CR COLINTERTOPS)
 STARON TEMPEST
 HORIZON EH114

SSM-1 (CR COUNTERTOPS)
STARON TEMPEST
HORIZON FH114
CORIAN / MEGANITE / LX HAUSYS
SSM-3 (ADMIN COUNTERTOPS)
STARON TEMPEST
BAMBOO FB173

STAGE CURTAIN

MATERIAL ABBREVIATION MATERIAL/MANUFACTURER COLOR SELECTION

REFER TO SPECIFICATIONS

REFER TO SPECIFICATIONS

CARNEGIE XOREL / METEOR

CARNEGIE XOREL / SAHARA MATTE

TACKADI E WALL CUDEAC

TACKABLE WALL SURFACE MATERIAL/MANUFACTURER **COLOR SELECTION** MATERIAL ABBREVIATION MOMENTUM / SYMPHONY / PULSE SILENT SILVER AZ52590 TWS-2 (POD-1ST) CARNEGIE XOREL / METEOR 6427-2004 TWS-3 (POD-2ND) CARNEGIE XOREL / METEOR 6427-2024 TWS-4 (POD-3RD) CARNEGIE XOREL / METEOR 6427-2043 TWS-5 (POD-4TH) CARNEGIE XOREL / METEOR 6427-2035

TO BE SELECTED

BLACK

6427-2009

6089-632

TACKBOARDS

TWS-6 (POD-5TH)

TWS-7 (DISC CTR)

MATERIAL ABBREVIATION MATERIAL/MANUFACTURER COLOR SELECTION

TB REFER TO SPECIFICATIONS MANUFACTURER'S STANDARD, TO BE SELECTED

MISCELLANEOUS FINISHES

J-TRIM AT VWC-2 WAINSCOT CAP TO BE CS ACROVYN WC75WTT, SAME COLOR/MANUFACTURER AS CORNER GUARDS

ROLLER WINDOW SHADES

MATERIAL ABBREVIATIONMATERIAL/MANUFACTURERCOLOR SELECTIONRWS-1REFER TO SPECIFICATIONSMFR STANDARD COLOR / 5% OPENRWS-2REFER TO SPECIFICATIONSMFR STANDARD COLOR / OPAQUERWS-3REFER TO SPECIFICATIONSMFR STANDARD COLOR / OPAQUE

EQUIPMENT MATERIAL & FINISH GEN. NOTES

- A. COLOR SELECTION OF ALL FINISHES FOR INTERIOR PLASTIC LAMINATE FACED ARCHITECTURAL CABINETS/ CUSTOM CASEWORK ITEMS
- ARE NOTED ON CASEWORK ELEVATIONS AND DETAIL DRAWINGS.

 B. EDUCATIONAL CASEWORK FINISHES ARE AS FOLLOWS (UNLESS OTHERWISE NOTED):

 HIGH PRESSURE PLASTIC LAMINATE COUNTERTOPS AND WORKSURFACES ARE TO BE PL-2, UNLESS OTHERWISE NOTED.
- 3MM AND 1MM PVC EDGES ON COUNTERTOPS AND WORKSURFACES ARE TO MATCH PL-2.
 1. PLASTIC LAMINATE SURFACES AT BOOKCASES, TYPICAL.
 HIGH PRESSURE PLASTIC LAMINATE CABINETS/VERTICAL SURFACES ARE TO BE PL-1 UNLESS OTHERWISE NOTED. INTERIOR MELAMINE TO BE WHITE.
- 3MM AND 1MM PVC EDGES ON CASEWORK ARE TO MATCH SPECIFIED LAMINATE.
 1. PL-3 EDGEBANDING TO BE WILSONART PEPPERDUST D327-60.
- PL-3 EDGEBANDING TO BE WILSONART PEPPERDUS
 HANDLES TO BE SILVER METALLIC POWDERCOAT.
 HINGES TO BE SILVER METALLIC POWDERCOAT.
- GROMMETS TO BE SELECTED.
 SOLID SURFACE COUNTERTOPS AND WORKSURFACES ARE TO BE SSM-1, UNLESS OTHERWISE NOTED.
- SOLID SURFACE COUNTERTOPS LOCATED AT SINK LOCATIONS, TYPICAL.
 DISCOVERY CENTER CASEWORK TO BE PLASTIC LAMINATE WITH PLASTIC LAMINATE SHELVES, TYPICAL.

CHERRY TREE
ELEMENTARY
SCHOOL
ADDITIONS AND
RENOVATIONS

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CARMEL CLAY SCHOOLS




<u>ARCHITECT</u>



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PROJECT MANAGER: SAM

DRAWN BY: AML

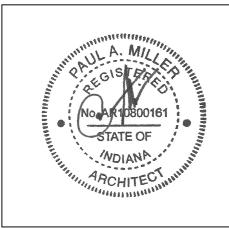
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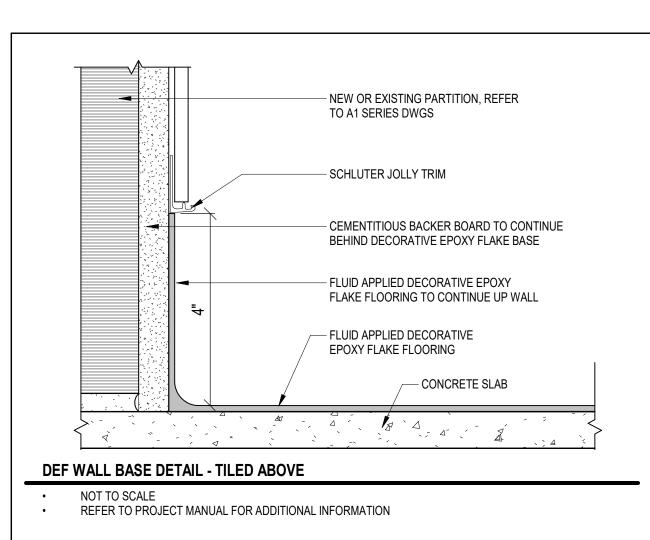
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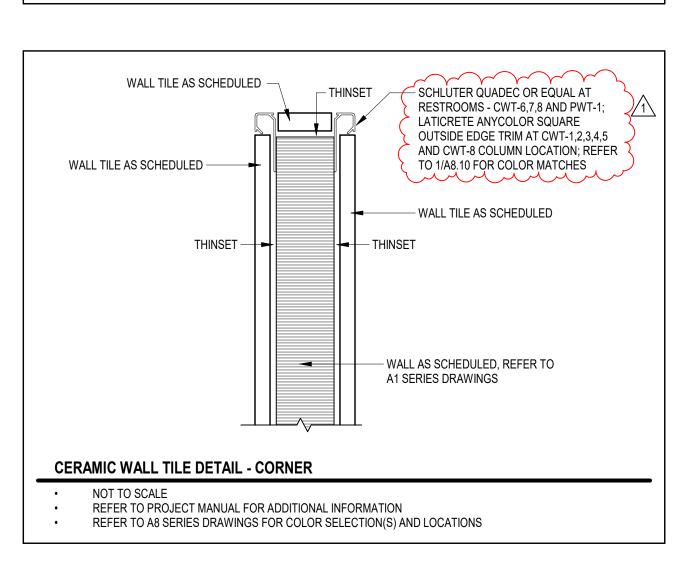
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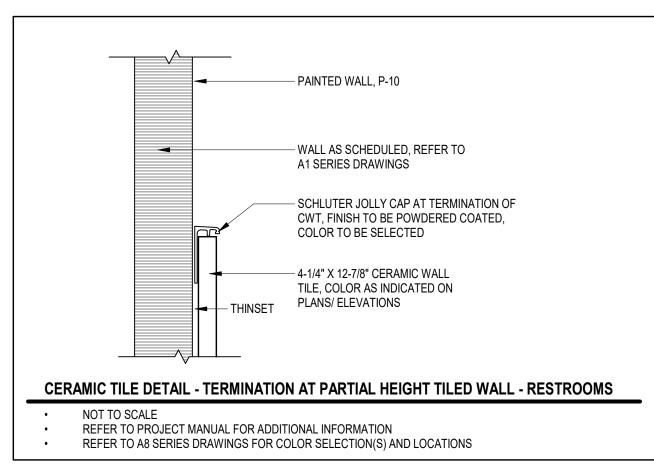
EDUCATIONAL CASEWORK SCHEDULES


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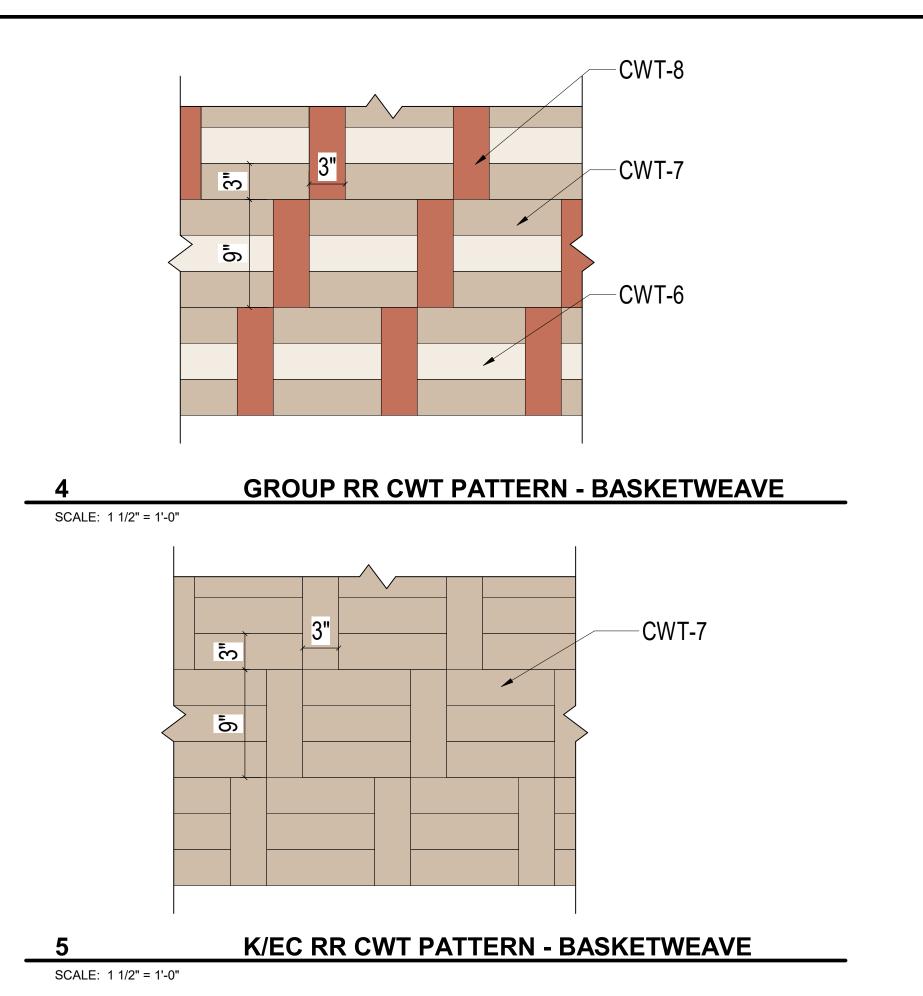










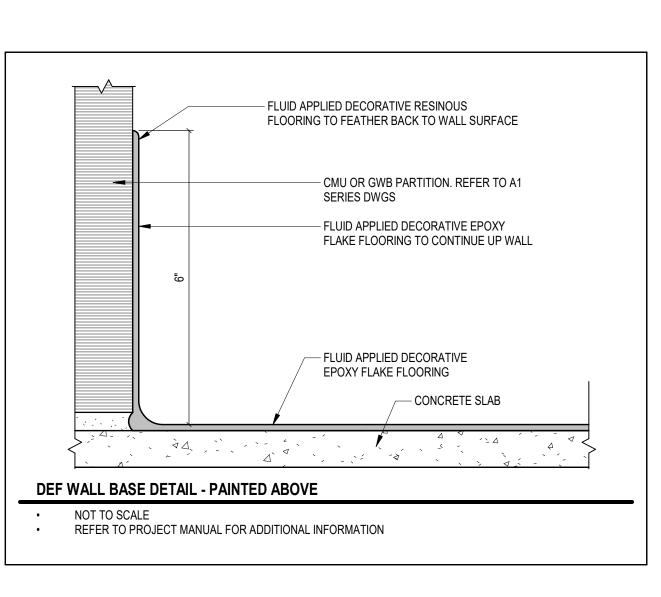


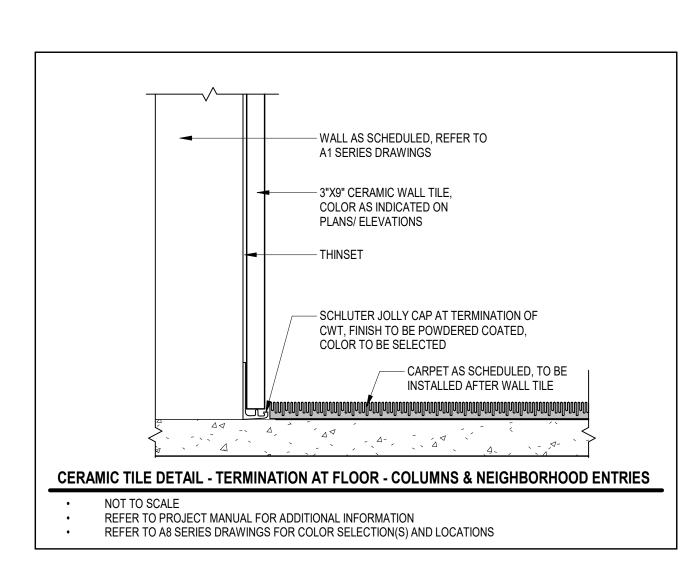


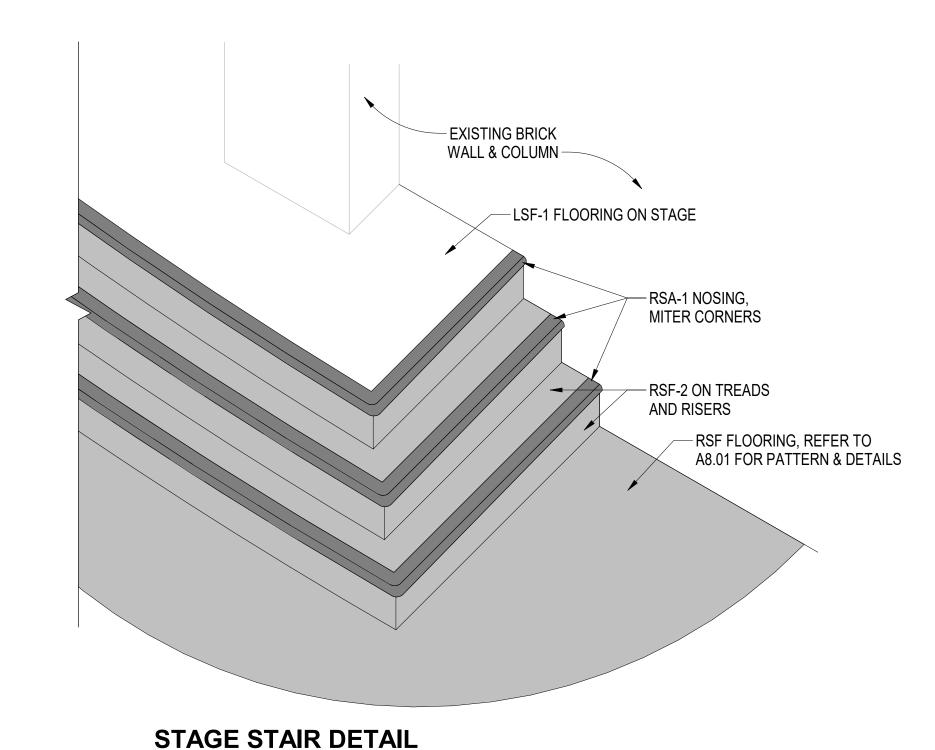

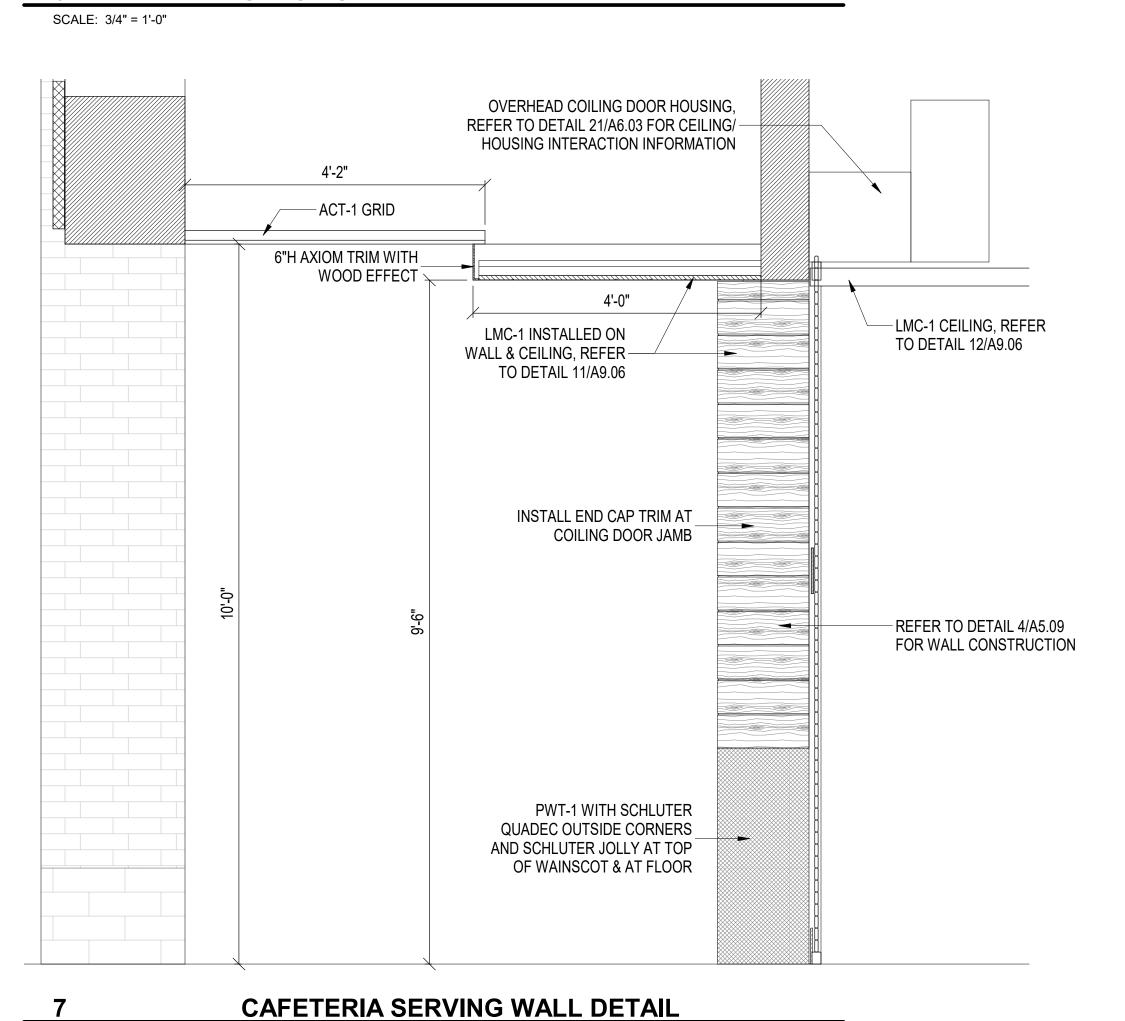


SCALE: 3/4" = 1'-0"

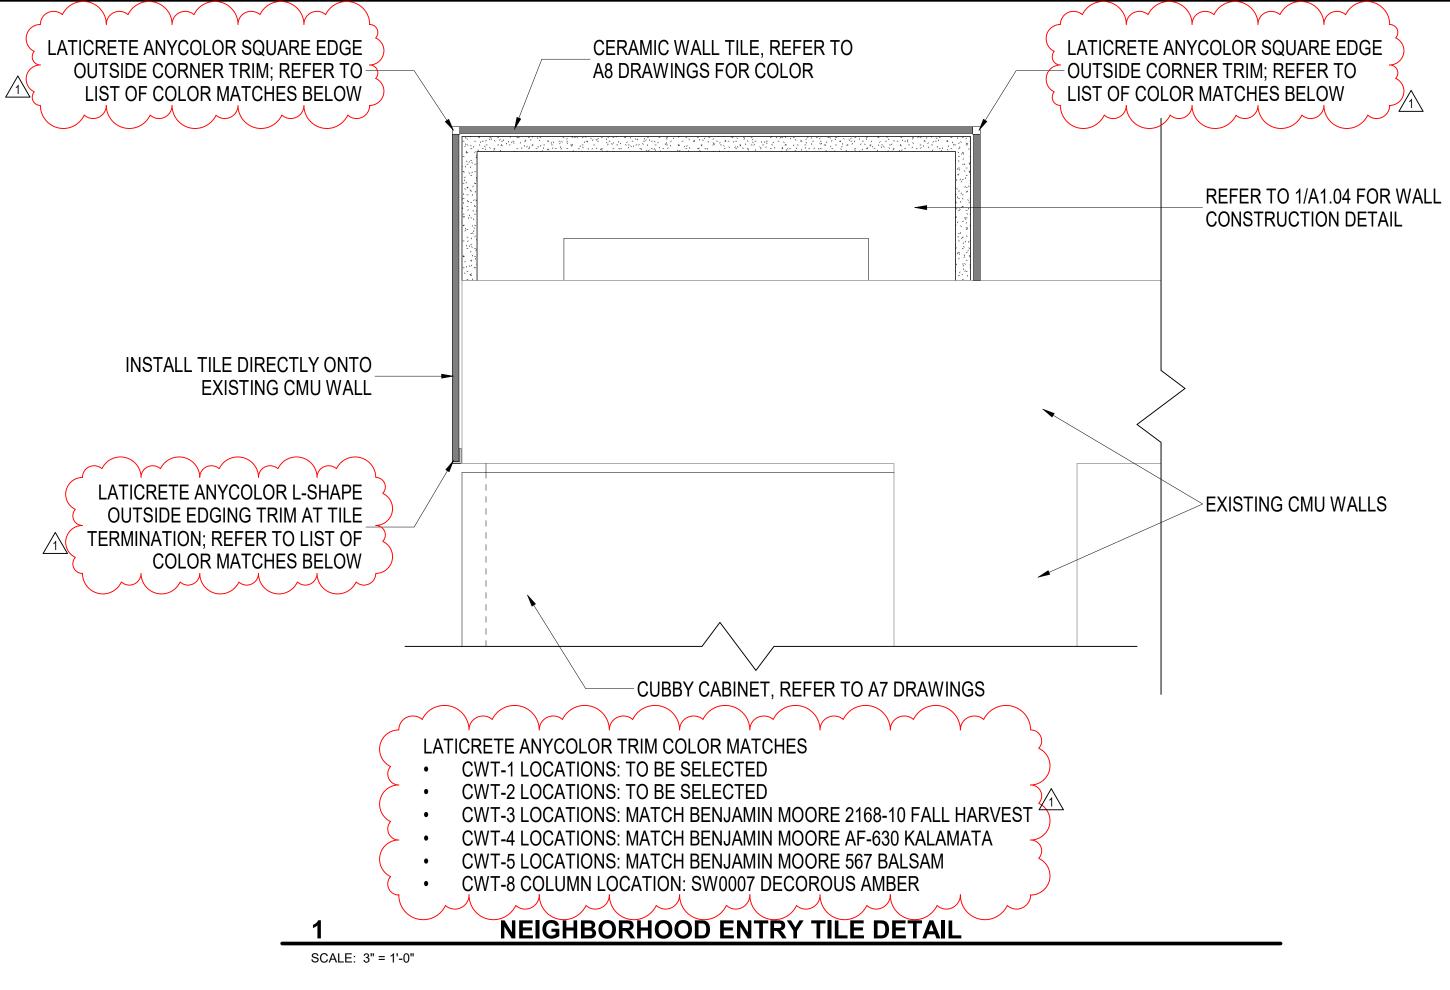

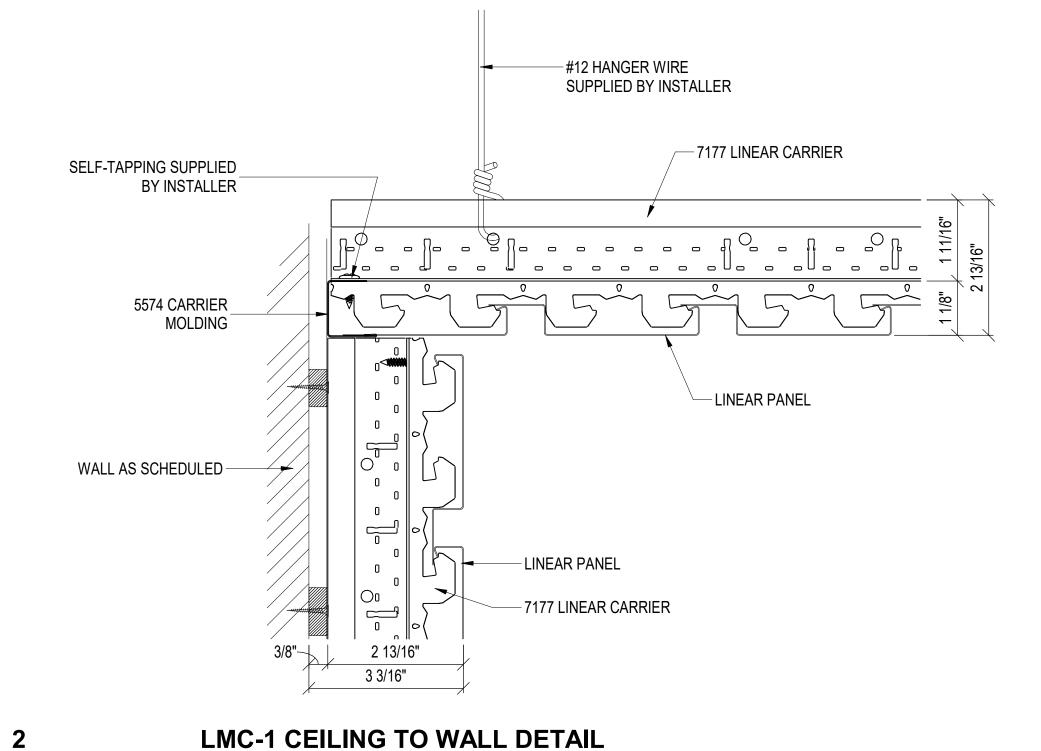

SCALE: 6" = 1'-0"

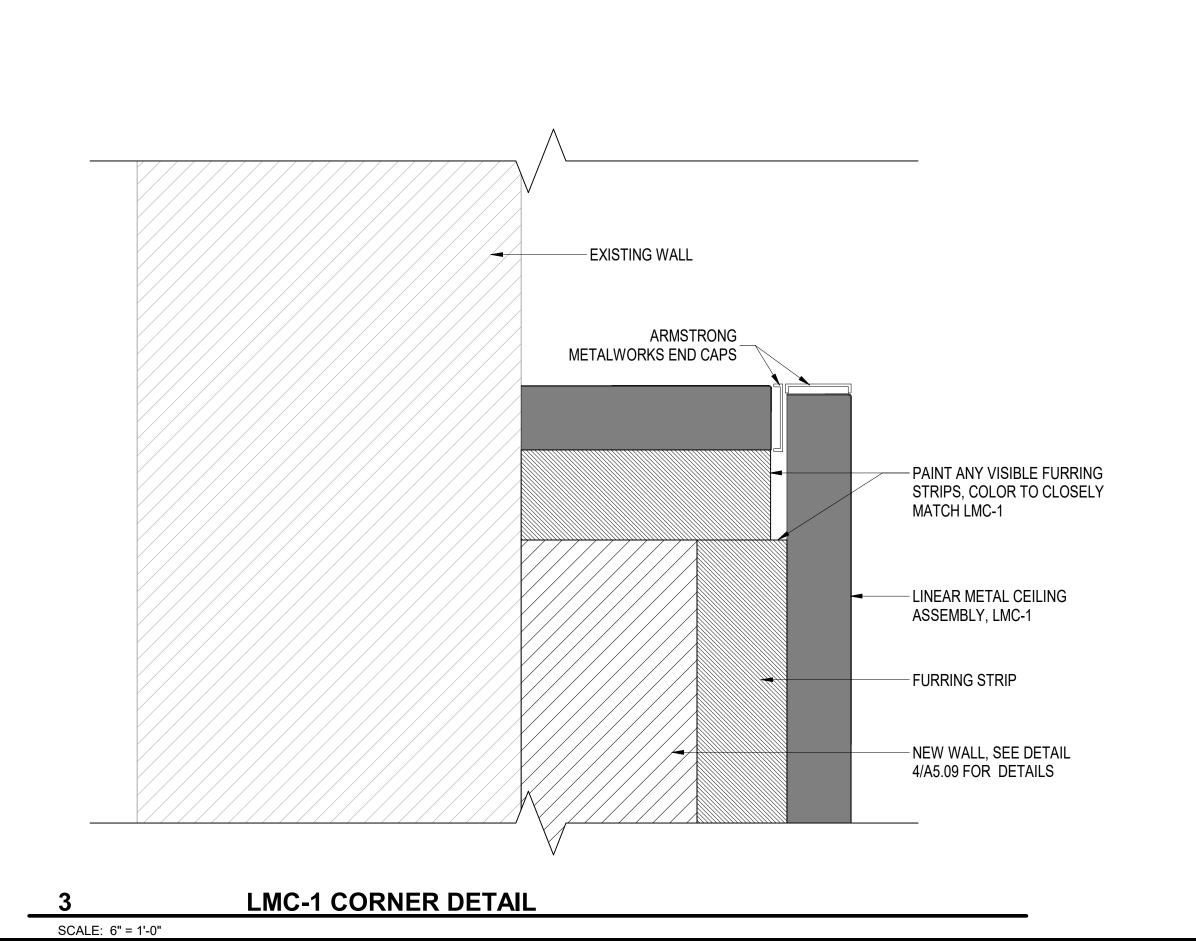

CHEDDA IDEE

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CARMEL CLAY SCHOOLS



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ARCHITECHMANNA

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PROJECT MANAGER: SAM

DRAWN BY: AML

PROJECT NUMBER: 222011.00

PROJECT ISSUE DATE: 02.09.2024

REV. NO. DESCRIPTION DATE

1 ADDENDUM#1 2.23.2024

INTERIOR DETAILS

A8.10

FLOOR MATERIALS

MATERIAL ABBREVIATION	MATERIAL/MANUFACTURER	COLOR SELECTION
CART-1 (ADMIN)	SHAW CONTRACT / ALONGSIDE	MERGE COLOR 5T495-50675 / 9"X36"
CART-2 (OFFICÉS)	SHAW CONTRACT / COLLABORATION	POSITIVE IMPACT 5T497-97676 / 9"X36"
CART-3 (FIELD)	J+J FLOORING / ANALYTIC	WARM 7631-3589 / 18"X36"
CART-4A (1ST ACCENT)	J+J FLOORING / ANALYTIC FORM	WARM YELLOW 7633-3595 / 18"X36"
CART-4B (1ST CR)	J+J FLOORING / ANALYTIC DIFFUSE	WARM YELLOW 7632-3595 / 18"X36"
CART-5A (2ND ACCENT)	J+J FLOORING / ANALYTIC FORM	WARM BLUE 7633-3593 / 18"X36"
CART-5B (2ND CR)	J+J FLOORING / ANALYTIC DIFFUSE	WARM BLUE 7632-3593 / 18"X36"
CART-6A (3RD ACCENT)	J+J FLOORING / ANALYTIC FORM	WARM ORANGE 7633-3596 / 18"X36"
CART-6B (3RD CR)	J+J FLOORING / ANALYTIC DIFFUSE	WARM ORANGE 7632-3596 / 18"X36"
CART-7A (4TH ACCENT)	J+J FLOORING / ANALYTIC FORM	WARM PURPLE 7633-3592 / 18"X36"
CART-7B (4TH CR)	J+J FLOORING / ANALYTIC DIFFUSE	WARM PURPLE 7632-3592 / 18"X36"
CART-8A (5TH ACCENT)	J+J FLOORING / ANALYTIC FORM	WARM GREEN 7633-3594 / 18"X36"
CART-8B (5TH CR)	J+J FLOORING / ANALYTIC DIFFUSE	WARM GREEN 7632-3594 / 18"X36"
CART-9A (DISC CTR)	INTERFACE / THIRD SPACE / 301	GRANITE / 50CM X 50CM
CART-9B (DISC CTR)	INTERFACE / THIRD SPACE / 302	GRANITE / 50CM X 50CM
CART-9C (DISC CTR)	INTERFACE / THIRD SPACE / 303	GRANITE / 50CM X 50CM

CERAMIC MOSAIC TILE		
MATERIAL ABBREVIATION	MATERIAL/MANUFACTURER	COLOR SELECTION
CMT-1	DALTILE / KEYSTONES AMERICAN OLEAN / UNGLAZED COLORBODY	GROUP 2, TO BE SELECTED / 2"X2" GROUP 2, TO BE SELECTED / 2"X2"
DECORATIVE EPOXY FLA	AKE FLOORING	
MATERIAL ABBREVIATION	MATERIAL/MANUFACTURER	COLOR SELECTION
DEF-1	REFER TO SPECIFICATIONS	MATCH TORGINAL COYOTE FB-513
ENTRANCE CARPET TILE		
MATERIAL ABBREVIATION	MATERIAL/MANUFACTURER	COLOR SELECTION
ECT-1	INTERFACE / SR899	TO BE SELECTED
LINOLEUM SHEET FLOOI	RING	
MATERIAL ABBREVIATION	MATERIAL/MANUFACTURER	COLOR SELECTION
LSF-1	FORBO / MARMOLEUM / CONCRETE	METEORITE 3705
LUXURY VINYL TILE		
MATERIAL ABBREVIATION	MATERIAL/MANUFACTURER	COLOR SELECTION
LVT-1 (ADMIN) LVT-2 (NEIGHBORHOODS) LVT-3 (STEAM)	MOHAWK / LIVING LOCAL / CHROMASCOPE MANNINGTON / AMTICO / WOODS MOHAWK / MYCOTEXTURE	JACK RABBIT C0159-940 / 12"X24" ROTTERDAM OAK AR0W8440 / 7.25"X48" BARK / 18"X36"
RESILIENT SHEET FLOOI	RING	
MATERIAL ABBREVIATION	MATERIAL/MANUFACTURER	COLOR SELECTION
RSF-1 (KITCHEN) RSF-2 RSF-3 RSF-4 RSF-5 RSF-6	ALTRO STRONGHOLD 30 ECORE / ECOSURFACES CLASSIC	TUNDRA-K30500 ACTION! 1213 MONDAY BLUES 2614 RAIDERS OF THE LOST ARCHITECT 1212 MRS. DOUBTFIREPLACE 1209 BLUE HIGHWAY 2620
RESILIENT STAIR NOSING	3	
MATERIAL ABBREVIATION	MATERIAL/MANUFACTURER	COLOR SELECTION
RSA-1	JOHNSONITE / VDL-XX-RD	TO BE SELECTED
VINYL COMPOSITION TIL	E	
MATERIAL ABBREVIATION	MATERIAL/MANUFACTURER	COLOR SELECTION
VCT-1	TARKETT VCT II	TO BE SELECTED / 12"X12"

I DACE MATERIAL C

MATERIAL ABBREVIATION

CERAMIC MOSAIC TILE BASE		BUILT-UP COVE	
MATERIAL ABBREVIATION	MATERIAL/MANUFACTURER	COLOR SELECTION	
CMTB-1	DALTILE / KEYSTONES AMERICAN OLEAN / UNGLAZED COLORBODY	GROUP 2, TO BE SELECTED / 2"X2" / MB5A GROUP 2, TO BE SELECTED / 2"X2" / MT6A	
DECORATIVE EPOXY FLA	AKE FLOORING		
MATERIAL ABBREVIATION	MATERIAL/MANUFACTURER	COLOR SELECTION	
DEF-1	REFER TO SPECIFICATIONS	MATCH TORGINAL COYOTE FB-513	
RESILIENT BASE		4" COVE	
MATERIAL ABBREVIATION	MATERIAL/MANUFACTURER	COLOR SELECTION	
RB-1	JOHNSONITE	BURNT UMBER 63	
RESILIENT SHEET FLOO	RING		
MATERIAL ABBREVIATION	MATERIAL/MANUFACTURER	COLOR SELECTION	
RSF-1 (KITCHEN)	ALTRO STRONGHOLD 30	TUNDRA-K30500	

COLOR SELECTION

BLACK

MATERIAL/MANUFACTURER

JOHNSONITE

WALL FINISHES

CERAMIC WALL TILE

ABUSE-RESISTANT ACOUSTICAL WALL TILES			
MATERIAL ABBREVIATION	MATERIAL/MANUFACTURER	COLOR SELECTION	
AR-AWT-1A	ARMSTRONG / TECTUM DESIGNART SHAPES / LEFT PARALLELOGRAM	PPG PAINTS - PPG1022-4 ROCK SLIDE 24"X48" OVERALL	
AR-AWT-1B	ARMSTRONG / TECTUM DESIGNART SHAPES / 45 DEGREE TRIANGLE	PPG PAINTS - PPG1022-4 ROCK SLIDE 24"X24" OVERALL	
AR-AWT-2A	ARMSTRONG / TECTUM DESIGNART SHAPES / LEFT PARALLELOGRAM	BENJAMIN MOORE - 2168-10 FALL HARVEST 24"X48" OVERALL	
AR-AWT-2B	ARMSTRONG / TECTUM DESIGNART SHAPES / 45 DEGREE TRIANGLE	BENJAMIN MOORE - 2168-10 FALL HARVEST 24"X24" OVERALL	
AR-AWT-3A	ARMSTRONG / TECTUM DESIGNART SHAPES / LEFT PARALLELOGRAM	PPG PAINTS - PPG1210-5 BRIGHT IDEA 24"X48" OVERALL	
AR-AWT-3B	ARMSTRONG / TECTUM DESIGNART SHAPES / 45 DEGREE TRIANGLE	PPG PAINTS - PPG1210-5 BRIGHT IDEA 24"X24" OVERALL	
AR-AWT-4A	ARMSTRONG / TECTUM DESIGNART SHAPES / LEFT PARALLELOGRAM	BENJAMIN MOORE - 567 BALSAM 24"X48" OVERALL	
AR-AWT-4B	ARMSTRONG / TECTUM DESIGNART SHAPES / 45 DEGREE TRIANGLE	BENJAMIN MOORE - 567 BALSAM 24"X24" OVERALL	
AR-AWT-5A	ARMSTRONG / TECTUM DESIGNART SHAPES / LEFT PARALLELOGRAM	PPG PAINTS - PPG1164-7 ANNAPOLIS BLUE 24"X48" OVERALL	
AR-AWT-5B	ARMSTRONG / TECTUM DESIGNART SHAPES / 45 DEGREE TRIANGLE	PPG PAINTS - PPG1164-7 ANNAPOLIS BLUE 24"X24" OVERALL	
AR-AWT-6A	ARMSTRONG / TECTUM DESIGNART SHAPES / LEFT PARALLELOGRAM	BENJAMIN MOORE - AF-630 KALAMATA 24"X48" OVERALL	
AR-AWT-6B	ARMSTRONG / TECTUM DESIGNART SHAPES / 45 DEGREE TRIANGLE	BENJAMIN MOORE - AF-630 KALAMATA 24"X24" OVERALL	

	MATERIAL ABBREVIATION	MATERIAL/MANUFACTURER	COLOR SELECTION	
	CWT-1 (1ST) CWT-2 (2ND) CWT-3 (3RD) CWT-4 (4TH) CWT-5 (5TH) CWT-6 (RR) CWT-7 (RR) CWT-8 (RR)	PLATFORM TILE / BRICK ENVY	GOLDEN COAST / 3"X9" NOTURNO / 3"X9" AMSTERDAM / 3"X9" MIRTILO / 3"X9" HIGHLAND / 3"X9" SANTORINI / 3"X9" LHAMA / 3"X9" HAVANA / 3"X9"	
ſ	PAINT			
	MATERIAL ABBREVIATION	MATERIAL/MANUFACTURER	COLOR SELECTION	
	P-1 (FIELD) P-2 (DOOR FRAMES) P-3 (CEILINGS) P-4 (1ST ACCENT)	SHERWIN WILLIAMS SHERWIN WILLIAMS SHERWIN WILLIAMS PPG PAINTS	SW7042 SHOJI WHITE SW7069 IRON ORE SW7005 PURE WHITE PPG1210-5 BRIGHT IDEA	

P-1 (FIELD)	SHERWIN WILLIAMS	SW7042 SHOJI WHITE
P-2 (DOOR FRAMES)	SHERWIN WILLIAMS	SW7069 IRON ORE
P-3 (CEILINGS)	SHERWIN WILLIAMS	SW7005 PURE WHITE
P-4 (1ST ACCÉNT)	PPG PAINTS	PPG1210-5 BRIGHT IDEA
P-5 (2ND ACCENT)	PPG PAINTS	PPG1164-7 ANNAPOLIS BLUE
P-6 (3RD ACCENT)	BENJAMIN MOORE	2168-10 FALL HARVEST
P-7 (4TH ACCENT)	BENJAMIN MOORE	AF-630 KALAMATA
P-8 (5TH ACCENT)	BENJAMIN MOORE	567 BALSAM
P-9 (DC/GYM/CAFE)	PPG PAINTS	PPG15-28 GREAT GRAY
P-10 (PWT-1 MATCH)	PPG PAINTS	PPG1006-5 SO SUBLIME
P-11 (BRICK MATCH)	SHERWIN WILLIAMS	SW0007 DECOROUS AMBER
P-12 (GREEN SCREÉN)	BENJAMIN MOORE	2032-20 TRAFFIC LIGHT GREEN / FLAT
P-13 (WOOD TRIM)	PPG PAINTS	1022-4 ROCK SLIDE
P-14 (DC/CAFE)	PPG PAINTS	PPG1164-6 BLUE CLOUD
P-15 (ACCENT)	PPG PAINTS	PPG1024-3 CRUSHED SILK
,		

PORCELAIN WALL TILE			
MATERIAL ABBREVIATION	MATERIAL/MANUFACTURER	COLOR SELECTION	
PWT-1 (RR)	FLORIDA TILE / TEMPO	DARK GRAY MATTE / 12"X24"	

MATERIAL ABBREVIATION	MATERIAL/MANUFACTURER	COLOR SELECTION
SFWS-1 (D.C./STEAM)	DESIGNTEX / BRUSHED FLANNEL	CREME 3797-101
SFWS-2 (D.C./STEAM)	DESIGNTEX / GAMUT	CADET 3468-409
SFWS-3 (CAFE)	DESIGNTEX / BIRDSEYE	MOCHA 4142-104

	VINYL WALLCOVERING		
,	MATERIAL ABBREVIATION	MATERIAL/MANUFACTURER	COLOR SELECTION
	VWC-1 (OP WALL) VWC-2 (WAINSCOT)	MOMENTUM / ALTO KOROSEAL / FLEX DECORATIVE WALL PROTECTION / MONROE TYPE III	TIRAMISU LLN-AT-04 LINEN MON1-06

MATERIAL/MANUFACTURER

STACKED WOOD WALLS / MAISIE

WINDFALL / HARDWOOD CLADDING

REFER TO A7S.01 FOR CORNER GUARD AND J-TRIM INFORMATION

MATERIAL ABBREVIATION

WDW-1

WOOD VENEER WALLCOVERING		
MATERIAL ABBREVIATION	MATERIAL/MANUFACTURER	COLOR SELECTION
WVWC-1	MOMENTUM / SOURCE ONE / WOODS	BROWN BIRCH SWS-62
WOOD WALL		

COLOR SELECTION

BEST MATCH TO JUGLANS

JUGLANS 2012

MISCELLANEOUS FINISHES

MATERIAL ABBREVIATION	MATERIAL/MANUFACTURER	COLOR SELECTION
AWC-1	SURFACE MATERIALS / CROSSPOINT / TIARA II	PELICAN 00103
ARCHITECTURAL FINISH F	ILM	
MATERIAL ABBREVIATION	MATERIAL/MANUFACTURER	COLOR SELECTION
AFF-1 (DISC CTR)	DESIGNTEX - 3M / DI-NOC	LEATHER / LE-1109
BRICK		
MATERIAL ABBREVIATION	MATERIAL/MANUFACTURER	COLOR SELECTION
BRK-1 (BEST MATCH EXISTING) BRK-2 (MATCH EXISTING)	GLEN-GERY BRICK / CUSHWA SERIES BELDEN'BRICK	ROSE FULL RANGE - NO DARK BRICK / MODULAR SIZE / STANNE SPECIAL BLEND / COARSE VELOUR TEXTURE / UTILITY SIZE, REFER TO DETAIL 6/A3.03 FOR TRIMS & DEP
DECORATIVE FILM OVERL	AY	
MATERIAL ABBREVIATION	MATERIAL/MANUFACTURER	COLOR SELECTION
DFO-1	3M FASARA	TO BE SELECTED
EXTERIOR CERAMIC WALI	L TILE	

GROUT			
MATERIAL ABBREVIATION	MATERIAL/MANUFACTURER	COLOR SELECTION	
GT-1 (PWT) GT-2 (CWT-1) GT-3 (CWT-2) GT-4 (CWT-3) GT-5 (CWT-4) GT-6 (CWT-5) GT-7 (CWT-6,7,8)	REFER TO SPECIFICATIONS	TO BE SELECTED	

AGROB-BUCHTAL / PLURAL PLUS ONE TO BE SELECTED / SILKY-MATT FINISH / 20CM X 20CM

INTERIOR WOOD DOORS/ INTERIOR WOOD TRIM

ECWT-1

EXISTING WOOD DOORS, TRANSOMS, AND TRIM TO REMAIN. NEW WOOD DOORS, AND TRANSOMS TO MATCH EXISTING. ROTARY CUT RED OAK TO BE WOOD SPECIES FOR NEW DOORS AND TRANSOMS. STAIN TO MATCH EXISTING DOORS.

 PROVIDE STAIN SAMPLES FOR VERIFICATION. DISCOVERY CENTER NOOK ASSEMBLY TO BE STAINED RED OAK, COLOR TO MATCH MINWAX SMOKEWOOD MW-407

DISCOVERY CENTER NOT	OK ASSEMBLY TO BE STAINED RED OAK, CO	DEOR TO MATCH MINWAX SMOREWOOD MW-407												
RESILIENT MOLDING ACCESSORIES														
MATERIAL ABBREVIATION	MATERIAL/MANUFACTURER	COLOR SELECTION												
RMA-1	JOHNSONITE	TO BE SELECTED												
SAFETY PADDING														
MATERIAL ABBREVIATION	MATERIAL/MANUFACTURER	COLOR SELECTION												
SP-1	REFER TO SPECIFICATIONS FOR ADD	ITIONAL INFORMATION												

AFU INC FINICHES

MATERIAL ABBREVIATION

LMC-1

ACOUSTICAL CEILING TI	LES	
MATERIAL ABBREVIATION	MATERIAL/MANUFACTURER	COLOR SELECTION
ACT-1 (FIELD)	ARMSTRONG / SCHOOL ZONE FINE FISSURED HIGH NRC #1713	WHITE / 2'X2'
ACT-2 (RESTROOMS)	ARMSTRONG / TUNDRA #301	WHITE / 2'X2'
ACT-3 (STORAGE)	ARMSTRONG / FINE FISSURED #1810	WHITE / 2'X2'
ACT-4 (KITCHEN)	ARMSTRONG / CLEAN ROOM VL #868	WHITE / 2'X2'
ACT-5 (OFFICES)	ARMSTRONG / OPTIMA #3354	WHITE / 2'X2'
NTERIOR FINISH SYSTEI	М	
MATERIAL ABBREVIATION	MATERIAL/MANUFACTURER	COLOR SELECTION
FS-1	REFER TO SPECIFICATIONS	TO BE SELECTED (MATCH P-15)
FS-2	REFER TO SPECIFICATIONS	TO BE SELECTED (WHITE)

COLOR SELECTION

EFFECTS SUBTLE, COLOR TO BE SELECTED / 4"X96"

MATERIAL/MANUFACTURER

LINEAR CLASSICS

ARMSTRONG / METALWORKS

MATERIAL & FINISH GENERAL NOTES

GENERAL

A. REFER TO FINISH PLAN DRAWINGS AND DETAILS (A8 SERIES) FOR MATERIALS, PATTERNS AND COLORS. B. REFER TO A7S.01 LIST OF FINISHES FOR ADDITIONAL FINISHES NOT NOTED ON THIS SHEET.

A. CENTER FLOORING TILE AND PATTERN IN ROOM UNLESS OTHERWISE INDICATED ON FINISH PLANS.

ALIGN EDGE OF FINISHED FLOOR MATERIAL WITH EDGE OF WALL OR CASEWORK. FLOOR FINISH MATERIAL TRANSITIONS SHALL OCCUR UNDER THE CENTER OF THE DOOR UNLESS OTHERWISE INDICATED, WHERE THE FLOORING MATERIAL CHANGES FROM ROOM TO ROOM.

EXTEND FLOOR MATERIAL AND PATTERN UNDER ALL OPEN TO THE FLOOR CASEWORK AND FURNITURE. COORDINATE CONTROL JOINTS IN CONCRETE SLAB WITH STRUCTURAL DRAWINGS AND FINISH FLOORING INSTALLER. REFER TO FLOOR PLANS, RESTROOM ENLARGED PLANS, PLUMBING DRAWINGS, ETC. FOR FLOOR DRAIN LOCATIONS.

AT BUILDING EXPANSION JOINTS (IF APPLICABLE) PROVIDE PRE-FABRICATED MOVEMENT PROFILE SYSTEM IN MORTAR BED. PROVIDE SCHLUTER DILEX-EDP OR APPROVED EQUAL. TYPICAL AT ALL LOCATIONS.

EXISTING MATERIALS (X)

A. (XBRK) INDICATES EXISTING BRICK TO REMAIN. DO NOT PAINT.

(XWAF) INDICATES EXISTING WOOD ATHLETIC FLOOR TO REMAIN. DO NOT PAINT.

(XVRB) INDICATES EXISTING VENTED RESILIENT BASE TO REMAIN. (XGWB) INDICATES EXISTING GYPSUM WALLBOARD CEILING TO REMAIN. REPAINT AS SCHEDULED.

(XWD) INDICATES EXISTING WOOD CEILING TO REMAIN. DO NOT PAINT.

LUXURY VINYL TILE (LVT)

A. ALL LVT PATTERNS BASED ON PLANK SIZE INCREMENTS PER MANUFACTURER.

ALL LVT TO HAVE SQUARE EDGE, NOT BEVEL. LVT-1 & LVT-3 INSTALLATION METHOD TO BE ASHLAR. D. LVT-2 INSTALLATION METHOD TO BE 1/3 OVERLAP.

VINYL COMPOSITION TILE (VCT)

A. ALL VCT TO BE INSTALLED PER MANUFACTURER'S RECOMMENDATIONS.

CARPET TILE (CART)

A. CART-1 & 2 TO BE LAID IN ASHLAR INSTALLATION METHOD. CART-3 TO BE LAID IN BOTH BRICK AND MONOLITHIC INSTALLATION METHODS, REFER TO A8.11 FOR FLOORING DETAIL.

CART-_A TO BE LAID IN BRICK INSTALLATION METHOD. CART- B TO BE LAID IN BRICK INSTALLATION METHOD.

CART-9_ TO BE LAID IN NON-DIRECTIONAL INSTALLATION METHOD, REFER TO A8.11 FOR FLOORING DETAIL PRIOR TO INSTALLATION, CONTRACTOR TO SUBMIT INSTALLATION DRAWINGS INDICATING DIRECTION/LAYOUT OF CARPET TILE TO ENSURE THAT DESIGN INTENT HAS BEEN IMPLEMENTED.

WALL TILE

A. SHOWER ENCLOSURE LOCATED IN ROOM A111 IS TO HAVE FLOOR TO CEILING CERAMIC WALL TILE INSTALLED ON ALL THREE WALLS

CERAMIC WALL TILE TO BE INSTALLED IN VERTICAL STRAIGHT LAY UNLESS NOTED OTHERWISE.

CERAMIC WALL TILE ACCENT WALLS IN SINGLE RESTROOMS TO BE INSTALLED IN BASKETWEAVE PATTERN AS NOTED. PORCELAIN WALL TILE TO BE INSTALLED IN VERTICAL STRAIGHT LAY.

WALL BASE
A. RUBBER BASE (RB-1) TO BE INSTALLED AT ALL LVT, VCT, CART, AND SVF LOCATIONS UNLESS OTHERWISE INDICATED. ALL RB BASE TO

B. PROVIDE PREFORMED BASE TO MATCH 1"RADIUS AT ALL LOCATIONS WHERE BASE COVERS MASONRY BULLNOSE. REFER TO FINISH SCHEDULE FOR BASE MATERIAL TYPE. TYPICAL AT ALL LOCATIONS. AT RB LOCATIONS PROVIDE PREFORMED OUTSIDE CORNERS, AND USE MANUFACTURER'S RECOMMENDED ADHESIVE (CONTACT CEMENT) FOR PROPER ADHESION WITH NO GAPS.

PAINT & STAIN

A. PAINT ALL WALLS UNLESS OTHERWISE INDICATED ON FINISH PLANS.

PAINT ONE MOCK-UP CLASSROOM TO RECEIVE ARCHITECT'S APPROVAL PRIOR TO ORDERING PAINT FOR THE ENTIRE BUILDING.

REPAINT ALL EXISTING DOOR FRAMES. REFER TO SPECIFICATIONS FOR ADDITIONAL INFORMATION. REFER TO "MISCELLANEOUS MATERIALS" SECTION FOR INFORMATION ON WOOD SPECIES AND STAIN.

PAINT TYPE GENERAL NOTES

- A. UNDER SECTION 099123 INTERIOR PAINTING, PAINT EXPOSED PIPES, DUCTWORK, BREACHING, CONDUIT, INSULATED PIPES, CONDUIT HANGERS, SUPPORTS, BRACING, ETC., WHICH OCCURS IN SPACES DESIGNATED TO BE PAINTED IN PART OR WHOLE.
- PAINTING AND FINISHING OF EXTERIOR SURFACES AS DESIGNATED. DETAILS SHALL BE UNDER THE WORK SECTION 0991113 EXTERIOR
- ALL WALLS ARE TO RECEIVE A SEMI-GLOSS FINISH AND ALL CEILINGS/BULKHEADS ARE TO RECEIVE A FLAT FINISH. ALL GYPSUM BOARD WALLS SHALL BE PAINTED WITH INTERIOR PAINT TYPE #9.23 (SEMI-GLOSS) UNLESS OTHERWISE INDICATED.
- ALL GYPSUM BOARD CEILINGS AND SOFFITS SHALL BE PAINTED WITH PAINT TYPE #9.21 (FLAT) UNLESS OTHERWISE INDICATED. PAINT ALL NON-INTEGRALLY COLORED CMU WALLS WITH INTERIOR PAINT TYPE #4.14 (SEMI-GLOSS), UNLESS OTHERWISE INDICATED. IN THE FOLLOWING ROOMS PAINT CMU WITH PAINT CODE #4.223 (EPOXY-SEMI-GLOSS). REFER TO SECTION 099600 - HIGH

PERFORMANCE COATING: <u>All Corridors, Neighborhood Cubby and Commons Areas, Gymnasium, Steam Lab, Large</u>

H. IN THE FOLLOWING ROOMS PAINT GWB WITH PAINT CODE #9.212 (EPOXY-SEMI-GLOSS). REFER TO SECTION 099600 - HIGH PERFORMANCE COATING: ADMIN CORRIDORS

ALL EXPOSED STEEL COLUMNS SHALL BE PAINTED WITH PAINT CODE #5.223 (EPOXY SEMI-GLOSS). REFER TO SECTION 099600 - HIGH PERFORMANCE COATINGS. ALL FERROUS METAL (EXCLUDING STRUCTURE) SHALL BE PAINTED INTERIOR PAINT TYPE #5.12.

ALL GALVANIZED METAL (EXCLUDING STRUCTURE) SHALL BE PAINTED INTERIOR PAINT TYPE #5.32. ALL EXPOSED STEEL (FERROUS) STRUCTURE SHALL BE PAINTED INTERIOR PAINT TYPE #5.11.

ALL EXPOSED GALVANIZED-METAL STRUCTURE SHALL BE PAINTED INTERIOR PAINT TYPE #5.31. ALL GALVANIZED STEEL TRIM SHALL BE PAINTED INTERIOR PAINT TYPE #5.322.


ALL ABUSE RESISTANT ACOUSTICAL WALL PANELS (AR-AWT) SHALL BE PAINTED WITH INTERIOR PAINT CODE #11.0. ALL WOOD DOORS AND TRANSOMS THAT ARE SCHEDULED TO BE PAINTED SHALL BE PAINTED INTERIOR PAINT TYPE #6.31.

ALL WOOD PANELS THAT ARE SCHEDULED TO BE PAINTED SHALL BE PAINTED INTERIOR PAINT TYPE #6.41.

ALL EXPOSED MECHANICAL INSULATION SHALL BE PAINTED INTERIOR PAINT TYPE #10.11.

PAINT COLOR GENERAL NOTES

- ALL INTERIOR WALLS SHALL BE PAINTED P-1, UNLESS OTHERWISE INDICATED ON FINISH PLANS OR INTERIOR ELEVATIONS.
- PAINT ALL EXPOSED STEEL ON STAIRS, RAILS, AND STRINGERS P-2. PAINT ALL GWB SOFFITS P-3 UNLESS OTHERWISE NOTED ON FINISH PLANS OR INTERIOR ELEVATIONS. PAINT ALL SIDES (HORIZ. AND VERT.) OF SOFFIT INDICATED COLOR, UNLESS OTHERWISE NOTED.
- PAINT ALL PAINTED EXPOSED CEILINGS AND GYPSUM BOARD CEILINGS P-3 UNLESS OTHERWISE NOTED ON FINISH PLANS, CEILING
- ALL INTERIOR HOLLOW METAL FRAMES AND DOOR FRAMES TO BE PAINTED P-2 UNLESS OTHERWISE NOTED. ALL EXPOSED INTERIOR STEEL COLUMNS SHALL BE PAINTED P-1 UNLESS OTHERWISE INDICATED ON INTERIOR ELEVATIONS OR FINISH

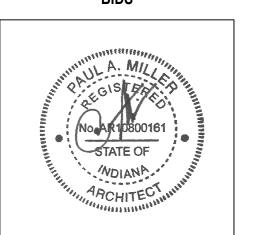

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CHERRY TREE

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ADDITIONS AND

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<u>ARCHITECT</u>

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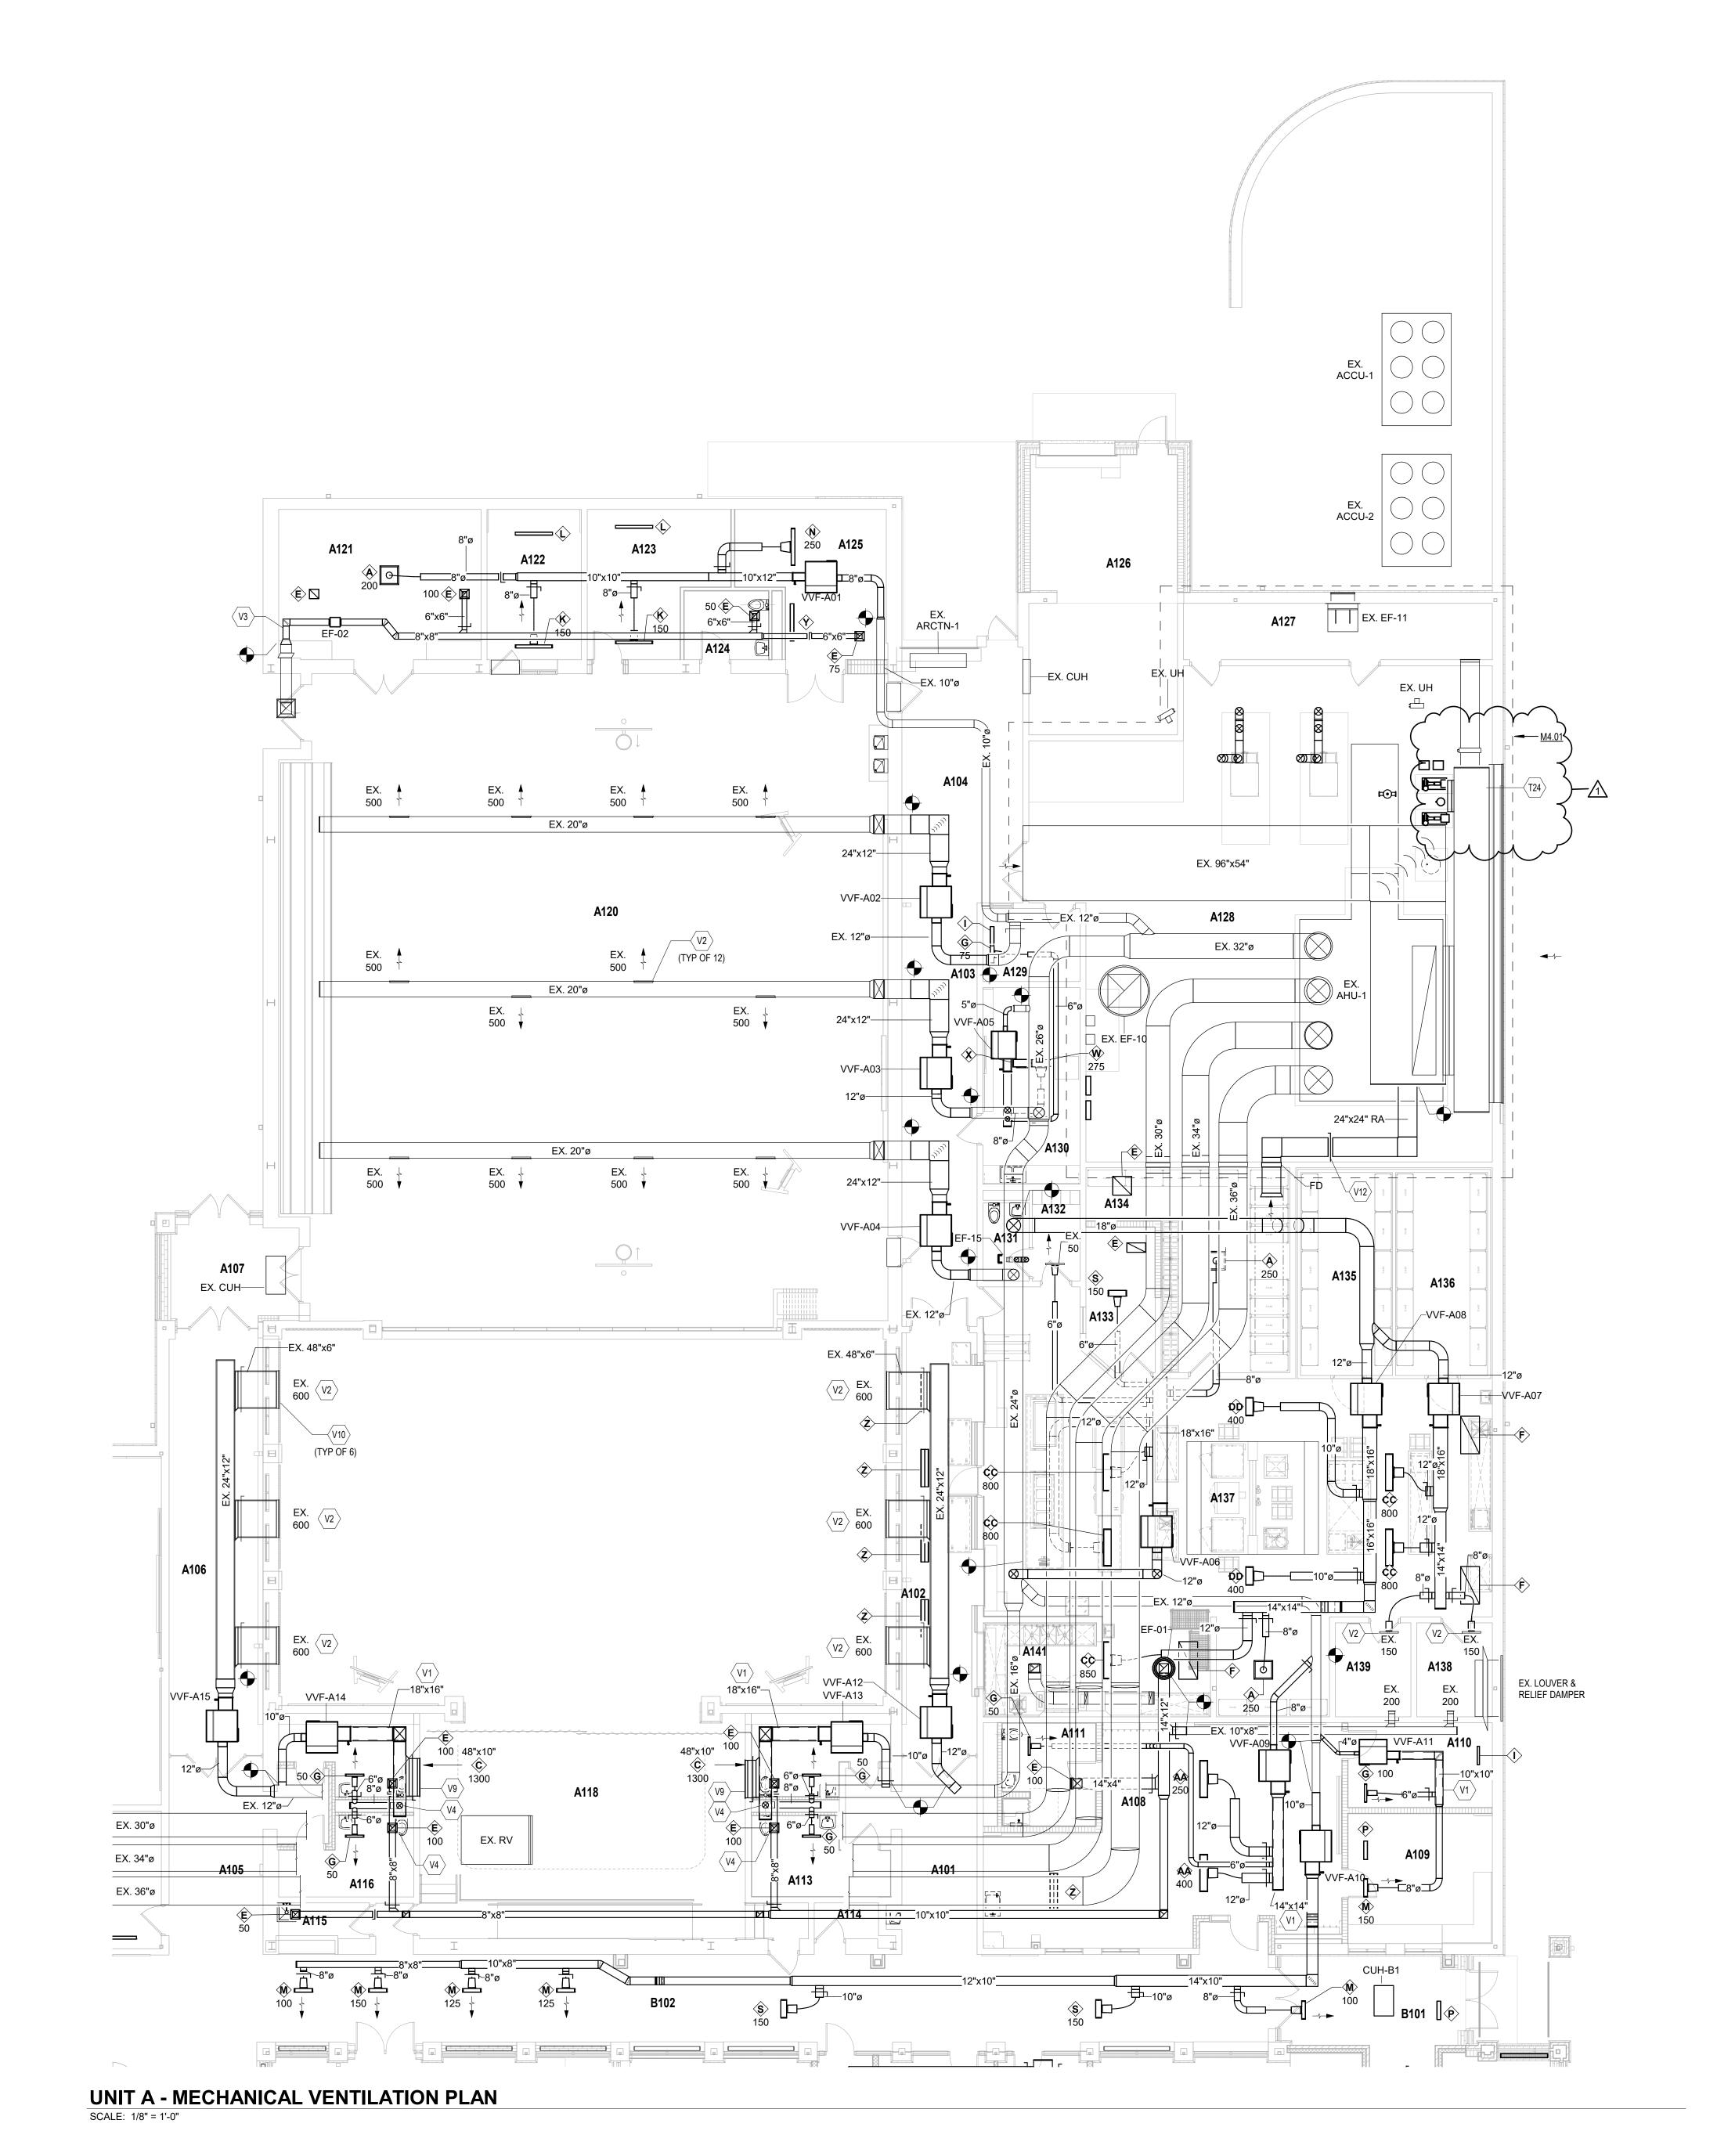
SCHOOL

PROJECT MANAGER: SAM DRAWN BY: AML PROJECT NUMBER: 222011.00

PROJECT ISSUE DATE: 02.09.2024

0.△	DESCRIPTION	DATE
	ADDENDUM #1	2.23.2024

LIST OF FINISHES



VENTILATION PLAN GENERAL NOTES

- ALL DUCTWORK, PIPING AND VALVES SHALL BE CONCEALED ABOVE THE CEILING AND WITHIN WALLS, UNLESS OTHERWISE NOTED.
- REFER TO THE SPECIFICATIONS FOR REQUIREMENTS RELATED TO EQUIPMENT QUALITY, CONSTRUCTION AND FINISH OF MATERIALS. ARRANGE DUCTWORK, PIPING, ETC. TO ALLOW FOR
- EASY ACCESS TO COILS, VALVES, DAMPERS AND CONTROLS. KEEP AREAS ADJACENT TO ACCESS PANELS FREE AND CLEAR OF ANY OBSTRUCTIONS. SEAL DUCT PENETRATIONS THROUGH THE FLOOR AND/OR WALLS IN ACCORDANCE WITH MECHANICAL CODE AND SMACNA REQUIREMENTS. SEAL DUCT PENETRATIONS THROUGH FIRE RATED FLOORS
- AND/OR WALLS WITH A MATERIAL HAVING SAME FIRE RATING AS THE WALL AND/OR FLOOR. MECHANICAL CONTRACTOR IS RESPONSIBLE FOR HIS RESPECTIVE WORK FOR REPAIRING AND PATCHING TO MATCH EXISTING SURFACES, SIDEWALKS, STREETS, FLOORS, WALLS, ROOFS, CEILING AND PAVEMENT. ALL RECTANGULAR SHEET METAL DUCT SIZES SHOWN
- ARE INSIDE FREE AREA DIMENSIONS. ALL ROUND DUCT SIZES SHOWN ARE INSIDE DIAMETERS. PROVIDE BALANCING DAMPER AT EACH DUCT BRANCH, SERVING DIFFUSER, GRILLE AND REGISTER.
- INSTALL WALL THERMOSTATS, TEMPERATURE SENSORS, HUMIDISTATS, ETC. 44" ABOVE THE FINISH FLOOR IN ACCORDANCE WITH ADA REQUIREMENTS. COORDINATE ALL REQUIRED WALL, ROOF AND FLOOR OPENINGS (BOTH DIMENSIONS AND LOCATIONS) WITH ALL OTHER TRADES. COORDINATE MECHANICAL SYSTEM INSTALLATION
- WITH STRUCTURE, FIRE PROTECTION AND LIGHTING PROVIDE ALL NECESSARY TRANSITIONS TO EQUIPMENT FROM SIZES SHOWN ON PLAN. THE CLEARANCE FOR THE DESIGNED FAN-POWERED VAV TERMINAL UNITS IS FROM THE BOTTOM OF THE UNIT. MECHANICAL CONTRACTOR IS RESPONSIBLE FOR COORDINATING APPROVED FAN-POWERED VAV

INSTALLATION.

VENTILATION PLAN NOTES

EXHAUST FAN.

(ALL NOTES MAY NOT BE INDICATED ON THIS SHEET)

T24 EXISTING OUTSIDE AIR PLENUM TO REMAIN. ALL EXISTING TEMPERATURE CONTROLS, DAMPER ACTUATORS, SENSORS, ETC. SHALL BE REMOVED AND REPLACED WITH NEW DDC CONTROLS, ACTUATORS, SENSORS, ETC. DUCTWORK PROVIDED WITH INTERNAL LINED INSULATION. REFER TO SPECIFICATIONS. EXISTING DIFFUSER TO REMAIN. BALANCE

VOLUME DAMPER TO CFM SHOWN.

V3 WRAP EXHAUST DUCTWORK WITH INSULATION FROM EXISTING BACKDRAFT DAMPER TO NEW

PROVIDE VOLUME DAMPER IN VERTICAL

DIFFUSER/GRILLE COLOR WITH ARCHITECT. /10 CONTRACTOR SHALL REMOVE EXISTING

DIFFUSER/GRILLE AND CLEAN TO LIKE NEW

CONDITION. CONTRACTOR SHALL PAINT DIFFUSER TO MATCH NEW WALL COLOR. COORDINATE FINAL COLOR WITH ARCHITECT.

V12 BALANCE DAMPER TO 6000 CFM. COORDINATE WITH STRUCTURAL STEEL IN AREA. PROVIDE FIRE DAMPER IN WALL PENETRATION.

V9 CONTRACTOR SHALL COORDINATE FINAL

DUCTWORK TO AIR DEVICE.

TERMINAL UNITS WITH ALL TRADES PRIOR TO

CHERRY TREE ELEMENTARY SCHOOL

ADDITIONS AND

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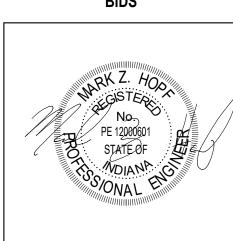
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CARMEL CLAY SCHOOLS



350 E. NEW YORK ST, INDIANAPOLIS IN 46204

KEY PLAN



PROJECT MANAGER: SAM DRAWN BY: DJA PROJECT NUMBER: 222011.00

PROJECT ISSUE DATE: 02.09.2024

NO.△	DESCRIPTION	DATE
1	ADDENDUM#1	2.23.2024
-		

1ST FLR VENTILATION PLAN - UNIT A CONTRACTOR SHALL VERIFY ALL DIMENSIONS AND CLEARANCES AND ALL EXISTING FIELD CONDITIONS BEFORE STARTING CONSTRUCTION. COMMENCEMENT OF WORK CONSTITUTES

VERIFICATION NOTE

ACCEPTANCE OF CONDITIONS.

SHOULD DIFFERENT CONDITIONS BE ENCOUNTERED, CONTACT

THE ARCHITECT BEFORE PROCEEDING WITH WORK.

VENTILATION PLAN GENERAL NOTES

- ALL DUCTWORK, PIPING AND VALVES SHALL BE CONCEALED ABOVE THE CEILING AND WITHIN WALLS, UNLESS OTHERWISE NOTED.
- REFER TO THE SPECIFICATIONS FOR REQUIREMENTS RELATED TO EQUIPMENT QUALITY, CONSTRUCTION AND FINISH OF MATERIALS. ARRANGE DUCTWORK, PIPING, ETC. TO ALLOW FOR EASY ACCESS TO COILS, VALVES, DAMPERS AND
- CONTROLS. KEEP AREAS ADJACENT TO ACCESS PANELS FREE AND CLEAR OF ANY OBSTRUCTIONS. SEAL DUCT PENETRATIONS THROUGH THE FLOOR AND/OR WALLS IN ACCORDANCE WITH MECHANICAL CODE AND SMACNA REQUIREMENTS. SEAL DUCT PENETRATIONS THROUGH FIRE RATED FLOORS AND/OR WALLS WITH A MATERIAL HAVING SAME FIRE RATING AS THE WALL AND/OR FLOOR. MECHANICAL CONTRACTOR IS RESPONSIBLE FOR HIS RESPECTIVE WORK FOR REPAIRING AND PATCHING TO
- MATCH EXISTING SURFACES, SIDEWALKS, STREETS, FLOORS, WALLS, ROOFS, CEILING AND PAVEMENT. ALL RECTANGULAR SHEET METAL DUCT SIZES SHOWN ARE INSIDE FREE AREA DIMENSIONS. ALL ROUND DUCT SIZES SHOWN ARE INSIDE DIAMETERS. PROVIDE BALANCING DAMPER AT EACH DUCT BRANCH,
- SERVING DIFFUSER, GRILLE AND REGISTER. INSTALL WALL THERMOSTATS, TEMPERATURE SENSORS, HUMIDISTATS, ETC. 44" ABOVE THE FINISH FLOOR IN ACCORDANCE WITH ADA REQUIREMENTS. COORDINATE ALL REQUIRED WALL, ROOF AND FLOOR OPENINGS (BOTH DIMENSIONS AND LOCATIONS) WITH ALL OTHER TRADES. COORDINATE MECHANICAL SYSTEM INSTALLATION
- WITH STRUCTURE, FIRE PROTECTION AND LIGHTING PROVIDE ALL NECESSARY TRANSITIONS TO EQUIPMENT FROM SIZES SHOWN ON PLAN. THE CLEARANCE FOR THE DESIGNED FAN-POWERED

TERMINAL UNITS WITH ALL TRADES PRIOR TO

INSTALLATION.

VENTILATION PLAN NOTES

(ALL NOTES MAY NOT BE INDICATED ON THIS SHEET)

HANDLING UNIT TO 4300 CFM. V6 APPROXIMATE LOCATION OF DUCT STATIC

V8 TRANSITION 6" ROUND DUCTWORK UP THROUGH ROOF. TERMINATE WITH

V11 AIR TRANSFER WALL OPENING LOCATED

LOCATION WITH ALL TRADES V14 ROUTE DUCTWORK BETWEEN/THROUGH

ABOVE THE CEILING. COORDINATE EXACT

STRUCTURAL STEEL. COORDINATE EXACT LOCATION WITH STRUCTURAL CONTRACTOR AND ALL OTHER TRADES.

PRESSURE SENSOR.

INSULATION. REFER TO SPECIFICATIONS. V2 EXISTING DIFFUSER TO REMAIN. BALANCE VOLUME DAMPER TO CFM SHOWN. V5 CONTRACTOR SHALL MODIFY EXISTING AIR

GOOSENECK. COORDINATE WITH STRUCTURAL

VAV TERMINAL UNITS IS FROM THE BOTTOM OF THE UNIT. MECHANICAL CONTRACTOR IS RESPONSIBLE FOR COORDINATING APPROVED FAN-POWERED VAV

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CHERRY TREE


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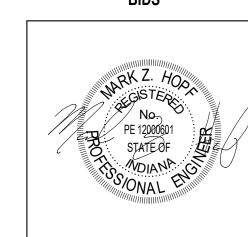
SCHOOL



350 E. NEW YORK ST, INDIANAPOLIS IN 46204

<u>CONSULTANT</u>

KEY PLAN

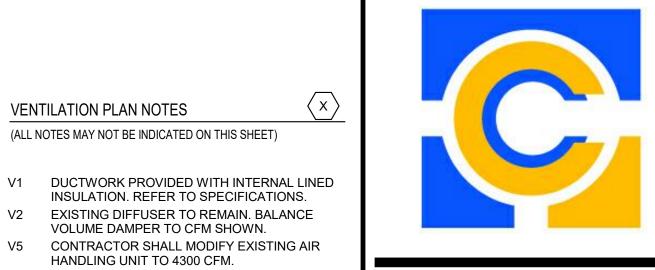

PROJECT MANAGER: SAM PROJECT NUMBER: 222011.00

PROJECT ISSUE DATE: 02.09.2024


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1	ADDENDUM#1	2.23.20

1ST FLR VENTILATION PLAN - UNIT B


ACCEPTANCE OF CONDITIONS. SHOULD DIFFERENT CONDITIONS BE ENCOUNTERED, CONTACT THE ARCHITECT BEFORE PROCEEDING WITH WORK.

UNIT B - MECHANICAL VENTILATION PLAN

SCALE: 1/8" = 1'-0"

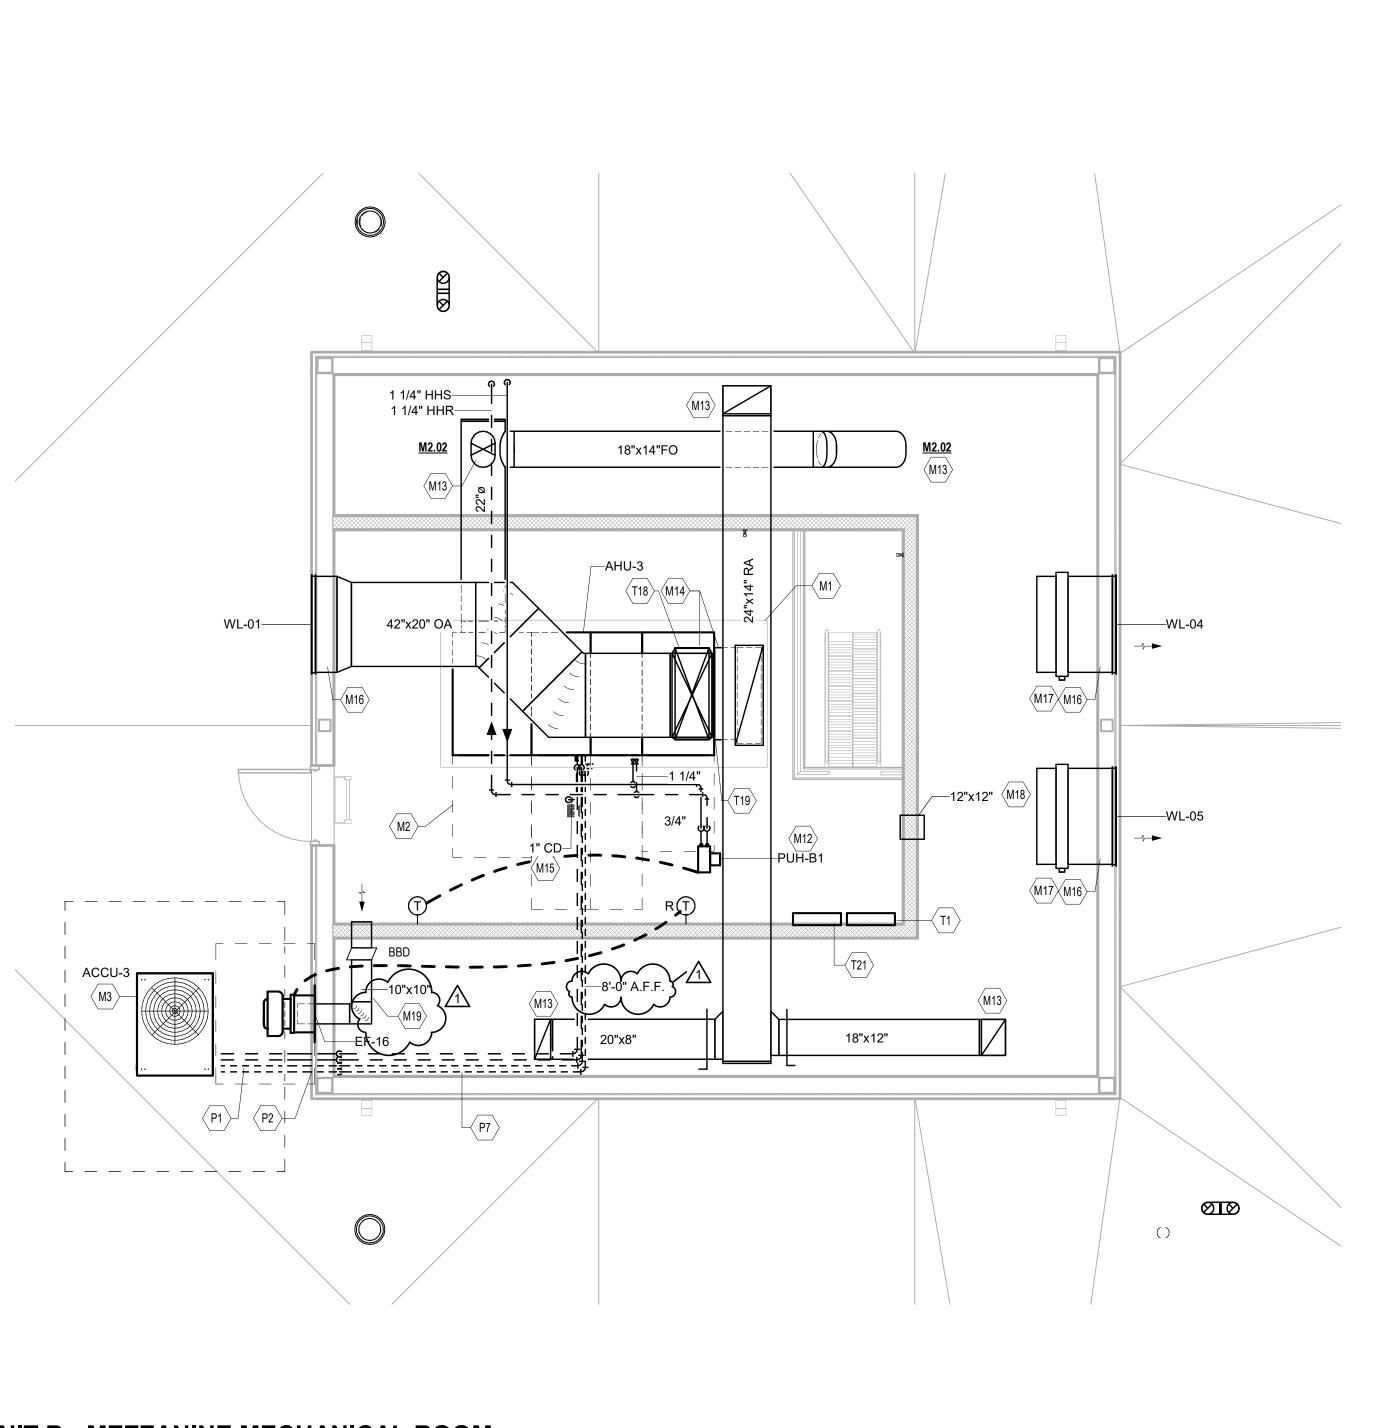

UNIT B - MEZZANINE MECHANICAL ROOM SCALE: 1/4" = 1'-0"

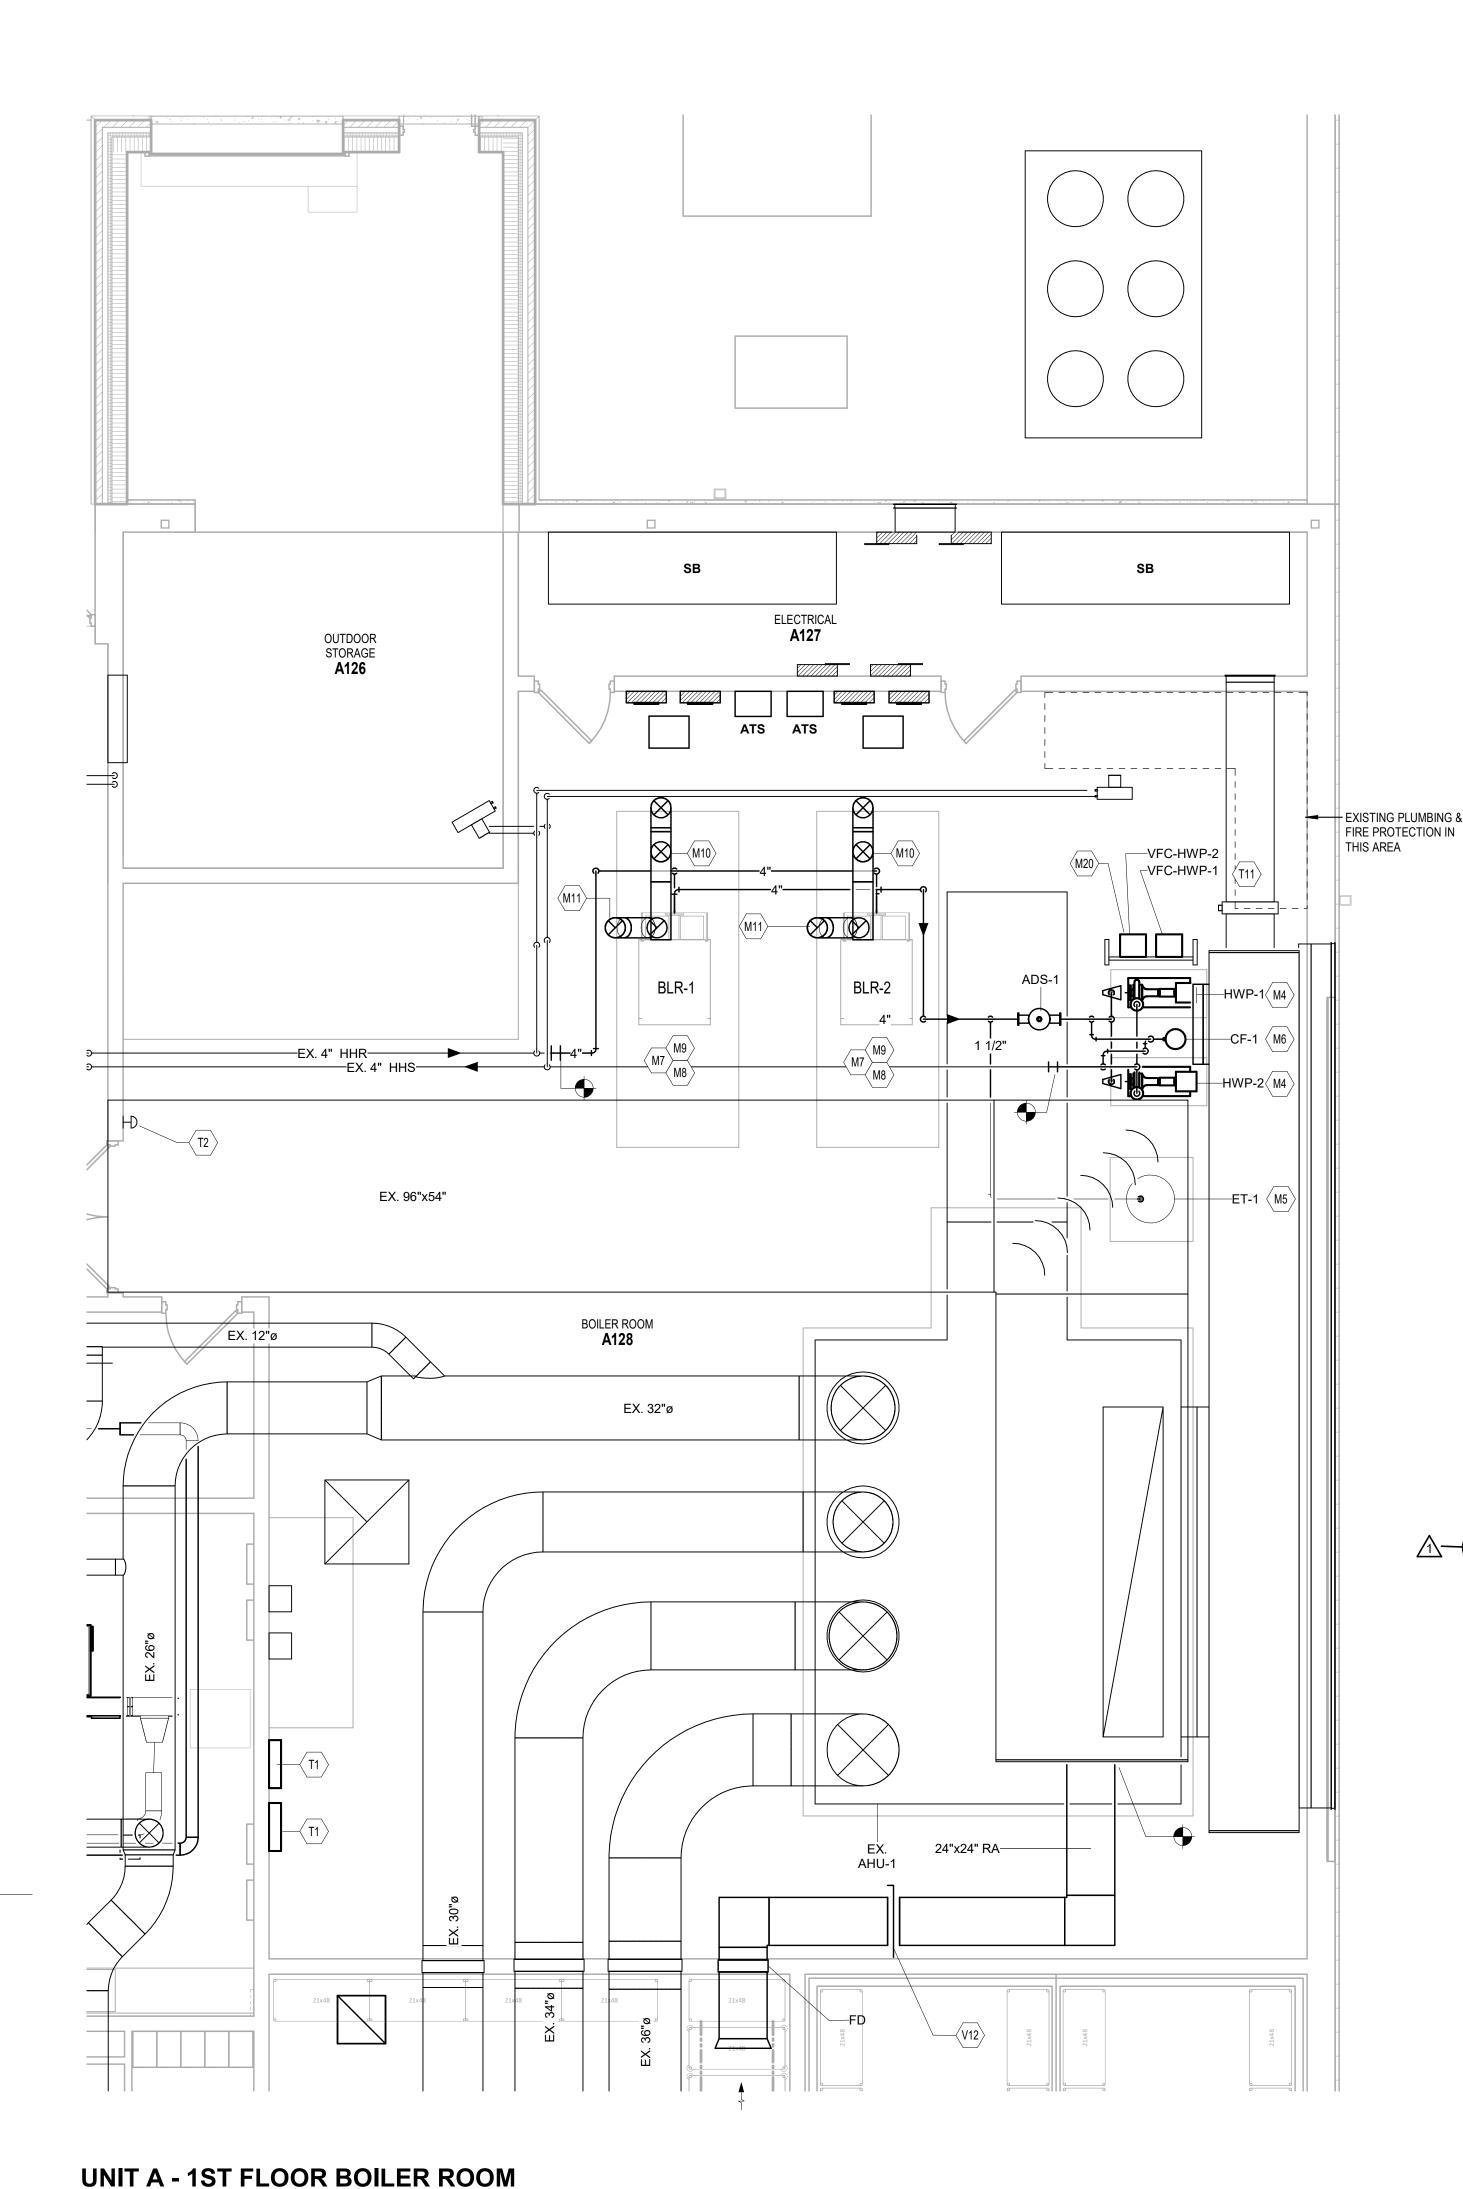

SCALE: 1/4" = 1'-0"

MECHANICAL ROOM PLAN GENERAL NOTES ALL DUCTWORK, PIPING AND VALVES SHALL BE CONCEALED

REFER TO THE SPECIFICATIONS FOR REQUIREMENTS RELATED TO EQUIPMENT QUALITY, CONSTRUCTION AND FINISH OF MATERIALS. ARRANGE DUCTWORK, PIPING, ETC. TO ALLOW FOR EASY ACCESS TO COILS, VALVES, DAMPERS AND CONTROLS. KEEP

OBSTRUCTIONS. SEAL DUCT PENETRATIONS THROUGH THE FLOOR AND/OR WALLS IN ACCORDANCE WITH MECHANICAL CODE AND SMACNA REQUIREMENTS. SEAL DUCT PENETRATIONS THROUGH FIRE RATED FLOORS AND/OR WALLS WITH A MATERIAL HAVING SAME FIRE RATING AS THE WALL AND/OR FLOOR. MECHANICAL CONTRACTOR IS RESPONSIBLE FOR HIS RESPECTIVE WORK FOR REPAIRING AND PATCHING TO MATCH EXISTING SURFACES, SIDEWALKS, STREETS, FLOORS, WALLS, ROOFS, CEILING AND PAVEMENT. ALL RECTANGULAR SHEET METAL DUCT SIZES SHOWN ARE

INSIDE FREE AREA DIMENSIONS. ALL ROUND DUCT SIZES SHOWN ARE INSIDE DIAMETERS. PROVIDE BALANCING DAMPER AT EACH DUCT BRANCH, SERVIN DIFFUSER, GRILLE AND REGISTER.

INSTALL WALL THERMOSTATS, TEMPERATURE SENSORS, HUMIDISTATS, ETC. 44" ABOVE THE FINISH FLOOR IN ACCORDANCE WITH ADA REQUIREMENTS. COORDINATE ALL REQUIRED WALL, ROOF AND FLOOR OPENINGS (BOTH DIMENSIONS AND LOCATIONS) WITH ALL OTHER TRADES. COORDINATE MECHANICAL SYSTEM INSTALLATION WITH STRUCTURE, FIRE PROTECTION AND LIGHTING LAYOUT. PROVIDE ALL NECESSARY TRANSITIONS TO EQUIPMENT FROM

SIZES SHOWN ON PLAN. HYDRONIC SUPPLY AND RETURN PIPING SHALL BE THE SAME SIZE UNLESS OTHERWISE NOTED.

MECHANICAL ROOM PLAN NOTES (ALL NOTES MAY NOT BE INDICATED ON THIS SHEET)

INSTALL EQUIPMENT ON 6" HIGH CONCRETE HOUSEKEEPING PAD. M2 CLEARANCE REQUIRED FOR AIR HANDLING UNIT

COIL PULLS. NEW CONDENSING UNIT MOUNTED ON ROOF. ROUTE REFRIGERANT PIPING FROM OUTDOOR UNIT TO INDOOR AIR HANDLING UNIT PER MANUFACTURERS GUIDE. INSTALLED ON ROOF

SUPPORT RAILS WITH VIBRATION ISOLATORS. NEW BASE MOUNTED PUMP ON EXISTING CONCRETE BASE. ANCHOR TO CONCRETE BASE. PROVIDE NEW VERTICAL EXPANSION TANK ON EXISTING CONCRETE PAD HOUSEKEEPING PAD. PRIOR TO BOILER OPERATION, ENSURE INSTALLATION OF NEW EXPANSION TANKS. REFER

REINFORCE AND EXTEND CONCRETE SUPPORT PAI FOR EQUIPMENT. CONTRACTOR SHALL PROVIDE CHEMICAL SHOT FEEDER WITH INTEGRAL BAG FILTER. SEE SPECIFCATIONS FOR ADDITIONAL REQUIREMENTS.

NATURAL GAS TRAIN APPROVED BY FACTORY MUTUAL (FM). DIVISION 22 PLUMBING CONTRACTOR TO INSTALL NATURAL GAS PIPING TO END OF GAS TRAIN. REFER TO DETAIL.

PROVIDE AND INSTALL PRESSURE RELIEF VALVE TO BOILER. REFER TO BOILER MANUFACTURER FOR RECOMMENDED LOCATION. PIPE FULL SIZE TO FLOOR DRAIN. SUPPORT PIPING INDEPENDENTLY OF VALVE TO PREVENT STRESS AND TO ALLOW PROPER OPERATION. PROVIDE AND INSTALL CONDENSATE PIPING, TRAP

ASSEMBLY, AND CONDENSATE NEUTRALIZER KIT PER MANUFACTURERS REQUIREMENTS (FOR EACH BOILER). ROUTE CONDENSATE PIPING TO NEAREST FLOOR DRAIN AS SHOWN ON DRAWINGS. PROVIDE PIT FOR NEUTRALIZATION KIT AND SUPPORT FOR CONDENSATE TRAP AS NECESSARY. M10 PROVIDE AND INSTALL 10" COMBUSTION AIR INLET PER MANUFACTURER REQUIREMENTS (FOR EACH BOILER). TERMINATE COMBUSTION AIR INLET WITH

INSTALLATION PER MANUFACTURERS

GOOSENECK. REFER TO DETAIL. PIPE SIZE AND

REQUIREMENTS. COORDINATE ALL ROOF WORK

WITH OWNER AND ROOFING PROVIDER TO MAINTAIN EXISTING ROOFING WARRANT. M11 PROVIDE AND INSTALL 10" EXHAUST VENT WITH A MINIMUM 1/4 INCH PER FOOT PITCH UPWARDS PER MANUFACTURERS REQUIREMENTS (FOR EACH BOILER). EXHAUST VENT MUST BE 3 FEET ABOVE THE COMBUSTION AIR INLET, AND 2 FEET ABOVE ANY HIGHER PORTION OF THE BUILDING WITHIN 10 FEET. TERMINATE THE VENT WITH AN SUPPORT COLLAR, ROOF FLASHING, AND VELOCITY CONE.

ROOFING WARRANT. M12 SUPPORT UNIT HEATER FROM STRUCTURE ABOVE WITH SUPPLEMENTAL STEEL AND THREADED ROD

DRAIN PIPING AND TRAP SIZED PER MANUFACTURERS REQUIREMENTS. REFER TO

BEHIND WALL LOUVER. TRANSITION BOTTOM OF DUCT AT A SLOPE DOWNWARD TO WALL LOUVER. SEAL ALL SEAMS AND EDGES WATER TIGHT. WRAP PLENUM WITH INSULATION. REFER TO DETAIL. M18 AIR TRANSFER WALL OPENING LOCATED ABOVE THE CEILING. COORDINATE EXACT LOCATION WITH ALL RADES. END OF DUCT OPEN TO SPACE, PROFECT OPENING TO BE PROTECTED WITH BIRDS TREEN. M19 WRAP EXHAUST DUCTWORK WITH INSULATION

M20 CONTRACTOR SHALL MOUNT VARIABLE PREQUENCY CONTROLLER ON A UNISTRUT STYLE RACK IN THIS GENERAL LOCATION IF THERE IS NO WALL SPACE AVAILABLE IN THE AREA. FIELD VERIFY FINAL LOCATION WITH OWNER. PROVIDE DRAIN PAN FOR

ROUTE REFRIGERANT PIPING FROM OUTDOOR UNIT TO INDOOR EVAPORATOR PER MANUFACTURERS GUIDE. REFRIGERANT PIPING AND ACCESSORIES TO BE SIZED PER UNIT MANUFACTURERS REQUIREMENTS. ALL PIPING ON THE EXTERIOR OF THE BUILDING SHALL BE WRAPPED WITH INSULATION AND THEN COVERED WITH A PVC JACKET PER THE PROJECT MANUAL. PROVIDE PIPE SUPPORTS AS REQUIRED TO PROPERLY SUPPORT THE PIPING.

MANUFACTURER'S RECOMMENDATIONS.

SWITCH PROVIDED AND INSTALLED BY TEMPERATURE CONTROL CONTRACTOR.

EQUIPMENT. T18 OUTSIDE AIR CONTROL DAMPER SHALL BE FACTORY MOUNTED IN AIR HANDLING UNIT. DAMPER OPERATORS PROVIDED BY TEMPERATURE

CONTROL CONTRACTOR. T19 RETURN AIR CONTROL DAMPER SHALL BE FACTORY MOUNTED IN AIR HANDLING UNIT. DAMPER OPERATORS PROVIDED BY TEMPERATURE CONTROL CONTRACTOR.

T21 PROVIDE NEW BUILDING AUTOMATION SYSTEM IN THIS AREA.

DATE NO. DESCRIPTION 1 ADDENDUM#1 2.23.2024

BOILER ROOM AND MECHANICAL MEZZANINE

ABOVE THE CEILING AND WITHIN WALLS, UNLESS OTHERWISE AREAS ADJACENT TO ACCESS PANELS FREE AND CLEAR OF ANY CHERRY TREE ELEMENTARY SCHOOL **ADDITIONS AND**

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KEY PLAN

PROJECT MANAGER: SAM

PROJECT NUMBER: 222011.00

PROJECT ISSUE DATE: 02.09.2024

DRAWN BY: DJA

COORDINATE ALL ROOF WORK WITH OWNER AND ROOFING PROVIDER TO MAINTAIN EXISTING AS REQUIRED. COORDINATE FINAL HEIGHT IN FIELD.

M13 DUCT ROUTED DOWN TO FLOOR BELOW. COORDINATE WITH STRUCTURAL STEEL IN AREA. M15 CONDENSATE DRAIN PIPING WITH WATER SEAL TRAP FROM UNIT TO NEAREST FLOOR DRAIN. CUT END OF PIPE AT A 45 DEGREE ANGLE. CONDENSATE

M16 INSULATED SHEET METAL PLENUM MOUNTED

FROM BACKDRAFT DAMPER TO THE WALL MOUNTED

ALL PIPING ABOVE VFDs

PROVIDE WALL SLEEVES FOR REFRIGERANT PIPING SEAL BOTH SIDES OF THE WALL WATERTIGHT. INSTALL ALL REFRIGERANT PIPING PER THE

APPROXIMATE LOCATION OF TEMPERATURE CONTROL PANEL. COORDINATE EXACT LOCATION WITH ALL TRADES. APPROXIMATE LOCATION OF BOILER SHUT-DOWN

T11 TEMPERATURE CONTROL CONTRACTOR SHALL PROVIDE INTERCONNECTING WIRING BETWEEN VARIABLE FREQUENCY CONTROLLER(S) AND

CONSTITUTES ACCEPTANCE OF CONDITIONS.

THE ARCHITECT BEFORE PROCEEDING WITH WORK.

SHOULD DIFFERENT CONDITIONS BE ENCOUNTERED, CONTACT

V12 BALANCE DAMPER TO 6000 CFM. COORDINATE WITH STRUCTURAL STEEL IN AREA. PROVIDE FIRE DAMPER IN WALL PENETRATION.

VERIFICATION NOTE CONTRACTOR SHALL VERIFY ALL DIMENSIONS AND CLEARANCES AND ALL EXISTING FIELD CONDITIONS BEFORE STARTING CONSTRUCTION. COMMENCEMENT OF WORK

	ASSOCAITED	TOTAL	SUCTION	AMBIENT	UI	NIT ELE	C. DATA		WEIGHT	СО	MPRES	SOR	
MARK	EQUIPMENT	MBH	TEMP	TEMP	VOLTS	PH.	MCA	MCA	(LBS)	STAGES	QTY	REFRIGERANT	NOTES
ACCU-3	AHU-3	145.1	115	45.0	460	3	25	30	459.0	2	2	R-410A	1,2,3,4,5,6,7
ACCU-4	AHU-2	130.0	115	45.0	460	3	28	35	459.0	2	2	R-410A	1,2,3,4,6,7
ACCU-5	FCU-1	63.9	115	40.2	460	3	11	15	241.0	1	1	R-410A	1,2,3,4,6,7

- 1. CONDENSING UNIT AS MANUFACTURED BY TRANE.
- 2. REFER TO PROJECT MANUAL FOR ADDITIONAL REQUIREMENTS.
- 3. INCLUDE THE FOLLOWING ACCESSORIES, HIGH AMBIENT UNLOADER PRESSURE STAT, PROTECTIVE COIL GUARDS COMPLETELY AROUND ENTIRE UNIT, PHASE LOSS/VOLTAGE PROTECTION AND VIBRATION ISOLATORS.
- 4. UNIT SHALL INCLUDE FROST PREVENTION DEVICE TO BE INSTALLED AT COIL.
- 5. UNIT SHALL BE INSTALLED ON ROOF SUPPORT RAILS WITH VIBRATION ISOLATORS. COORDINATE EXACT LOCATION IN FIELD.
- 6. SINGLE POINT POWER CONNECTION. UNIT MANUFACTURER SHALL PROVIDE FACTORY MOUNTED DISCONNECT SWITCH.
- 7. REFRIGERANT PIPING SIZE AND QUANTITY PER MANUFACTURER'S REQUIREMENTS.

	AIR HANDLING UNIT SCHEDULE
SUPPLY FAN DATA	HEATING HOT WATER COIL DATA

SUPPLY FAN DATA											HEATIN	G HOT V	WATER C	COIL DA	ГА					D)	X COIL E	ATA				EI	ECTRICAL				
TAG	LOCATION	MANF.	MODEL	TOTAL AIR (CFM)	OUTSIDE AIR (CFM)	EXT. S.P.	TOTAL S.P.	HP	HEATING MBH	GPM	HTG EAT (°F)	HTG LAT (°F)	HTG EWT (°F)	HTG LWT (°F)	WPD (FT.HD)	APD (IN WC)	FACE VELOCITY		SENSIBLE MBH	EAT DB (°F)	EAT WB (°F)	LAT LA DB W (°F) (°	D	PD FACE WC) VELOCIT	Y FLA	SCCR	VOLTS	ERVICE HZ	(LBS)		NOTES
AHU-3	MECHANICAL MEZZANINE	TRANE	CSAA010	4500	675	1.5	3.75	5	142	7.0	60.9	90.0	180.0	140.0	0.19	0.105	490	145.1	112.0	76.7	63.9	54 52	9 0.	92 463	6.7	5	460	60	3	1500	1,2,3,4,5,6,7,8,9,10,11

- 1. REFER TO PROJECT MANUAL SECTION 23 73 13 FOR ADDITIONAL DETAILS AND SECTION 23 09 93 FOR CONTROL
- REQUIREMENTS. 2. SUPPLY FAN MOTOR(S) CONTROLLED WITH VARIABLE FREQUENCY CONTROLLERS(S).
- 3. REFER TO PLANS AND SCHEMATIC SHEETS FOR UNIT LAYOUT DETAILS. 4. MAXIMUM FILTER FACE VELOCITY SHALL BE 550 FPM. 5. MAXIMUM COOLING COIL FACE VELOCITY SHALL BE 550 FPM.

- PROVIDE FACTORY MOUNTED CONVENIENCE OUTLETS AND INTERNAL LIGHTS AT EACH ACCESS DOOR. PROVIDE CONVENIENCE OUTLET AND LIGHTS ON SEPARATE CIRCUITS.
- 8. DIRECT EXPANSION REFRIGERANT COOLING COIL CONTAINS R410-A REFRIGERANT. 9. COORDINATE SHIPPING SPLITS WITH FIELD CONDITIONS.

10. SINGLE POINT ELECTRICAL CONNECTION TO UNITS.

11. UNIT SHALL INCLUDE FACTORY MOUNTED BELLMOUTH FITTINGS.

											CO	NDENSIN	IG BOILE	RS SCH	EDULE										
				HEA ⁻	ΓEXCHAN	GER CRIT	ERIA & PE	ERFORM	ANCE			DESIGN	N & RATED	HEATING	PERFORMANC	E		FUEL		ELECTRI	CAL CRITER	A & PERFO	RMANCE		
T 4.0	TAG MANUFACTURER MODEL			HHS	FLOW			W	PD	CAPA	CITY		MAXIMU	M	DECION					SINGLE	POINT		OPERATING		
TAG N	MANUFACTURER	MODEL NUMBER	SOLUTION	(%)	DESIGN	MIN	EWT	LWT	DESIGN	MAX	DESIGN	MIN	TEMP	RISE	PRESSURE	DESIGN EFFICIENCY	GAS TRAIN TYPE	MIN (IN.WC)	MAX	SEF	RVICE	FLA	MOCP	WEIGHT (LBS)	NOTES
		NUMBER	TYPE	, ,	(GPM)	(GPM)	(°F)	(°F)	(FT.HD)	(FT.HD)	(MBH)	(%)	(°F)	(°F)	(PSIG)	(%)	ITPE	(IIV.VVC)	(IN.WC)	(VOLTS)	(HZ) (PI	(AMPS)	(AMPS)	(LDC)	
BLR-1	CONDENSING BOILER	CFC-E-3000	WATER	0	141	0	140	180	10	12	3000	10%	210	60	125	94.0	FM	7	14	120	60 1	2	20	3500	1,2,3,4
		OI C-L-3000	***************************************		1-71	<u> </u>	140	100	10	12	3000	1070	0% 210 60 125	120	34.0	I IVI	,	17	460	60 3	4	20	3300	1,2,0,1	
BLR-2	CONDENSING BOILER	CFC-E-3000	WATER 0 14		141	0	140	180	10	12	3000	10%	210	60	125	94.0	FM	7	1.4	120	60 1	2	20	3500	1,2,3,4
		O1 O-L-3000	VV/XILIX		141	0	0 140 180 10 12 3000 10% 210		210	60	123	94.0	FIVI	'	14	460	60 3	4	20	3500	.,2,5,1				

- 1. REFER TO PROJECT MANUAL SECTION.
- 3. ELECTRICAL REQUIREMENTS VARY BY UNIT MANUFACTURER.

4. PROVIDE DEDICATED 120V POWER CONNECTION FOR CONTROL PANEL. 2. SINGLE POINT POWER CONNECTION

VARIABLE FREQUENCY CONTROLLER SCHEDULE														
	EQUIPMENT		SI	ERVICE										
MARK	SERVING	HP	(VOLT)	(HZ)	(PH)	NOTES								
VFC-HWP-1	HWP-1	5	460	60	3	1,2,3,4								
VFC-HWP-2	HWP-2	5	460	60	3	1,2,3,4								

- 1. DRIVE PROVIDED AND INSTALLED BY THE DIVISION 23 HVAC CONTRACTOR.
- 2. DIVISION 26 ELECTRICAL CONTRACTOR TO PROVIDE POWER WIRING TO VFC AND FROM VFC TO MOTOR.
- 3. PROVIDED WITH A FACTORY MOUNTED DISCONNECT.
- 4. REFER TO PROJECT MANUAL FOR ADDITIONAL REQUIREMENTS.

										ENERG	SY REC	COVERY	Y VENT	ILATOF	R SCHEDU	JLE													
	GENERAL DAT	A				SUPPLY F	AN DATA	1	E	XHAUS ⁻	Γ FAN DA	ATA						ENERGY	WHEEL	-					ELE	CTRICAL	-		
TAG	MANUFACTURER	MODEL NUMBER	TYPE	OPERATING WEIGHT (LB.)	CFM	ESP (IN.)		OTOR HP M	CA MOC	P CFM	ESP (IN.)	MOTOR HP	MCA	МОСР	OA DB WB	SA	ER/COOI R B DB	A	EA B WB	OA DB W		SA WB	RA	١	EA DB WB	VOLTS	HZ	PH	NOTES
ERV-1	GREENHECK	MINICORE-10-VG-P	INDOOR / HORIZONTAL	245	900	0.3	DIRECT	3/4 1	2.2 20	900	0.3	3/4	12.2	20	91.7 75.0	80.3 68	74.0	61.7 85	.3 69.4	-2.0 -3	4 41.9	34.9	72.0	55.9	28.9 28.8	208	60	1	1,2,3,4,5,6

- 1. REFER TO PROJECT MANUAL FOR ADDITIONAL REQUIREMENTS.
- 2. UNIT PROVIDED WITH FACTORY MOUNTED NON-FUSED DISCONNECT SWITCH. 3. FANS TO BE CONTROLLED BY BAS CONTRACTOR. INTERLOCK WITH FAN COIL UNIT.
- 4. UNIT PROVIDED WITH TWO MERV 8 FILTERS.
- 5. VIBRATION ISOLATORS TO BE PROVIDED BY THE MECHANICAL CONTRACTOR.
- 6. SEQUENCE INTAKE AND EXHAUST DAMPERS WITH ERV.

								FAN (COIL UN	NIT SCH	IEDULE	<u> </u>									
		SUPPI	_Y FAN			DX C	COOLING C	OIL				HE	ATING (COIL			UNI	TELE	EC. DA	TA	
MARK	CFM	EXT. S.P.	TOTAL S.P.	MOTOR HP	TOTAL (MBH)	SENS, (MBH)	EAT (DB/WB)	LAT (DB/WB)	APD	EAT	LAT	МВН	GPM	EWT LWT	APD	WPD	VOLTS	PH.	MCA	MCA	NOTES
FCU-1	1500	0.4	1.25	1	62.2	38.7	77.8/65.8	54.2/51.9	0.33	54.0	92.8	63.1	3.0	180	0.08	0.40	208	1	9.7	20	1,2,3
1. UNIT	NOTES: 1. UNIT TO BE INTERLOCKED WITH ERV-1. 2. UNIT WARNUFACTOR REACTORY MOUNTED DECONNECT SWITCH.																				

	PUMP SCHEDULE																
MARK SYSTEM SERVED					BHP@ DESIGN	DESIGN X		MOTOR			MODEL MANUF. NUMBER	MODEL NUMBER	WEIGHT	NOTES			
					FT.	%	FLOW	DISCH.	DIAMETER	RPM	HP	VOLT	PH		NOMBLIX	(LBS.)	.)
HWP-1	HEATING HOT WATER	VARIABLE PRIMARY	37	120	75	69	3.21	2.5x2	8.625	1800	5	460	3	BELL & GOSSETT	E-1510 2BD	270	1,2,3,4,5
HWP-2	HEATING HOT WATER	VARIABLE PRIMARY	37	120	75	69	3.21	2.5x2	8.625	1800	5	460	3	BELL & GOSSETT	E-1510 2BD	270	1,2,3,4,5
NOTES:																	

1. REFER TO PROJECT MANUAL SECTION 232123.

- 2. PUMP SHALL BE SELECTED WITH 100% WATER.
- 3. PUMP CONTROLLED BY VARIABLE FREQUENCY CONTROLLER.
- 4. PUMPS WILL OPERATE IN PARALLEL. PUMP SHALL BE SIZED SUCH THAT IT DOES NOT RUN OFF ITS CURVE, WHEN OPERATING ALONE OUT AT THE SYSTEM CURVE. 5. SINGLE POINT POWER CONNECTION TO THE PUMP. PUMP DISCONNECT AND WIRING BETWEEN PUMP AND VFC BY DIVISION 26.

	SPLIT SYSTEM SCHEDULE														
	EVAPORATOR BLOWER					CONDENSER SECTION									
MARK	CFM	EXT. S.P.	SENS. (MBH)	TOTAL (MBH)	EAT (DB/WB)	MANUFACTURER MODEL NUMBER	MARK	SEER	EAT	VOLTS	PH.	МОСР	MCA	MANUFACTURER MODEL NUMBER	NOTES
EVAP-1	635-705-775	0.2	21,000	30,000	80/67	TRANE TPKA0A0301KA70A	ACCU-6	19.8	95	208	1	25	19	TRANE TRUYA0301HA70NA	1-15

- 1. ENTERING AIR CONDITIONS 75 DB, 50% RH. 2. FURNISH WITH PRO-HEAT PLUS AND BASE PAN HEATER TO ACHIEVE OUTDOOR TEMPERATURE OPERATING RANGES: COOLING: 0°-115°F.
- 3. FURNISH WITH LOW AMBIENT CONTROL AND ADVANCED WIND BAFFLE KIT TO ACHIEVE OUTDOOR TEMPERATURE OPERATING RANGE: COOLING: -40°-115°F.
- 4. DIRECT DRIVE FAN. 5. EVAPORATOR SECTION COMPLETE WITH COIL, THERMOSTATIC EXPANSION VALVE AND FILTER
- 6. UNIT SHALL BE COMPLETE WITH REFIRGERANT PIPING PER MANUFACTURER'S RECOMMENDATIONS.
- 7. UNIT SELECTED WITH R410-A REFRIGERANT. 8. INDOOR UNIT TO BE WALL MOUNTED TYPE. SUPPORT UNIT FROM WALL BELOW CEILING. OUTDOOR UNIT SHALL BE MOUNTED ON EXISTING EQUIPMENT PAD SHOWN ON PLAN.
- 9. VARIABLE SPEED COMPRESSOR. 10. FURNISH WITH WIRELESS REMOTE CONTROLLER. 11. FURNISH WITH HAIL GUARDS.
- 12. UNIT SHALL INCLUDE SINGLE POINT POWER CONNECITON KIT. ELECTRICAL CONTRACTOR TO PROVIDE DISCONNECT SWITCH. 13. INCOMING POWER SHALL BE TO OUTDOOR UNIT. ELECTRICAL CONTRACTOR SHALL TAP OFF
- TO INDOOR UNIT. 14. UNIT SHALL BE PROVIDED WITH A CONDENSATE PUMP & OVERFLOW SWITCH, MOUNTED
- WITHIN THE UNIT COIL PAN. 120v./1 POWER; 8 FT. HEAD PUMP PRESSURE...

. REFER TO PROJECT MANUAL FOR ADDITIONAL INFORMATION.	

ROOFTOP VENTILATOR/INTAKE HOOD SCHEDULE									
MARK	THROAT LENGTH	THROAT WIDTH	MOTORIZED RELIEF CONTROL DAMPER	DRIP PAN	MODEL	NOTES			
RV-01	12	18	YES	NO	FGI-12x18	1,2,3,4			
RV-02	12	18	YES	NO	FGR-12x18	1,2,3,4			

NOTES:

- 1. REFER TO PROJECT MANUAL FOR ADDITIONAL REQUIREMENTS.
- 2. HOODS SCHEDULED ARE AS MANUFACTURED BY GREENHECK (FABRA HOOD)
- 3. HOODS TO BE MOUNTED ON MINIMUM 18" HIGH ROOF CURB. 4. PROVIDE CUSTOM COLOR TO MATCH EXISTING ROOF.

MARK	SIZE	TOP OF LOUVER	T) (DE	LC	DUVER PERF.		NOTEO
	WXH	ELEVATION	TYPE	FREE AREA (SQ.FT)	MAX AIRFLOW (CFM)	MAX VELOCITY (FT/MIN)	NOTES
WL-01	48" X 32"	20'-0" ABOVE 1ST FLOOR	INTAKE	4.8	4500	938	1,2,3,4,5,6,7
WL-04	48" X 32"	20'-0" ABOVE 1ST FLOOR	RELIEF	4.8	2250	469	1,2,3,4,5,6,7
WL-05	48" X 32"	20'-0" ABOVE 1ST FLOOR	RELIEF	4.8	2250	469	1,2,3,4,5,6,7

- 1. REFER TO PROJECT MANUAL SECTION 089119.
- 2. SEAL ALL AROUND WITH SILICONE. 3. REFER TO INSTALLATION DETAILS ON ARCHITECTURAL DRAWING.
- 4. CUSTOM COLOR AS SELECTED BY ARCHITECT/ENGINEER. 5. COORDINATE SIZE AND LOCATION WITH ALL TRADES.
- 6. INSTALL WALL LOUVER AS HIGH AS POSSIBLE. FIELD VERIFY EXACT ELEVATION.
- 7. DRIP PAN TO EXTEND A MINIMUM OF 6" ON EACH SIDE OF WALL LOUVER.

EXPANSION TANK/AIR SEPARATOR SYSTEM SYSTEM TEMP. | PRV FILL | MAX. OPERATING | TANK PRESSURE PSIG TANK ACCEPT. OPER. MANUFACTURER SYSTEM AT TANK RELIEF AT EXP. VOLUME VOLUME WEIGHT NO. MIN. MAX. & MODEL NO. GAL. LBS. PSIG VALVE TANK GAL. HEATING

1. AIR SEPARATOR WITH STRAINER SHALL HAVE TANGENTIAL INLET AND OUTLET.

50 200

2. REFER TO SPECIFICATION 232113. 3. EXPANSION TANKS SHALL BE SELECTED WITH 100% WATER.

HOT WATER

ADS-1

	EXHAUST FAN SCHEDULE										
144514	MARK TYPE	0514	2014	EXT.	MAX.	EL	EC	CONTROL	MODEL	DRIVE	NOTES
MARK		CFM	RPM	S.P.	SONES	HP	SERV	CONTROL	WODLE	DRIVE	INOTES
EF-01	ROOF MOUNTED	950	1700	0.30	10.2	1/4	120V	А	G-95-VG	DIRECT	1,2,4,5,6,7,8,9
EF-02	INLINE	225	1675	0.25	5.7	1/6	120V	А	SQ-70-VG	DIRECT	1,2,3,4,6,7,8
EF-04	INLINE	450	1450	0.30	6.5	1/4	120V	А	SQ-90-VG	DIRECT	1,2,3,4,6,7,8
EF-05	INLINE	1250	1525	0.375	10.9	1/4	120V	А	SQ-100-VG	DIRECT	1,2,3,4,6,7,8
EF-06	INLINE	600	1450	0.30	8.0	1/4	120V	А	SQ-95-VG	DIRECT	1,2,3,4,6,7,8
EF-07	INLINE	600	1450	0.30	8.0	1/4	120V	А	SQ-95-VG	DIRECT	1,2,3,4,6,7,8
EF-08	INLINE	200	1400	0.375	6.5	1/6	120V	А	SQ-80-VG	DIRECT	1,2,3,4,6,7,8
EF-12	INLINE	225	1425	0.375	6.5	1/6	120V	А	SQ-80-VG	DIRECT	1,2,3,4,6,7,8
EF-13	CEILING MOUNTED	75	900	0.125	2.0	0.16 A	120V	B.1	SP-B80	DIRECT	4,6

1/10 120V

75 900 0.125 2.0 0.16 A 120V

350 900 0.125 2.4

75 900 0.125 2.0 0.16 A 120V B.1

NOTES

EF-15

EF-16

1. INCLUDE FACTORY MOUNTED DISCONNECT SWITCH.

CEILING MOUNTED

CEILING MOUNTED

WALL MOUNTED

- 2. INCLUDE BACKDRAFT DAMPER.
- 3. SUPPORT FROM STRUCTURE ABOVE WITH VIBRATION ISOLATORS.
- 4. REFER TO PROJECT MANUAL FOR ADDITIONAL REQUIREMENTS.
- 5. MOUNT ON 12" HIGH ROOF CURB, UNLESS OTHERWISE NOTED.
- 6. ALL FAN MODELS SPECIFIED AS MANUFACTURED BY GREENHECK.
- 7. INCLUDE FACTORY MOUNTED AND WIRED SPEED CONTROL.
- 8. CUSTOM COLOR AS SELECTED BY ARCHITECT/ENGINEER. 9. MOUNT NEW EXHAUST FAN ON EXISTING ROOF CURB. EXISTING EXHAUST FAN TO BE REMOVED. MODIFY EXISTING ROOF CURB

AS REQUIRED TO INSTALL NEW EXHAUST FAN OR REPLACE WITH

NEW ROOF CURB. 10. PROVIDE SIDE WALL MOUNTING.

- CONTROL
- A AUTOMATIC OCCUPIED OPERATION BY LOCAL TEMPERATURE CONTROL ZONE. B MANUAL CONTROLS BY DIVISION 26.

SP-B80

CUE-90-VG

.1 WITH LOCAL SWITCH C AUTOMATIC OPERATION BY REVERSE ACTING THERMOSTAT D 24 HOUR CONTINUOUS OPERATION.

73.6

128.2

DIRECT

DIRECT

MECHANICAL SCHEDULES

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CHERRY TREE

ELEMENTARY

ADDITIONS AND

RENOVATIONS

13989 Hazel Dell Pkwy, Carmel, IN

CARMEL CLAY SCHOOLS

350 E. NEW YORK ST, INDIANAPOLIS IN 46204

CONSULTANT

KEY PLAN

PROJECT MANAGER: SAM

PROJECT NUMBER: 222011.00 PROJECT ISSUE DATE: 02.09.2024

1 ADDENDUM#1

DRAWN BY: DJA

REV.

BELL & GOSSETT

4,6


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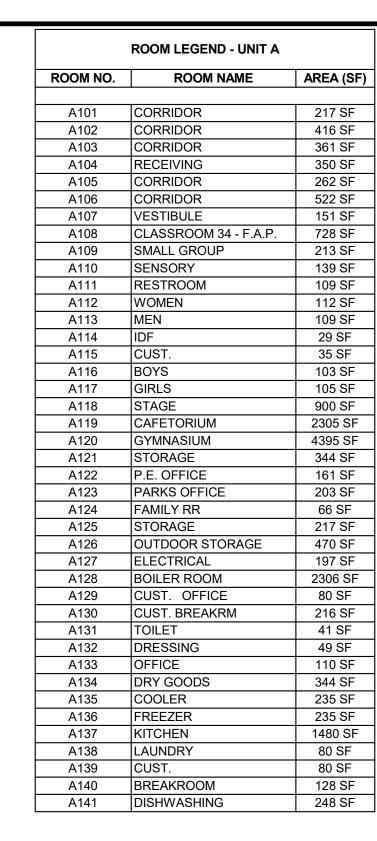
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SCHOOL

DESCRIPTION

DATE



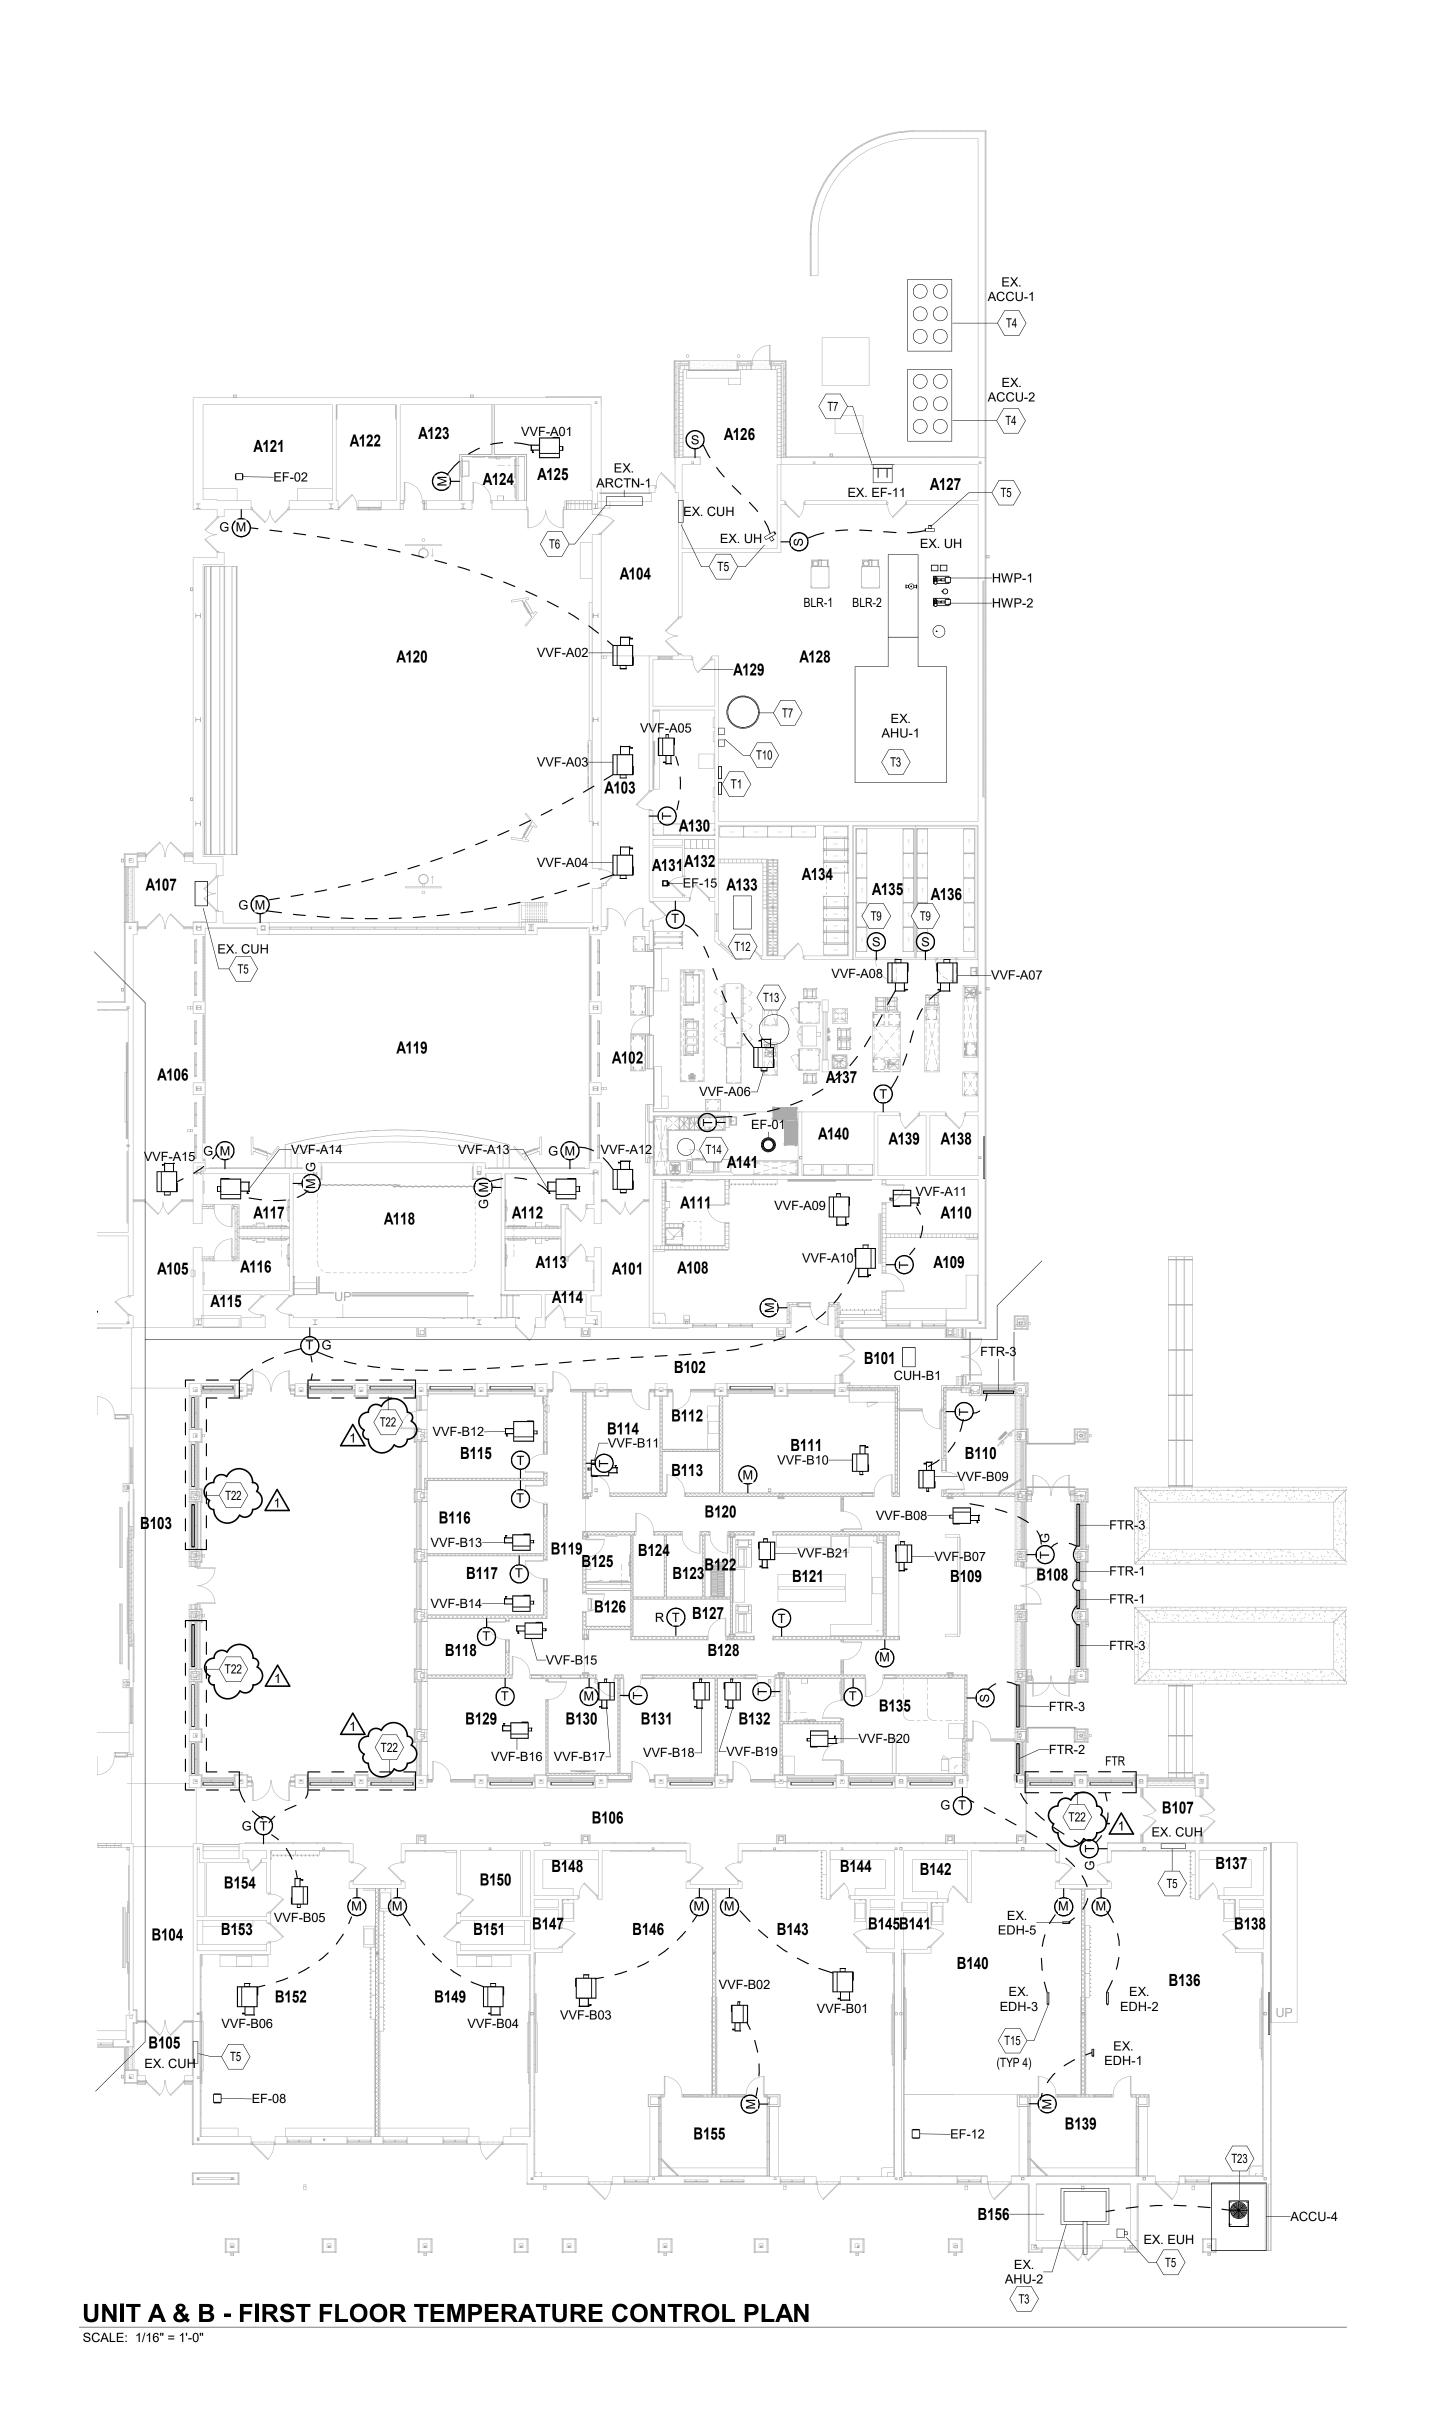

	ROOM LEGEND - UNIT B	
ROOM NO.	ROOM NAME	AREA (SF)
B101	VESTIBULE	216 SF
B102	CORRIDOR	1194 SF
B103	CORRIDOR	625 SF
B104	CORRIDOR	290 SF
B105	VESTIBULE	95 SF
B106	CORRIDOR	1738 SF
B107	VESTIBULE	89 SF
B108	SECURE VESTIBULE	253 SF
B109	RECEPTION	901 SF
B110	SRO OFFICE	189 SF
B111	LARGE CONFERENCE	477 SF
B112	MOTHERS	91 SF
B113	TEST STOR/ QUIET SPACE	65 SF
B114	SPEECH/HEARING	206 SF
B115	OT/PT OFFICE	272 SF
B116	SOCIAL WORKER	235 SF
B117	PSYCHOLOGIST	191 SF
B118	INST COACH OFFICE	123 SF
B119	CORRIDOR	343 SF
B120	CORRIDOR	248 SF
B121	WORKROOM	418 SF
B122	MEZZANINE	43 SF
B123	IDF	62 SF
B124	ELEC	53 SF
B125	RR	58 SF
B126	CALM	44 SF
B127	STORAGE	100 SF
B128	CORRIDOR	261 SF
B129	PRINCIPAL'S OFFICE	332 SF
B130	SMALL CONFERENCE	183 SF
B131	ASST PRINCIPAL'S OFFICE	262 SF
B132	E.C. SPEECH	174 SF
B133	RR	63 SF
B134	EXAM	84 SF
B135	CLINIC	315 SF
B136	KINDER - CR 1	1327 SF
B137	STORAGE	80 SF
B138	TOILET	26 SF
B139	SMALL GROUP	234 SF
B140	KINDER - CR 2	1321 SF
B141	TOILET	24 SF
B142	STORAGE	86 SF
B143	KINDER - CR 3	1329 SF
B144	STORAGE	80 SF
B145	TOILET	27 SF
B146	KINDER - CR 4	1327 SF 27 SF
B147	TOILET	
B148	STORAGE CB 5	80 SF
B149	EARLY CHILD - CR 5	963 SF
B150	RESTROOM	110 SF
B151	STORAGE	59 SF
B152	EARLY CHILD - CR 6	1161 SF
B153	STORAGE	59 SF
B154	RESTROOM	90 SF
B155 B156	SMALL GROUP MECH	234 SF 149 SF
		. 144.5E

TEMPERATURE CONTROL PLAN GENERAL NOTES REFER TO SECTION 23 05 00 GENERAL REQUIREMENTS

AND CONDITIONS FOR THE TRANSPORT, STORAGE, DEMOLITION, & INSTALLATION AS DESCRIBED HEREIN. REPLACE BUILDING TEMPERATURE CONTROLS: COMPLETE REPLACEMENT & UPGRADE OF EXISTING TO A MODERN ELECTRONIC DIRECT DIGITAL CONTROL

(DDC) SYSTEM & COMPONENTS; REPLACEMENT SHALL INCLUDE ITEMS SUCH AS, BUT MAY NOT BE LIMITED TO SHOWN & UNSHOWN, PNEUMATIC SYSTEM COMPRESSOR, COMPONENTS, & ACCESSORIES, EXPOSED PNEUMATIC TUBING, OPERATORS & ACTUATORS, LIMIT SWITCHES, SENSORS, CONTROLLED VALVES, VARIABLE FREQUENCY CONTROLLERS (VFCs / VFDs), LOGIC CONTROLLERS, & OPERATOR INTERFACES. FOR ALL BELOW INDICATED NOTES, ALSO REFER TO SECTIONS 230900 & 230993 FOR ADDITIONAL CLARIFICATION & REQUIREMENTS.

BUILDING HEATING & COOLING PLANT CONTROLS: TEMPERATURE CONTROL CONTRACTOR SHALL PROVIDE ITEMS SUCH AS, BUT NOT BE LIMITED TO, CONTROL EQUIPMENT, VALVES, ACTUATORS, SENSORS, DEVICES, COMPONENTS, & COORDINATION FOR NEW COMPLETE & FUNCTIONAL BUILDING TEMPERATURE CONTROL SYSTEM. **REMOVAL & SALVAGE**: UNLESS OTHERWISE NOTED,

CONTRACTOR IS RESPONSIBLE TO REMOVE ALL

UNUSED EQUIPMENT, COMPONENTS, MATERIALS, ETC. FROM SITE. IF ITEMS ARE OF REASONABLE QUALITY & CONDITION, CONFIRM ALL SALVAGED ITEMS w/OWNERS WRITTEN APPROVAL, LEAVE SALVAGED ITEMS IN UNOBSTRUCTING LOCATION NEAR AREA OF REMOVAL. EX. AIR HANDLER COIL CLEANING: EXISTING AIR HANDLER COILS SHALL BE THOROUGHLY SWEPT & THEN WET CLEANED WITH A FOAMING, BIODEGRADABLE, ALKALINE COIL CLEANER WITH EPA REGISTERED MOLD AND MILDEW INHIBITORS. PROTECT EQUIPMENT & ADJACENT AREAS FROM DAMAGE DURING CLEANING PROCEDURE. REPLACE FILTERS PRIOR TO REUSE OF EXISTING AIR HANDLERS EX. CABINET, CONVECTOR, & UNIT HEATER UPGRADES: REPLACEMENT & ADDITIONAL COMPONENTS SHALL NCLUDE, BUT MAY NOT BE LIMITED TO, TEMPERATURE

SENSOR (FLAT PLATE), UNIT CONTROLLER, HEATING CONTROL VALVE, FAN POWER RELAY SWITCH, MOTOR CURRENT SENSOR, WIRE & CABLING. EX. BUILDING EXHAUST FANS UPGRADES: REPLACEMENT & ADDITIONAL COMPONENTS SHALL INCLUDE, BUT MAY NOT BE LIMITED TO, UNIT CONTROLLER, MOTOR CURRENT SENSOR, FAN POWER RELAY SWITCH, TEMPERATURE SENSOR (FLAT PLATE) FOR TEMPERATURE-CONTROLLED FANS, SWITCHES FOR MANUALLY OPERATED FANS, WIRE & CABLING.

EX. WALL/ROOF VENTS: REPLACEMENT & ADDITIONAL COMPONENTS SHALL INCLUDE, BUT MAY NOT BE

LIMITED TO, UNIT CONTROLLER, PRESSURE SENSOR(S), WIRE & CABLING. TEMP CONTROL (WALL MTD) SENSORS/THERMOSTATS: ANTICIPATED REPLACEMENT LOCATIONS FOR EXISTING TEMPERATURE CONTROL SYSTEMS AMBIENT SENSORS & THERMOSTATIC CONTROLLERS ARE SHOWN; SOME OF THESE LOCATIONS MAY BE SHOWN WHERE AN EXISTING DEVICE LOCATION IS UNKNOW OR NOT CONFIRMED w/SITE CONDITIONS. REFER TO SECTIONS 23 09 00 & 23 09 93 FOR DEVICE REQUIREMENT(S) RELEVANT TO EQUIPMENT & ZONE INSTALLATIONS. WHERE NEW INSTALLATION LOCATIONS OF DEVICES ARE NECESSARY, CONTRACTOR IS RESPONSIBLE TO IDENTIFY MOST APPROPRIATE NEW DEVICE LOCATION, CONTACT PROJECT ENGINEER IF CLARIFICATION BECOMES NECESSARY. THE SCHOOL CURRENTLY UTILIZES A PNUEMATIC

TEMPERATURE CONTROLS SYSTEM RUN OFF JOHNSON CONTROLS CONTRACTOR SHALL PROVIDE ALL NEW WIRING, DEVICES AND COMPONENTS. ALL EXISTING TEMPERATURE CONTROLS MATERIAL REMOVED SHALL BE DISPOSED OF OFFSITE

TEMPERATURE CONTROL PLAN NOTES (ALL NOTES MAY NOT BE INDICATED ON THIS SHEET)

T3 REMOVE ALL EXISTING AIR HANDLING UNIT CONTROLS, SENSORS, SAFETIES, DAMPER OPERATORS AND CONTROL ACCESSORIES. EXISTING UNIT CONTROL DAMPERS TO REMAIN IN PLACE. DISPOSE OF MATERIAL OFF SITE. PROVIDE NEW CONTROLS, SENSORS. SAFETIES, CONTROL DAMPER OPERATORS,

CONNECT EXISTING AIR COOLED CONDENSING UNIT INTO NEW BAS. PROVIDE NEW CONTROLS

IF REQUIRED. EXISTING UNIT HEATER EQUIPMENT TO REMAIN. ALL EXISTING TEMPERATURE CONTROLS, VALVES, SENSORS, ETC. SHALL BE

EXISTING AIR CURTAIN TO REMAIN IN PLACE. ALL EXISTING TEMPERATURE CONTROLS. VALVES, SENSORS, ETC. SHALL BE REMOVED AND REPLACED WITH NEW DDC CONTROLS, VALVES, SENSORS, ETC.

T9 PROVIDE TEMPERATURE SENSOR IN NEW

KITCHEN EQUIPMENT. COORDINATE WITH KITCHEN CONSULTANT FOR ADDITIONAL

T14 DISHWASHER EXHAUST FAN. SEQUENCE WITH DISHWASHER. COORDINATE WITH KITCHEN CONSULTANT FOR ADDITIONAL INFORMATION. 15 EXISTING DUCT MOUNTED ELECTRIC HEATER TO REMAIN IN PLACE. REMOVE ASSOCIATED CONTROLS SENSORS ETC CONTROLS, STENSORS, ETC. EXISTING FIN-TUBE(S) TO REMAIN IN PLACE.

VALVES ETC. SHALL BE REMOVED. DISPOSE OF ALL MEATERIAL OFF SITE. PROVIDE NEW CONTROLS, CONTROL VALVES, ISOLATION VALVES, ETC. AS REQUIRED TO BEST CONTROL NEW FIN-TUBE/LAYOUT. 23 TEMPERATURE CONTROL CONTRACTOR SHA PROVIDE INTERCONNECTING CONTROL WIRING TO OUTDOOR CONDENSING UNIT.

| CHERRY TREE **ELEMENTARY** SCHOOL **ADDITIONS AND**

13989 Hazel Dell Pkwy, Carmel, IN

RENOVATIONS

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CARMEL CLAY SCHOOLS





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REMOVED AND REPLACED WITH NEW DDC CONTROLS, VALVES, SENSORS, ETC


NEXISTING EXHAUST FANTO REMAINING PLACE. BE REMOVED AND REPLACED WITH NEW DDC

WALK-IN COOLER/FREEZER FOR MONITORING THROUGH BAS. T10 EXISTING VFD'S TO REMAIN. TIE INTO NEW BAS.

T12 MAKE-UP AIR UNIT. COORDINATE WITH KITCHEN CONSULTANT FOR ADDITIONAL INFORMATION. T13 KITCHEN EXHAUST FAN. SEQUENCE WITH INFORMATION.

ALL EXISTING TEMPERATURE CONTROLS.

KEY PLAN

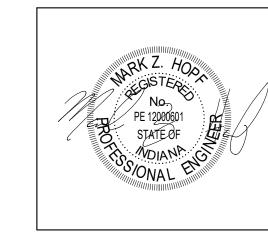

PROJECT MANAGER: SAM DRAWN BY: DJA PROJECT NUMBER: 222011.00

PROJECT ISSUE DATE: 02.09.2024


REV. NO.△	DESCRIPTION	DATE
1	ADDENDUM#1	2.23.2024
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VERIFICATION NOTE

CONTRACTOR SHALL VERIFY ALL DIMENSIONS AND CLEARANCES AND ALL EXISTING FIELD CONDITIONS BEFORE STARTING CONSTRUCTION. COMMENCEMENT OF WORK CONSTITUTES ACCEPTANCE OF CONDITIONS.

SHOULD DIFFERENT CONDITIONS BE ENCOUNTERED, CONTACT THE ARCHITECT BEFORE PROCEEDING WITH WORK.

1ST FLR TEMPERATURE CONTROL PLAN - UNIT A & B

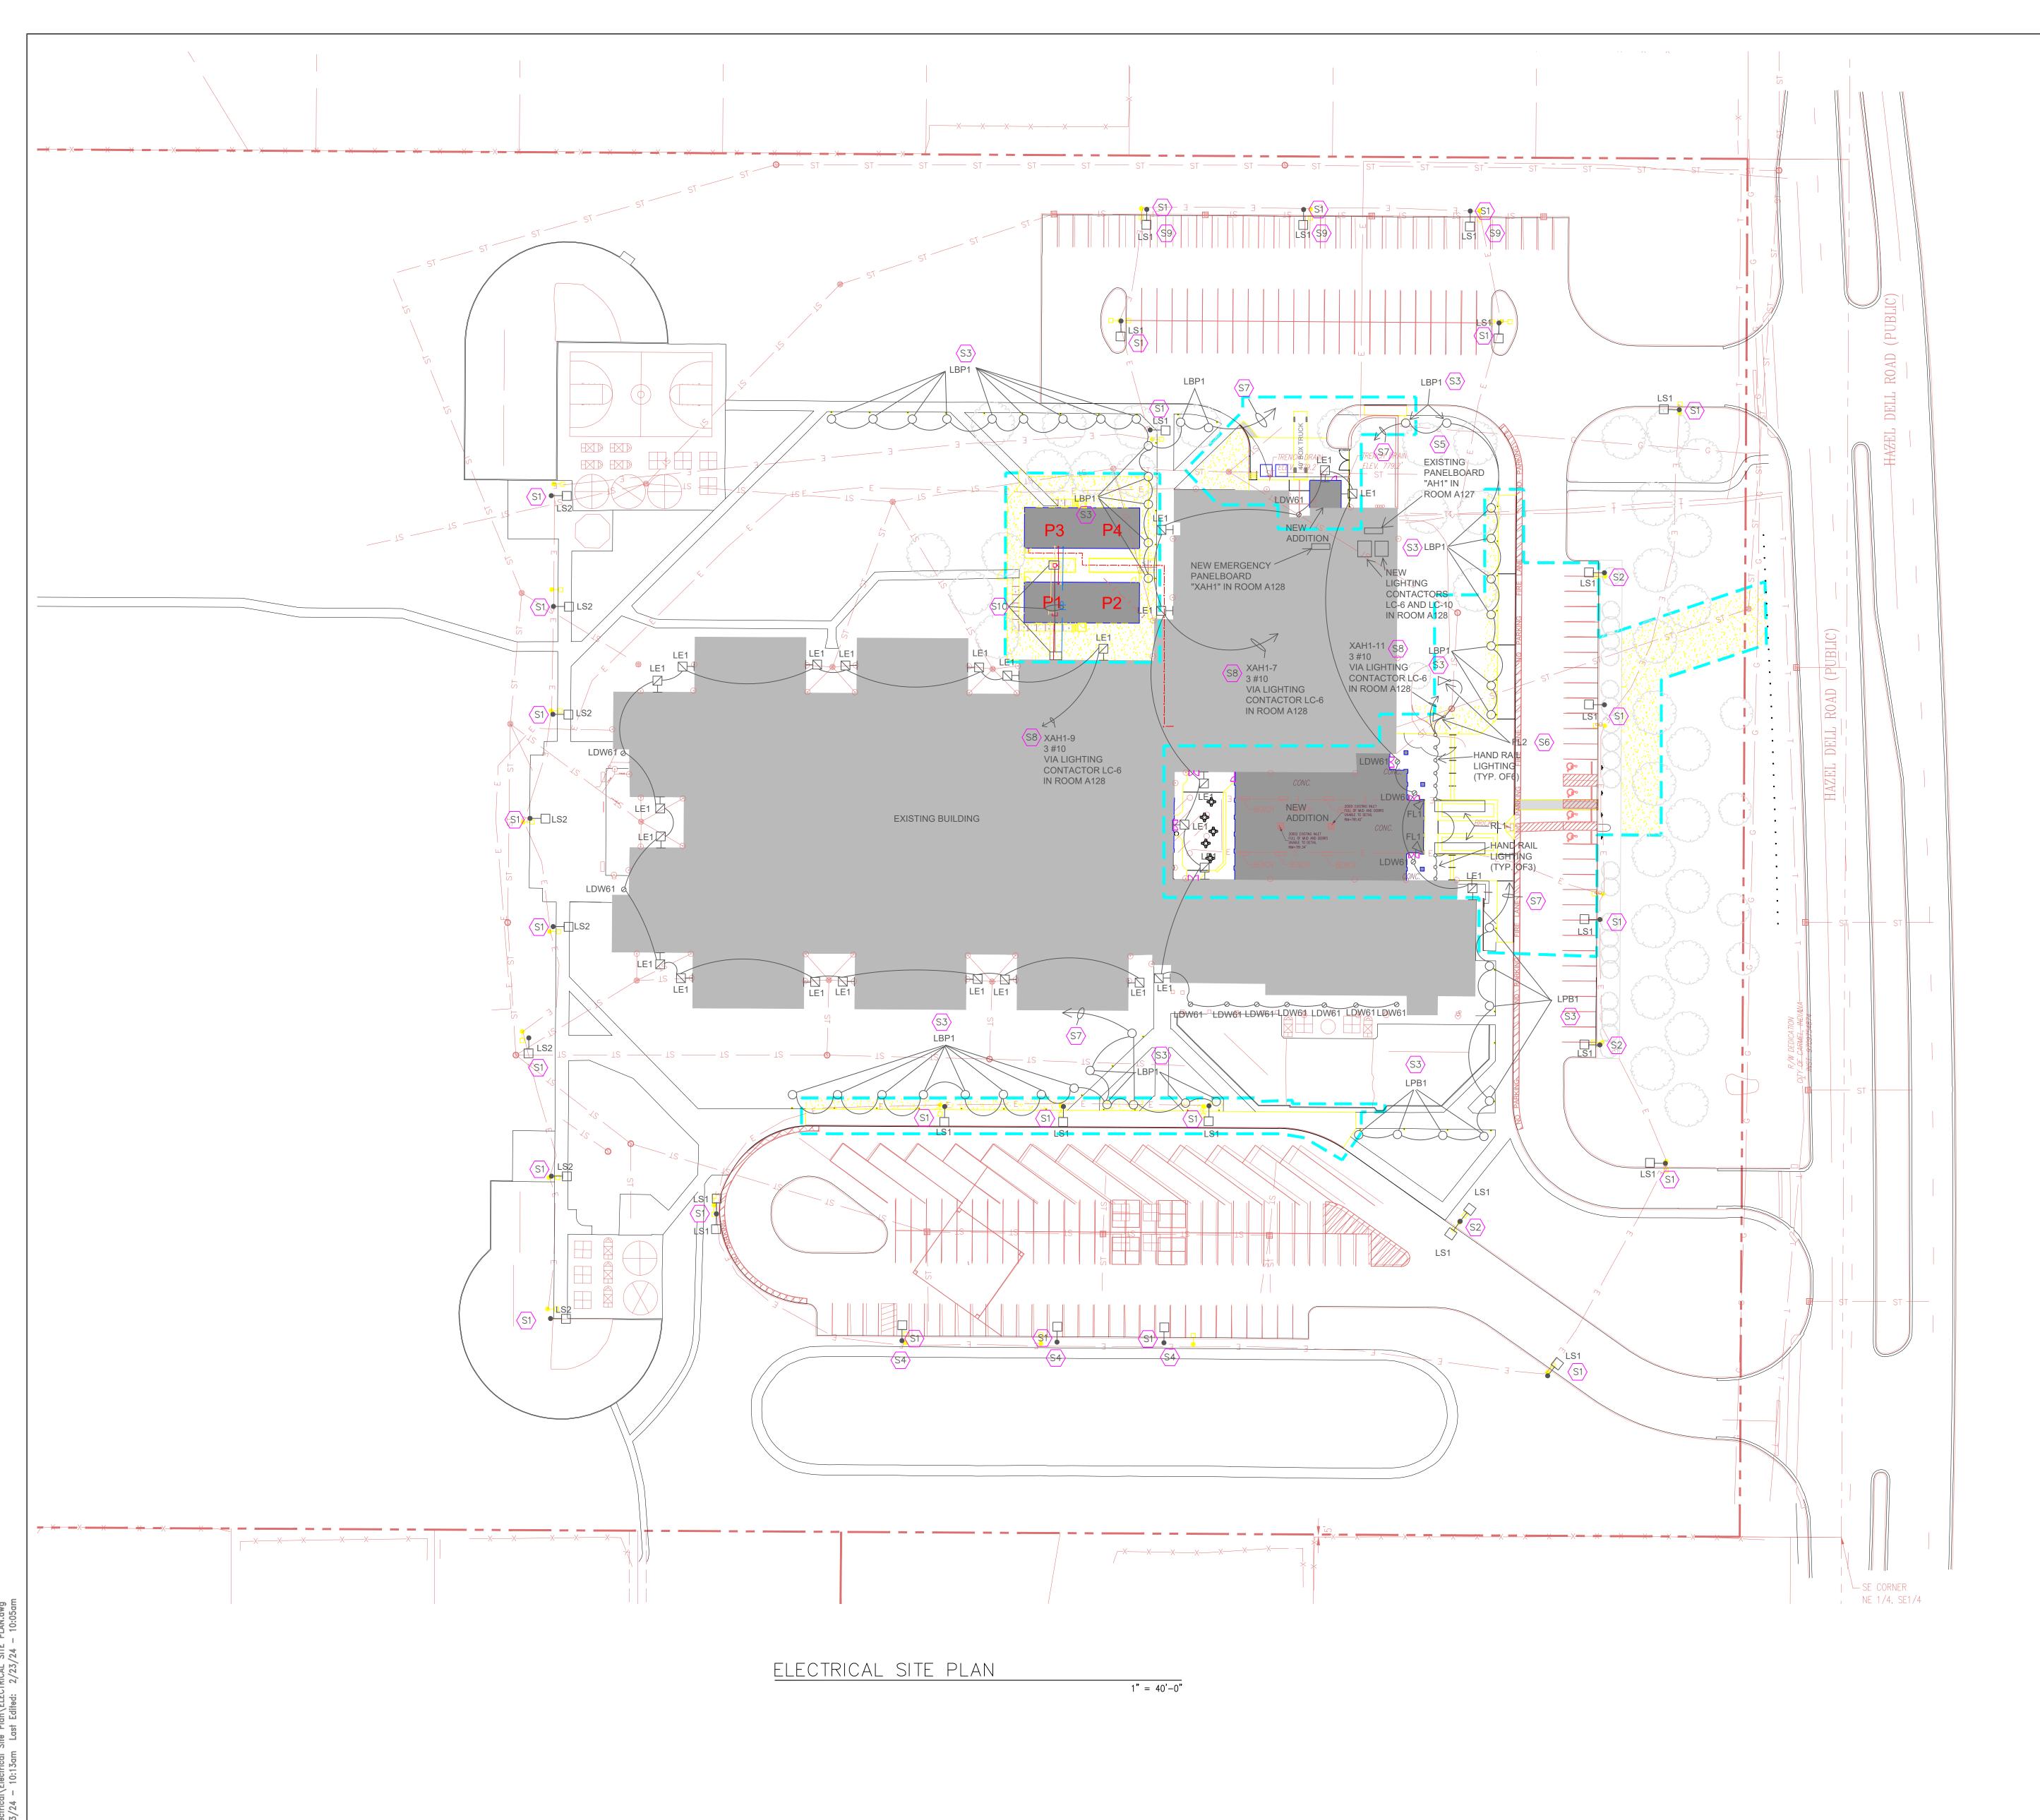

PLAN NOTES:

- S1 DISCONNECT AND REMOVE EXISTING POLE AND LIGHT FIXTURE AT THIS LOCATION. PROVIDE A NEW POLE AND LIGHT FIXTURE MOUNTED ON THE EXISTING CONCRETE BASE.
- PROVIDE A NEW LIGHT POLE AND CONCRETE BASE AT THIS LOCATION. WIRE NEW LIGHT POLE TO THE NEAREST EXISTING SITE LIGHTING CIRCUIT.
- SITE LIGHTING CIRCUIT.

 S3 PROVIDE A NEW LIGHT BALLARD AND CONCRETE BASE AT THIS LOCATION.
- THIS NEW LIGHT POLE IS TO BE PROVIDED WITH THREADED HUB AT THE MOUNTING HEIGHT OF THE SECURITY CAMERA. PROVIDE A HAND HOLE OPPOSITE OF THE THREADED HOLE.
- S5 EXISTING CIRCUITS THAT FEED THE NEW "LS1" SITE LIGHTING FIXTURES ARE TO BE RUN THROUGH THE NEW 10 POLE LIGHTING CONTACTOR "LC-10" LOCATED IN ROOM A128.
- S6 PROVIDE A NEW GROUND MOUNTED FLOOD LIGHT TO ILLUMINATE THE SCHOOL NAME ON THE FACE OF THE BUILDING.
- WIRE THE BALLARD LIGHT FIXTURES "LPB1" TO A SPARE 20 AMP, 1—POLE CIRCUIT BREAKER IN EXISTING PANELBOARD "AH1" IN ROOM A127. RUN THROUGH NEW LIGHTING CONTACTOR "LC—10" IN ROOM A128.
- NEW LIGHTING CONTACTOR LC-6 FOR THE BUILDING SECURITY LIGHTING, HANDRAIL LIGHTING, AND THE PLANTER RL1 LIGHTING IS TO BE A 6 POLE CONTACTOR.
- S9 THIS LIGHT FIXTURE IS TO BE PROVIDED WITH A 15 DEGREE
- RUN A 3-INCH CONDUIT FOR THE POWER TO THE ELECTRICAL PULL BOX BETWEEN THE TRAILERS, THEN RUN A 2-INCH CONDUIT FROM THE PULL BOX TO EAST TRAILER. RUN A 1-INCH CONDUIT FOR FIRE ALARM TO THE TECHNOLOGY PULL BOX BETWEEN TRAILERS, THEN A 1-INCH CONDUIT FROM THE PULL BOX TO EACH TRAILER. CONDUITS ARE TO BE RUN UNDERGROUND FROM THE PULL BOXES BACK TO THE BUILDING, THEN UP THE EXTERIOR WALL OF THE BUILDING AND STUBBED INTO THE CEILING SPACE. CONDUITS RUNNING UP THE EXTERIOR WALL ARE TO BE LOCATED TO MISS THE WINDOWS. VERIFY EXACT LOCATION IN THE FIELD.

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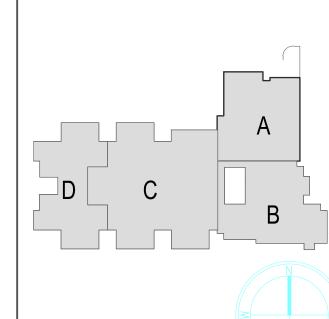
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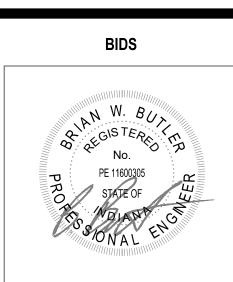
ARCHITECT



317-848-0966 350 E NEW YORK ST# 300, INDIANAPOLIS, IN 46204



KEY PLAN



PROJECT MANAGER: SAM DRAWN BY: RR

PROJECT NUMBER: 222011

PROJECT ISSUI	E DATE: 02/09/2024	
REV. NO.△	DESCRIPTION	DATE
1	ADDENDUM #1	02/23/24
	ADDENDOW #1	02/23/24
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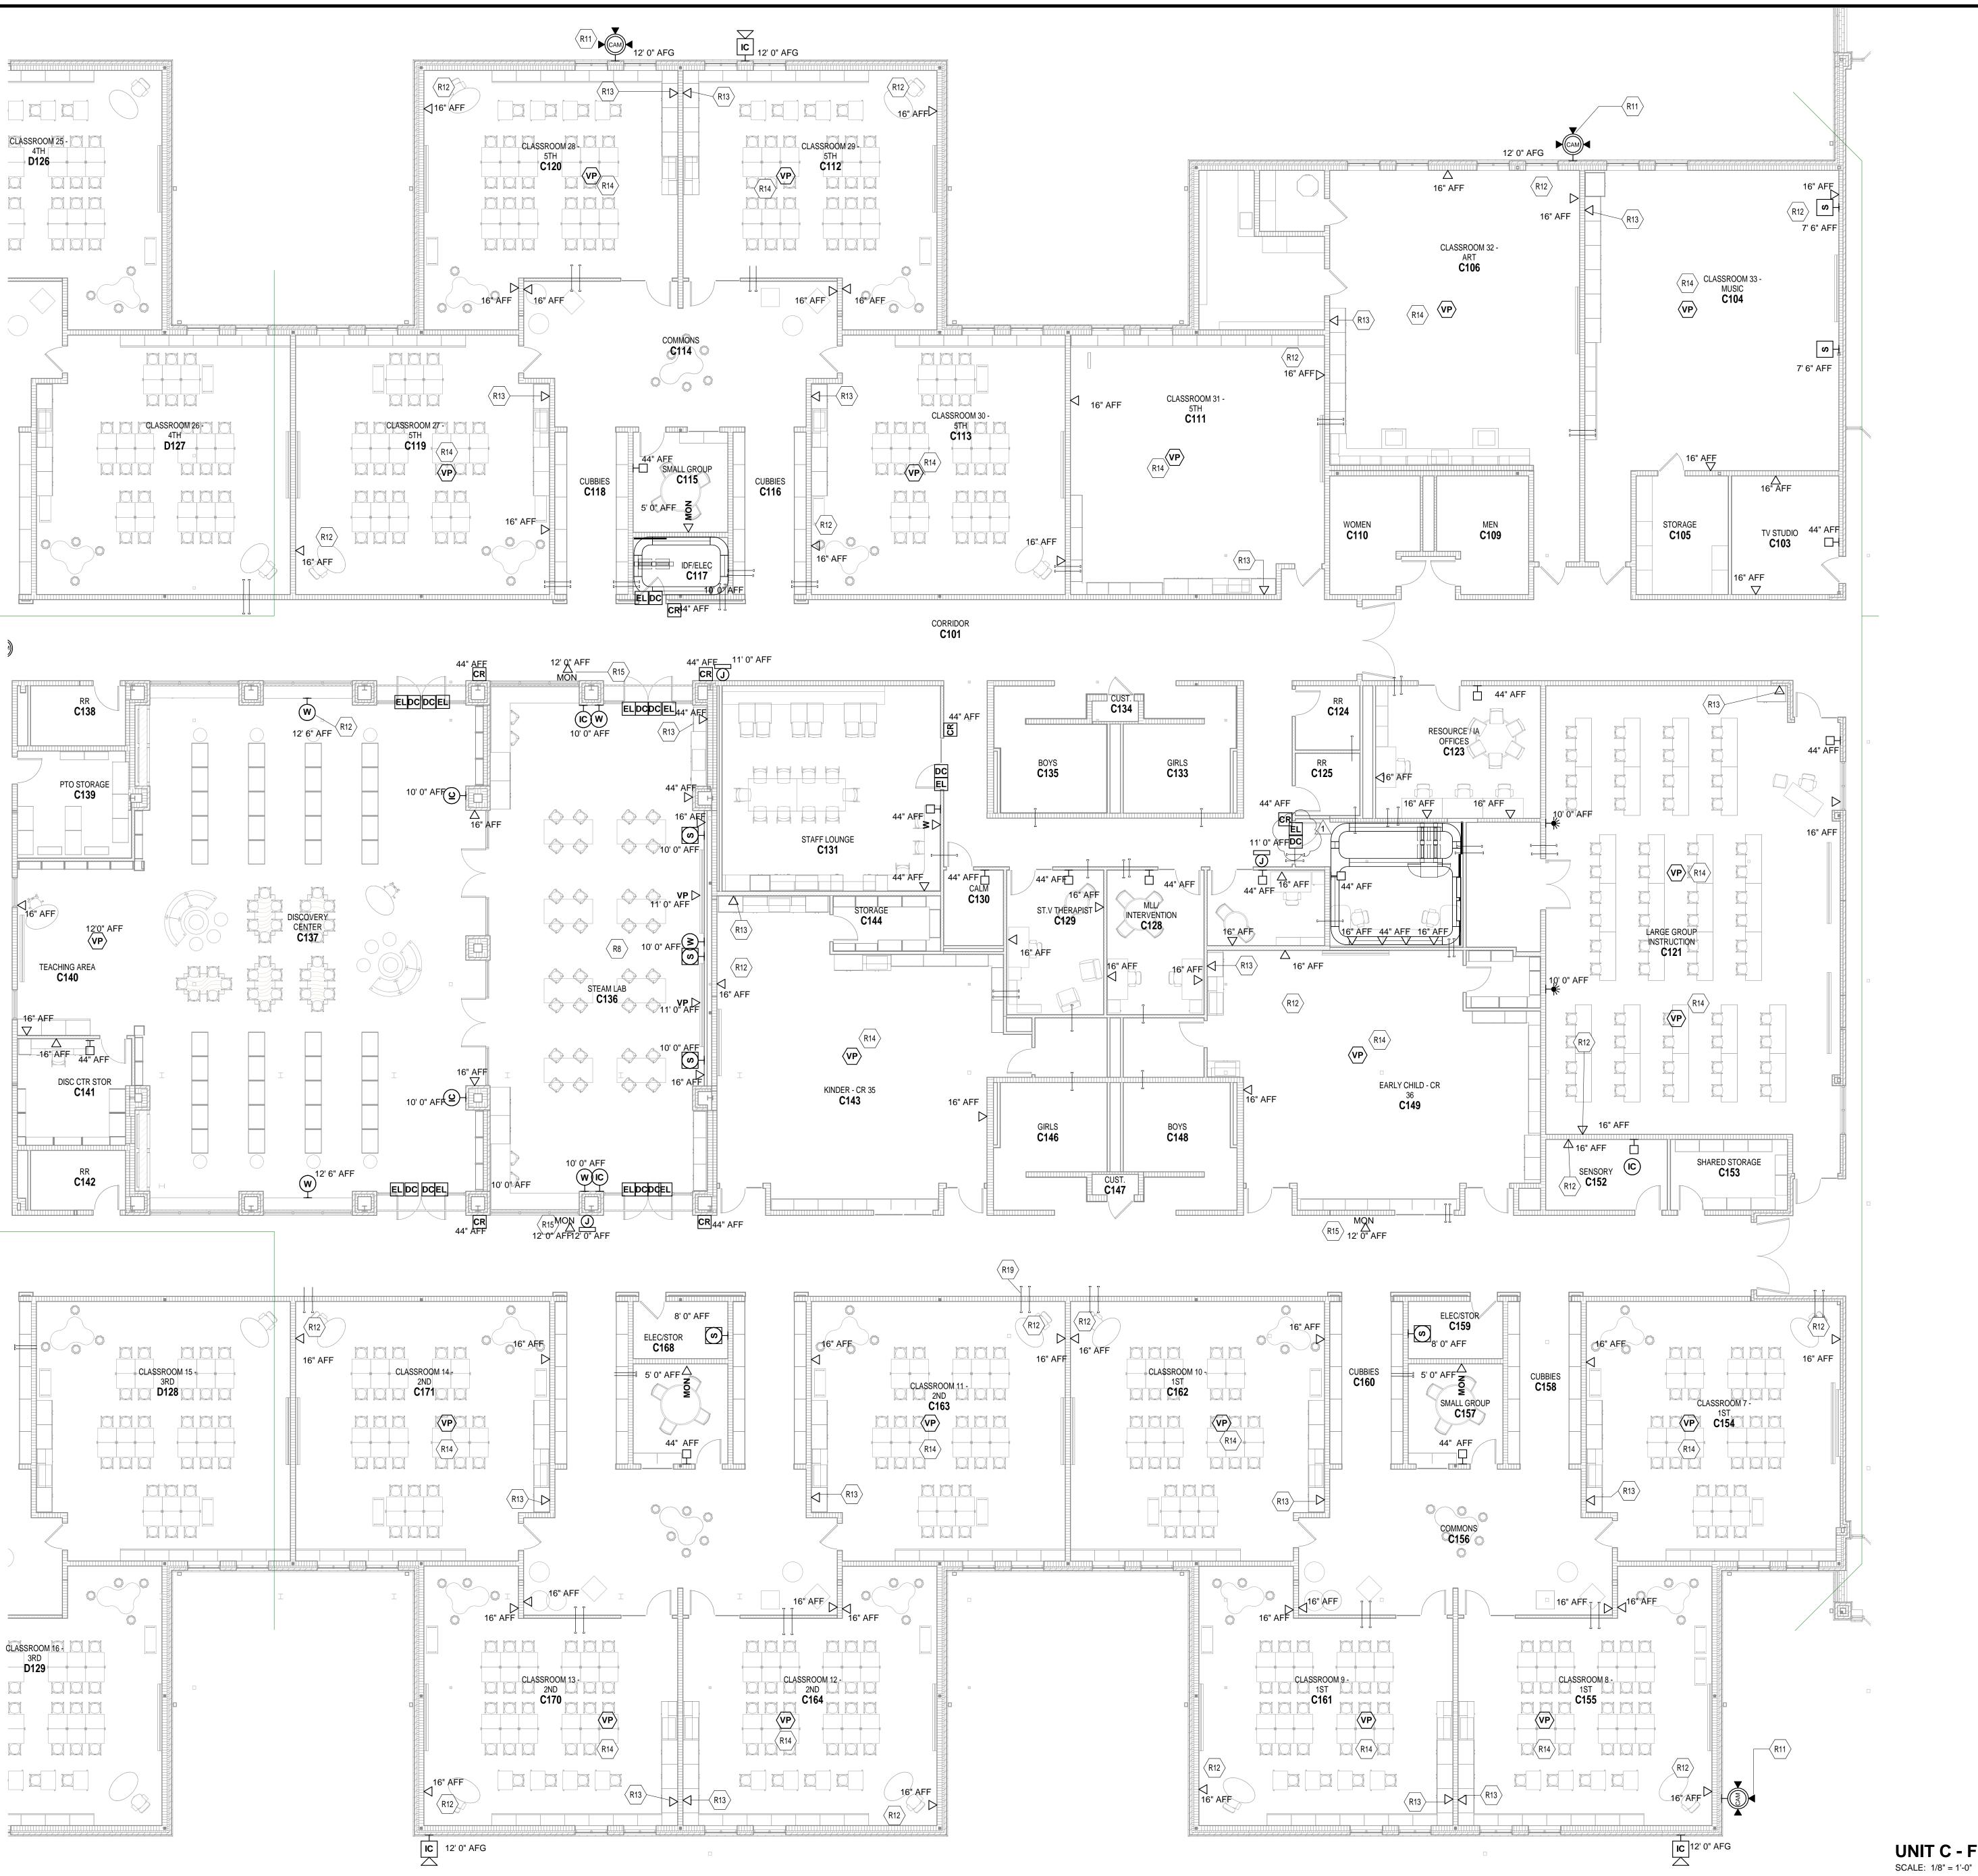
VERIFICATION NOTE

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SHOULD DIFFERENT CONDITIONS BE ENCOUNTERED CONTACT
THE ARCHITECT BEFORE PROCEEDING WITH WORK.

ELECTRICAL SITE PLAN

E2.01



ROOM LEGEND - FIRST FLOOR UNIT C ROOM NAME AREA (SF) C101 CORRIDOR
C102 CORRIDOR
C103 TV STUDIO 2434 SF 2035 SF C104 CLASSROOM 33 - MUSIC 1227 SF C105 STORAGE 167 SF C106 CLASSROOM 32 - ART C107 KILN 60 SF 235 SF C108 STORAGE
C109 MEN
C110 WOMEN C111 CLASSROOM 31 - 5TH C112 CLASSROOM 29 - 5TH
C113 CLASSROOM 30 - 5TH 878 SF 981 SF C114 COMMONS 648 SF C116 CUBBIES C117 IDF/ELEC C118 CUBBIES C119 CLASSROOM 27 - 5TH C120 CLASSROOM 28 - 5TH 878 SF C121 LARGE GROUP INSTRUCTION 1990 SF C122 LGI STORAGE
C123 RESOURCE / IA OFFICES C126 IT OFFICE/ MDF 278 SF C127 BHVL THERAPIST 135 SF C128 MLL/ INTERVENTION 214 SF C129 ST.V THERAPIST 213 SF 69 SF 683 SF 451 SF C130 CALM
C131 STAFF LOUNGE
C132 CORRIDOR
C133 GIRLS 195 SF C134 CUST. 14 SF C135 BOYS
C136 STEAM LAB
C137 DISCOVERY CENTER 196 SF 2676 SF C139 PTO STORAGE
C140 TEACHING AREA
C141 DISC CTR STOR 312 SF 180 SF 86 SF 1160 SF C142 RR C143 KINDER - CR 35 90 SF C144 STORAGE C145 RR 65 SF 196 SF 15 SF 196 SF C148 BOYS C149 EARLY CHILD - CR 36 C150 RR
C151 STORAGE
C152 SENSORY 73 SF 62 SF 131 SF 120 SF C153 SHARED STORAGE C154 CLASSROOM 7 - 1ST C155 CLASSROOM 8 - 1ST 980 SF 877 SF C156 COMMONS C157 SMALL GROUP 649 SF 145 SF C158 CUBBIES 188 SF 83 SF 189 SF 877 SF C159 ELEC/STOR CLASSROOM 9 - 1S CLASSROOM 10 - 1ST 982 SF C163 CLASSROOM 11 - 2ND C164 CLASSROOM 12 - 2ND 878 SF C165 COMMONS 649 SF C167 CUBBIES 189 SF C168 ELEC/STOR 83 SF 189 SF C169 CUBBIES CLASSROOM 13 - 2ND

TECHNOLOGY PLAN NOTES

RISER DIAGRAM.

OF TREE COVER.

CLASSROOM 14 - 2ND

- SEE DETAILS FOR LGI SOUND/PROJECTOR SYSTEM CONDUIT
- COORDINATE OUTDOOR CAMERA LOCATIONS WITH TECHNOLOGY CONTRACTOR BEFORE ROUGH INS TO DETERMINE BEST LOCATIONS BECAUSE
- REMOVE ALL SURFACE MOUNT RACEWAY DATA PATHS AND REPLACE WITH 1 NEW 1 1/4" MINIMUM FLEX CONDUIT INSIDE EXISTING WALLS TO
- DATA ROUGH IN BOX. CLASSROOM SOUND/DATA LOCATION TO BE LOCATED AT 66" INSIDE
- TEACHER WARDROBE. PROJECTOR POWER CAN BE COILED
- ABOVE FOR REUSE IN THE PROJECTOR CEILING PLATE. HALLWAY CEILING MOUNTED MONITOR WILL NEED POWER PROVIDED. COORDINATE WITH TECH
- CONTRACTOR. SEE DETAIL 2/E3.17 FOR CLASSROOM SLEEVE ROUGH-IN REQUIREMENTS PROVIDED BY ELECTRICAL

GENERAL NOTE: ELECTRICAL RECEPTACLES SHOWN ON THE TECHNOLOGY ROUGH-IN DRAWINGS ARE FOR COORDINATION PURPOSES ONLY. REFER TO ELECTRICAL POWER DRAWINGS FOR RECEPTACLE ROUGH-IN REQUIREMENTS.

CONTRACTOR

VERIFICATION NOTE: CONTRACTOR SHALL VERIFY ALL DIMENSIONS, CLEARANCES AND EXISTING FIELD CONDITIONS BEFORE STARTING CONSTRUCTION. COMMENCEMENT OF WORK CONSTITUTES ACCEPTANCE OF CONDITIONS

SHOULD DIFFERENT CONDITIONS BE ENCOUNTERED CONTACT THE ARCHITECT BEFORE PROCEEDING WITH ANY WORK.

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CHERRY TREE ELEMENTARY SCHOOL **ADDITIONS AND** RENOVATIONS


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KEY PLAN

PROJECT MANAGER: SAM DRAWN BY: CDT


PROJECT NUMBER: 222011.00


PROJECT ISSUE DATE: 2.8.2024

REV. DESCRIPTION DATE 1 ADDENDUM #1

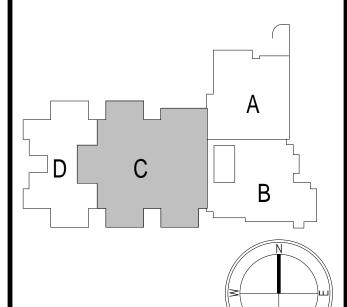UNIT C - FIRST FLOOR TECHNOLOGY ROUGH-IN PLAN

E3.03

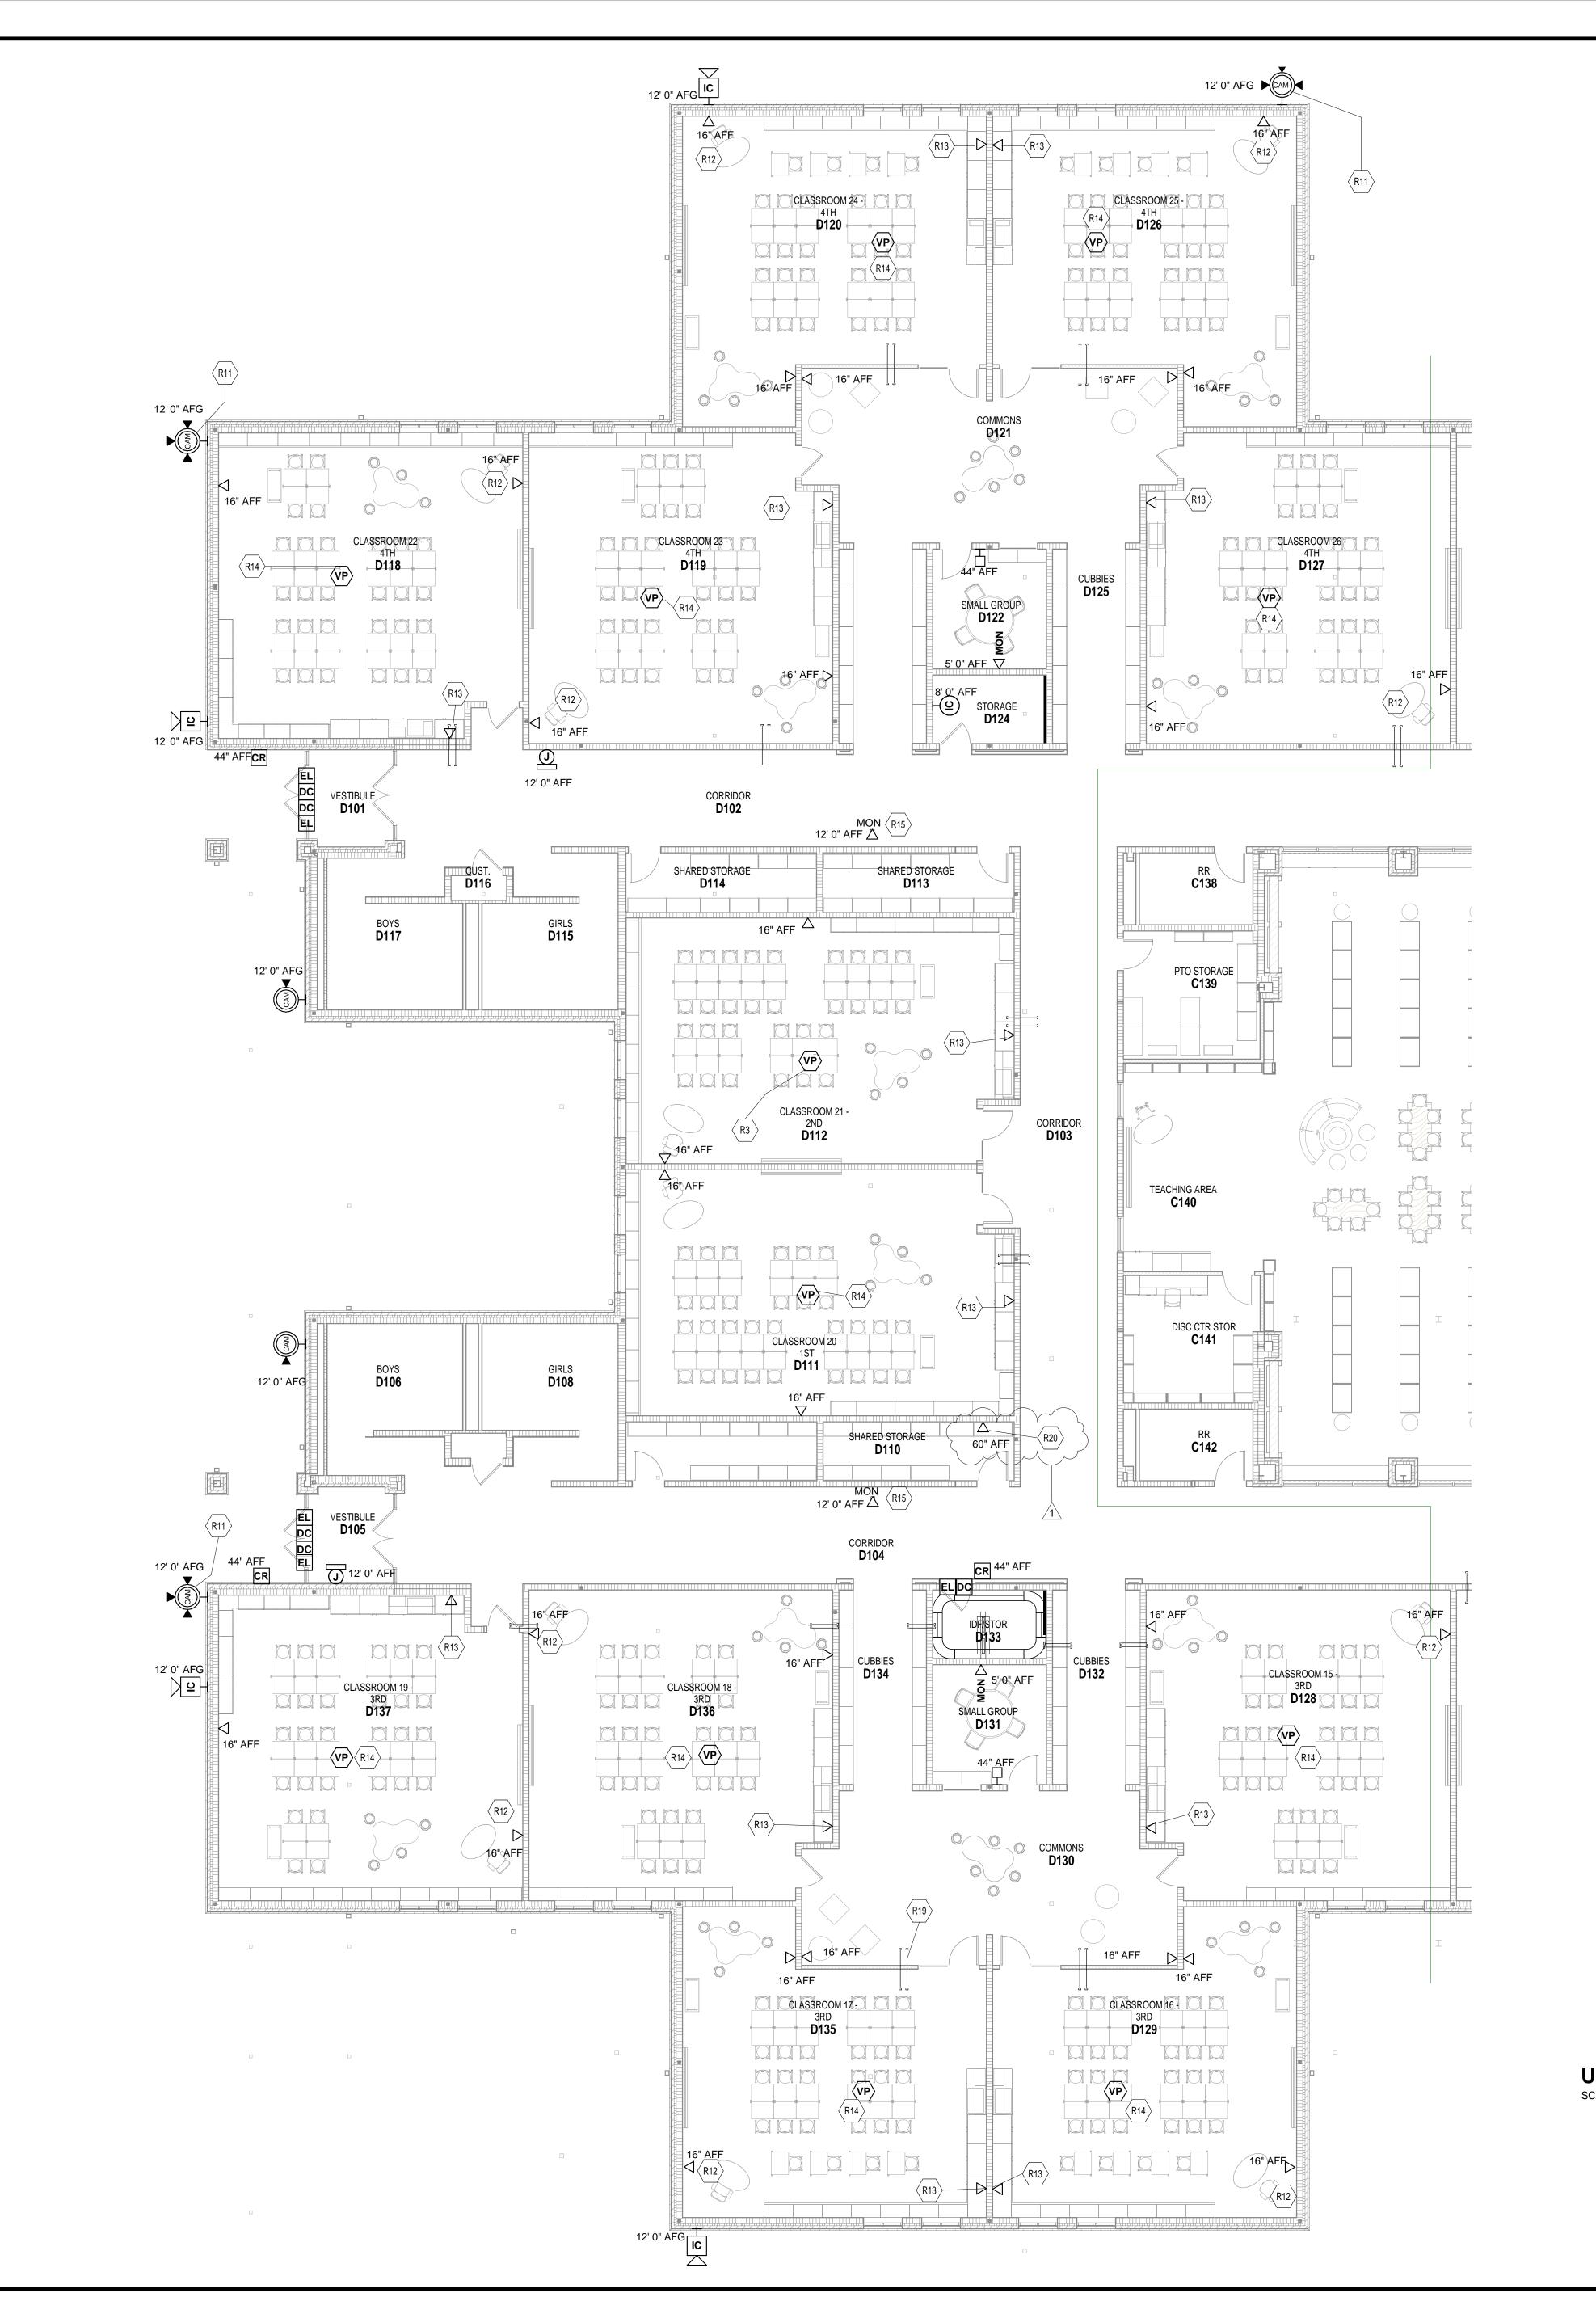

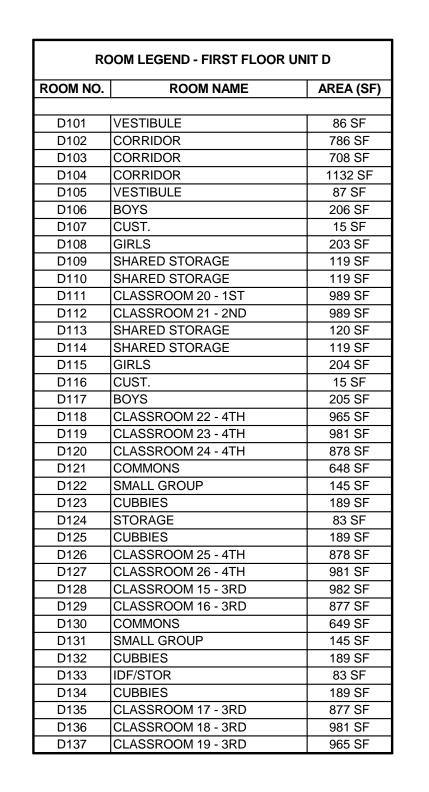

TECHNOLOGY PLAN NOTES

- COORDINATE WITH TECH CONTRACTOR TO CONFIRM ELECTRICAL NEEDS.
- COORDINATE OUTDOOR CAMERA LOCATIONS WITH TECHNOLOGY CONTRACTOR BEFORE ROUGH INS TO DETERMINE BEST LOCATIONS BECAUSE OF TREE COVER.
- REMOVE ALL SURFACE MOUNT RACEWAY DATA PATHS AND REPLACE WITH 1 NEW 1 1/4" MINIMUM FLEX CONDUIT INSIDE EXISTING WALLS TO DATA ROUGH IN BOX.
- CLASSROOM SOUND/DATA LOCATION TO BE LOCATED AT 66" INSIDE
- TEACHER WARDROBE. R14 PROJECTOR POWER CAN BE COILED ABOVE FOR REUSE IN THE PROJECTOR
- CEILING PLATE. HALLWAY CEILING MOUNTED MONITOR
- WILL NEED POWER PROVIDED. COORDINATE WITH TECH CONTRACTOR.
- R19 SEE DETAIL 2/E3.17 FOR CLASSROOM SLEEVE ROUGH-IN REQUIREMENTS PROVIDED BY ELECTRICAL

LOCATION ROUGH INS.

CONTRACTOR R20 COORDINATE WITH HVAC CONTRACTOR FOR TEMPERATURE CONTROL PANEL

GENERAL NOTE:

ELECTRICAL RECEPTACLES SHOWN ON THE TECHNOLOGY ROUGH-IN DRAWINGS ARE FOR COORDINATION PURPOSES ONLY. REFER TO ELECTRICAL POWER DRAWINGS FOR RECEPTACLE ROUGH-IN REQUIREMENTS.

VERIFICATION NOTE: CONTRACTOR SHALL VERIFY ALL DIMENSIONS, CLEARANCES AND EXISTING FIELD CONDITIONS BEFORE STARTING CONSTRUCTION. COMMENCEMENT OF WORK CONSTITUTES ACCEPTANCE OF CONDITIONS SHOULD DIFFERENT CONDITIONS BE

ENCOUNTERED CONTACT THE ARCHITECT

BEFORE PROCEEDING WITH ANY WORK.

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CHERRY TREE ELEMENTARY SCHOOL **ADDITIONS AND** RENOVATIONS

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CARMEL CLAY SCHOOLS



ARCHITECT



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CONSULTANT

KEY PLAN



PROJECT MANAGER: SAM DRAWN BY: CDT PROJECT NUMBER: 222011.00

PROJECT ISSUE DATE: 2.8.2024

REV. No. \triangle	DESCRIPTION	DATE
1	ADDENDUM #1	2.23.2024
-		

UNIT D - FIRST FLOOR TECHNOLOGY ROUGH-IN PLAN

UNIT D - FIRST FLOOR TECHNOLOGY ROUGH-IN PLAN SCALE: 1/8" = 1'-0"

ROOM LEGEND - SECOND FLOOR UNIT B 389 SF B201 MECH. MEZZ.

TECHNOLOGY PLAN NOTES R20 COORDINATE WITH HVAC CONTRACTOR FOR TEMPERATURE CONTROL PANEL LOCATION ROUGH INS. 13989 Hazel Dell Pkwy, Carmel, IN 46033

ADDITIONS AND

RENOVATIONS

CHERRY TREE

ELEMENTARY

SCHOOL

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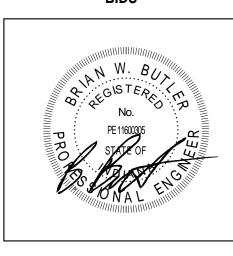
CARMEL CLAY SCHOOLS





350 E. New York St, Indianapolis IN 46204

KEY PLAN



PROJECT MANAGER: SAM

PROJECT NUMBER: 222011.00

VERIFICATION NOTE:

CONTRACTOR SHALL VERIFY ALL
DIMENSIONS, CLEARANCES AND EXISTING
FIELD CONDITIONS BEFORE STARTING
CONSTRUCTION. COMMENCEMENT OF WORK
CONSTITUTES ACCEPTANCE OF CONDITIONS.

SHOULD DIFFERENT CONDITIONS BE ENCOUNTERED CONTACT THE ARCHITECT BEFORE PROCEEDING WITH ANY WORK.

GENERAL NOTE:

ELECTRICAL RECEPTACLES SHOWN ON THE
TECHNOLOGY ROUGH-IN DRAWINGS ARE FOR
COORDINATION PURPOSES ONLY. REFER TO


ELECTRICAL POWER DRAWINGS FOR RECEPTACLE ROUGH-IN REQUIREMENTS.

PROJECT ISSUE DATE: 2.8.2024 NO. DESCRIPTION DATE 1 ADDENDUM #1 2.23.2024

UNIT B - SECOND FLOOR TECHNOLOGY ROUGH-IN PLAN

UNIT B - SECOND FLOOR TECHNOLOGY ROUGH-IN PLAN SCALE: 1/8" = 1'-0"

ALL EMERGENCY LIGHT FIXTURES AND EXIT SIGNS IN THIS UNIT ARE TO BE WIRED TO EMERENCY CIRCUIT "XAH1-4".

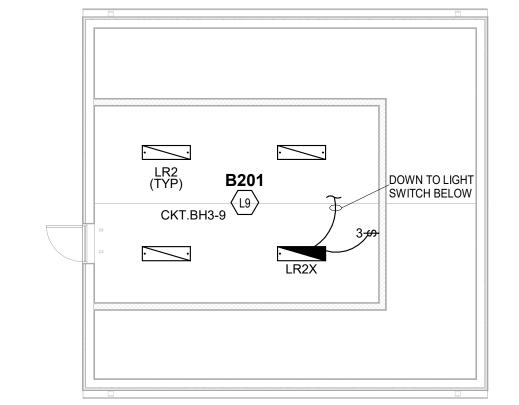

UNIT B - UPPER LEVEL LIGHTING PLAN

SCALE: 1/8" = 1'-0"

ROOM	
NO.	ROOM NAME
B101	VESTIBULE
B102	CORRIDOR
B103	CORRIDOR
B104	CORRIDOR
B105	VESTIBULE
B106	CORRIDOR
B107	VESTIBULE
B108	SECURE VESTIBULE
B109	RECEPTION
B110	SRO OFFICE
B111	LARGE CONFERENCE
B112	MOTHERS
B113	TEST STOR/ QUIET SPACE
B114	SPEECH/HEARING
B115	OT/PT OFFICE
B116	SOCIAL WORKER
B117	PSYCHOLOGIST
B118	INST COACH OFFICE
B119	CORRIDOR
B120	CORRIDOR
B121	WORKROOM
B122	MEZZANINE
B123	IDF
B124	ELEC
B125	RR
B126	CALM
B127	STORAGE
B128	CORRIDOR
B129	PRINCIPAL'S OFFICE
B130	SMALL CONFERENCE
B131	ASST PRINCIPAL'S OFFICE
B132	E.C. SPEECH
B133	RR
B134	EXAM
B135	CLINIC
B136	KINDER - CR 1
B137	STORAGE
B138	TOILET
B139	SMALL GROUP
B140	KINDER - CR 2
B141	TOILET
B142	STORAGE
B143	KINDER - CR 3
B144	STORAGE
B145	TOILET
B146	KINDER - CR 4
B147	TOILET
B148	STORAGE
B149	EARLY CHILD - CR 5
B150	RESTROOM
B151	STORAGE
B152	EARLY CHILD - CR 6
B153	STORAGE
B154	RESTROOM
B155	SMALL GROUP
B156	MECH

	ROOM	LEGEND - SECOND FLOOR	UNIT B
	ROOM NO.	ROOM NAME	AREA (SF)
	B201	MECH. MEZZ.	389 SF
· ·			

GENERAL NOTES - LIGHTING

- GENERATOR TRANSFER DEVICE TO TAKE FIXTURE TO 100% IN EMERGENCY FINAL CONNECTION TO RECESSED LUMINAIRES SHALL BE WITH FLEXIBLE METALLIC CONDUIT, MC CABLE OR MANUFACTURED WIRING SYSTEM. REFER TO ARCHITECTURAL REFLECTED CEILING PLANS FOR LOCATION OF LUMINAIRES. COORDINATE LOCATION OF LUMINAIRES, LOUDSPEAKERS, DIFFUSERS, GRILLES, AND OTHER CEILING INSTALLED ELEMENTS WITH THEIR RESPECTIVE INSTALLERS.
- 4. REFER TO ARCHITECTURAL REFLECTED CEILING PLAN AND ROOM FINISH SCHEDULE TO DETERMINE PROPER TYPE OF LUMINAIRE TRIM REQUIRED FOR CEILING TYPE PRIOR TO ORDERING LUMINAIRES. PROVIDE LUMINAIRES COMPATIBLE WITH CEILING TYPE. RECESSED LUMINAIRE IN GRID CEILING SYSTEMS SHALL BE PROVIDED WITH

SEISMIC CLIPS OR PROVIDE ATTACHMENT TO CEILING GRID SYSTEM AND

SUPPORTED PER PROJECT MANUAL AND DETAIL "7/E1.02".

•	LUMINAIRE TIPE IS SHOWN ONLY ONCE, AS TIP. IN EVERY ROOM. PROVID
	SAME TYPE OF LUMINAIRE THROUGH-OUT SAME ROOM UNLESS OTHERWISE
	INDICATED.
	PROVIDE NO. 10 AWG, MINIMUM, CONDUCTORS FOR EXIT SIGNS AND SECUR
	LIGHT CIRCUITS.

	KEYNOTES
L1	WIRE NEW LIGHTING IN THIS ROOM TO THE EXISTING LIGHTING CIRCUIT.
L2	WIRE ONE DIMMER SWITCH TO CONTROL THE ROW OF LIGHT FIXTURES AT THE TEACHING WALL AND ONE DIMMER SWITCH TO CONTROL ALL THE OTHER LIGHT FIXTURES IN THE ROOM.
L3	WIRE THE NEW EXTERIOR LIGHT FIXTURE TO NEW EMERGENCY PANELBOARD "XAH1". REFER TO DRAWING SHEET "E2.01" FOR ADDITIONAL REQUIREMENTS.
L4	REFER TO THE ARCHITECTURAL EXTERIOR ELEVATION DRAWING SHEETS FOR MOUNTING HEIGHT OF LIGHT FIXTURE.
L9	MOUNT LIGHT FIXTURES TO MISS MECHANICAL EQUIPMENT.
L10	PROVIDE THIS LIGHT FIXTURE WITH A FLANGE CEILING KIT.
L11	LIGHT FIXTURES IN THIS ROOM ARE TO BE TUNABLE WHITE 2700-5000K, 80+CRI, 0-10V DIMMING. REFER TO DETAIL "8/E1.03" FOR ADDITIONAL REQUIREMENTS.
L12	MOUNT THE RL1 TYPE LIGHT FIXTURE UNDER THE 2-INCH CAP OVERHANG OF TH STONE CAP ON THE PLANTER WALL. REFER TO DRAWING SHEET "E2.01" FOR ADDITIONAL REQUIREMENTS.
L13	ROUGH-IN FOR THE DECORATIVE METAL RAILINGS. REFER TO THE ARCHITECTURAL SPECIFICATION SECTION 057300 FOR ADDITIONAL ELECTRICAL REQUIREMENTS AND COORDINATE WITH THE RAILING INSTALLER FOR ALL ROUGH-IN LOCATIONS AND REQUIREMENTS. REFER TO DRAWING SHEET "E2.01" FOR ADDITIONAL REQUIREMENTS.
L14	LIGHT FIXTURE TYPE "FL1" IS TO BE MOUNTED ON THE ROOF AND AIMED TO ILLUMINATE THE ENTRY TOWER. REFER TO DRAWING SHEET "E2.04" FOR ADDITIONAL REQUIREMENTS.
L17	MOUNT LIGHT FIXTURE TYPE "RL1" UNDER THE COUNTERTOP IN THE GROOVE PROVIDED. REFER TO DETAIL "7/A7.07"

VERIFICATION NOTE

CONTRACTOR SHALL VERIFY ALL DIMENSIONS AND CLEARANCES AND ALL EXISTING FIELD CONDITIONS

SHOULD DIFFERENT CONDITIONS BE ENCOUNTERED, CONTACT THE ARCHITECT BEFORE PROCEEDING WITH

BEFORE STARTING CONSTRUCTION. COMMENCEMENT OF WORK CONSTITUTES ACCEPTANCE OF CONDITIONS. CHERRY TREE ELEMENTARY SCHOOL ADDITIONS AND RENOVATIONS

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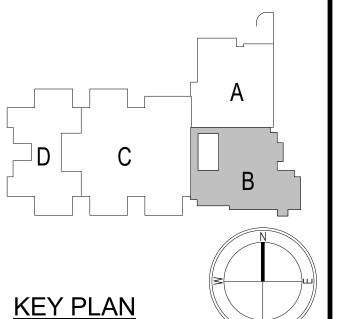
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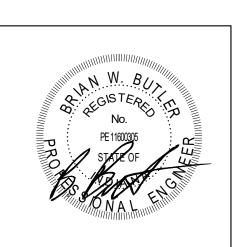
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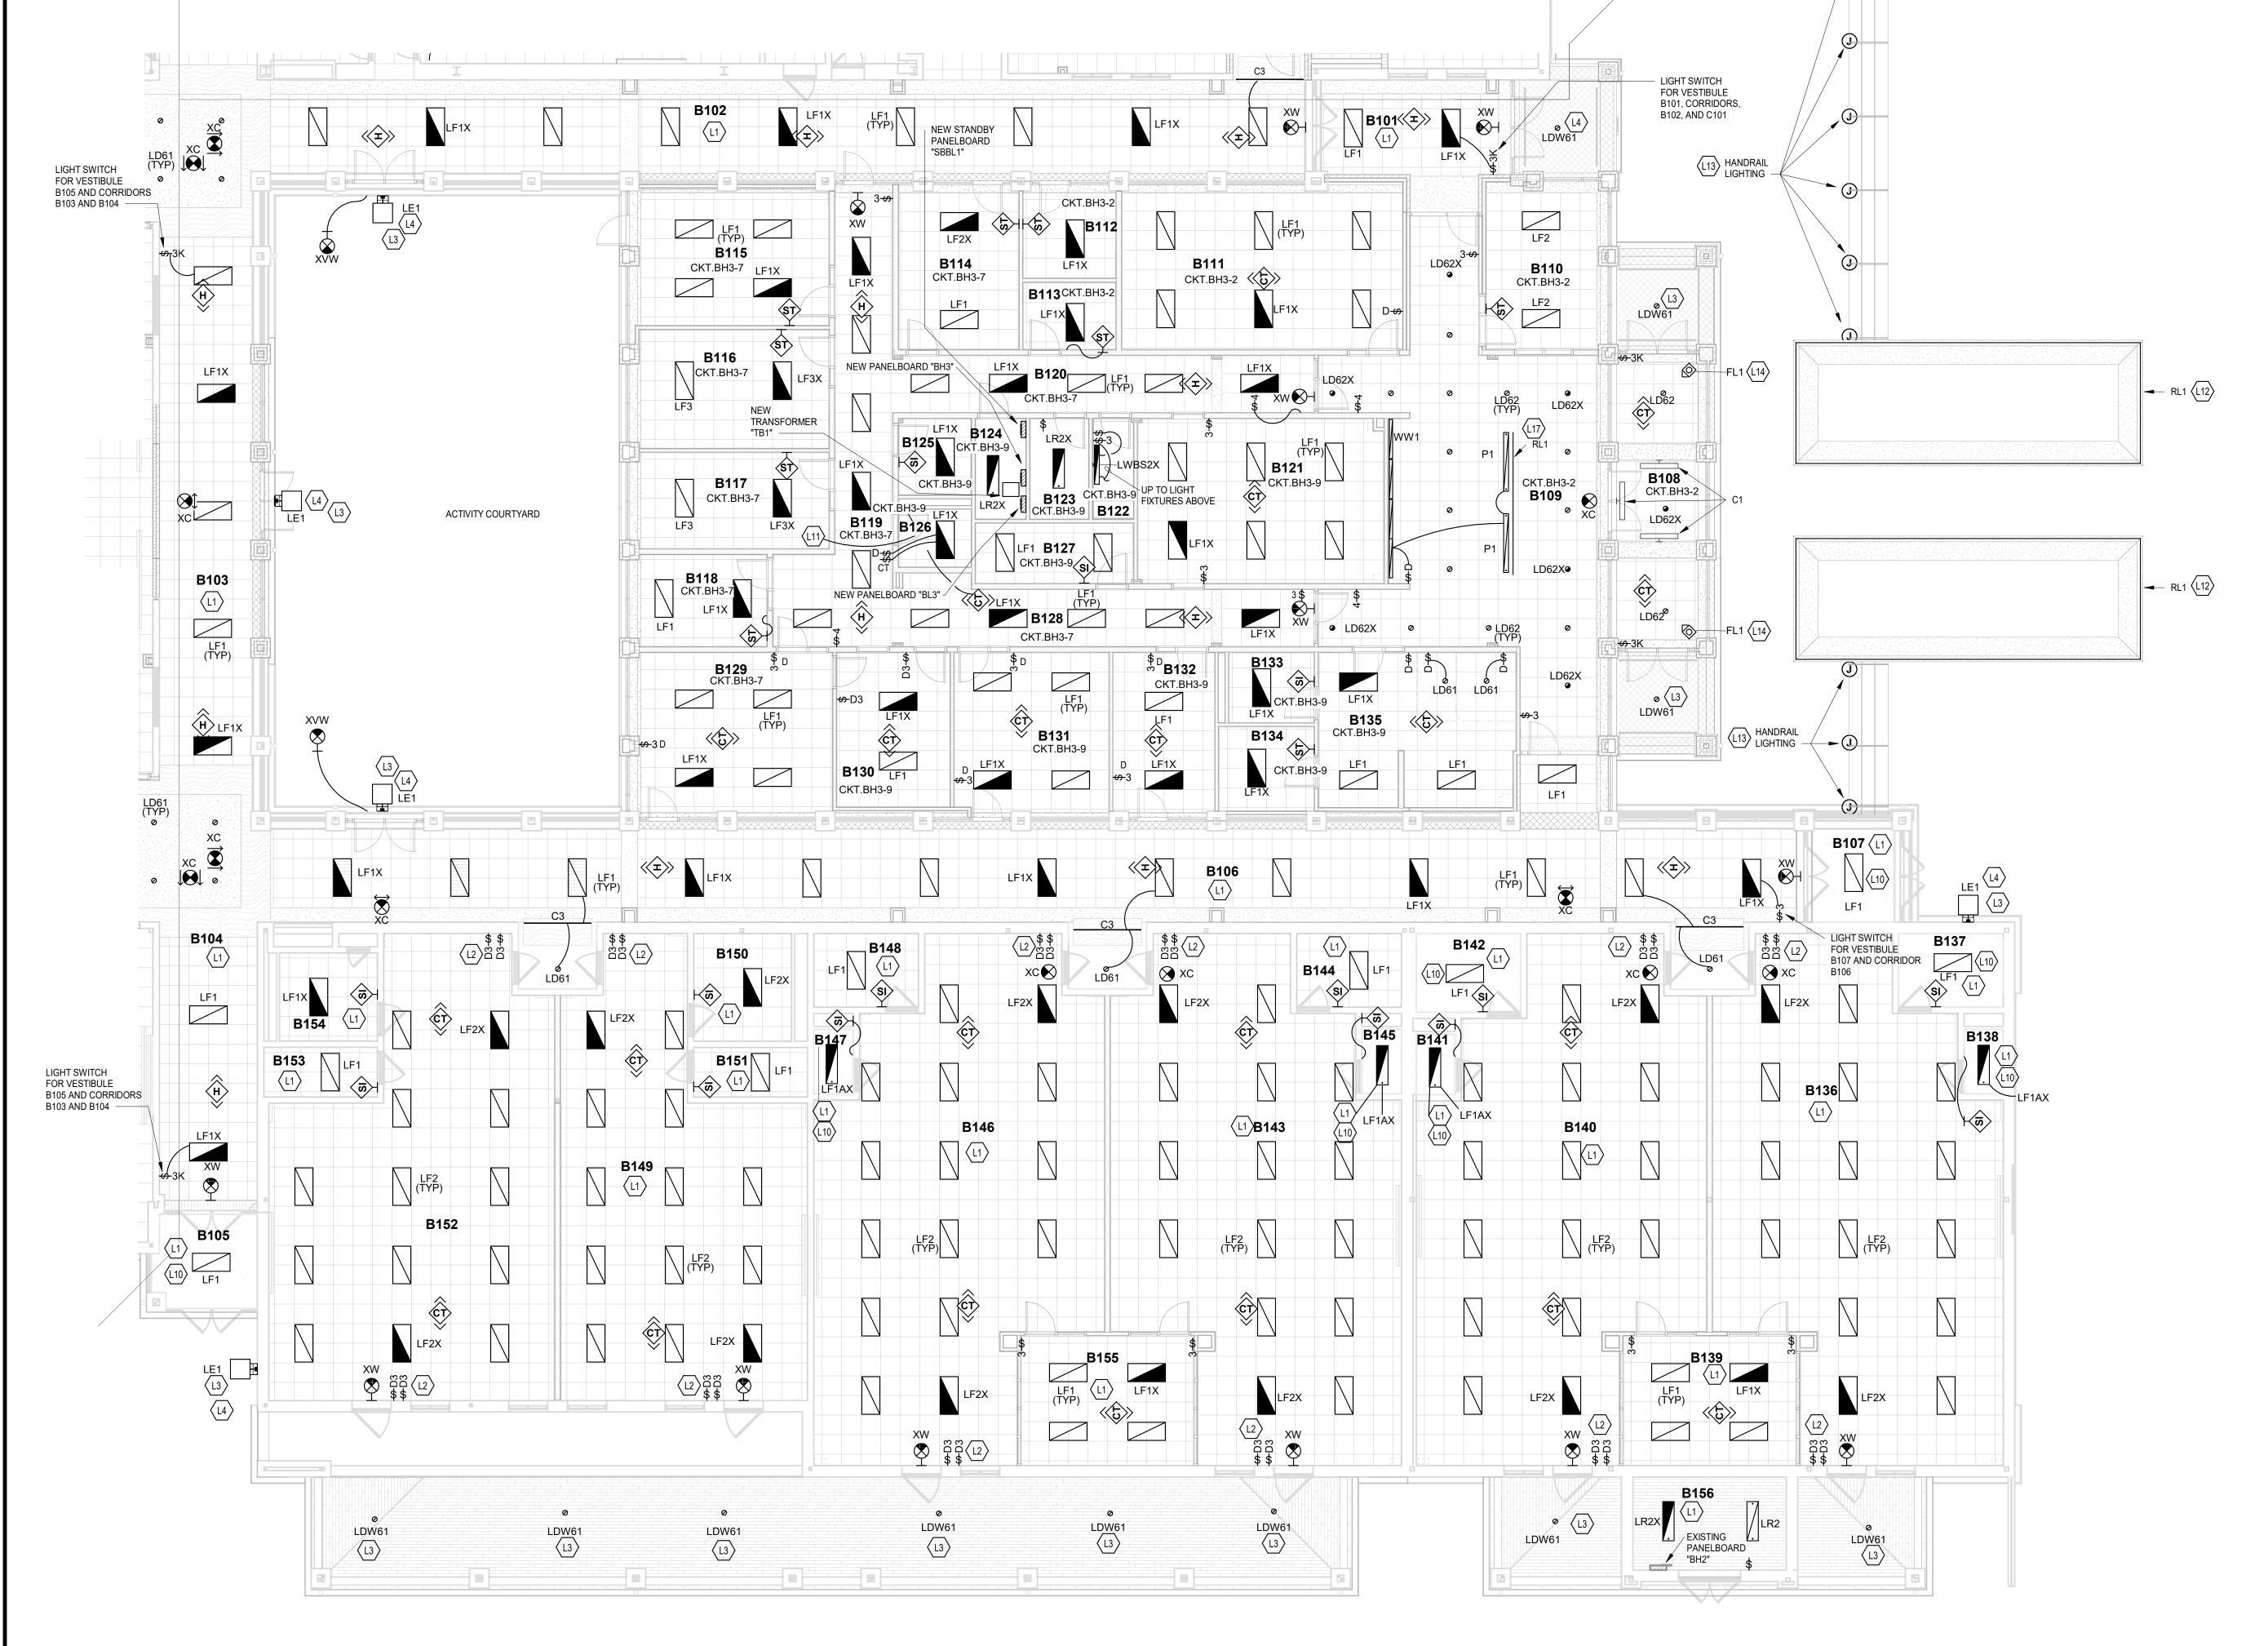


PROJECT MANAGER: SAM DRAWN BY: RDR PROJECT NUMBER: 222011.00

PROJECT ISSUE DATE: 02.09.2024


NO.	DESCRIPTION	DATE
1	ADDENDUM #1	2-23-24
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UNIT B - FIRST FLOOR LIGHTING PLAN




UNIT B - FIRST FLOOR LIGHTING PLAN

SCALE: 1/8" = 1'-0"

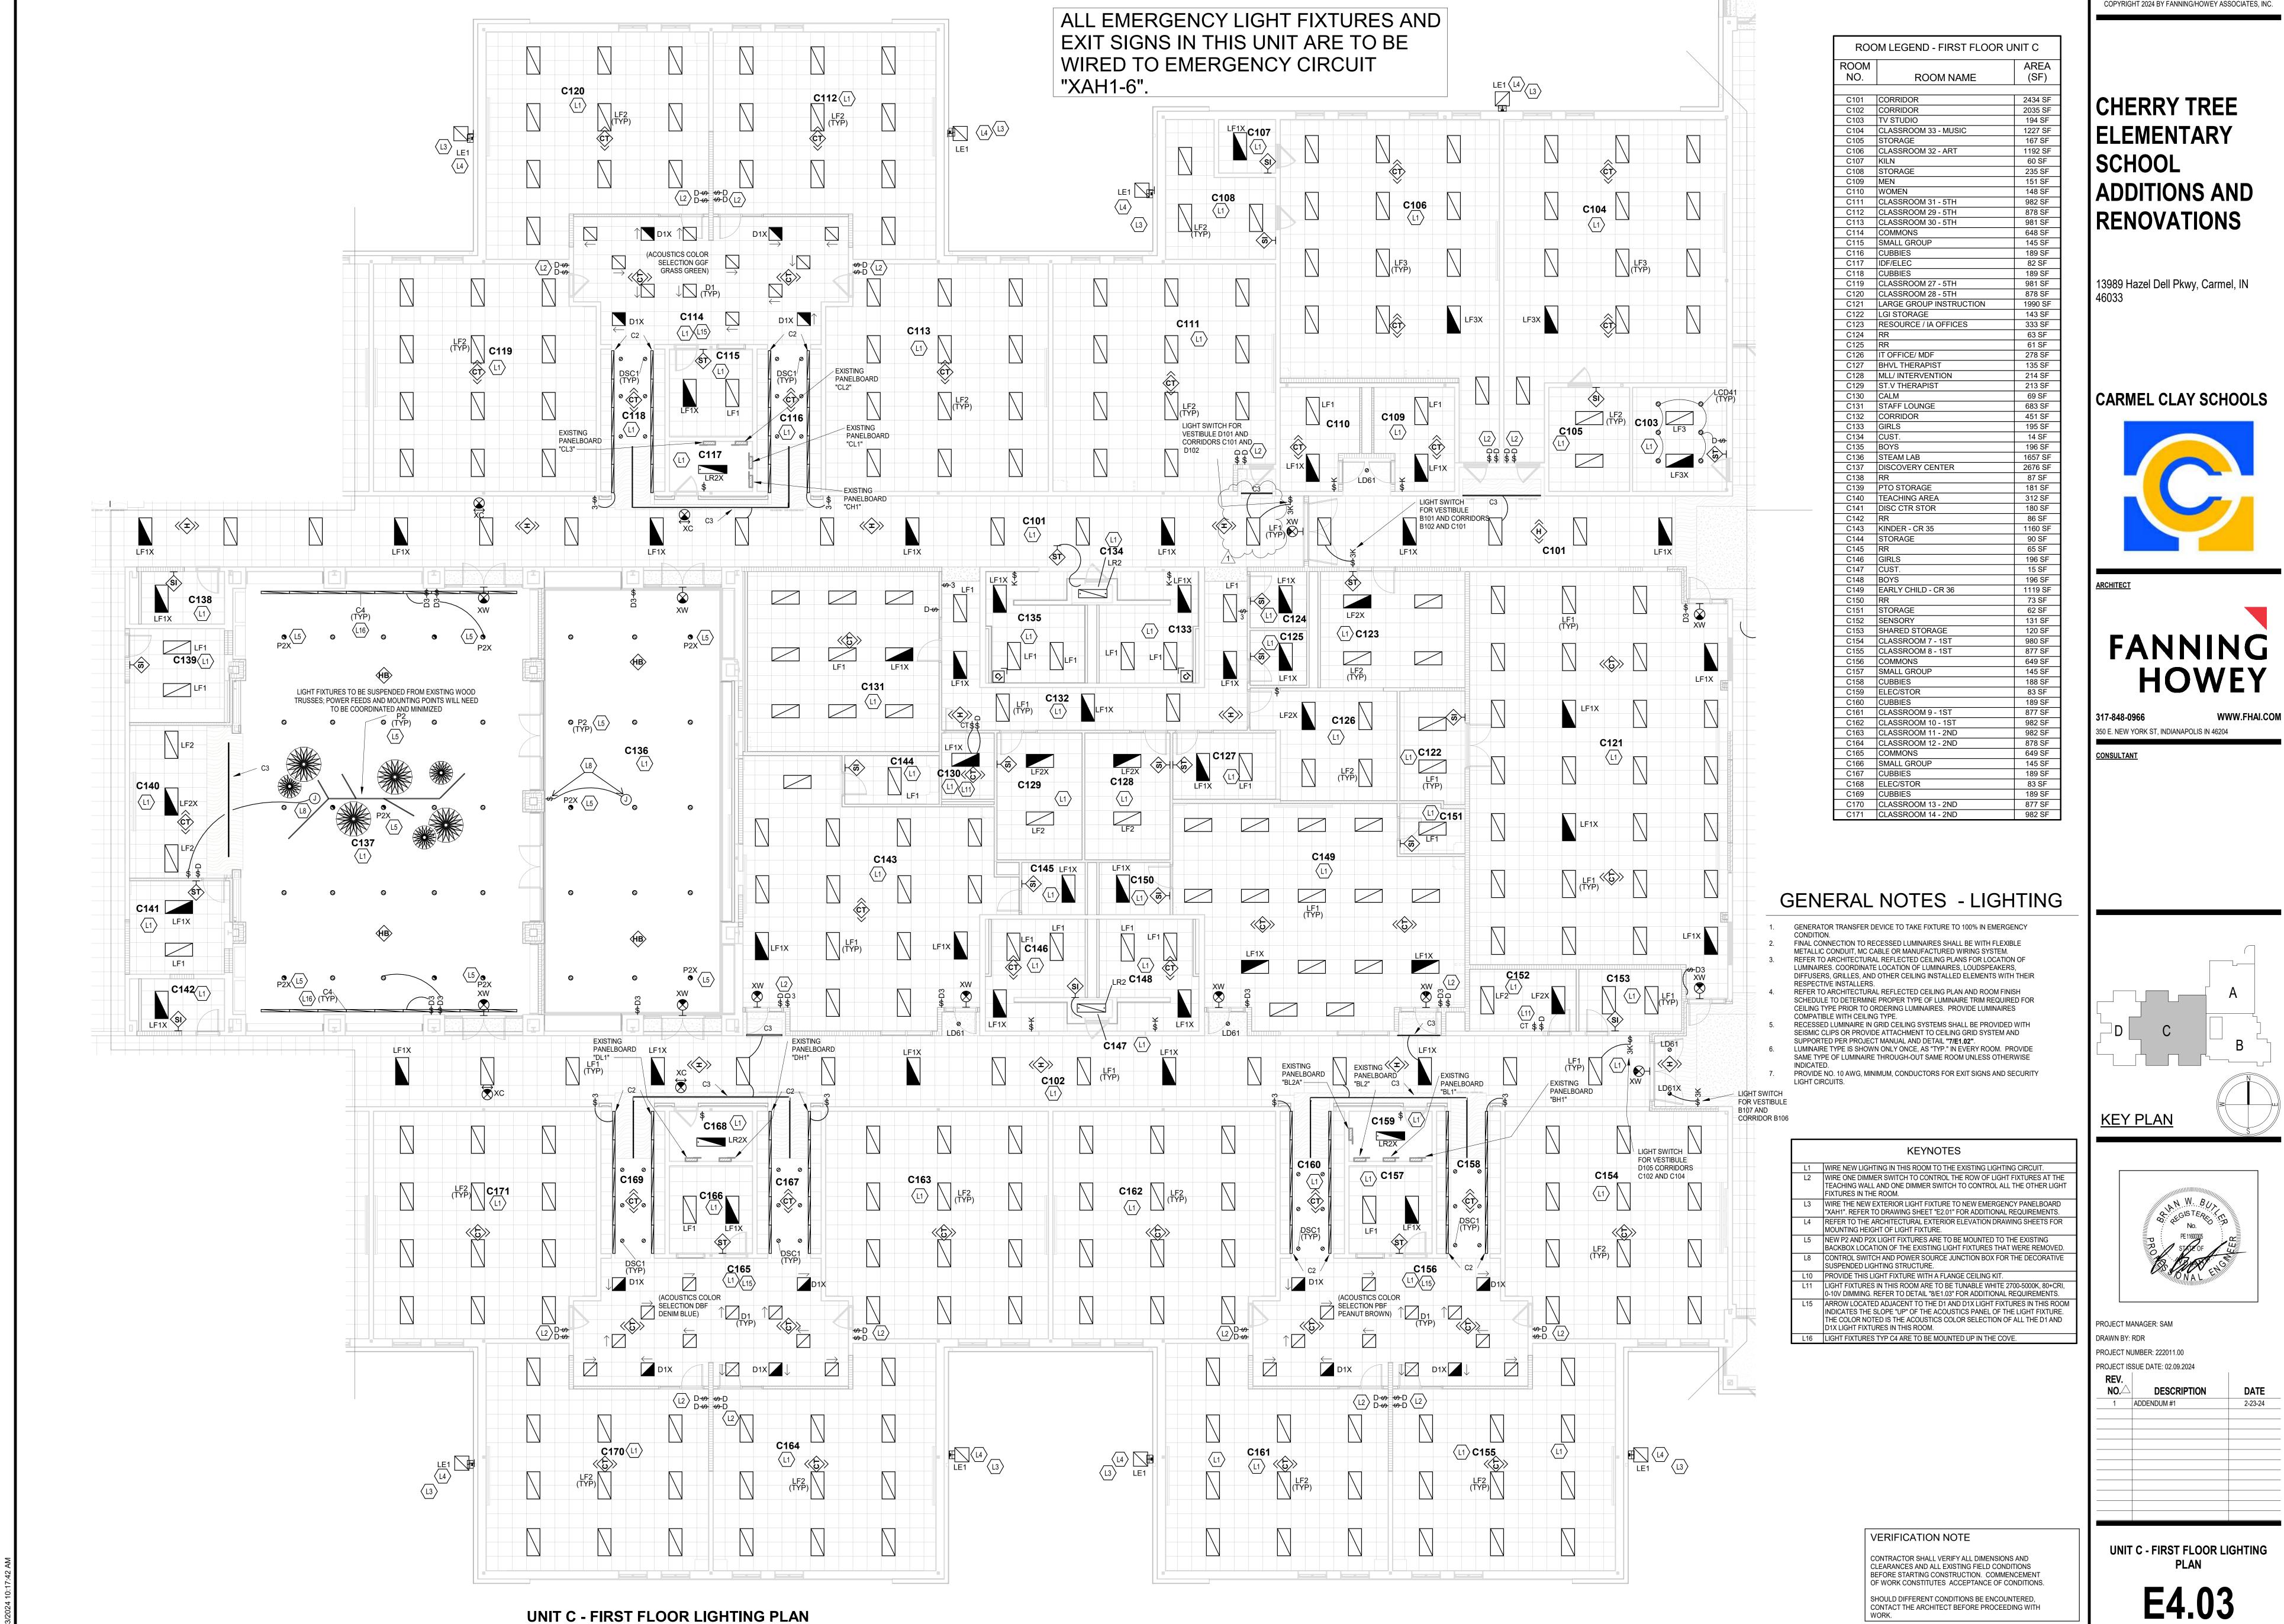

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ROOM LEGEND - FIRST FLOOR UNIT A AREA **ROOM NAME** NO. (SF) A101 CORRIDOR
A102 CORRIDOR
A103 CORRIDOR
A104 RECEIVING
A105 CORRIDOR 416 SF 350 SF A106 CORRIDOR A107 VESTIBULE 151 SF A108 CLASSROOM 34 - F.A.P. 728 SF A108 CLASSROUM 34 A109 SMALL GROUP
A110 SENSORY
A111 RESTROOM
A112 WOMEN
A113 MEN
A114 IDF
A115 CUST. 213 SF 139 SF 109 SF 112 SF 109 SF 29 SF 35 SF A116 BOYS
A117 GIRLS
A118 STAGE 900 SF A118 STAGE
A119 CAFETORIUM
A120 GYMNASIUM
A121 STORAGE
A122 P.E. OFFICE
A123 PARKS OFFICE
A124 FAMILY RR
A125 STORAGE 2305 SF 4395 SF 344 SF A126 OUTDOOR STORAGE 470 SF A127 ELECTRICAL
A128 BOILER ROOM
A129 CUST. OFFICE
A130 CUST. BREAKRM 197 SF 2306 SF 80 SF 216 SF A130 COST. BREAK
A131 TOILET
A132 DRESSING
A133 OFFICE
A134 DRY GOODS
A135 COOLER
A136 FREEZER
A137 KITCHEN 41 SF 110 SF 344 SF 235 SF 235 SF 1480 SF A138 LAUNDRY 80 SF A139 CUST. A140 BREAKROOM
A141 DISHWASHING 128 SF

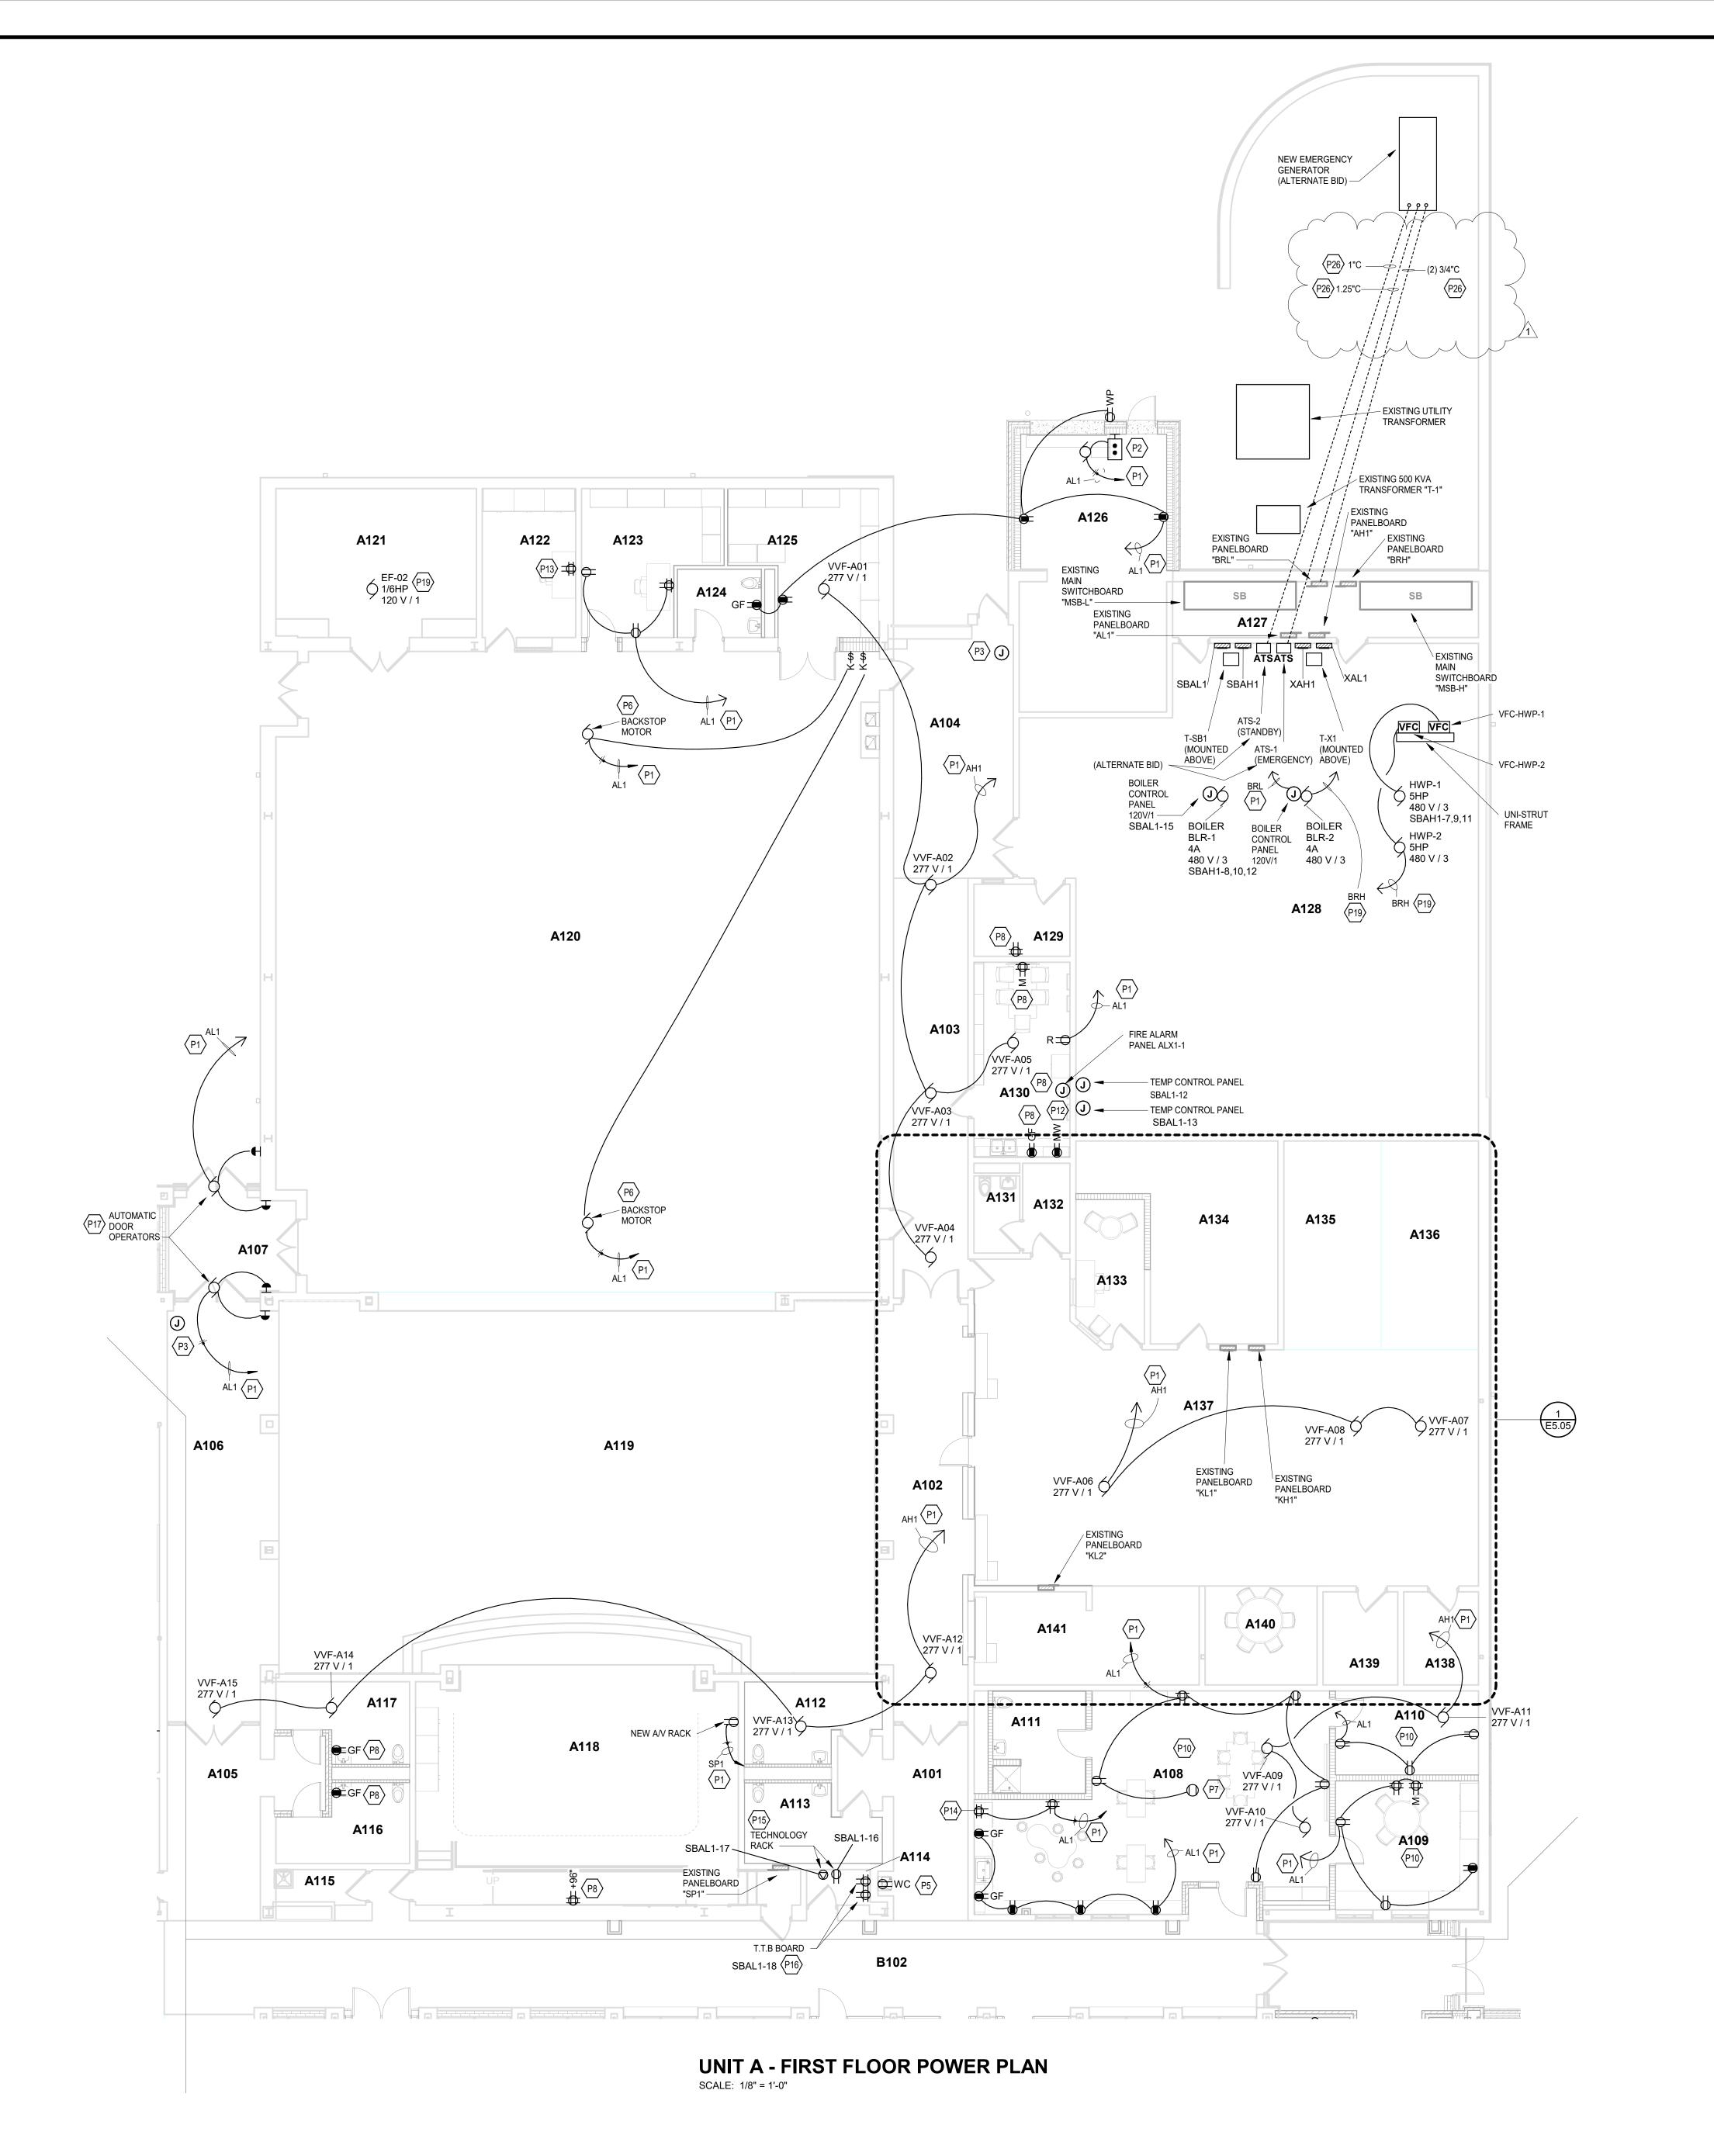GENERAL NOTES - POWER

PROVIDE REVISED TYPED PANELBOARD DIRECTORIES FOR EACH PANELBOARD ADDED OR MODIFIED DURING CONSTRUCTION. FIELD VERIFY EXISTING CIRCUIT INFORMATION WITH OWNER'S ASSISTANCE TO ENSURE FINAL DIRECTORY IS ACCURATE. UNUSED SPARE BREAKERS SHALL BE IN THE OFF POSITION. VIDEO PROJECTOR RECEPTACLE TO BE MOUNTED ABOVE WALL MOUNTED BROJECTOR BRACKET OF A F. E. LINO.

PROJECTOR BRACKET, 96" A.F.F. UNO.
CONTRACTOR SHALL VERIFY ALL DIMENSIONS AND CLEARANCES AND ALL EXISTING
FIELD CONDITIONS BEFORE STARTING CONSTRUCTION. COMMENCEMENT OF WORK
CONSTITUTES ACCEPTANCE OF CONDITIONS. SHOULD DIFFERENT CONDITIONS BE
ENCOUNTERED, CONTACT THE ARCHITECT BEFORE PROCEEDING WITH WORK.
LABEL EACH RECEPTACLE WITH THE PANEL NAME AND CIRCUIT NUMBER ON THE FACE

OF EACH COVER PLATE WITH A TYPED LAMINATED LABEL.
PROVIDE "GFCI PROTECTED" LABEL ON COVER PLATE FOR ANY GFCI PROTECTED DEVICE.
CONTRACTOR SHALL INCREASE CIRCUIT CONDUCTOR SIZE TO COMPENSATE FOR

VOLTAGE DROP DUE TO EXCESSIVE CIRCUIT LENGTHS. IN NO CASE SHALL VOLTAGE DROP EXCEED NFPA 70 (N.E.C.) REQUIREMENTS.

REFER TO MECHANICAL PLANS FOR LOCATION OF MECHANICAL EQUIPMENT. LOCATE

DISCONNECT SWITCHES PER NEC.

8. REFER TO "CONTROL SCHEMATICS" MECHANICAL DRAWINGS FOR ADDITIONAL CONTROL WIRING AND CONTROL CONNECTIONS.

9. ALL DEVICES. EQUIPMENT, FIXTURES, AND THE LIKE, SHALL BE BONDED WITH A

PROPERLY SIZED EQUIPMENT GROUNDING CONDUCTOR. MAINTAIN
MECHANICAL/ELECTRICAL BONDS OF METALLIC RACEWAY SYSTEM.

10. NEW ELECTRICAL DEVICES THAT ARE TO BE MOUNTED IN EXISTING WALLS ARE TO BE
FLUSH MOUNTED BY RECESSING A NEW BACK BOX IN THE WALL, THEN FISHING
FLEXIBLE CONDUIT DOWN THE WALL TO THE NEW BACK BOXS OR BY RE-USING AND
EXISTING BACK BOX AND CONDUIT IN CLOSE PROXIMITY TO THE NEW ELECTRICAL

11. ALL EXISTING DUPLEX RECEPTACLES INSIDE AND OUTSIDE OF THE BUILDING ARE TO BE REPLACED WITH NEW DEVICES AND COVER PLATES.
12. ALL NEW ELECTRICAL DEVICES MOUNTED IN WALL WITH TACKABLE WALL SURFACE "TWS" ARE TO BE PROVIDED WITH AN EXTENSION RING ON THE BACKBOX.

	KEYNOTES
P1	WIRE TO A SPARE 20-AMP, 1-POLE CIRCUIT BREAKER IN EXISTING DESIGNATED PANELBOARD.
2	CONTROLLER IS PROVIDED BY THE UNIT MANUFACTURER.
⊃3	SECURITY JUNCTION BOX MOUNTED ABOVE THE CEILING FOR THE DOOR SECURITY DEVICES AND POWER. WIRE TO THE NEAREST DUPLEX RECEPTACLE CIRCUIT IN THIS ROOM.
25	EXISTING DUPLEX RECEPTACLE AT THIS LOCATION IS TO BE REPLACED WITH A NEW DUPLEX RECEPTACLE AND USED FOR NEW WATER COOLER.
P 6	CONTROLLER FOR BACKSTOP ARE PROVIDED BY THE BACKSTOP MANUFACTURER. CONDUIT, BACKBOXES, AND WIRING FOR THE CONTROLLER AND BACKSTOP MOTOR ARE PROVIDED BY THE DIVISION 26 CONTRACTOR PER THE MANUFACTURER'S REQUIREMENTS.
27	NEW CEILING MOUNTED DUPLEX RECEPTACLE FOR VIDEO PROJECTOR. COORDINATE EXACT LOCATION IN THE FIELD WITH VIDEO PROJECTOR LOCATION.
28	WIRE NEW RECEPTACLE TO THE EXISTING RECEPTACLE CIRCUIT IN THIS ROOM.
10	ALL NEW POWER RECEPTACLES IN THIS ROOM BELOW 5'-6" ARE TO BE TAMPER RESISTANT TYPE.
12	MOUNT MICROWAVE RECEPTACLE ABOVE THE SHELF THAT THE MICROWAVE SITS ON. REFER TO ARCHITECTURAL ELEVATION "7/A7.08".
13	THE EXISTING DUPLEX RECEPTACLE AND SINGLE GANG BACKBOX AT THIS LOCATION IS TO BE CHANGED TO A DOUBLE DUPLEX RECEPTACLE WITH A DOUBLE GANG BACKBOX.
14	PROVIDE A DOUBLE DUPLEX RECPETACLE ADJACENT TO THE TECHNOLOGY DATA BOX MOUNTED AT 66 INCHES A.F.F BEHIND THE TEACHERS WARDROBE/TECHNOLOGY CABINET. REFER TO DETAILS ON DRAWING SHEET A7.06 FOR EXACT MOUNTING LOCATION PRIOR TO ROUGH-IN OF BACKBOX.
15	TECHNOLOGY RACK (IDF) RECEPTACLES. COORDINATE MOUNTING LOCATIONS AND INSTALLATION REQUIREMENTS WITH THE TECHNOLOGY CONTRACTOR PRIOR TO ROUGH-IN. PROVIDE #10 CONDUCTORS.
16	TECHNOLOGY RACK (IDF) BACKBOARD RECEPTACLES. REFER TO DETAIL "2/E1.02" FOR MOUNTING LOCATIONS AND INSTALLATION REQUIREMENTS. PROVIDE #10 CONDUCTORS.
917	AUTOMATIC DOOR OPERATOR MOTOR, PUSHBUTTONS AND KEYED SWITCH BY UNIT MANUFACTURER. CONDUIT, BACKBOXES, AND POWER WIRING ARE PROVIDED BY THE DIVISION 26 CONTRACTOR PER THE MANUFACTURER'S REQUIREMENTS. LOCATIONS SHOWN ON THIS DRAWING ARE FOR REFERENCE ONLY. VERIFY EXACT LOCATIONS WITH OPERATOR INSTALLER PRIOR TO ROUGH-IN.

P19 WIRE NEW MECHANICAL UNIT TO EXISTING CIRCUIT(S) AT THIS LOCATION, FROM

THE MECHANICAL UNIT THAT WAS REMOVED.

P26 GENERATOR CONDUITS ARE UNDER THE BASE BID.

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CHERRY TREE
ELEMENTARY
SCHOOL
ADDITIONS AND
RENOVATIONS

13989 Hazel Dell Pkwy, Carmel, IN

CARMEL CLAY SCHOOLS




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CONSULTANT

KEY PLAN



PROJECT MANAGER: SAM
DRAWN BY: RDR
PROJECT NUMBER: 222011.00

PROJECT ISSUE DATE: 02.09.2024

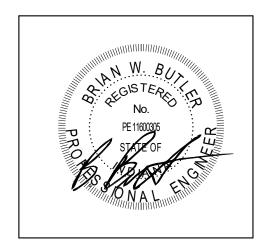NO.	DESCRIPTION	DATE
1	ADDENDUM #1	2-23-24
-		

UNIT A - FIRST FLOOR POWER PLAN

5.01

VERIFICATION NOTE

CONTRACTOR SHALL VERIFY ALL DIMENSIONS AND CLEARANCES AND ALL EXISTING FIELD CONDITIONS BEFORE STARTING CONSTRUCTION. COMMENCEMENT

OF WORK CONSTITUTES ACCEPTANCE OF CONDITIONS.

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SHOULD DIFFERENT CONDITIONS BE ENCOUNTERED,
CONTACT THE ARCHITECT BEFORE PROCEEDING WITH
WORK.



CHERRY TREE ELEMENTARY SCHOOL **ADDITIONS AND** RENOVATIONS

13989 Hazel Dell Pkwy, Carmel, IN 46033

CARMEL CLAY SCHOOLS



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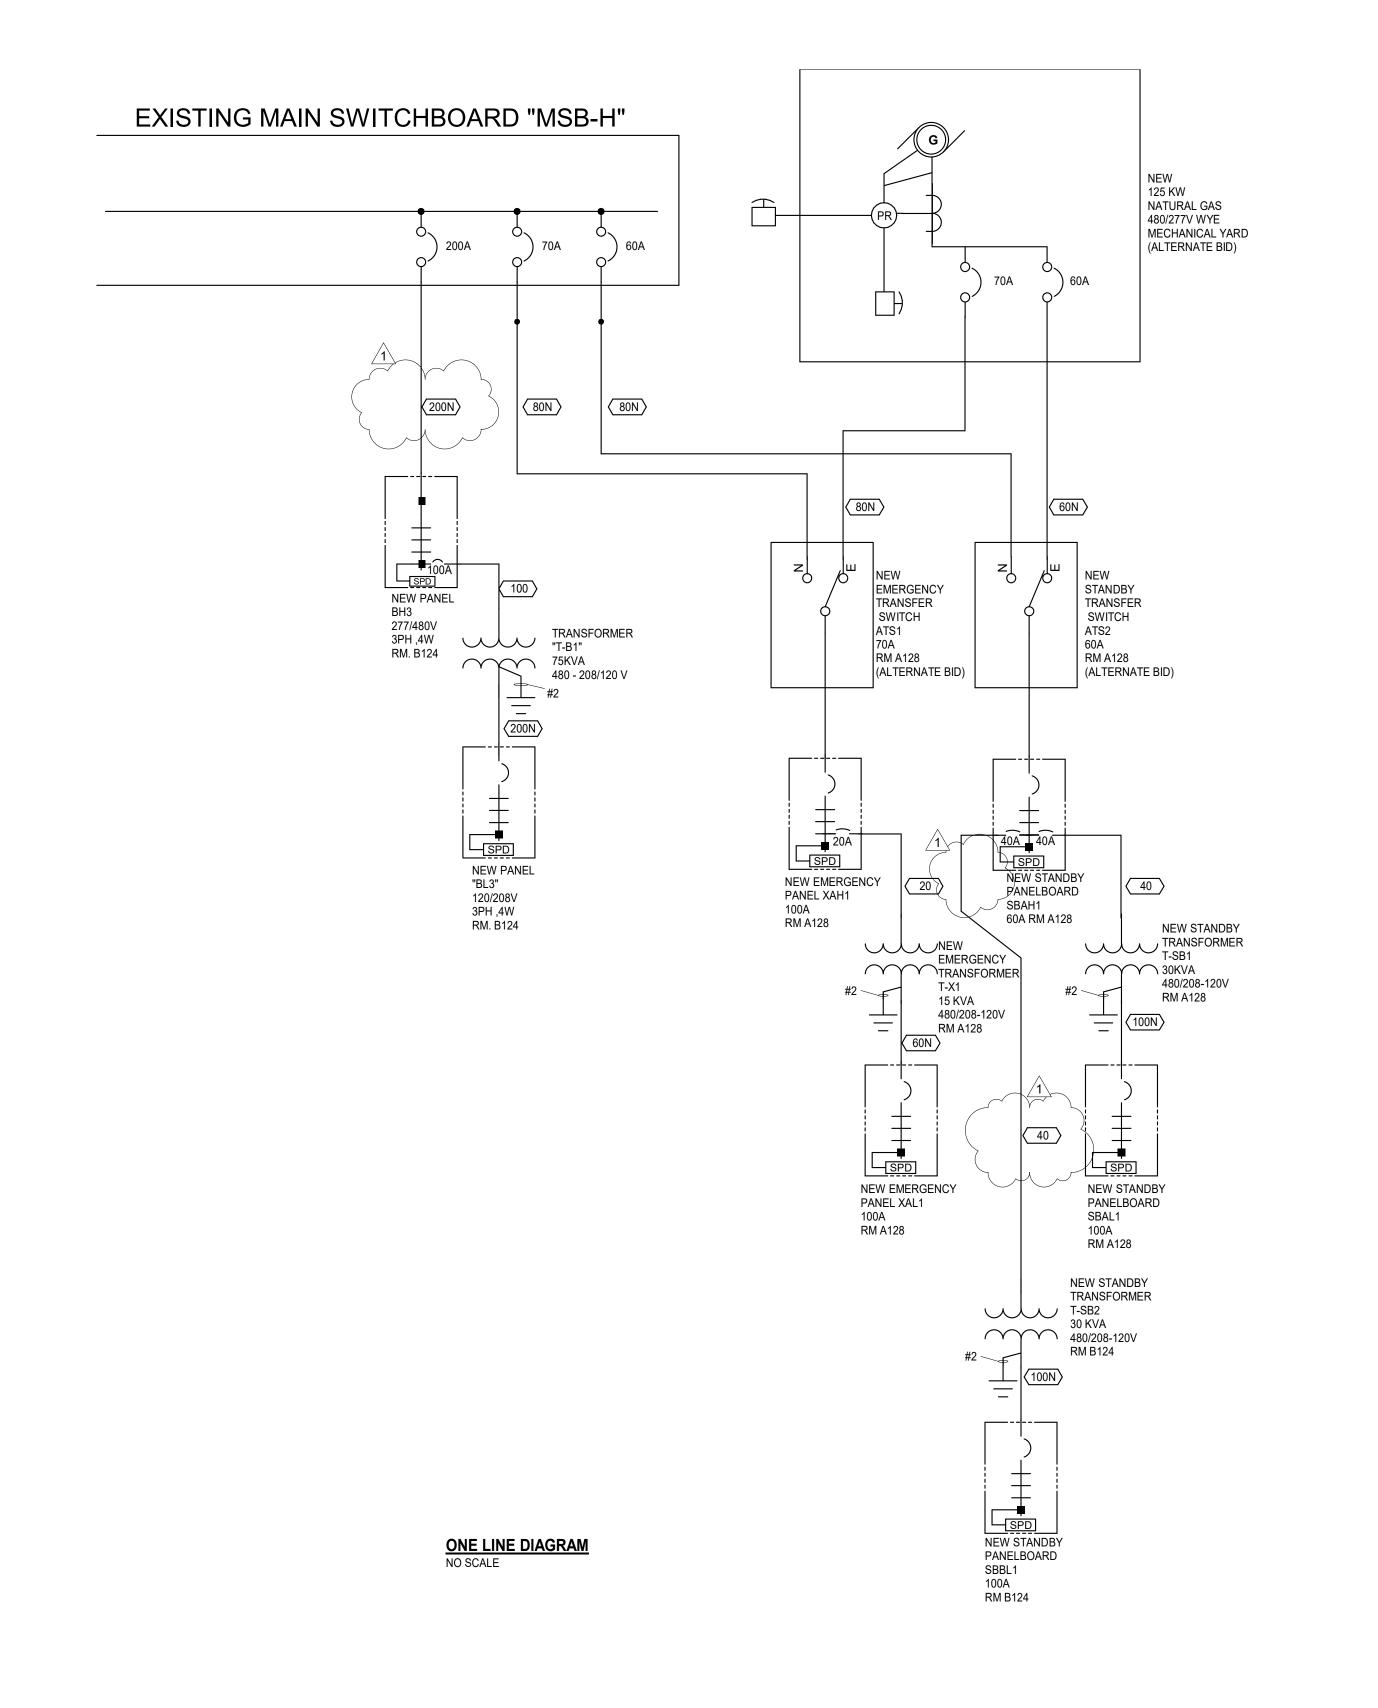
FEEDER	OF	PHASE	NEUTRAL	GROUND	SIZE
LEGEND	SETS	QTY	(1)	(1)	Inches
15	1	3 # 14		#14	3/4
15N	1	3 # 14	#14	#14	3/4
20	1	3 # 12		#12	3/4
20N	1	3 # 12	#12	#12	3/4
30	1	3 # 10		#10	3/4
30N	1	3 # 10	#10	#10	3/4
40	1	3#8		#10	3/4
40N	1	3#8	#8	#10	3/4
60	1	3#6		#10	1
60N	1	3#6	#6	#10	1
80	1	3#4		#8	1 1/4
80N	1	3#4	#4	#8	1 1/4
100	1	3#3		#8	1 1/2
100N	1	3#3	#3	#8	1 1/2
125	1	3#1		#6	2
125N	1	3#1	#1	#6	2
150	1	3 # 1/0		#6	2
150N	1	3 # 1/0	#1/0	#6	2
175	1	3 # 2/0		#6	2
175N	1	3 # 2/0	#2/0	#6	2
200	1	3 # 3/0		#6	2
200N	1	3 # 3/0	#3/0	#6	2
225	1	3 # 4/0		#4	2 1/2
225N	1	3 # 4/0	#4/0	#4	2 1/2
250	1	3 # 250		#4	2 1/2
250N	1	3 # 250	#250	#4	2 1/2
300	1	3 # 350		#3	3
300N	1	3 # 350	#350	#3	3
350	1	3 # 500		#3	4
350N	1	3 # 500	#500	#3	4
400	1	3 # 600		#3	4
400N	1	3 # 600	#600	#3	4
500	2	3 # 250		#2	2 1/2
500N	2	3 # 250	#250	#2	2 1/2
600	2	3 # 350		#1	3
600N	2	3 # 350	#350	#1	3
800	2	3 # 600		#1/0	4
800N	2	3 # 600	#600	#1/0	4
1000	3	3 # 400		#2/0	3
1000N	3	3 # 400	#400	#2/0	3
1200	3	3 # 600		#3/0	4
1200N	3	3 # 600	#600	#3/0	4
1600	4	3 # 600		#4/0	4
1600N	4	3 # 600	#600	#4/0	4
2000	5	3 # 600		#250	4
2000N	5	3 # 600	#600	#250	4
2500	6	3 # 600		#350	4
2500N	6	3 # 600	#600	#350	4
3000	7	3 # 600		#400	4
3000N	7	3 # 600	#600	#400	4
3300	8	3 # 600		#400	4
3300N	8	3 # 600	#600	#400	4
3700	9	3 # 600		#400	4

COPPER FEEDER SCHEDULE

No. PE 11600005 STATE OF
No. PE 1160005 STATE OF WALL A PROPERTY OF THE PROPERTY OF

NO.	DESCRIPTION	DATE
	DESCRIPTION	DAIL
1	ADDENDUM #1	2-23-24
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ELECTRICAL ONE-LINE DIAGRAM



<i>"""</i>					GRAM SYMBOLS	E LINE DIA	ONI			
	FUSED POTENTIAL TRANSFORMER		FUSED SWITCH IN SWITCHBOARD, 3P UNO	-9_OFIL		•	DIGITAL ELECTRONIC POWER METER	DM		
	CURRENT TRANSFORMERS, 3 UNO		DISCONNECT SWITCH IN SWITCHBOARD, 3P UNO	-0,0-	COMBINATION MAGNETIC MOTOR STARTER WITH FUSED SWITCH	る日子と	KIRK KEY INTERLOCK	K	MAIN LUG ONLY CIRCUIT BREAKER PANELBOARD, REFER TO E8 SERIES DRAWINGS FOR PANELBOARD SCHEDULES	#
PROJECT MANAGE			FUSED BOLTED PRESSURE SWITCH WITH GROUND FAULT AND SINGLE PHASE PROTECTION, 3P	(SP) (G)		7	UTILITY METER	— M		1AL1
DRAWN BY: RDR PROJECT NUMBER PROJECT ISSUE DA	CAPACITOR EARTH GROUND		UNO	ON ON	COMBINATION MAGNETIC MOTOR STARTER WITH CIRCUIT BREAKER	1	MAIN BREAKER IN CIRCUIT BREAKER PANELBOARD	<u> </u>	MAIN BREAKER IN	
REV.			TRANSFER SWITCH	—O		\	WITH SUB-FEED BREAKER, REFER TO E8 SERIES DRAWINGS FOR PANELBOARD SCHEDULES	TXXXA	CIRCUIT BREAKER PANELBOARD, REFER TO E8 SERIES DRAWINGS FOR PANELBOARD SCHEDULES	#
1 ADDEN	LIGHTNING ARRESTER	—○ ^{LA} ○—	DISCONNECT, 3P UNO		COMBINATION MAGNETIC MOTOR STARTER WITH MOTOR CIRCUIT	•		5AL1		2AL1
	PLUG AND RECEPTACLE OR DRAWOUT DEVICE	-	MOLDED CASE CIRCUIT BREAKER, 3P UNO	_~_	PROTECTOR	支	MAIN BREAKER IN CIRCUIT BREAKER PANELBOARD		THROUGH FEED LUGS	·
	POWER TRANSFORMER		CIRCUIT BREAKER IN SWITCHBOARD, 3P UNO		COMBINATION MAGNETIC MOTOR	•	WITH INTEGRAL BUS CONNECTED SPD, REFER TO E8 SERIES DRAWINGSFOR PANELBOARD		CIRCUIT BREAKER PANELBOARD, REFER TO E8 SERIES DRAWINGS FOR PANELBOARD SCHEDULES	#
			INSULATED CASED POWER CIRCUIT BREAKER WITH L.I.S.G. PROTECTION FEATURES, 3P UNO	—	STARTER WITH VARIABLE SPEED CONTROLLER	vsc	SCHEDULES	SPD 6AL1		3AL1
	3 PHASE MOTOR. X INDICATES HORSEPOWER OR KILOWATTS	(x)/	DRAWOUT CIRCUIT BREAKER, 3P UNO	- ⟨ -⟨-⟨-⟩-⟩-		•	MAIN BREAKER IN CIRCUIT BREAKER PANELBOARD		MAIN DOUBLE LUG	
ELECTRIC	CONTROL PANEL FURNISHED UNDER DIVISION 25	СР	SHUNT TRIP OPERATED CIRCUIT	(S)	COMBINATION MAGNETIC MOTOR STARTER WITH ELECTRONIC OVERLOADS		WITH SPD MOUNTED ADJACENT WITH CLOSED NIPPLE, REFER TO E8 SERIES DRAWINGS	— ↑ SPD	CIRCUIT BREAKER PANELBOARD, REFER TO E8 SERIES DRAWINGS FOR PANELBOARD SCHEDULES	#

LUMINAIRE SCHEDULE - GENERAL NOTES

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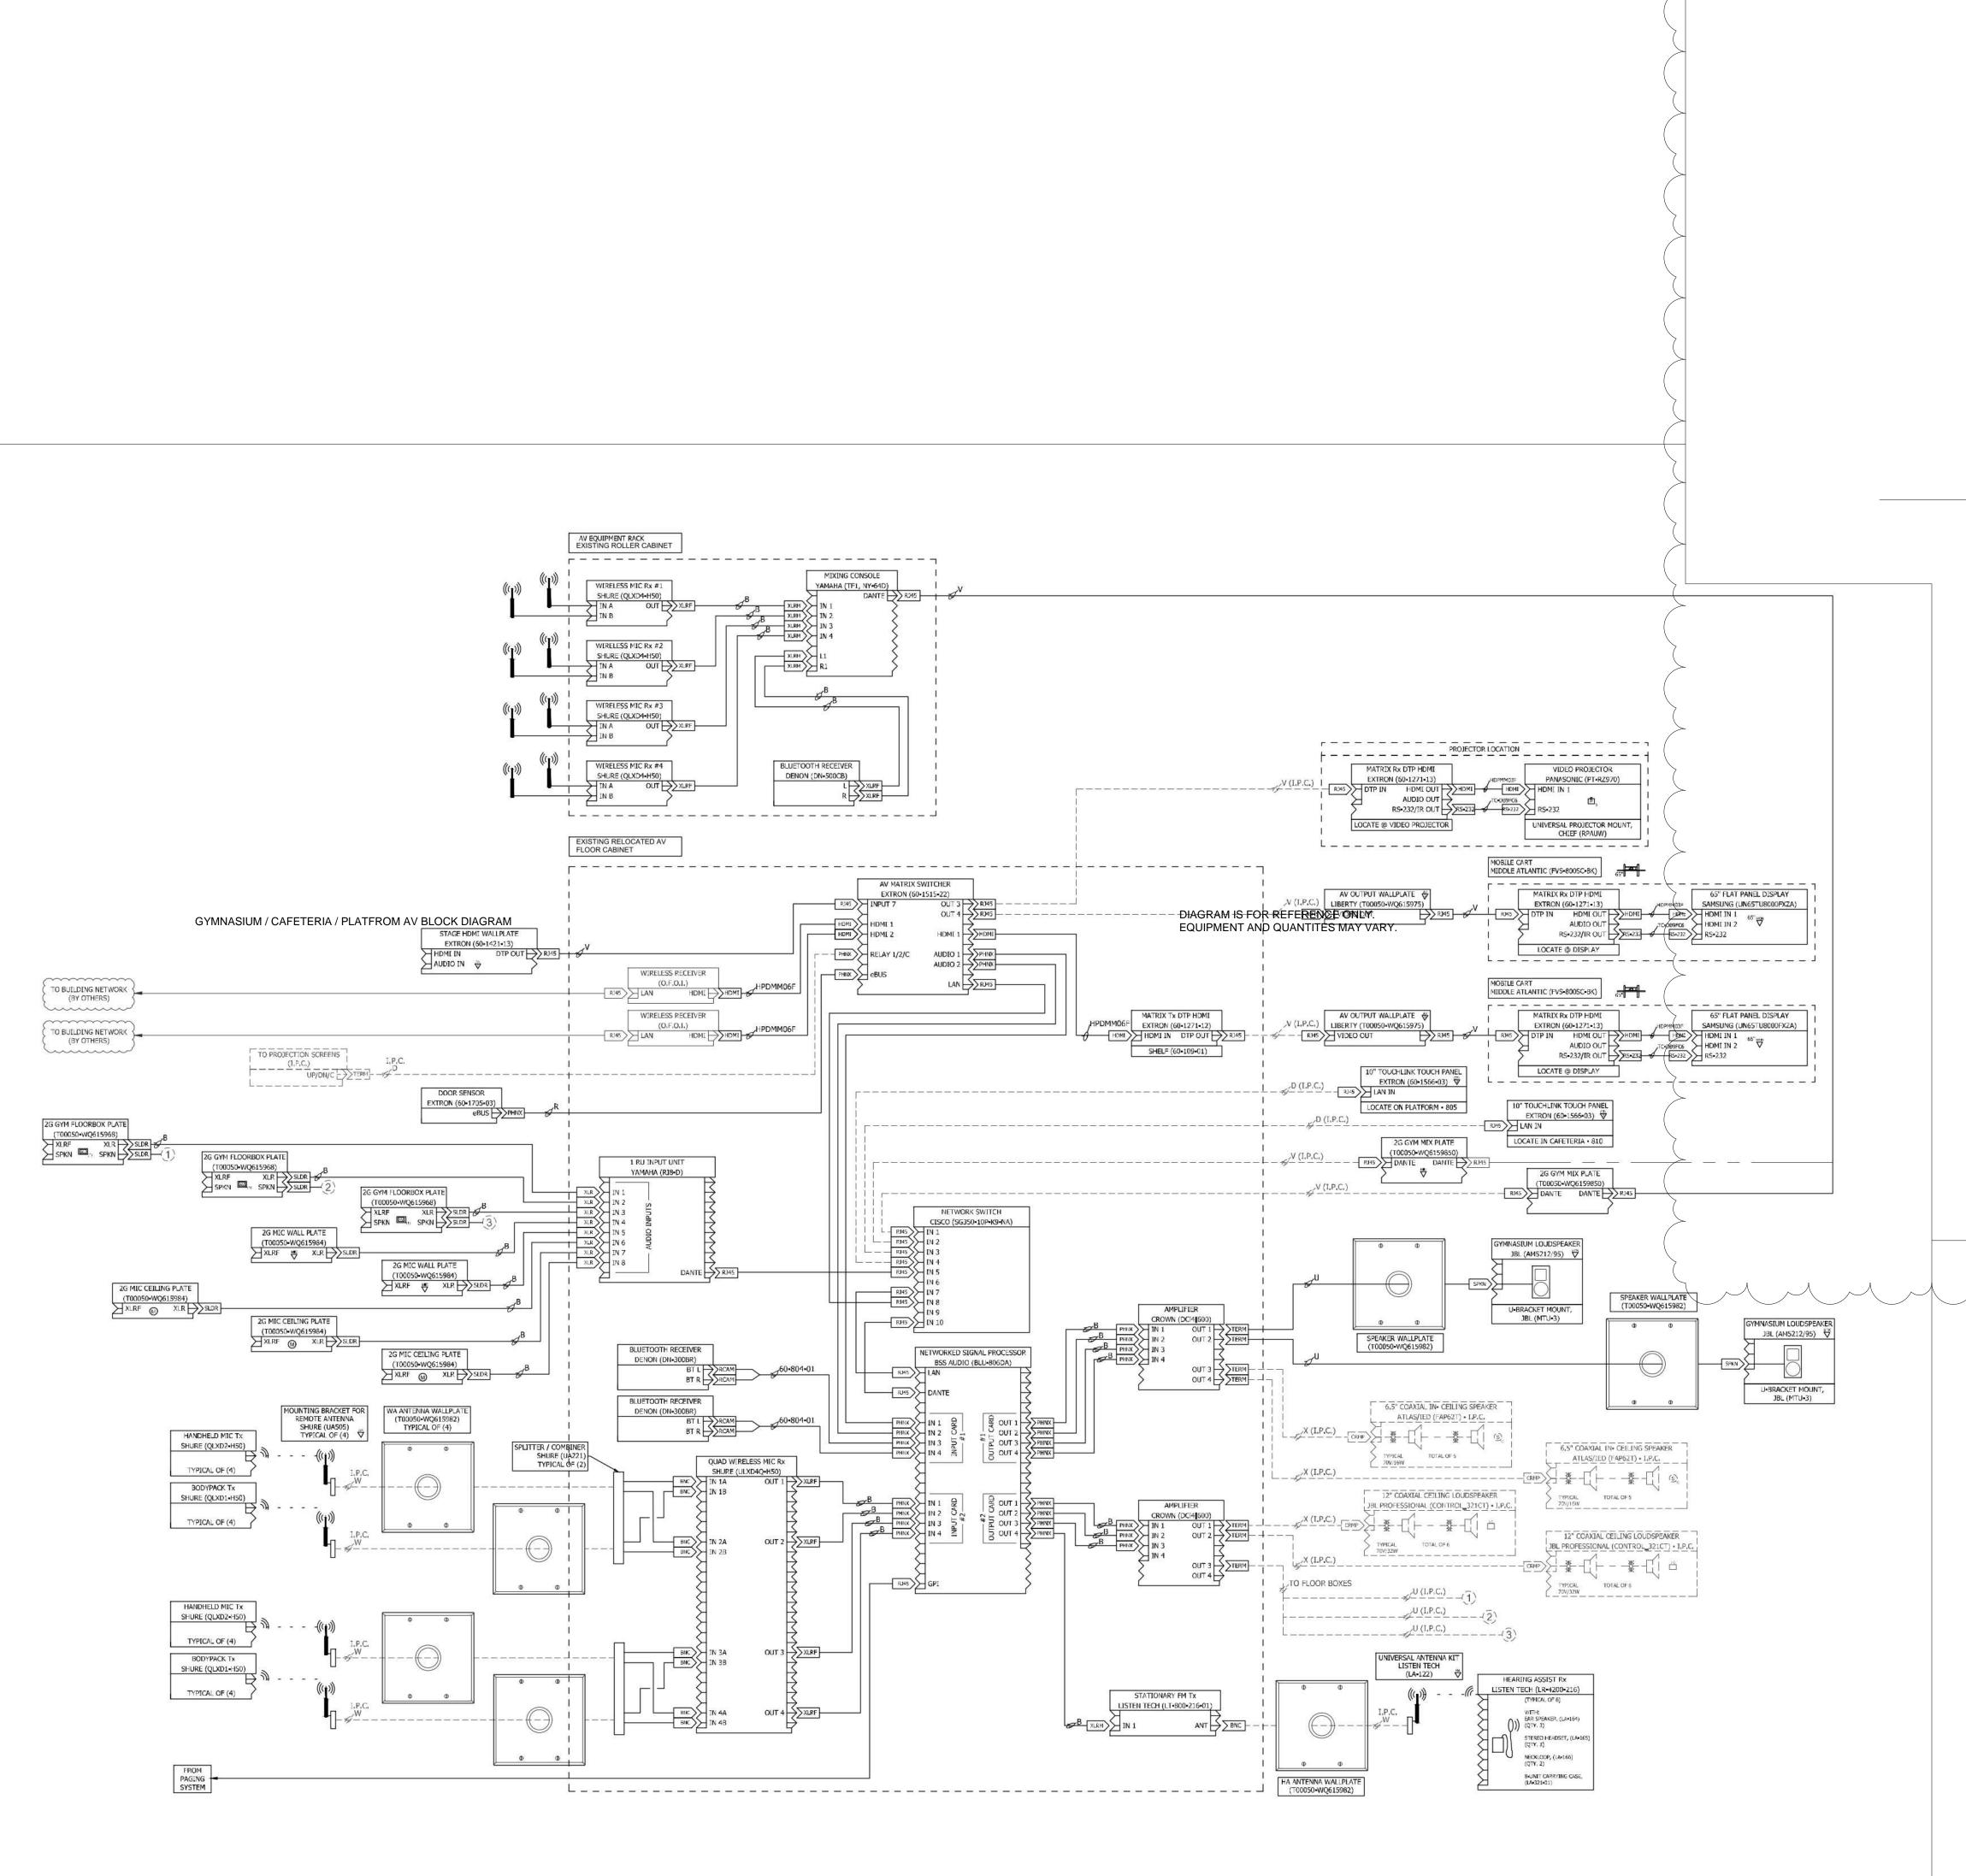
WWW.FHAI.COM 350 E. NEW YORK ST, INDIANAPOLIS IN 46204

PROJECT MANAGER: SAM DRAWN BY: RDR PROJECT NUMBER: 222011.00 PROJECT ISSUE DATE: 02.09.2024

TROULGTIO	30E DATE. 02.09.2024	
REV.	DECODIDATION	DATE
NO.	DESCRIPTION	DATE
1	ADDENDUM #1	2-23-24
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LUMINAIRE & PANELBOARD SCHEDULES

LUMINAIRE SCHEDULE - GENERAL NOTES							LUMINAIRE SCHEDULE	Branch Panel: BH3 Location: ELEC B124		Volts : 480/2	277 Wve	A.I.C. Rating: 10 kA
 SEE SPECIFICATIONS FOR DRIVER REQUIREMENTS. FOR ALL DOWNLIGHTING FIXTURES, PROVIDE REQUIRED MOUNTING HARDWARE FOR MOUNTING IN LAY-IN TYPE CEILINGS. 	PLAN TYPE	MANUFACTURER/CATALOG	MOUNTING I	LAMPS NO. WATTS		MENS VOLTAG		VA Supply From: MSB-H Mounting: Surface		Phases: 3 Wires: 4	zrr wye	Mains Type: M.L.O Mains Rating: 200 A
3. CONTRACTOR TO VERIFY TYPES AND QUANTITY OF LIGHT FIXTURES REQUIRING EMERGENCY BATTERY UNITS AND PROVIDE REQUIRED QUANTITY OF EMERGENCY BATTERY UNITS, LABOR,	C2	JESCO LIGHTING	SURFACE WALL 1 COVE 1		LED 0 lr	m 277 V 4 lm 277 V	4-FOOT ADJUSTABLE MEDIUM OUTPUT. WALL MOUNTED LED UPLIGHT ASYMMETRIC FIXTURE. TEXTURED WHITE. FLEXIBLE LINEAR LED STRIP LIGHTING MOUNTED IN COVE.	36 VA 5.5 VA Notes: INTEGRAL SURGE PROTECTION				MCB Rating: 200 A
MATERIAL, ETC. IN THE PROJECT BID FOR FIELD INSTALLATION OF EMERGENCY BATTERY UNITS.	C3	DL-AC-FLEXZ-BEAM SERIES EXTANT HTG-IR-LP SERIES	RECESSED 1			3 lm 277 V	1.5 - INCH APERTURE RECESSED LED TRIMLESS FIXTURE. LENGTH PER DRAWINGS. INTERGRAL DRIVER, MUD RING.	1.8 VA CKT Circuit Description	Trip Poles A (VA)	R (VA)	C (VA)	Poles Trip Circuit Description
4. LIGHT FIXTURE SUBMITTALS TO INCLUDE DATA SHEETS FOR ALL FIXTURE TYPES, INCLUDING ADDITIONAL DATA SHEETS FOR	D1	MODALIGHT ELV SERIES A-LIGHT LEAN SERIES	COVE 1 RECESSED 1	40.0 W	LED 370	66 lm 277 V 04 lm 277 V	4-FOOT LED COVE LIGHT FIXTURES ADJUSTABLE 120 DEGREE BEAM ANGLE. 2'BY2' INDIRECT RECESSED LAY-IN, WITH ACOUSTIC COLOR OPTION AS SHOWN ON DRAWINGS.	40 VA 1 Transformer TB1	100 A 3 14812 14	B (VA) 412 15014 416	C (VA)	1 20 A Lighting - RM B108-B113 1 20 A VVF'S - B121, B131, B132
DRIVER COMBINATIONS REQUIRED TO MEET THE INSTALLATION REQUIREMENTS OF THE VARIOUS FIXTURE TYPES INDICATED IN THE REMARKS COLUMN OF THE FIXTURE SCHEDULES OR ON THE		A-LIGHT LEAN SERIES	RECESSED 1			04 lm 277 V	TRANSFER DEVICE.	40 VA 5			13584 416	1 20 A VVF'S - B117, B119, B129, B130
DRAWINGS. SUBMITTALS SHALL ALSO INDICATE COLOR FOR ANY CUSTOM COLOR LIGHT FIXTURES.	FL1	FLUXWERX PORTAL TC1 SERIES	BRACKET 1			00 lm 277 V 32 lm 277 V	5.5 INCH MEDIUM BEAM, 80 CRI, WHITE POWDER COAT FIXTURE/TRIM FINISH AND OPTIC CHANNEL FINISH. ROOFTOP MOUNTED LED FLOOD LIGHT AIMED TO ILLUMINATE THE ENTRY TOWER.	9 VA 7 Lighting - RM B114-B120, B128-B129 9 Lighting - RM B121-B127, B130-135, B201	20 A 1	12 1097 185		1 20 A VVF'S - B111, B112, B113 3 20 A AHU-3 6.7 FLA RM B201 (NOTE 1)
COLOR TEMPERATURE FOR ALL FIXTURES IS TO BE 4000K UNLESS NOTED OTHERWISE.	FL2	STONECO FL20 SERIES COOPER INVUE VFS SERIES	MOUNTED GROUND MOUNTED	46.0 W	LED 413	32 lm 277 V	GROUND MOUNTED LED FLOOD LIGHT AIMED TO ILLUMINATE TO THE LETTERS ON THE FACE OF THE BUILDING. WIDE SYMMETRIC RECTANGULAR DISTRIBUTION.	11 VVF'S B107, B108, B109, B110 46 VA 13 Spare	20 A 1 0 18	356	416 1856	
UNDER THE ALTERNATE BID FOR THE EMERGENCY GENERATOR ALL EMERGENCY LIGHT FIXTURES AND EXIT SIGNS ARE TO BE		PORTFOLIO LER4B SERIES GOTHAM INCITO 4 SERIES	PENDANT 1	12.0 W	LED 100	00 lm 277 V	4-INCH APERATURE OPEN REFLECTOR LED CYLINDER DOWNLIGHT, SURFACE MOUNTED WITH NO STEM. MEDIUM DISTRIBUTION, CLEAR SPECULAR REFLECTOR, 0-10VDC DIMMING FIXTURE HOUSING WHITE IN COLOR.	12 VA 15 Spare 17 Spare	20 A 1 20 A 1	0 554	0 5540	3 40 A ACCU-3 25 MCA ROOFTOP (NOTE 2
PROVIDED WITH AN EMERGENCY TRANSFER DEVICES. UNDER THE BASE BID THEY ARE TO BE PROVIDE WITH AN EMERGENCY	✓ L	PRESCOLITE LTC-4RD SERIES PORTFOLIO LD6A SERIES	RECESSED 1	22.0 W	LED 150	00 lm 277 V	6-INCH ROUND APERTURE OPEN REFLECTOR LED DOWNLIGHT, MEDIUM DISTRIBUTION, CLEAR SPECULAR FINISH,	19 Spare 19 VA 21 Spare	20 A 1 0 55 20 A 1	0 0		 1 20 A Spare
BATTERY UNIT.		GOTHAM EVO SERIES PRESCOLITE LF6LED SERIES				277 7	SELF-FLANGED, 0-10VDC DIMMING, BAR HANGER ACCESSORY. FIXTURES IN SERVING AREA ARE TO BE EITHER 3000K OR 3500K AS NOTED, ALL OTHER INSTANCES TO BE 4000K	23 Spare 25 Spare	20 A 1 0	0	0 0	1 20 A Spare 1 20 A Spare
		PORTFOLIO LD6A SERIES GOTHAM EVO SERIES	RECESSED 1	22.0 W	LED 150	00 lm 277 V	6-INCH ROUND APERTURE OPEN REFLECTOR LED DOWNLIGHT, MEDIUM DISTRIBUTION, CLEAR SPECULAR FINISH, SELF-FLANGED, 0-10VDC DIMMING, BAR HANGER ACCESSORY, WITH EMERGENCY TRANSFER DEVICE.	22 VA 27 Spare 29 Spare	20 A 1 20 A 1	0 0	0 0	1 20 A Spare 1 20 A Spare
	LD62	PRESCOLITE LF6LED SERIES PORTFOLIO LD6A SERIES GOTHAM EVO SERIES	RECESSED 1	22.0 W	LED 200	00 lm 277 V	6-INCH ROUND APERTURE OPEN REFLECTOR LED DOWNLIGHT, MEDIUM DISTRIBUTION, CLEAR SPECULAR FINISH, SELF-FLANGED, 0-10VDC DIMMING, BAR HANGER ACCESSORY. FIXTURES IN SERVING AREA ARE TO BE EITHER 3000K OR 3500K	19 VA 31 Spare 33 Spare	20 A 1 0	0 0 0	0 0	1 20 A Spare 1 20 A Spare
		PRESCOLITE LF6LED SERIES PORTFOLIO LD6A SERIES	RECESSED 1	22.0 W	LED 200	00 lm 277 V	AS NOTED, ALL OTHER INSTANCES TO BE 4000K 6-INCH ROUND APERTURE OPEN REFLECTOR LED DOWNLIGHT. MEDIUM DISTRIBUTION. CLEAR SPECULAR FINISH.	35 Spare	20 A 1	0 0	0 0	1 20 A Spare
		GOTHAM EVO SERIES PRESCOLITE LF6LED SERIES	RECESSED 1	22.0 VV	LED 200	00 IM 277 V	SELF-FLANGED, 0-10VDC DIMMING, BAR HANGER ACCESSORY, WITH EMERGENCY TRANSFER DEVICE.	22 VA 37 Spare 39 Spare	20 A 1 0 20 A 1	0 0 0		1 20 A Spare 1 20 A Spare
	LDW61	PORTFOLIO LD6A SERIES GOTHAM EVO SHOWER SERIES	RECESSED 1	15.0 W	LED 100	00 lm 277 V	6-INCH ROUND APERTURE LED SHOWER LIGHT WITH REGRESSED LENS REFLECTOR, WHITE REFLECTOR AND TRIM, SELF-FLANGED, IP65 WET LOCATION LISTED.	15 VA 41 Spare	20 A 1 25244 V	A 23923 VA	0 0 21812 VA	1 20 A Spare
		PRESCOLITE LF6LEDG4 SERIES McGRAW-EDISON LIGHTING	SURFACE WALL 1		LED	277 V	HALF-CYLINDER LED WALL MOUNTED LUMINAIRE WITH DIE CAST ALUMINUM HOUSING, BOTTOM DIFFUSER FLUSH WITH THE DIE	20 VA Legend:	Total Amps: 92 A	88 A	79 A	
		GARDCO LIGHTING LITHONIA LIGHTING					CASTING, TYPE 3 DISTRIBUTION, 70 CRI LEDs. LUMINAIRE COLOR: FROM MANUFACTURER STANDARD COLORS. MOUNT ONTO JUNCTION BOX. VANDAL RESISTANT					
		SPAULDING LIGHTING BEACON GEOPAK SERIES	DE05005D		155 40			Load Classification	Connected Load	Demand Factor	Estimated De	
		LITHONIA CPX SERIES COLUMBIA CFP SERIES EATON METALUX CGT SERIES	RECESSED 1	39.0 W	LED 400	00 lm 277 V	2 BY 4-FOOT BACK LIT FLAT PANEL WITH ALUMINUM FRAME, 1% 0-10V DIMMING.	39 VA Lighting Motor	3821 VA 12058 VA	100.00% 111.54%	3821 VA 13450 VA	A Total Conn. Load: 70979 VA
	LF1A	LITHONIA CPX SERIES COLUMBIA CFP SERIES	RECESSED 1	39.0 W	LED 400	00 lm 277 V	1 BY 4-FOOT BACK LIT FLAT PANEL WITH ALUMINUM FRAME, 1% 0-10V DIMMING.	Other Receptacle - Convenience	0 VA 27720 VA	0.00% 68.04%	0 VA 18860 VA	A Total Est. Demand: 58833 VA Total Conn.: 85 A
		EATON METALUX CGT SERIES LITHONIA CPX SERIES	RECESSED 1	39.0 W	LED 400	00 lm 277 V	1 BY 4-FOOT BACK LIT FLAT PANEL WITH ALUMINUM FRAME, 1% 0-10V DIMMING, EMERGENCY TRANSFER DEVICE.	HVAC Receptacle - Undercounter Ref.	18180 VA 1200 VA	90.00% 70.00%	16362 VA 840 VA	
		COLUMBIA CFP SERIES EATON METALUX CGT SERIES	THE SECOLD 1			277 V	TET TOOL BROKEN LET LET TRANSCOMMENT AND TO VERY BUILDING CONTROLLED BY THE WAR IN THE W	Receptacle - Refrigerator Receptacle - Microwave	2000 VA 3000 VA	80.00% 50.00%	1600 VA 1500 VA	
		LITHONIA CPX SERIES COLUMBIA CFP SERIES	RECESSED 1	39.0 W	LED 400	00 lm 277 V	2 BY 4-FOOT BACK LIT FLAT PANEL WITH ALUMINUM FRAME, 1% 0-10V DIMMING, EMERGENCY TRANSFER DEVICE.	39 VA Receptacle - Copy Machine	3000 VA	80.00%	2400 VA	
	LF1XA	EATON METALUX CGT SERIES LITHONIA CPX SERIES	RECESSED 1	39.0 W	LED 400	00 lm 277 V	1 BY 4-FOOT BACK LIT FLAT PANEL WITH ALUMINUM FRAME, 1% 0-10V DIMMING, EMERGENCY TRANSFER DEVICE.	39 VA NOTE 1: CONNECT WITH 3#12, #12G IN 3/4"C. NOTE 2: CONNECT WITH 3#8, #10G IN 1"C.				
		COLUMBIA CFP SERIES EATON METALUX CGT SERIES										
		LITHONIA CPX SERIES COLUMBIA CFP SERIES EATON METALUX CGT SERIES	RECESSED 1	47.0 W	LED 480	00 lm 277 V	2 BY 4-FOOT BACK LIT FLAT PANEL WITH ALUMINUM FRAME, 1% 0-10V DIMMING.	47 VA				
	LF2X	LITHONIA CPX SERIES COLUMBIA CFP SERIES	RECESSED 1	47.0 W	LED 480	00 lm 277 V	2 BY 4-FOOT BACK LIT FLAT PANEL WITH ALUMINUM FRAME, 1% 0-10V DIMMING, EMERGENCY TRANSFER DEVICE.	Branch Panel: BL3		Voltor 200/a	100 \\\\\\	ALC Potings 40 kA
		EATON METALUX CGT SERIES LITHONIA CPX SERIES	RECESSED 1	53.0 W	LED 600	00 lm 277 V	2 BY 4-FOOT BACK LIT FLAT PANEL WITH ALUMINUM FRAME, 1% 0-10V DIMMING.	Supply From: TB1		Volts: 208/1 Phases: 3	120 wye	A.I.C. Rating: 18 kA Mains Type: MCB
		COLUMBIA CFP SERIES EATON METALUX CGT SERIES	REOLOGED	33.0 **		277 V	2 BT 4-1 GOT BACK EITT BATT AIREE WITH ALCOMING WITHAIRIE, 170 G-10V BIIVIINING.	Enclosure: Type 1		Wires: 4		Mains Rating: 200 A MCB Rating: 200 A
1					. ==	00 lm , 277 V						
		LITHONIA CPX SERIES CQLUMBIA-CFP SERIES	RECESSED 1	53.0 W	LED 600	<u> </u>	2 BY 4-FOOT BACK LIT FLAT PANEL WITH ALUMINUM FRAME, 1% 0-10V DIMMING. EMERGENCY TRANSFER DEVICE.	Notes: INTEGRAL SURGE PROTECTION				
	LFW2	COLUMBIA CAP SERIES EATON METALUX CGT SERIES LITHONIA CPX SERIES	I // // // //			00 lm 277 V		Notes: INTEGRAL SURGE PROTECTION 47 VA CKT Circuit Description	Trip Poles A	В	С	Poles Trip Circuit Description
	LFW2	COLUMBIA CAP SERIES EATON METALUX CGT SERIES LITHONIA CPX SERIES COLUMBIA CFP SERIES EATON METALUX CGT SERIES	RECESSED 1	47.0 W	LED 480	00 lm 277 V	2 BY 4-FOOT BACK LIT FLAT PANEL WITH ALUMINUM FRAME, 1% 0-10V DIMMING. DAMP LOCATION.	47 VA CKT Circuit Description 1 Receptacle - B109, B108 3 AUTOMATIC DOOR RM - B108	<u> </u>	B 00 1127 0	С	Poles Trip Circuit Description 1 20 A RECEPTS RM - B122, B201 1 20 A AHU LIGHTS/RECEPTS RM - B201
	LFW2	COLUMBIA CAP SERIES EATON METALUX CGT SERIES LITHONIA CPX SERIES COLUMBIA CFP SERIES EATON METALUX CGT SERIES LITHONIA CPX SERIES COLUMBIA CFP SERIES		47.0 W	LED 480			47 VA	20 A 1 1080 9 20 A 1 20 A 1	1127 0	1127 470	1 20 A RECEPTS RM - B122, B201 1 20 A AHU LIGHTS/RECEPTS RM - B201 1 20 A EF 16, PUH-B1 RM - B201
	LFW2 LFW2X LPB1	COLUMBIA CAP SERIES EATON METALUX CGT SERIES LITHONIA CPX SERIES COLUMBIA CFP SERIES EATON METALUX CGT SERIES LITHONIA CPX SERIES COLUMBIA CFP SERIES EATON METALUX CGT SERIES COOPER INVUE	RECESSED 1 RECESSED 1 BALLARD 1	47.0 W I 37.0 W I	LED 480 LED 480 LED 121	00 lm 277 V 00 lm 277 V 76 lm 277 V	2 BY 4-FOOT BACK LIT FLAT PANEL WITH ALUMINUM FRAME, 1% 0-10V DIMMING. DAMP LOCATION. 2 BY 4-FOOT BACK LIT FLAT PANEL WITH ALUMINUM FRAME, 1% 0-10V DIMMING WITH AN EMERGENCY TRANSFER DEVICE, DAMP LOCATION 36 - INCH TALL BALLARD, DIE CAST ALUMINUM HOUSING SYMETRIC DISTRIBUTION.	47 VA CKT Circuit Description 1 Receptacle - B109, B108 3 AUTOMATIC DOOR RM - B108 5 AUTOMATIC DOOR RM - B108 7 AUTOMATIC DOOR RM - B108 7 AUTOMATIC DOOR RM - B108 37 VA 9 AUTOMATIC DOOR RM - B101	20 A 1 1080 9 20 A 1 20 A 1 20 A 1 1127 3 20 A 1	-	1127 470	1 20 A RECEPTS RM - B122, B201 1 20 A AHU LIGHTS/RECEPTS RM - B201 1 20 A EF 16, PUH-B1 RM - B201 1 20 A EF-14, EF-16, CUH-B1 1 20 A RECEPTS RM - B115
	LFW2 LFW2X LPB1 LR2	COLUMBIA CAP SERIES EATON METALUX CGT SERIES LITHONIA CPX SERIES COLUMBIA CFP SERIES EATON METALUX CGT SERIES LITHONIA CPX SERIES COLUMBIA CFP SERIES EATON METALUX CGT SERIES COOPER INVUE METALUX WNLED SERIES LITHONIA SBL SERIES	RECESSED 1	47.0 W I 37.0 W I	LED 480 LED 480 LED 121	00 lm 277 V 00 lm 277 V	2 BY 4-FOOT BACK LIT FLAT PANEL WITH ALUMINUM FRAME, 1% 0-10V DIMMING. DAMP LOCATION. 2 BY 4-FOOT BACK LIT FLAT PANEL WITH ALUMINUM FRAME, 1% 0-10V DIMMING WITH AN EMERGENCY TRANSFER DEVICE, DAMP LOCATION 36 - INCH TALL BALLARD, DIE CAST ALUMINUM HOUSING SYMETRIC DISTRIBUTION.	47 VA CKT Circuit Description 1 Receptacle - B109, B108 3 AUTOMATIC DOOR RM - B108 5 AUTOMATIC DOOR RM - B108 7 AUTOMATIC DOOR RM - B108 37 VA 9 AUTOMATIC DOOR RM - B101 27 VA 11 AUTOMATIC DOOR RM - B101 13 RECEPTS RM - B110	20 A 1 1080 9 20 A 1	1127 0 85 1127 144	1127 470 10 1127 1440	1 20 A RECEPTS RM - B122, B201 1 20 A AHU LIGHTS/RECEPTS RM - B201 1 20 A EF 16, PUH-B1 RM - B201 1 20 A EF-14, EF-16, CUH-B1 1 20 A RECEPTS RM - B115 1 20 A RECEPTS RM - B116 1 20 A RECEPTS RM - B117
	LFW2X LFW2X LPB1 LR2	EATON METALUX CGT SERIES LITHONIA CPX SERIES COLUMBIA CFP SERIES EATON METALUX CGT SERIES EATON METALUX CGT SERIES LITHONIA CPX SERIES COLUMBIA CFP SERIES EATON METALUX CGT SERIES EATON METALUX CGT SERIES COOPER INVUE METALUX WNLED SERIES LITHONIA SBL SERIES COLUMBIA LAW SERIES METALUX WNLED SERIES	RECESSED 1 RECESSED 1 BALLARD 1	47.0 W I 47.0 W I 37.0 W I 48.0 W I	LED 480 LED 122 LED 400	00 lm 277 V 00 lm 277 V 76 lm 277 V	2 BY 4-FOOT BACK LIT FLAT PANEL WITH ALUMINUM FRAME, 1% 0-10V DIMMING. DAMP LOCATION. 2 BY 4-FOOT BACK LIT FLAT PANEL WITH ALUMINUM FRAME, 1% 0-10V DIMMING WITH AN EMERGENCY TRANSFER DEVICE, DAMP LOCATION 36 - INCH TALL BALLARD, DIE CAST ALUMINUM HOUSING SYMETRIC DISTRIBUTION. 4-FOOT LED WRAP AROUND FIXTURE, ACRYLIC PRISMATIC DIFFUSER, 0-10VDC DIMMING. IF SUSPENDED, INSTALL AT 8-FOOT AFF WITH CONDUIT STEMS (UNO). 4-FOOT LED WRAP AROUND FIXTURE, ACRYLIC PRISMATIC DIFFUSER, 0-10VDC DIMMING, WITH EMERGENCY TRANSFER DEVICE.	47 VA CKT Circuit Description 1 Receptacle - B109, B108 3 AUTOMATIC DOOR RM - B108 5 AUTOMATIC DOOR RM - B108 7 AUTOMATIC DOOR RM - B108 37 VA 9 AUTOMATIC DOOR RM - B101 27 VA 11 AUTOMATIC DOOR RM - B101 13 RECEPTS RM - B100 15 RECEPTS RM - B101, B109 27 VA 17 RECEPTS RM - B109	20 A 1 1080 9 20 A 1	1127 0 85 1127 144 080 1800 900	1127 470 10 1127 1440	1 20 A RECEPTS RM - B122, B201 1 20 A AHU LIGHTS/RECEPTS RM - B201 1 20 A EF 16, PUH-B1 RM - B201 1 20 A EF-14, EF-16, CUH-B1 1 20 A RECEPTS RM - B115 1 20 A RECEPTS RM - B116 1 20 A RECEPTS RM - B117 1 20 A RECEPTS RM - B117 1 20 A RECEPTS RM - B118 1 20 A RECEPTS RM - B129
	LFW2X LFW2X LPB1 LR2 LR2X	EATON METALUX CGT SERIES LITHONIA CPX SERIES COLUMBIA CFP SERIES EATON METALUX CGT SERIES EATON METALUX CGT SERIES LITHONIA CPX SERIES COLUMBIA CFP SERIES EATON METALUX CGT SERIES EATON METALUX CGT SERIES COOPER INVUE METALUX WNLED SERIES LITHONIA SBL SERIES COLUMBIA LAW SERIES LITHONIA SBL SERIES LITHONIA SBL SERIES COLUMBIA LAW SERIES COLUMBIA LAW SERIES	RECESSED 1 RECESSED 1 BALLARD 1 SUSPENDED 1 SUSPENDED 1	47.0 W I 47.0 W I 48.0 W I 48.0 W I	LED 480 LED 12: LED 400 LED 400	00 Im 277 V 00 Im 277 V 76 Im 277 V 00 Im 277 V	2 BY 4-FOOT BACK LIT FLAT PANEL WITH ALUMINUM FRAME, 1% 0-10V DIMMING. DAMP LOCATION. 2 BY 4-FOOT BACK LIT FLAT PANEL WITH ALUMINUM FRAME, 1% 0-10V DIMMING WITH AN EMERGENCY TRANSFER DEVICE, DAMP LOCATION 36 - INCH TALL BALLARD, DIE CAST ALUMINUM HOUSING SYMETRIC DISTRIBUTION. 4-FOOT LED WRAP AROUND FIXTURE, ACRYLIC PRISMATIC DIFFUSER, 0-10VDC DIMMING. IF SUSPENDED, INSTALL AT 8-FOOT AFF WITH CONDUIT STEMS (UNO).	47 VA CKT Circuit Description 1 Receptacle - B109, B108 3 AUTOMATIC DOOR RM - B108 5 AUTOMATIC DOOR RM - B108 7 AUTOMATIC DOOR RM - B108 37 VA 9 AUTOMATIC DOOR RM - B101 27 VA 11 AUTOMATIC DOOR RM - B101 13 RECEPTS RM - B100 15 RECEPTS RM - B101, B109	20 A 1 1080 9 20 A 1	1127 0 85 1127 144	1127 470 10 1127 1440 0 1440 1080	1 20 A RECEPTS RM - B122, B201 1 20 A AHU LIGHTS/RECEPTS RM - B201 1 20 A EF 16, PUH-B1 RM - B201 1 20 A EF-14, EF-16, CUH-B1 1 20 A RECEPTS RM - B115 1 20 A RECEPTS RM - B116 1 20 A RECEPTS RM - B117 1 20 A RECEPTS RM - B118
	LFW2 LFW2X LPB1 LR2 LR2X LR4	EATON METALUX CGT SERIES LITHONIA CPX SERIES COLUMBIA CFP SERIES EATON METALUX CGT SERIES EATON METALUX CGT SERIES LITHONIA CPX SERIES COLUMBIA CFP SERIES EATON METALUX CGT SERIES COOPER INVUE METALUX WNLED SERIES LITHONIA SBL SERIES COLUMBIA LAW SERIES METALUX WNLED SERIES LITHONIA SBL SERIES LITHONIA SBL SERIES	RECESSED 1 RECESSED 1 BALLARD 1 SUSPENDED 1	47.0 W I 47.0 W I 47.0 W I 48.0 W I 48.0 W I	LED 480 LED 12: LED 400 LED 400	00 Im 277 V 00 Im 277 V 76 Im 277 V 00 Im 277 V 00 Im 277 V	2 BY 4-FOOT BACK LIT FLAT PANEL WITH ALUMINUM FRAME, 1% 0-10V DIMMING. DAMP LOCATION. 2 BY 4-FOOT BACK LIT FLAT PANEL WITH ALUMINUM FRAME, 1% 0-10V DIMMING WITH AN EMERGENCY TRANSFER DEVICE, DAMP LOCATION 36 - INCH TALL BALLARD, DIE CAST ALUMINUM HOUSING SYMETRIC DISTRIBUTION. 4-FOOT LED WRAP AROUND FIXTURE, ACRYLIC PRISMATIC DIFFUSER, 0-10VDC DIMMING. IF SUSPENDED, INSTALL AT 8-FOOT AFF WITH CONDUIT STEMS (UNO). 4-FOOT LED WRAP AROUND FIXTURE, ACRYLIC PRISMATIC DIFFUSER, 0-10VDC DIMMING, WITH EMERGENCY TRANSFER DEVICE. IF SUSPENDED, INSTALL AT 8-FOOT AFF WITH CONDUIT STEMS (UNO).	47 VA CKT Circuit Description 1 Receptacle - B109, B108 3 AUTOMATIC DOOR RM - B108 5 AUTOMATIC DOOR RM - B108 7 AUTOMATIC DOOR RM - B108 37 VA 9 AUTOMATIC DOOR RM - B101 27 VA 11 AUTOMATIC DOOR RM - B101 13 RECEPTS RM - B101 15 RECEPTS RM - B101, B109 17 RECEPTS RM - B109 19 REFRIGERATOR RM - B111	20 A 1 1080 9 20 A 1	1127 0 85 1127 144 080 1800 900	1127 470 10 1127 1440 0 1440 1080	1 20 A RECEPTS RM - B122, B201 1 20 A AHU LIGHTS/RECEPTS RM - B201 1 20 A EF 16, PUH-B1 RM - B201 1 20 A EF-14, EF-16, CUH-B1 1 20 A RECEPTS RM - B115 1 20 A RECEPTS RM - B116 1 20 A RECEPTS RM - B117 1 20 A RECEPTS RM - B118 1 20 A RECEPTS RM - B129 1 20 A RECEPTS COURTYARD
	LFW2 LFW2X LPB1 LR2 LR2X LR4 LR4	EQLUMBIA CAP SERIES EATON METALUX CGT SERIES LITHONIA CPX SERIES COLUMBIA CFP SERIES EATON METALUX CGT SERIES LITHONIA CPX SERIES COLUMBIA CFP SERIES EATON METALUX CGT SERIES EATON METALUX CGT SERIES COLUMBIA CFP SERIES EATON METALUX CGT SERIES COLUMBIA LAW SERIES LITHONIA SBL SERIES COLUMBIA LAW SERIES LITHONIA SBL SERIES COLUMBIA LAW SERIES LITHONIA SBL SERIES LITHONIA SBL SERIES COLUMBIA LAW SERIES LITHONIA SBL SERIES LITHONIA SBL SERIES COLUMBIA LAW SERIES LITHONIA SBL SERIES LITHONIA SBL SERIES LITHONIA SBL SERIES	RECESSED 1 RECESSED 1 BALLARD 1 SUSPENDED 1 SUSPENDED 1	47.0 W I 47.0 W I 47.0 W I 48.0 W I 87.0 W I	LED 480 LED 127 LED 400 LED 700	00 Im 277 V 00 Im 277 V 76 Im 277 V 00 Im 277 V 00 Im 277 V	2 BY 4-FOOT BACK LIT FLAT PANEL WITH ALUMINUM FRAME, 1% 0-10V DIMMING. DAMP LOCATION. 2 BY 4-FOOT BACK LIT FLAT PANEL WITH ALUMINUM FRAME, 1% 0-10V DIMMING WITH AN EMERGENCY TRANSFER DEVICE, DAMP LOCATION 36 - INCH TALL BALLARD, DIE CAST ALUMINUM HOUSING SYMETRIC DISTRIBUTION. 4-FOOT LED WRAP AROUND FIXTURE, ACRYLIC PRISMATIC DIFFUSER, 0-10VDC DIMMING. IF SUSPENDED, INSTALL AT 8-FOOT AFF WITH CONDUIT STEMS (UNO). 4-FOOT LED WRAP AROUND FIXTURE, ACRYLIC PRISMATIC DIFFUSER, 0-10VDC DIMMING, WITH EMERGENCY TRANSFER DEVICE. IF SUSPENDED, INSTALL AT 8-FOOT AFF WITH CONDUIT STEMS (UNO).	47 VA CKT Circuit Description 1 Receptacle - B109, B108 3 AUTOMATIC DOOR RM - B108 5 AUTOMATIC DOOR RM - B108 7 AUTOMATIC DOOR RM - B108 37 VA 9 AUTOMATIC DOOR RM - B101 11 AUTOMATIC DOOR RM - B101 13 RECEPTS RM - B101 15 RECEPTS RM - B101, B109 27 VA 17 RECEPTS RM - B109 19 REFRIGERATOR RM - B111 87 VA 21 RECEPTS RM - B111 23 RECEPTS RM - B111 25 REFRIGERATOR RM - B112 116 VA 27 RECEPTS RM - B112, B113	20 A 1 1080 9 20 A 1	1127 0 85 1127 144 080 1800 900 080 1080 126	1127 470 10 1127 1440 0 1440 1080 60 1260 900	1 20 A RECEPTS RM - B122, B201 1 20 A AHU LIGHTS/RECEPTS RM - B201 1 20 A EF 16, PUH-B1 RM - B201 1 20 A EF-14, EF-16, CUH-B1 1 20 A RECEPTS RM - B115 1 20 A RECEPTS RM - B116 1 20 A RECEPTS RM - B117 1 20 A RECEPTS RM - B118 1 20 A RECEPTS RM - B118 1 20 A RECEPTS RM - B129 1 20 A RECEPTS COURTYARD 1 20 A RECEPTS RM - B130 1 20 A RECEPTS RM - B131 1 20 A RECEPTS RM - B132 1 20 A RECEPTS RM - B132 1 20 A RECEPTS RM - B120, B123-B125, B1
	LFW2X LFW2X LPB1 LR2 LR2X LR4 LR4 LR4X	EATON METALUX CGT SERIES LITHONIA CPX SERIES COLUMBIA CFP SERIES EATON METALUX CGT SERIES EATON METALUX CGT SERIES LITHONIA CPX SERIES COLUMBIA CFP SERIES EATON METALUX CGT SERIES COUMBIA CFP SERIES EATON METALUX CGT SERIES COOPER INVUE METALUX WNLED SERIES LITHONIA SBL SERIES COLUMBIA LAW SERIES LITHONIA SBL SERIES	RECESSED 1 RECESSED 1 BALLARD 1 SUSPENDED 1 SUSPENDED 1 SUSPENDED 1 SUSPENDED 1	47.0 W I 47.0 W I 47.0 W I 48.0 W I 87.0 W I 87.0 W I	LED 480 LED 127 LED 400 LED 700 LED 700	00 Im 277 V 00 Im 277 V 76 Im 277 V 00 Im 277 V 00 Im 277 V	2 BY 4-FOOT BACK LIT FLAT PANEL WITH ALUMINUM FRAME, 1% 0-10V DIMMING. DAMP LOCATION. 2 BY 4-FOOT BACK LIT FLAT PANEL WITH ALUMINUM FRAME, 1% 0-10V DIMMING WITH AN EMERGENCY TRANSFER DEVICE, DAMP LOCATION 36 - INCH TALL BALLARD, DIE CAST ALUMINUM HOUSING SYMETRIC DISTRIBUTION. 4-FOOT LED WRAP AROUND FIXTURE, ACRYLIC PRISMATIC DIFFUSER, 0-10VDC DIMMING. IF SUSPENDED, INSTALL AT 8-FOOT AFF WITH CONDUIT STEMS (UNO). 4-FOOT LED WRAP AROUND FIXTURE, ACRYLIC PRISMATIC DIFFUSER, 0-10VDC DIMMING, WITH EMERGENCY TRANSFER DEVICE. IF SUSPENDED, INSTALL AT 8-FOOT AFF WITH CONDUIT STEMS (UNO). 4-FOOT WRAP LED AROUND FIXTURE, ACRYLIC PRISMATIC DIFFUSER, 0-10VDC DIMMING. IF SUSPENDED, INSTALL AT 8-FOOT AFF WITH CONDUIT STEMS (UNO).	47 VA CKT Circuit Description 1 Receptacle - B109, B108 3 AUTOMATIC DOOR RM - B108 5 AUTOMATIC DOOR RM - B108 7 AUTOMATIC DOOR RM - B108 37 VA 9 AUTOMATIC DOOR RM - B101 27 VA 11 AUTOMATIC DOOR RM - B101 13 RECEPTS RM - B101 15 RECEPTS RM - B101, B109 27 VA 17 RECEPTS RM - B109 19 REFRIGERATOR RM - B111 21 RECEPTS RM - B111 22 RECEPTS RM - B111 23 RECEPTS RM - B112 116 VA 27 RECEPTS RM - B112 116 VA 27 RECEPTS RM - B114 29 RECEPTS RM - B134	20 A 1 1080 9 20 A 1	1127 0 85 1127 144 080 900 080 1800 900 080 126 00 1440 126	1127 470 10 1127 1440 0 1127 1440 0 1440 1080 0 1260 900 0 1440 0	1 20 A RECEPTS RM - B122, B201 1 20 A AHU LIGHTS/RECEPTS RM - B201 1 20 A EF 16, PUH-B1 RM - B201 1 20 A EF-14, EF-16, CUH-B1 1 20 A RECEPTS RM - B115 1 20 A RECEPTS RM - B116 1 20 A RECEPTS RM - B117 1 20 A RECEPTS RM - B118 1 20 A RECEPTS RM - B129 1 20 A RECEPTS RM - B129 1 20 A RECEPTS RM - B130 1 20 A RECEPTS RM - B130 1 20 A RECEPTS RM - B131 1 20 A RECEPTS RM - B132 1 20 A RECEPTS RM - B120, B123-B125, B1 1 20 A Spare 1 20 A COPIER RM - B121
	LFW2X LPB1 LR2 LR2X LR4 LR4X LS1	EATON METALUX CGT SERIES LITHONIA CPX SERIES COLUMBIA CFP SERIES EATON METALUX CGT SERIES EATON METALUX CGT SERIES LITHONIA CPX SERIES COLUMBIA CFP SERIES EATON METALUX CGT SERIES EATON METALUX CGT SERIES COLUMBIA LAW SERIES LITHONIA SBL SERIES COLUMBIA LAW SERIES LITHONIA SBL SERIES COLUMBIA LAW SERIES LITHONIA SBL SERIES COLUMBIA LAW SERIES METALUX WNLED SERIES LITHONIA SBL SERIES COLUMBIA LAW SERIES LITHONIA SBL SERIES COLUMBIA LAW SERIES LITHONIA SBL SERIES COLUMBIA LAW SERIES LITHONIA SBL SERIES LITHONIA SBL SERIES COLUMBIA LAW SERIES LITHONIA DSX2 SERIES MCGRAW EDISON GALEON SERIES	RECESSED 1 RECESSED 1 BALLARD 1 SUSPENDED 1 SUSPENDED 1 SUSPENDED 1	47.0 W I 47.0 W I 47.0 W I 48.0 W I 87.0 W I 87.0 W I	LED 480 LED 127 LED 400 LED 700 LED 700	00 Im 277 V 00 Im 277 V 76 Im 277 V 00 Im 277 V 00 Im 277 V 00 Im 277 V	2 BY 4-FOOT BACK LIT FLAT PANEL WITH ALUMINUM FRAME, 1% 0-10V DIMMING. DAMP LOCATION. 2 BY 4-FOOT BACK LIT FLAT PANEL WITH ALUMINUM FRAME, 1% 0-10V DIMMING WITH AN EMERGENCY TRANSFER DEVICE, DAMP LOCATION 36 - INCH TALL BALLARD, DIE CAST ALUMINUM HOUSING SYMETRIC DISTRIBUTION. 4-FOOT LED WRAP AROUND FIXTURE, ACRYLIC PRISMATIC DIFFUSER, 0-10VDC DIMMING. IF SUSPENDED, INSTALL AT 8-FOOT AFF WITH CONDUIT STEMS (UNO). 4-FOOT LED WRAP AROUND FIXTURE, ACRYLIC PRISMATIC DIFFUSER, 0-10VDC DIMMING, WITH EMERGENCY TRANSFER DEVICE. IF SUSPENDED, INSTALL AT 8-FOOT AFF WITH CONDUIT STEMS (UNO). 4-FOOT WRAP LED AROUND FIXTURE, ACRYLIC PRISMATIC DIFFUSER, 0-10VDC DIMMING. IF SUSPENDED, INSTALL AT 8-FOOT AFF WITH CONDUIT STEMS (UNO). 4-FOOT LED WRAP AROUND FIXTURE, ACRYLIC PRISMATIC DIFFUSER, 0-10VDC DIMMING, WITH EMERGENCY TRANSFER DEVICE. IF SUSPENDED, INSTALL AT 8-FOOT AFF WITH CONDUIT STEMS (UNO).	47 VA CKT Circuit Description 1 Receptacle - B109, B108 3 AUTOMATIC DOOR RM - B108 47 VA 5 AUTOMATIC DOOR RM - B108 7 AUTOMATIC DOOR RM - B108 37 VA 9 AUTOMATIC DOOR RM - B101 27 VA 11 AUTOMATIC DOOR RM - B101 13 RECEPTS RM - B101 15 RECEPTS RM - B101 15 RECEPTS RM - B109 19 REFRIGERATOR RM - B111 21 RECEPTS RM - B111 22 RECEPTS RM - B111 23 RECEPTS RM - B111 25 REFRIGERATOR RM - B112 116 VA 27 RECEPTS RM - B112 116 VA 31 RECEPTS RM - B134 33 RECEPTS RM - B135 35 RECEPTS RM - B135	20 A 1 1080 9 20 A 1 20 A 1 20 A 1 1127 3 20 A 1 127 3 20 A 1 1080 10	1127 0 85 1127 144 080 1800 900 080 1080 126 00 1440 126 500 900 150	1127 470 10 1127 1440 0 1127 1440 0 1440 1080 0 1260 900 0 1440 0	1 20 A RECEPTS RM - B122, B201 1 20 A AHU LIGHTS/RECEPTS RM - B201 1 20 A EF 16, PUH-B1 RM - B201 1 20 A EF-14, EF-16, CUH-B1 1 20 A RECEPTS RM - B115 1 20 A RECEPTS RM - B116 1 20 A RECEPTS RM - B117 1 20 A RECEPTS RM - B118 1 20 A RECEPTS RM - B129 1 20 A RECEPTS RM - B130 1 20 A RECEPTS RM - B130 1 20 A RECEPTS RM - B131 1 20 A RECEPTS RM - B131 1 20 A RECEPTS RM - B132 1 20 A RECEPTS RM - B120, B123-B125, B1 1 20 A Spare 1 20 A COPIER RM - B121 1 20 A MICROWAVE RM - B121
	LFW2 LFW2X LPB1 LR2 LR2X LR4 LR4X LS1	EATON METALUX CGT SERIES LITHONIA CPX SERIES COLUMBIA CFP SERIES EATON METALUX CGT SERIES EATON METALUX CGT SERIES LITHONIA CPX SERIES COLUMBIA CFP SERIES EATON METALUX CGT SERIES EATON METALUX CGT SERIES COLUMBIA LAW SERIES LITHONIA SBL SERIES LITHONIA SBL SERIES LITHONIA SBL SERIES LITHONIA SBL SERIES COLUMBIA LAW SERIES LITHONIA DSX2 SERIES MCGRAW EDISON GALEON	RECESSED 1 RECESSED 1 BALLARD 1 SUSPENDED 1 SUSPENDED 1 SUSPENDED 1 SUSPENDED 1	47.0 W I 47.0 W I 47.0 W I 48.0 W I 87.0 W I 270.0 W I	LED 480 LED 127 LED 400 LED 700 LED 700 LED 273	00 Im 277 V 00 Im 277 V 76 Im 277 V 00 Im 277 V 00 Im 277 V 00 Im 277 V	2 BY 4-FOOT BACK LIT FLAT PANEL WITH ALUMINUM FRAME, 1% 0-10V DIMMING. DAMP LOCATION. 2 BY 4-FOOT BACK LIT FLAT PANEL WITH ALUMINUM FRAME, 1% 0-10V DIMMING WITH AN EMERGENCY TRANSFER DEVICE, DAMP LOCATION 36 - INCH TALL BALLARD, DIE CAST ALUMINUM HOUSING SYMETRIC DISTRIBUTION. 4-FOOT LED WRAP AROUND FIXTURE, ACRYLIC PRISMATIC DIFFUSER, 0-10VDC DIMMING. IF SUSPENDED, INSTALL AT 8-FOOT AFF WITH CONDUIT STEMS (UNO). 4-FOOT LED WRAP AROUND FIXTURE, ACRYLIC PRISMATIC DIFFUSER, 0-10VDC DIMMING, WITH EMERGENCY TRANSFER DEVICE. IF SUSPENDED, INSTALL AT 8-FOOT AFF WITH CONDUIT STEMS (UNO). 4-FOOT WRAP LED AROUND FIXTURE, ACRYLIC PRISMATIC DIFFUSER, 0-10VDC DIMMING. IF SUSPENDED, INSTALL AT 8-FOOT AFF WITH CONDUIT STEMS (UNO). 4-FOOT LED WRAP AROUND FIXTURE, ACRYLIC PRISMATIC DIFFUSER, 0-10VDC DIMMING, WITH EMERGENCY TRANSFER DEVICE. IF SUSPENDED, INSTALL AT 8-FOOT AFF WITH CONDUIT STEMS (UNO).	47 VA CKT Circuit Description 1 Receptacle - B109, B108 3 AUTOMATIC DOOR RM - B108 5 AUTOMATIC DOOR RM - B108 7 AUTOMATIC DOOR RM - B108 7 AUTOMATIC DOOR RM - B101 27 VA 11 AUTOMATIC DOOR RM - B101 13 RECEPTS RM - B101 15 RECEPTS RM - B101 15 RECEPTS RM - B109 19 REFRIGERATOR RM - B111 27 VA 17 RECEPTS RM - B111 23 RECEPTS RM - B111 25 REFRIGERATOR RM - B112 116 VA 27 RECEPTS RM - B112 116 VA 27 RECEPTS RM - B114 31 RECEPTS RM - B135 35 RECEPTS RM - B135 36 RECEPTS RM - B135 37 REFRIGERATOR RM - B135 38 RECEPTS RM - B135 39 ICE MAKER RM - B135	20 A 1 1080 9 20 A 1	1127 0 85 1127 144 080 1800 900 080 1080 126 00 1440 126 500 900 150	1127 470 10 1127 1440 10 1127 1440 10 1080 10 1260 900 10 1440 0 10 720 1500	1 20 A RECEPTS RM - B122, B201 1 20 A AHU LIGHTS/RECEPTS RM - B201 1 20 A EF 16, PUH-B1 RM - B201 1 20 A EF-14, EF-16, CUH-B1 1 20 A RECEPTS RM - B115 1 20 A RECEPTS RM - B116 1 20 A RECEPTS RM - B116 1 20 A RECEPTS RM - B117 1 20 A RECEPTS RM - B118 1 20 A RECEPTS RM - B129 1 20 A RECEPTS RM - B130 1 20 A RECEPTS RM - B130 1 20 A RECEPTS RM - B131 1 20 A RECEPTS RM - B131 1 20 A RECEPTS RM - B132 1 20 A RECEPTS RM - B125, B1 1 20 A RECEPTS RM - B120, B123-B125, B1 1 20 A COPIER RM - B121 1 20 A MICROWAVE RM - B121 1 20 A REFRIGERATOR RM - B121
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TYPICAL TEMP CLASSROOM LAYOUT CONFIGURATION MAY DIFFER ACCORDING TO EACH CLASSROOM LAYOUT. -2 CABLES AT TEACHER LOCATION 1 CABLE RAN TO PROJECTOR 1 CABLE TAN TO WAP 3.5 CABLE FROM PROJECTOR LOCATION TO TEACHER LOCATION P3 CLASSROOM P4 CLASSROOM CONDUITS CONNECTING THE TWO DUAL TECH CLASSROOM TRAILERS. THIS WILL BE USED TO PULLBOX RUN THE OUTDOOR CAT6 CABLES TO EACH INDIVIDUAL CLASSROOM. PROVIDED BY DIV26 TEMPORARY 6 STRAND FIBER RAN THROUGH A DIVISION 26 PROVIDED 1" CONDUIT THAT WILL HOUSE THE FIRE ALARM WIRING AS WELL. P1 CLASSROOM P2 CLASSROOM EXISTING SCHOOL BUILDING MAIN ER LOCATION INSIDE SCHOOL

TEMP CLASSROOM RISER DIAGRAM GENERAL NOTES

- 1. RISER DIAGRAM IS REPRESENTATIONAL ONLY FOR TECHNOLOGY INFRASTRUCTURE NEEDED FOR CLASSROOMS. THERE SHALL BE FOUR CAT6 CABLES INSTALLED INTO EACH CLASSROOM AREA. (2-TEACHER LOCATION, 1-PROJECTOR & 1 - WAP)
- 2. CONTRACTOR SHALL VERIFY IF SURFACE MOUNT RACEWAY WILL NEED TO BE UTILIZED TO REACH THE APPROPRIATE CEILING
- LOCATIONS FROM THE TEACHER LOCATION OR CABLE ENTRY LOCATION FOR THE PATHWAY INDICATED. 3. CONTRACTOR SHALL COORDINATE FIBER AND PAGING INSTALLATION WITH THE FIRE ALARM CONNECTION CABLING WITH ELECTRICAL
- CONTRACTOR. 4. A SIX STRAND INDOOR/OUTDOOR OS2 FIBER SHALL BE INSTALLED, TEMINATED AND TESTED FROM THE ER TO A LOCATION IN P1 CLASSROOM.
- INSIDE THIS CLASSROOM THERE WILL NEED TO BE A 2 POST OR SMALL WALL MOUNT RACK WHERE A FIBER PANEL AND 24 PORT PATCH PANEL AND SCHOOL PROVIDED SWITCH WILL BE INSTALLED TO SERVE THE NETWORK NEEDS OF ALL 4 TEMP CLASSROOMS.
- 5. THE TECH CONTRACTOR SHALL PROVIDE AND INSTALL 4 NEW LIGHTSPEED 975 CLASSROOM AUDIO SYSTEMS. A SINGLE 3.5 CABLE WILL NEED TO CONNECT THE PROJECTOR LOCATION WITH THE TEACHER LOCATION IN EACH CLASSROOM AS WELL.
- 6. A SINGLE 14-2 PAGING CIRCUIT SHALL BE INSTALLED AND SPLIT TO EACH CLASSROOM FOR MORNING AND GENERAL ANNOUNCEMENTS TO BE HEARD OVER A SINGLE WALL MOUNT SPEAKER PROVIDED BY
- DIVISION 27 CONTRACTOR. ALL INSTALLATION MATERIALS AND WORKMANSHIP SHALL BE IN COMPLETE COMPLIANCE WITH ALL APPLICABLE LOCAL, STATE AND FEDERAL CODES AND REGULATIONS.
- 8. CONTRACTOR SHALL PROVIDE ALL NECESSARY GROUNDING, ROUGH-IN AND BACKBOXES, ENCLOSURES, AND BRACKETS

TEMPORARY CLASSROOM **CABLING OVERVIEW**

> **VERIFICATION NOTE:** CONTRACTOR SHALL VERIFY ALL DIMENSIONS, CLEARANCES AND EXISTING FIELD CONDITIONS BEFORE STARTING CONSTRUCTION. COMMENCEMENT OF WORK CONSTITUTES ACCEPTANCE OF CONDITIONS. SHOULD DIFFERENT CONDITIONS BE

ENCOUNTERED CONTACT THE ARCHITECT BEFORE PROCEEDING WITH ANY WORK.

SCHOOL **ADDITIONS AND** RENOVATIONS

CHERRY TREE

ELEMENTARY

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CARMEL CLAY SCHOOLS






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350 E. New York St, Indianapolis IN 46204

CONSULTANT

KEY PLAN

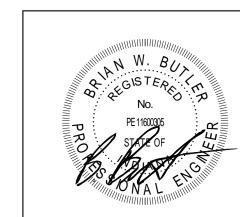

PROJECT MANAGER: SAM

DRAWN BY: CDT PROJECT NUMBER: 222011.00 PROJECT ISSUE DATE: 2.8.2024 REV.

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NO.	DESCRIPTION	DATE
1	ADDENDUM #1	2.23.202
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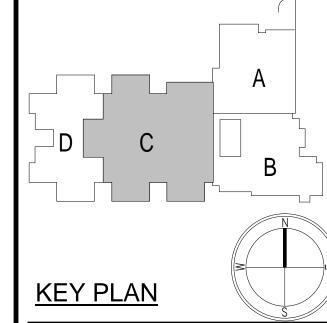
TECHNOLOGY DETAILS



ROOM LEGEND - FIRST FLOOR UNIT C




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J.—		DAIL		
	ADDENDUM #1	2.23.2024		

T3.03



CHERRY TREE ELEMENTARY SCHOOL **ADDITIONS AND** RENOVATIONS

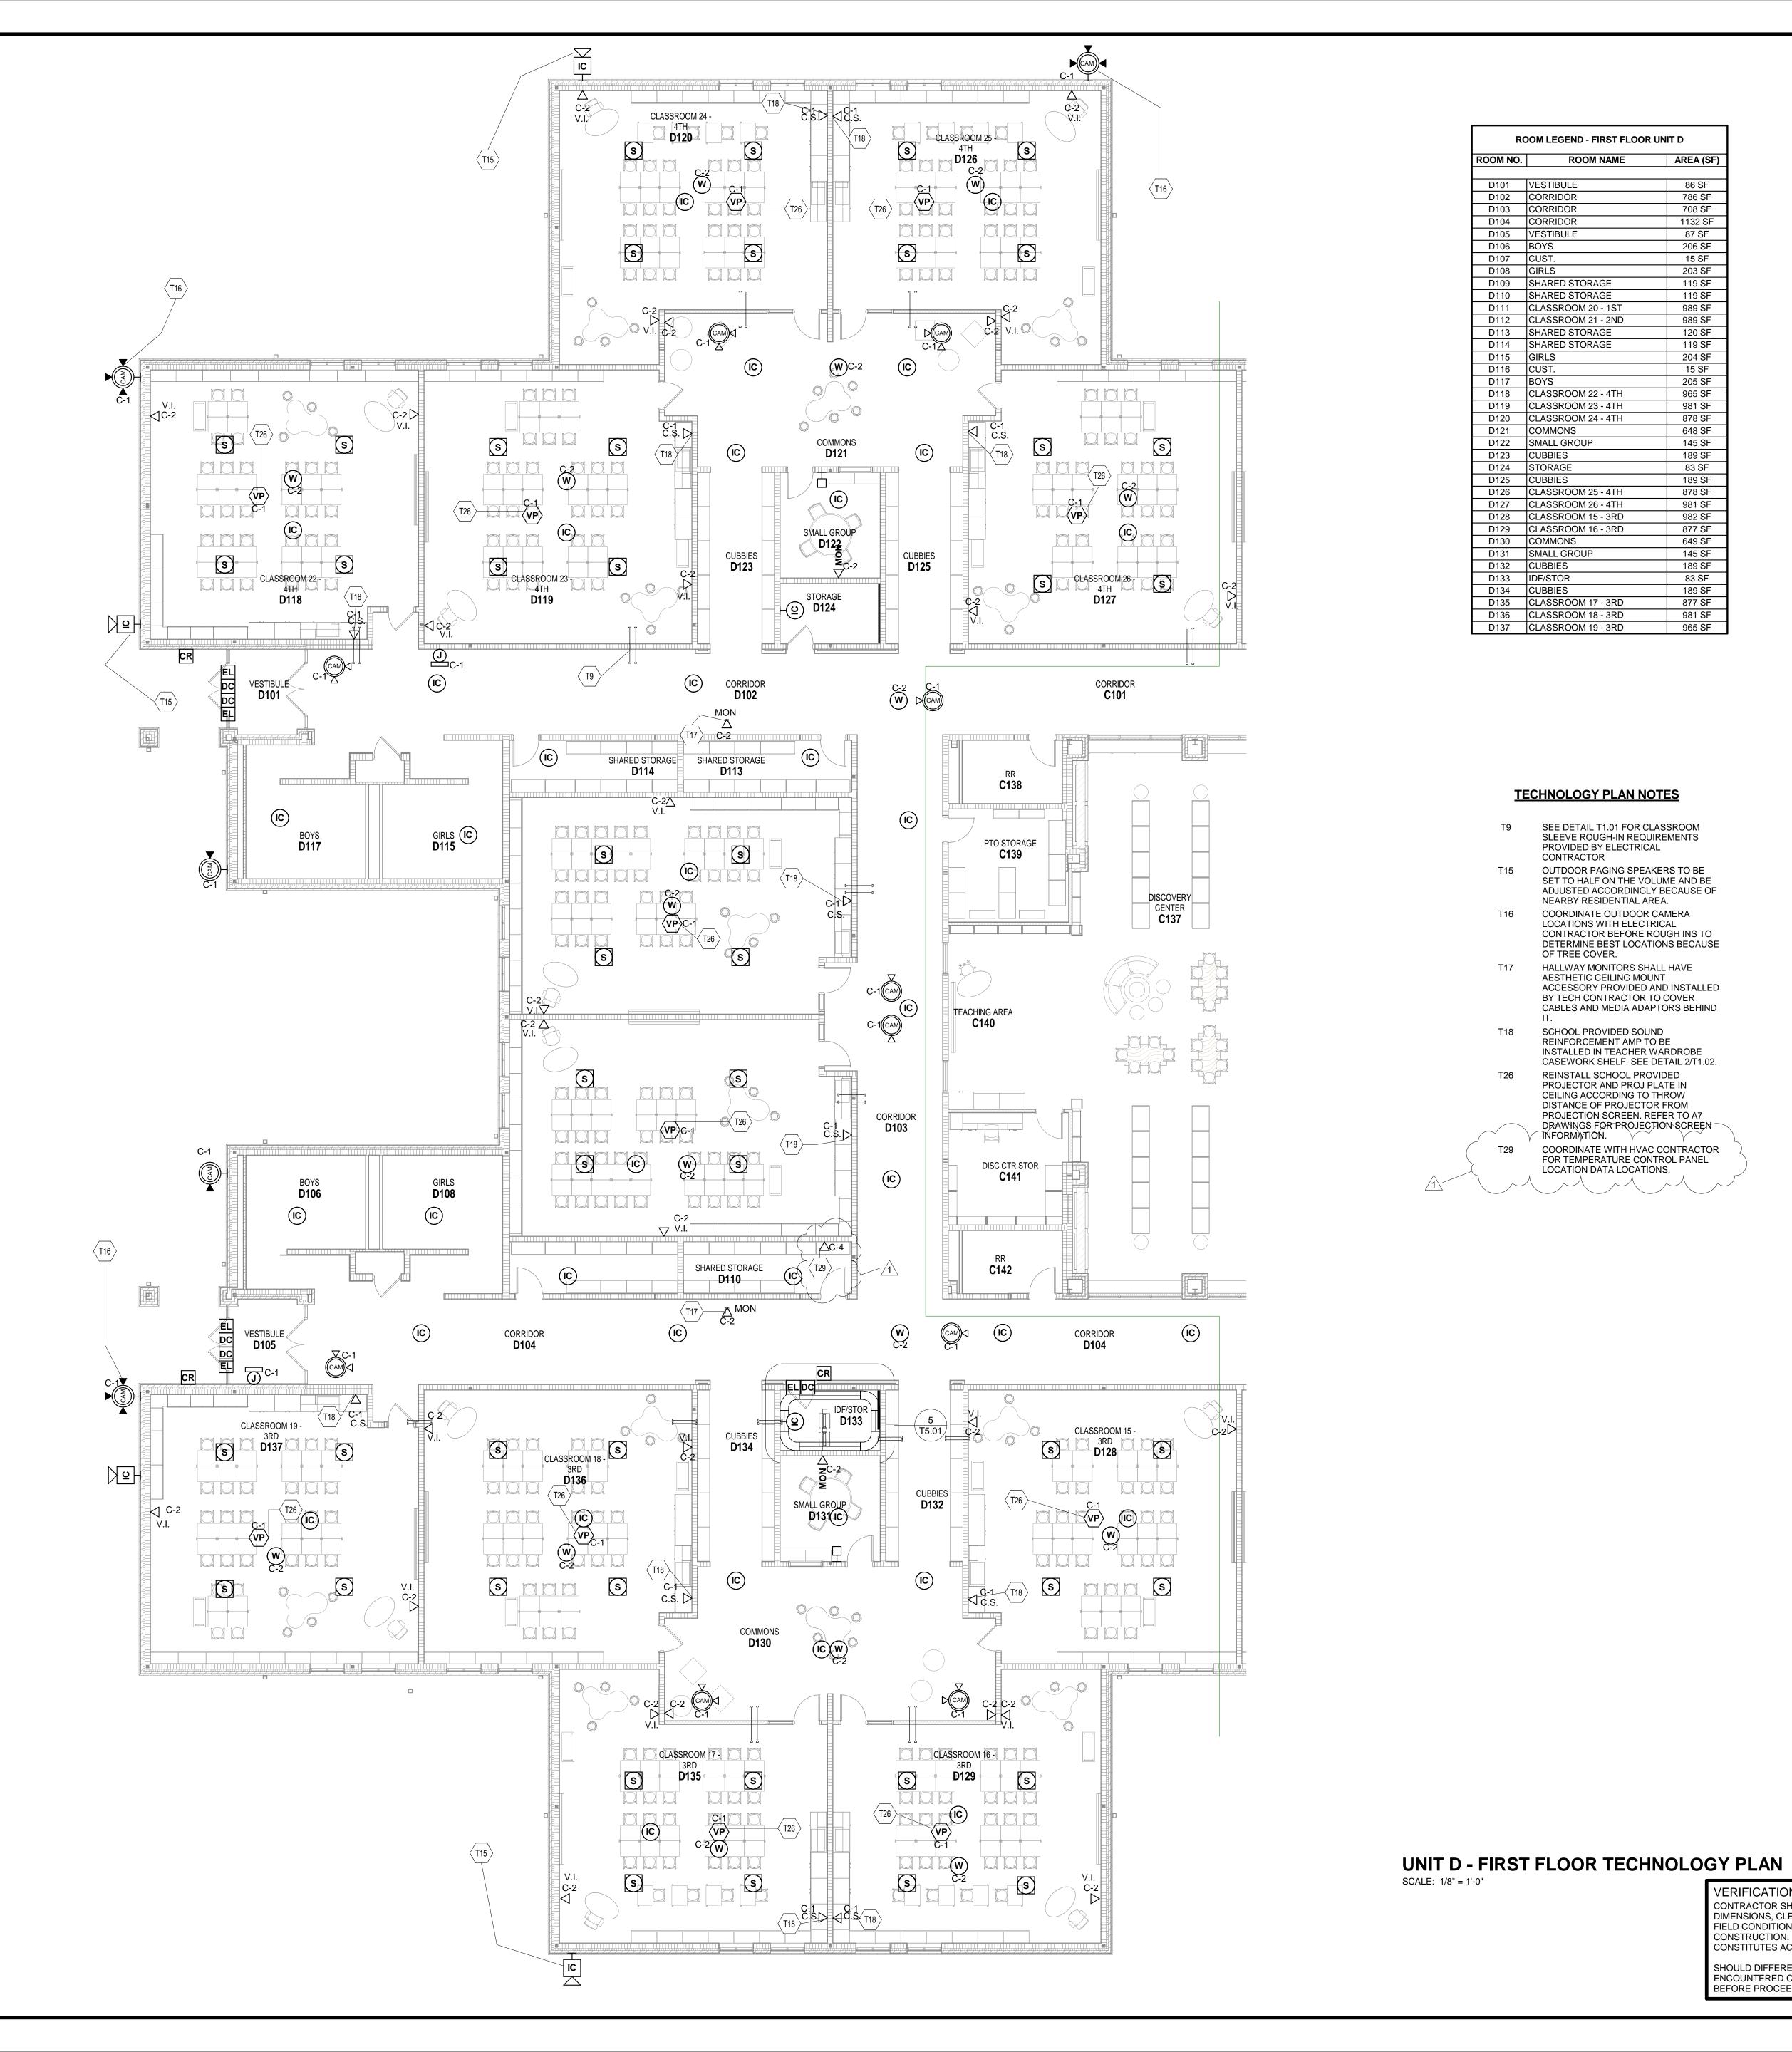ROOM LEGEND - FIRST FLOOR UNIT D

D101 VESTIBULE
D102 CORRIDOR
D103 CORRIDOR

D104 CORRIDOR

D105 VESTIBULE
D106 BOYS

D109 SHARED STORAGE
D110 SHARED STORAGE
D111 CLASSROOM 20 - 1S

D112 CLASSROOM 20 - 131

D112 CLASSROOM 21 - 2ND

D113 SHARED STORAGE

D114 SHARED STORAGE

D115 GIRLS

D118 CLASSROOM 22 - 4TH
D119 CLASSROOM 23 - 4TH

D120 CLASSROOM 24 - 4TH

D127 CLASSROOM 26 - 4TH
D128 CLASSROOM 15 - 3RD
D129 CLASSROOM 16 - 3RD
D130 COMMONS

D135 CLASSROOM 17 - 3RD D136 CLASSROOM 18 - 3RD

D137 CLASSROOM 19 - 3RD

TECHNOLOGY PLAN NOTES

PROVIDED BY ELECTRICAL

T15 OUTDOOR PAGING SPEAKERS TO BE SET TO HALF ON THE VOLUME AND BE

NEARBY RESIDENTIAL AREA.

LOCATIONS WITH ELECTRICAL

HALLWAY MONITORS SHALL HAVE AESTHETIC CEILING MOUNT

REINFORCEMENT AMP TO BE

REINSTALL SCHOOL PROVIDED PROJECTOR AND PROJ PLATE IN CEILING ACCORDING TO THROW DISTANCE OF PROJECTOR FROM PROJECTION SCREEN. REFER TO A7 DRAWINGS FOR PROJECTION SCREEN

LOCATION DATA LOCATIONS.

INSTALLED IN TEACHER WARDROBE CASEWORK SHELF. SEE DETAIL 2/T1.02.

COORDINATE WITH HVAC CONTRACTOR FOR TEMPERATURE CONTROL PANEL

T16 COORDINATE OUTDOOR CAMERA

OF TREE COVER.

T18 SCHOOL PROVIDED SOUND

INFORMATION.

CONTRACTOR

SEE DETAIL T1.01 FOR CLASSROOM SLEEVE ROUGH-IN REQUIREMENTS

ADJUSTED ACCORDINGLY BECAUSE OF

CONTRACTOR BEFORE ROUGH INS TO DETERMINE BEST LOCATIONS BECAUSE

ACCESSORY PROVIDED AND INSTALLED BY TECH CONTRACTOR TO COVER CABLES AND MEDIA ADAPTORS BEHIND

D131 SMALL GROUP
D132 CUBBIES

CLASSROOM 25 - 4TH

D121 COMMONS
D122 SMALL GROUP

AREA (SF)

87 SF 206 SF 15 SF 203 SF 119 SF 119 SF 989 SF

989 SF

120 SF 119 SF

981 SF

878 SF

648 SF 145 SF 189 SF 83 SF 189 SF 878 SF 981 SF 982 SF 877 SF 649 SF 145 SF 189 SF 83 SF

877 SF

981 SF

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CARMEL CLAY SCHOOLS



ARCHITECT




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317-848-0966 350 E. New York St, Indianapolis IN 46204

CONSULTANT

KEY PLAN

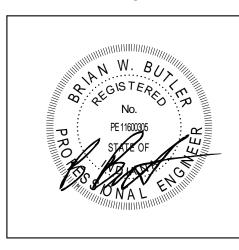

PROJECT MANAGER: SAM DRAWN BY: CDT PROJECT NUMBER: 222011.00

PROJECT ISSUE DATE: 2.8.2024

VERIFICATION NOTE:

CONTRACTOR SHALL VERIFY ALL DIMENSIONS, CLEARANCES AND EXISTING FIELD CONDITIONS BEFORE STARTING

SHOULD DIFFERENT CONDITIONS BE ENCOUNTERED CONTACT THE ARCHITECT BEFORE PROCEEDING WITH ANY WORK.

CONSTRUCTION. COMMENCEMENT OF WORK CONSTITUTES ACCEPTANCE OF CONDITIONS.

REV. No. \triangle	DESCRIPTION	DATE
1	ADDENDUM #1	2.23.2024

UNIT D - FIRST FLOOR TECHNOLOGY PLAN

ELEMENTARY

TECHNOLOGY PLAN NOTES

COORDINATE WITH HVAC CONTRACTOR FOR TEMPERATURE CONTROL PANEL LOCATION DATA LOCATIONS.

CHERRY TREE SCHOOL ADDITIONS AND RENOVATIONS

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CARMEL CLAY SCHOOLS





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KEY PLAN

PROJECT MANAGER: SAM PROJECT NUMBER: 222011.00

VERIFICATION NOTE:


CONTRACTOR SHALL VERIFY ALL
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FIELD CONDITIONS BEFORE STARTING
CONSTRUCTION. COMMENCEMENT OF WORK
CONSTITUTES ACCEPTANCE OF CONDITIONS.

SHOULD DIFFERENT CONDITIONS BE ENCOUNTERED CONTACT THE ARCHITECT BEFORE PROCEEDING WITH ANY WORK.


PROJECT ISSUE DATE: 2.8.2024 NO. DESCRIPTION DATE 1 ADDENDUM #1 2.23.2024


UNIT B - SECOND FLOOR TECHNOLOGY PLAN

UNIT B - SECOND FLOOR TECHNOLOGY PLAN SCALE: 1/8" = 1'-0"

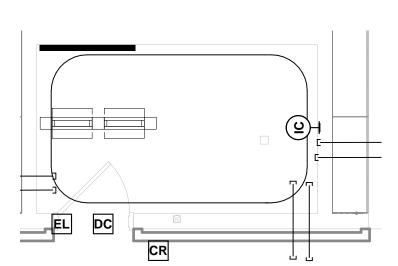


TR - CSCALE: 1/4" = 1'-0"

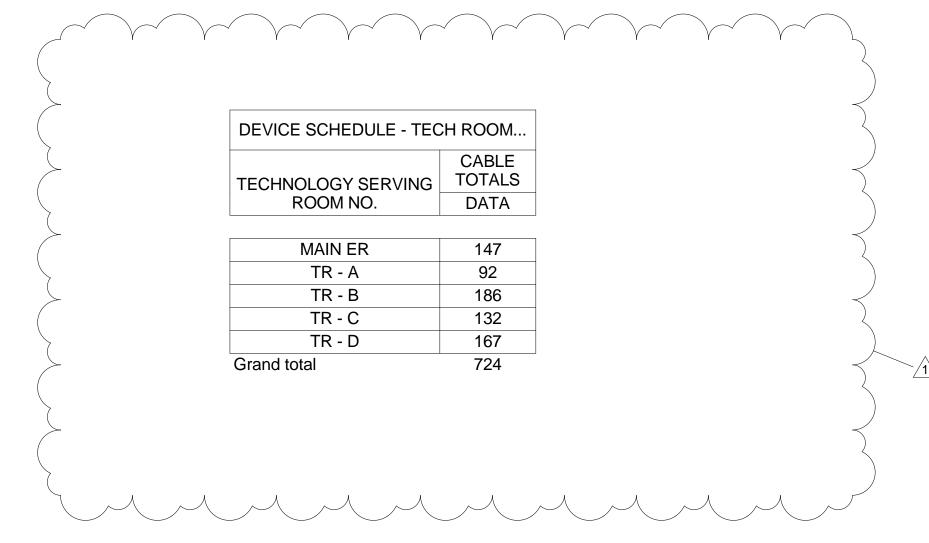


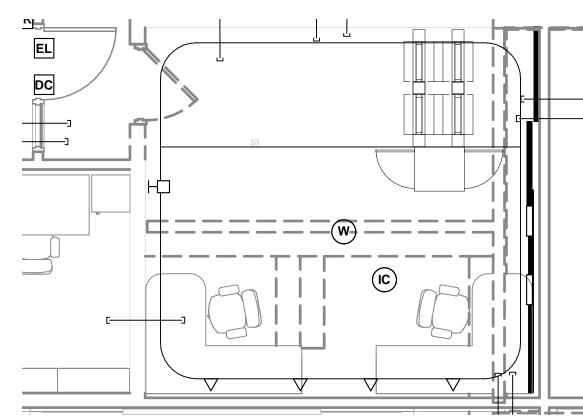



MAIN ER SCALE: 1/4" = 1'-0"

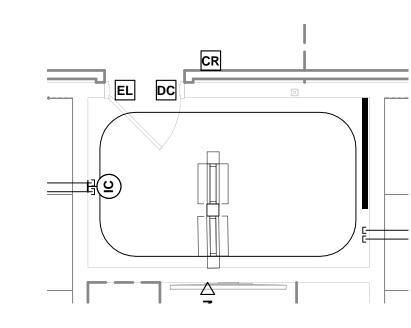

TR - DSCALE: 1/4" = 1'-0"

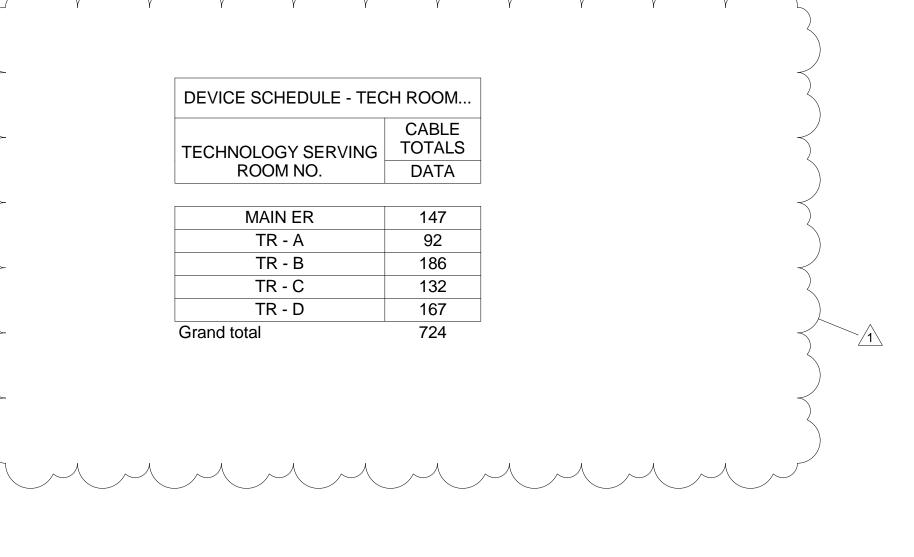

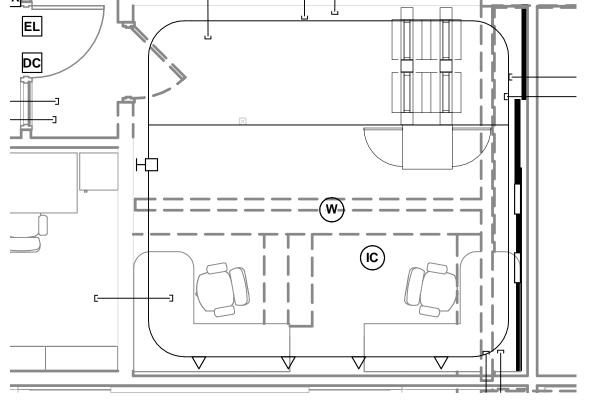

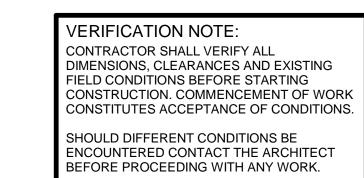

TR - A

SCALE: 1/4" = 1'-0"

TR - BSCALE: 1/4" = 1'-0"



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CARMEL CLAY SCHOOLS





<u>ARCHITECT</u>



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CONSULTANT



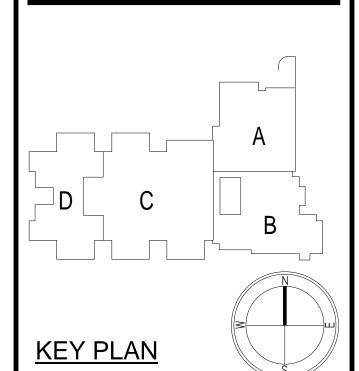

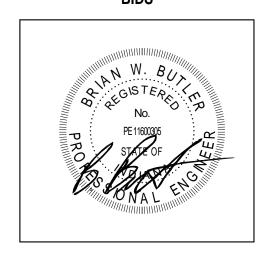PROJECT MANAGER: SAM DRAWN BY: CDT PROJECT NUMBER: 222011.00

PROJECT ISSUE DATE: 2.8.2024				
REV. NO.△	DESCRIPTION	DATE		
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1	ADDENDUM #1	2.23.2024		
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ENLARGED TECHNOLOGY ROOMS

T5.01